



1 Roof Plan
Scale: 1:50

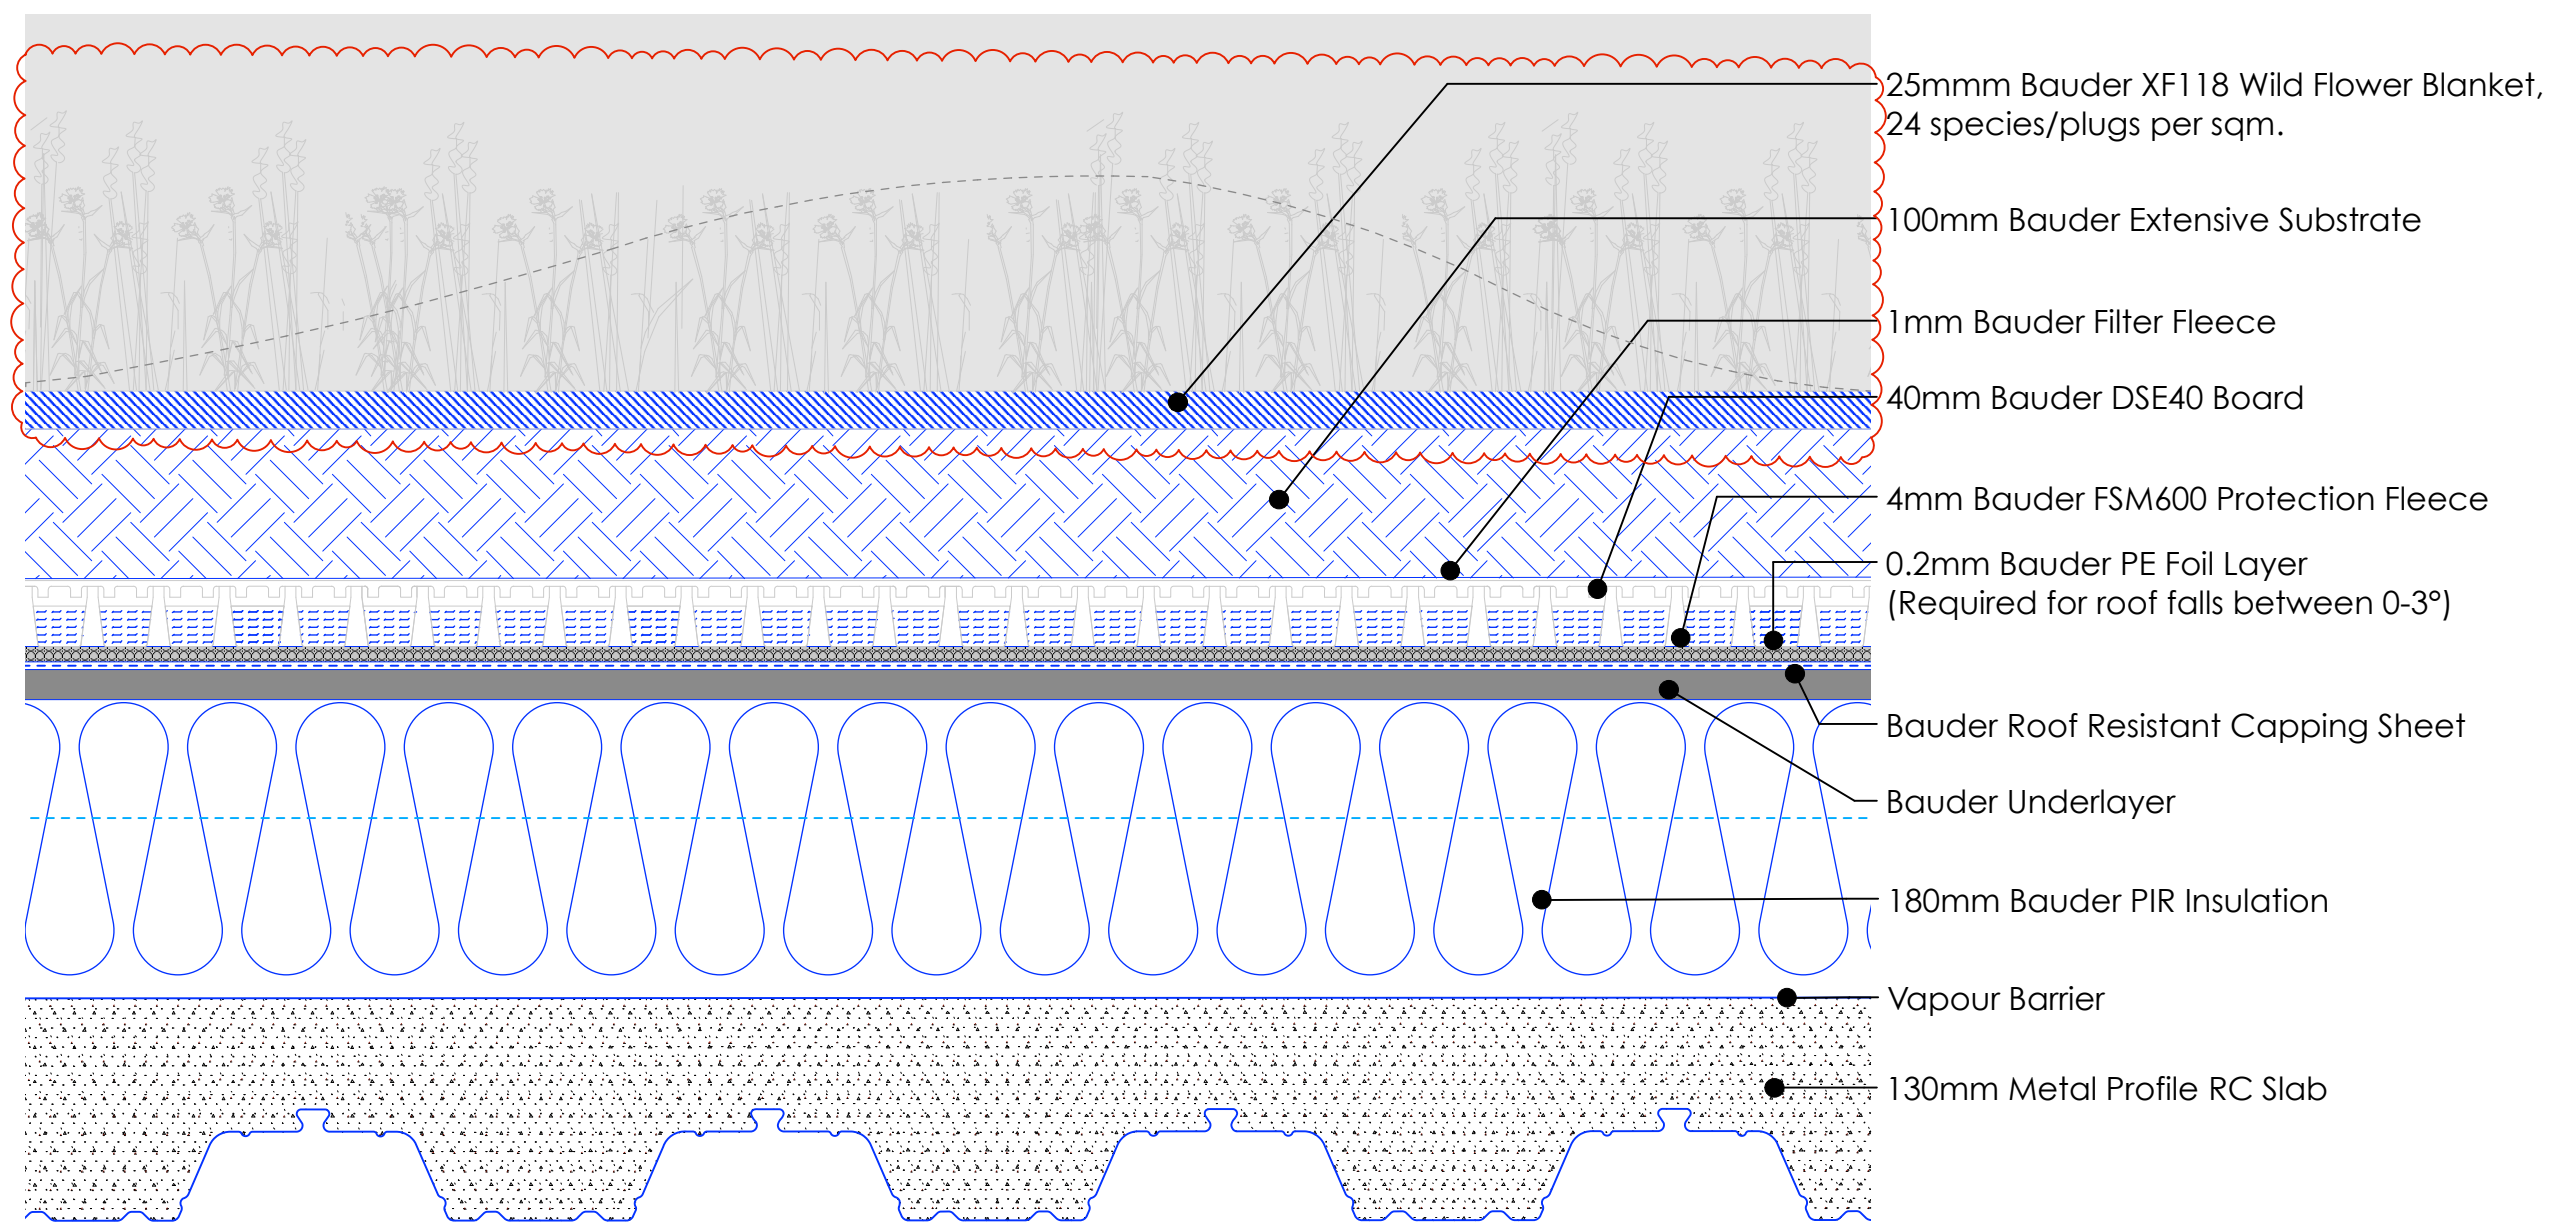

B Proposed Green Roof Build Up
Scale: 1:5

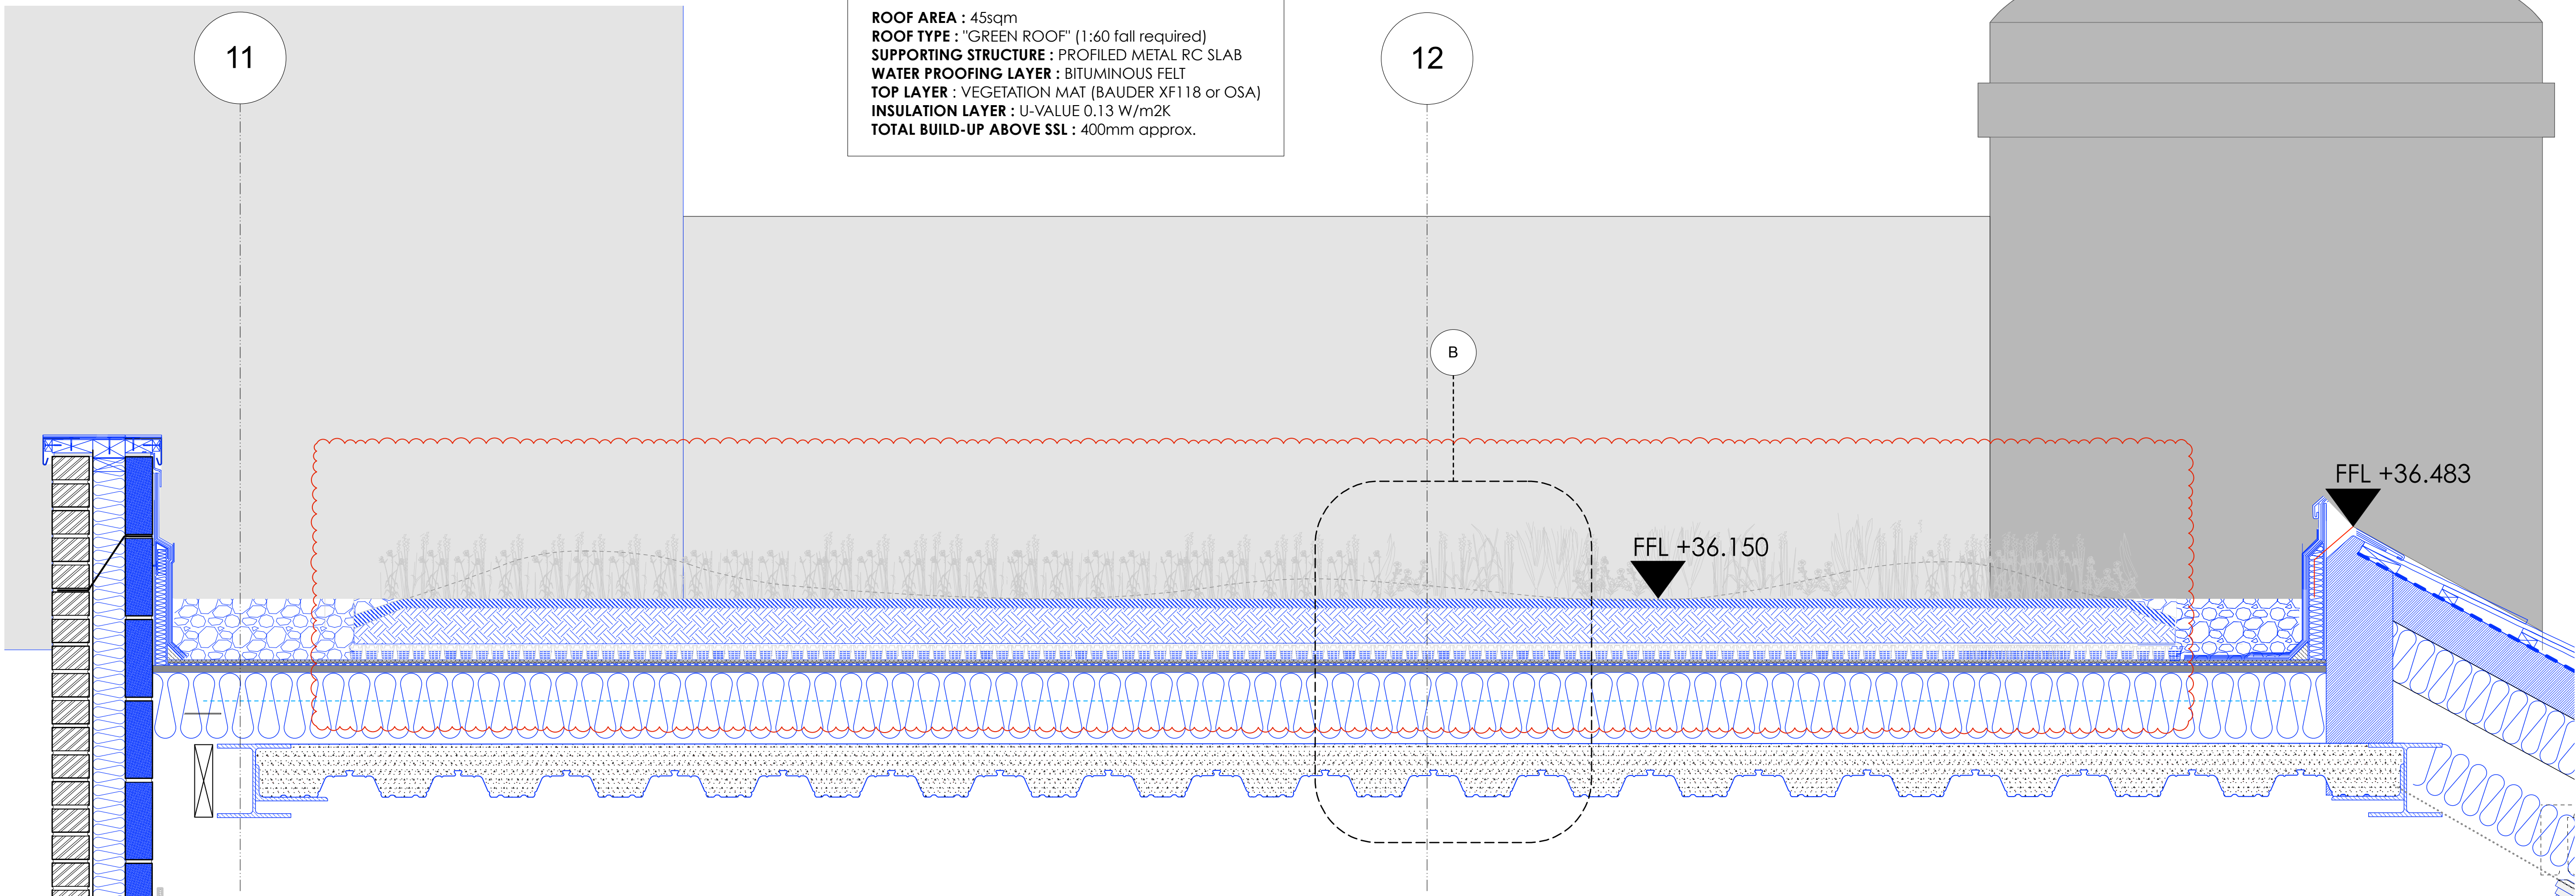

A Proposed Green Roof Detail
Scale: 1:10

**RF-06
FOURTH FLOOR**

ROOF AREA : 45sqm
ROOF TYPE : "GREEN ROOF" (1:60 fall required)
SUPPORTING STRUCTURE : PROFILED METAL RC SLAB
WATER PROOFING LAYER : BITUMINOUS FELT
TOP LAYER : VEGETATION MAT (BAUDER XF118 or OSA)
INSULATION LAYER : U-VALUE 0.13 W/m2K
TOTAL BUILD-UP ABOVE SSL : 400mm approx.

NOTE:
1. Refer to manufacturer's details for installation guides
2. Drawing to read inconjunction with AHA/KKC/DET-565

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Only the original drawing should be relied upon. Contractors, subcontractors and suppliers must verify all dimensions on site before commencing any work or making any shop drawings.

All shop drawings to be submitted to the architect for comment prior to fabrication.

This drawing is to be read in conjunction with the Architect's specification, bills of quantities / schedules, structural, mechanical & electrical drawings and all discrepancies are to be reported to the architect.

Do not scale from this drawing. Dimensions are in millimetres unless otherwise stated.

revision / date / amendments		
-	22/03/18	First Issue
A	09/11/18	1. Drawing number amended from DET 600 to DET 564. 2. Variable Substrate shown indicatively



PLANNING CONDITIONS

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project title		
KOKO + Hope & Anchor + Bayham Place Camden, London		
drawing title	scale	date
Proposed Green Roof Details	1:VARIES	21.03.18
SHEET 1	drawn	checked
	PD	DA
drawing number	revision	
AHA/ KKC /DET/564	A	