

All dimensions to be checked on site prior to commencement of work

1) HARDWOOD TIMBER VENEER FINISH STRAIGHT GRAIN LAID VERTICALLY REFER TO APPROVED HARDWOOD VENEER CONTROL SAMPLE. DOORS MOUNTED ON SPRING BLUM HINGES WITH 'SMOOTH PISTON'-


NOTE: SCRIBE PANELS TO MATCH PLINTH & TOP RAIL FINISH.


2 GROMMET FOR POWER & DATA TO PRINTER. REF: 80mmø GROMMET

11.10.18 Date


Shelving units elevations & section details

-2332 DT19 172332 DT19

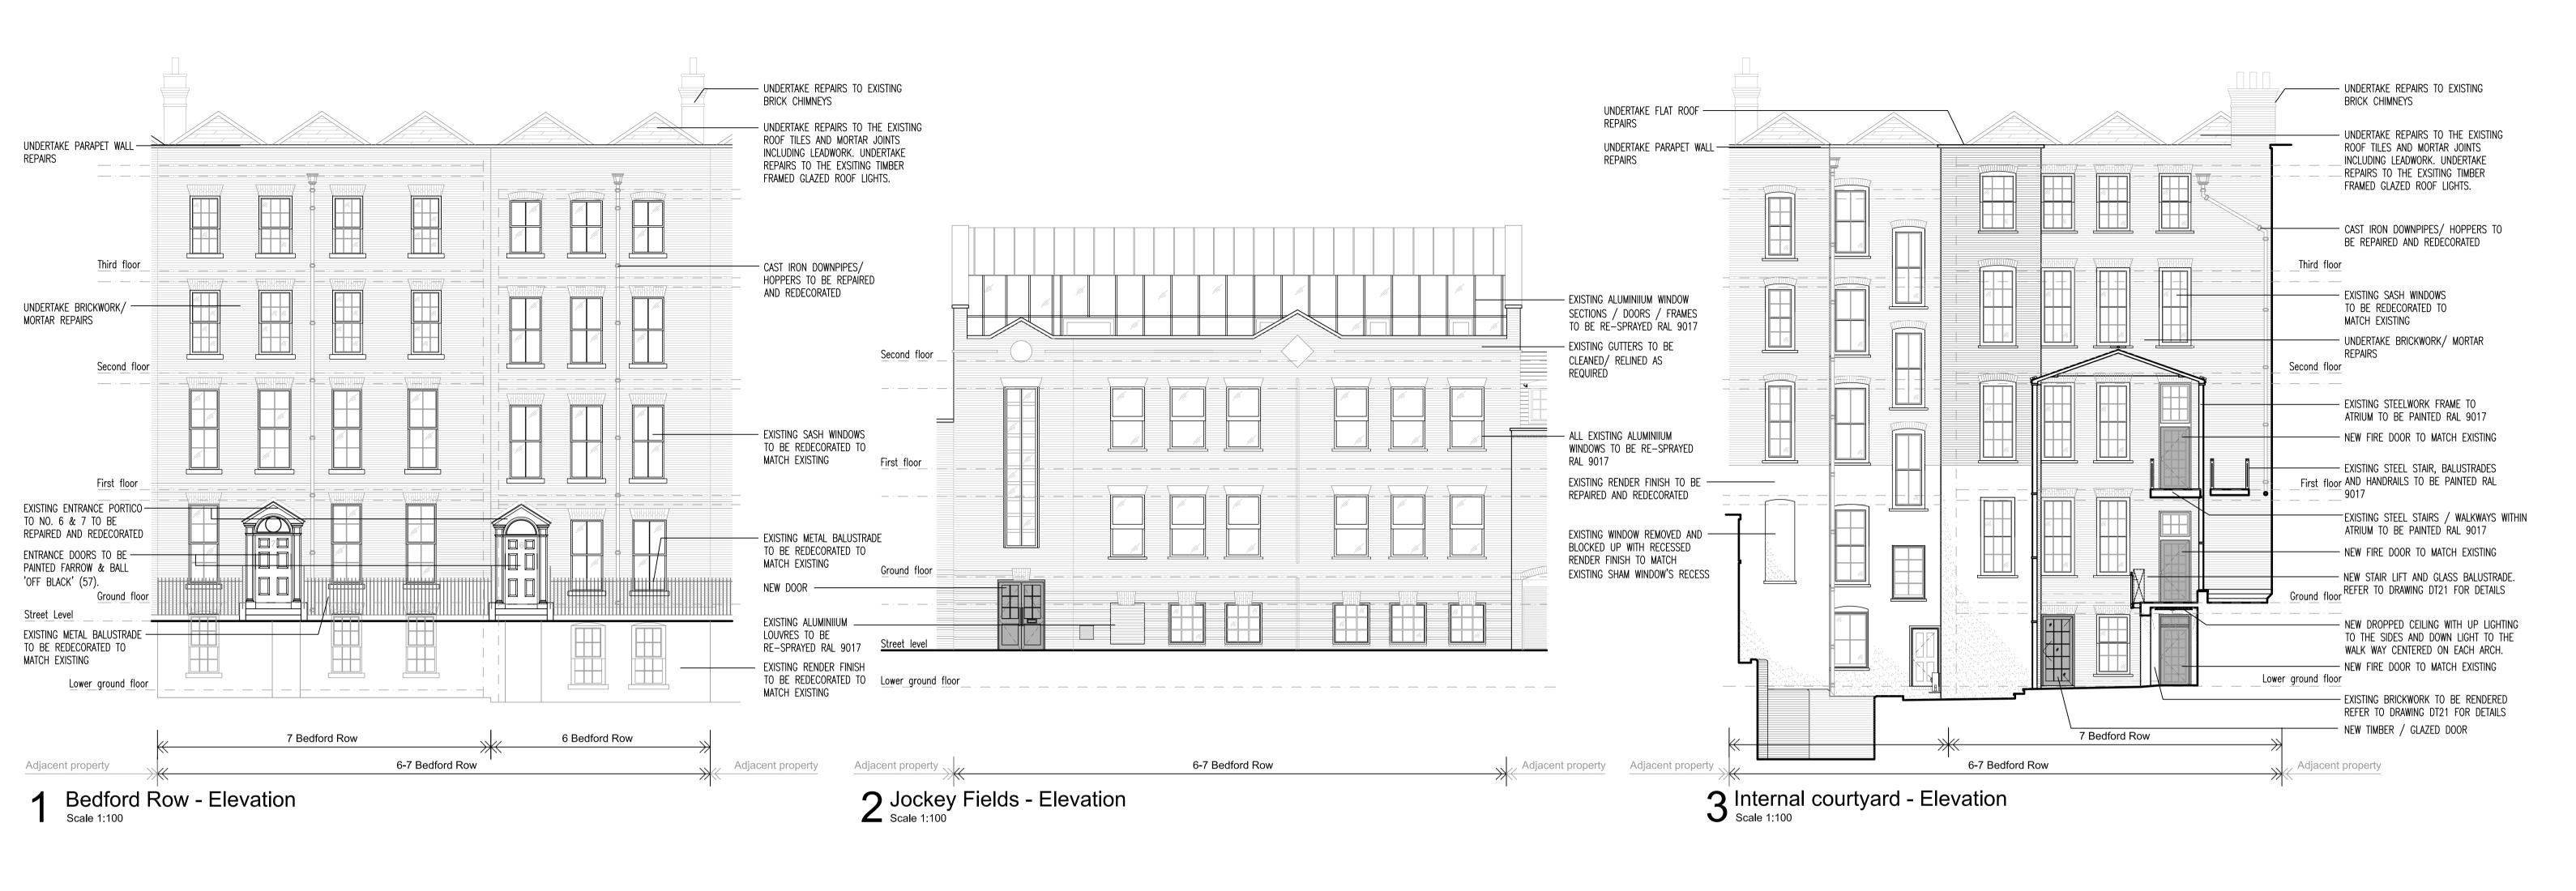

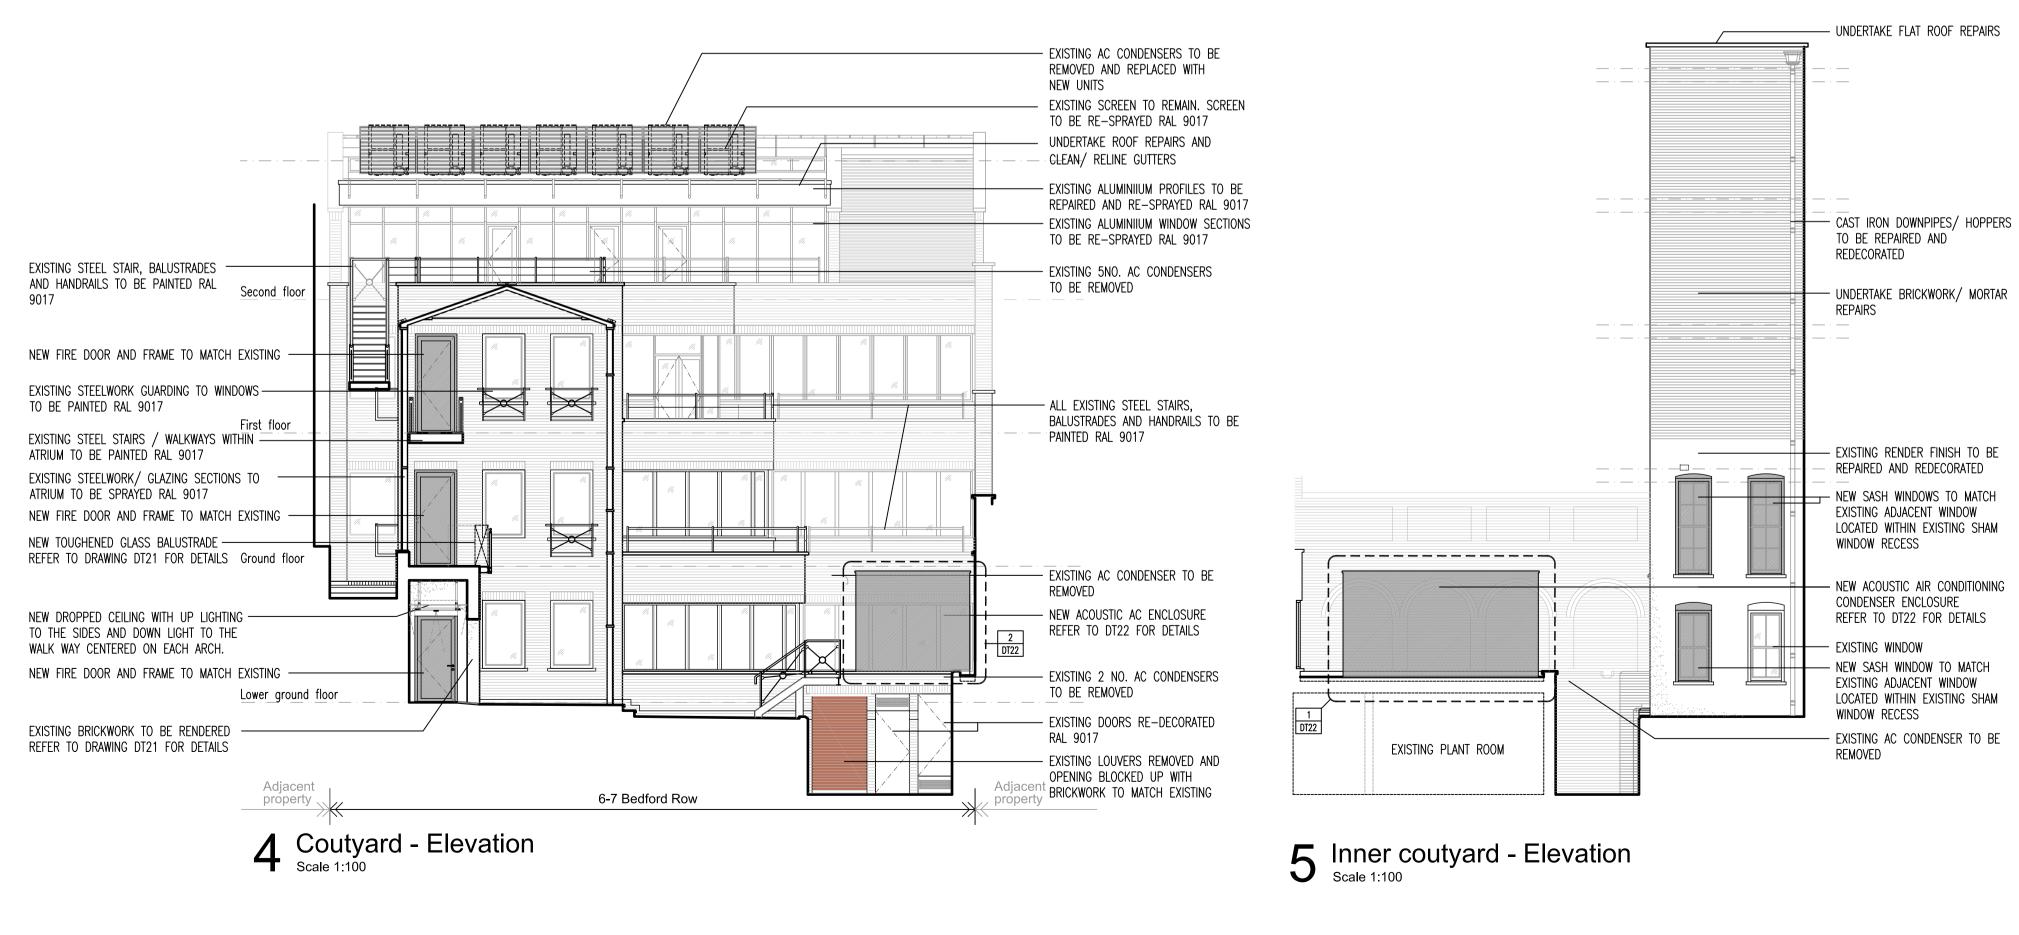





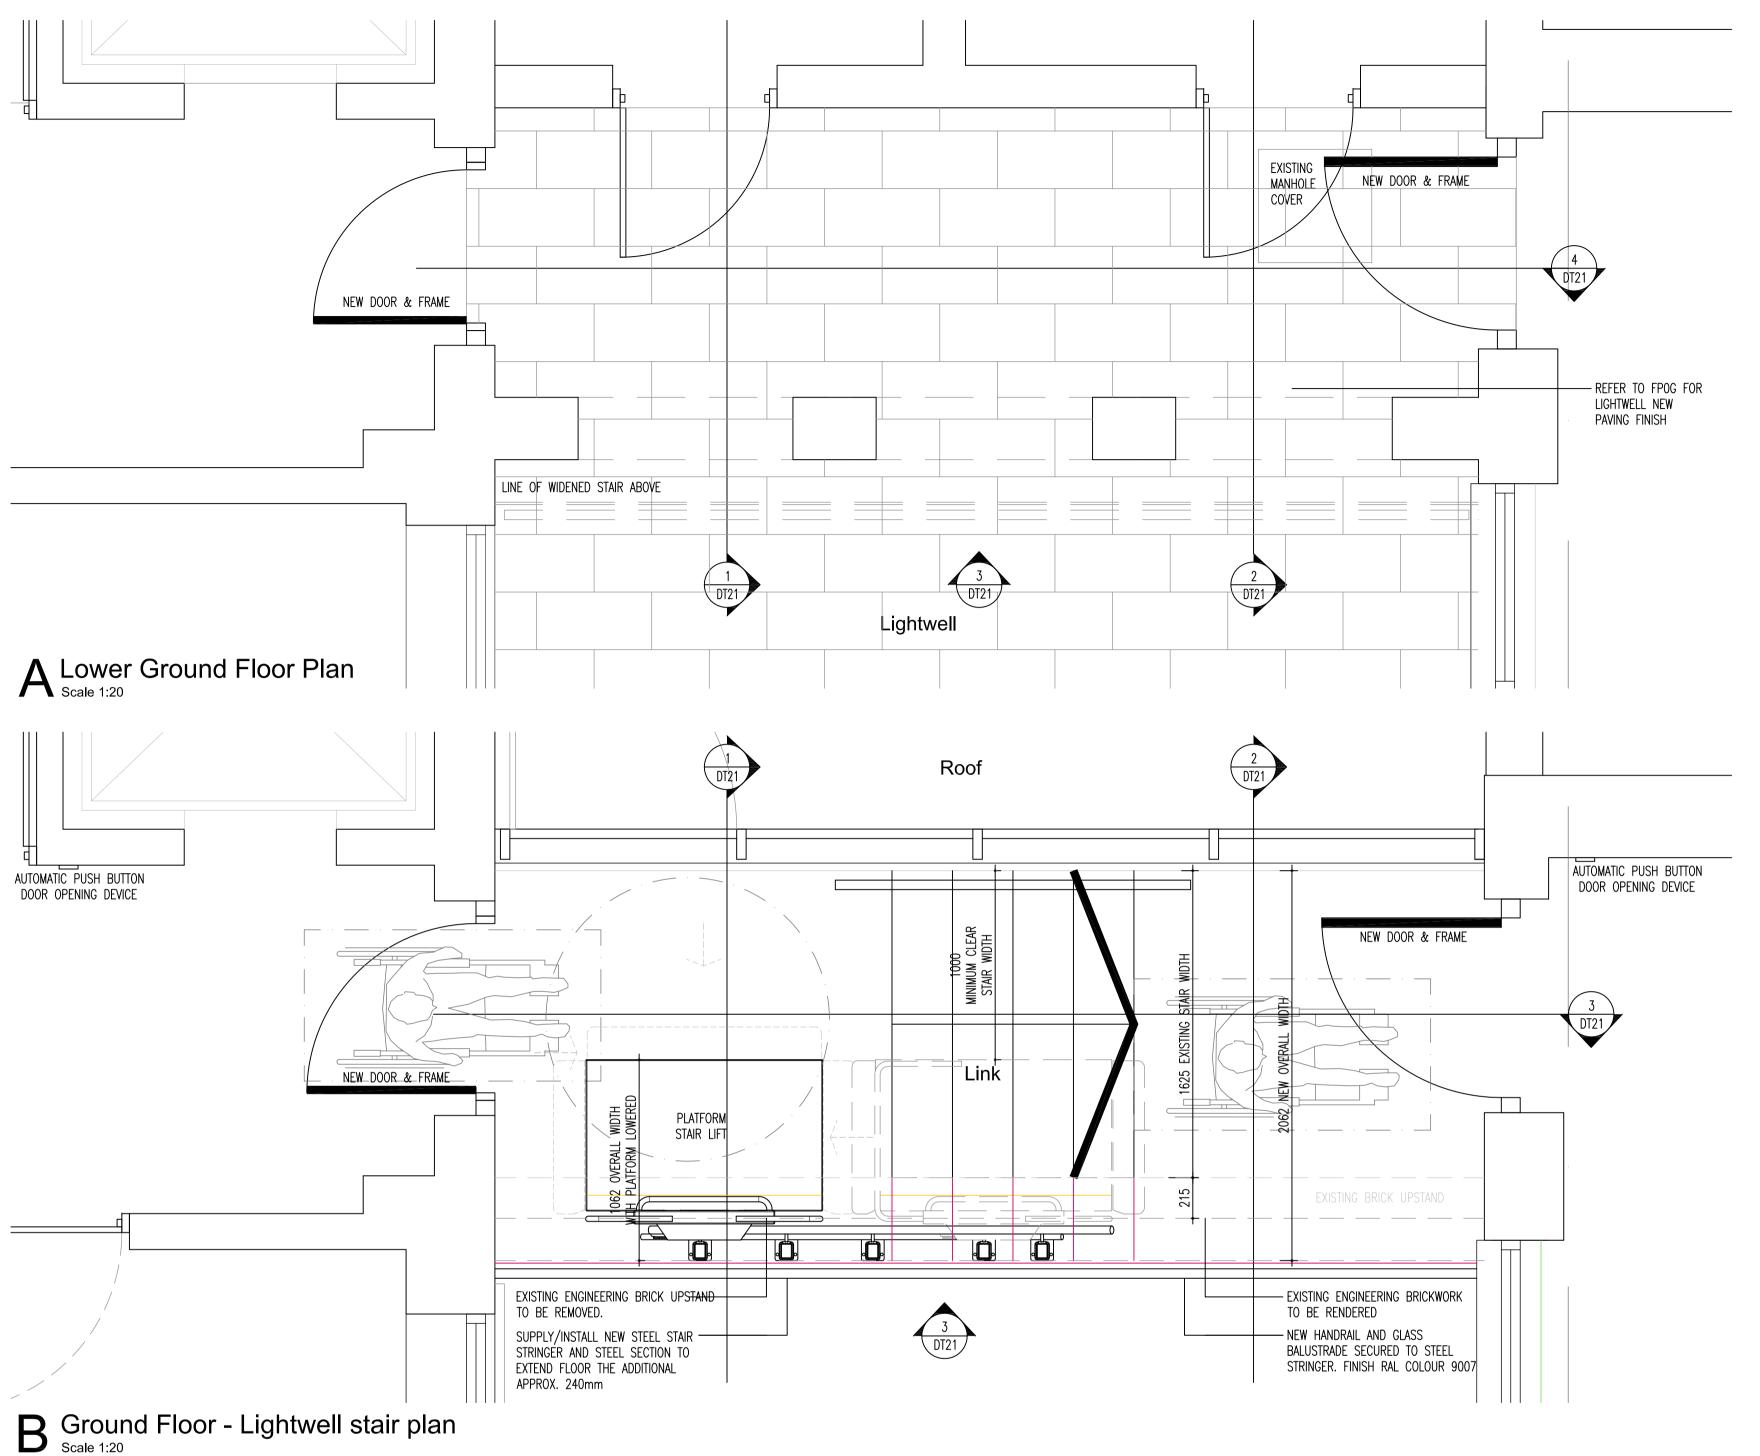


This drawing is the copyright of Mansfield Monk

All dimensions to be checked on site prior to commencement of work

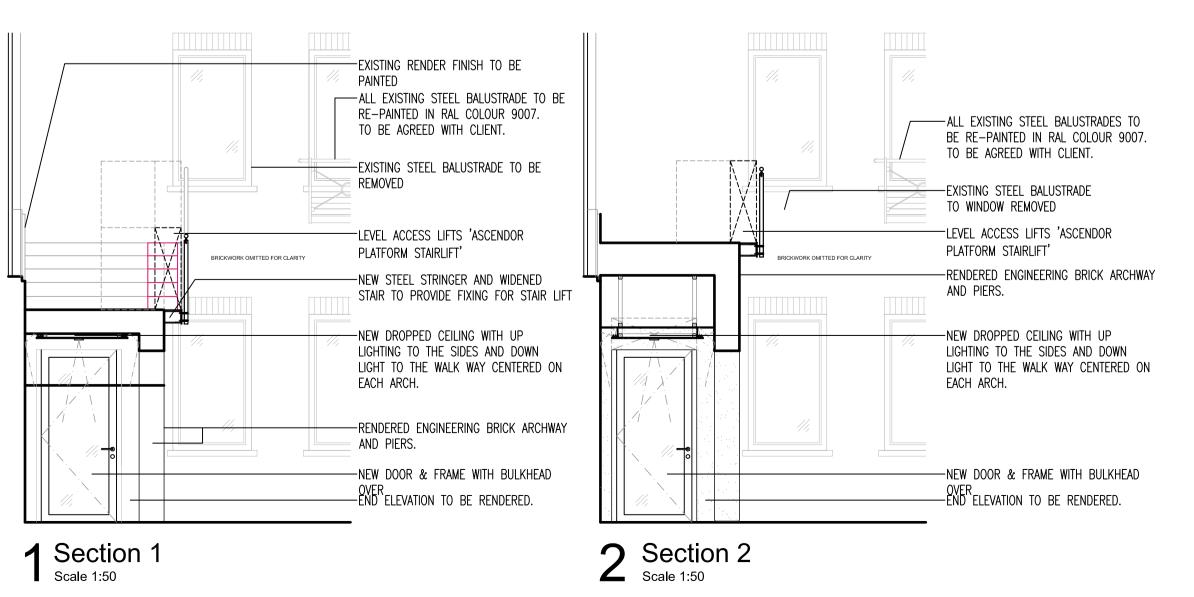

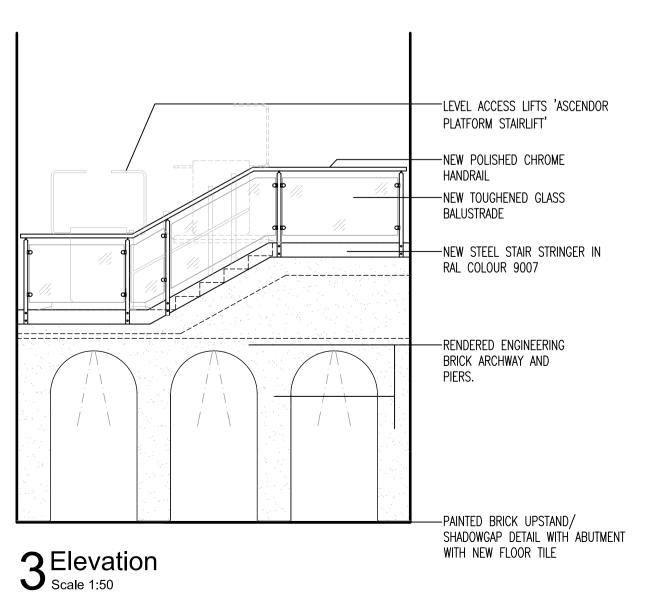

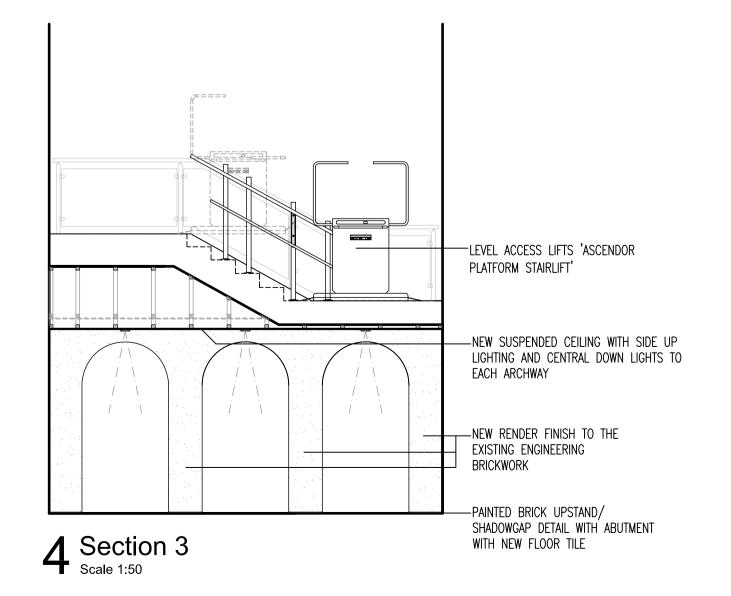

SPECIFICATION:

PROVIDE LINK BETWEEN STAIR LIFT AND AUTOMATIC POWER ASSISTED DOORS WITH PUSH TO OPEN BUTTONS TO EACH DOOR AT EITHER END OF LIGHTWELL.

PROVIDE LINK BETWEEN STAIR LIFT AND FIRE ALARM SYSTEM SO THAT THE STAIR LIFT FAILS SAFE/ CLOSED POSITION IN THE EVENT OF AN EMERGENCY. (BATTERY BACK UP).

PROVIDE LINK BETWEEN POWER ASSISTED DOORS/ PUSH BUTTON TO OPEN DEVICES SO THAT THE DOORS FAIL SAFE/ CLOSED IN THE EVENT OF AN EMERGENCY.

STAIR LIFT OPERATION/ MECHANISM TO OPERATE AS FOLLOWS:

APPROACH FROM GROUND FLOOR BEDFORD ROAD.

- 1. PUSH BUTTON DEVICE OPENS DOORS AND SENDS SIGNAL TO LOWER STAIR LIFT PLATFORM.
- 2. USER ENTERS ONTO PLATFORM LIFT AND USES CONTROLS TO OPERATE THE
- LIFTING DEVICE. 3. UPON ARRIVING AT THE TOP OF THE STAIR LIFT, THE DOOR AUTOMATICALLY
- THUS ALLOWING EASY ACCESS ON/ OFF THE STAIR LIFT WITH DOORS

AUTOMATICALLY OPEN/ CLOSE TO ASSIST USER AND NOT IMPEACHING WHEELCHAIR MOVEMENT SPACE.

APPROACH FROM GROUND FLOOR JOCKEY FIELDS ROAD.

- 1. PUSH BUTTON DEVICE SENDS SIGNAL TO CALL THE STAIR LIFT TO THE TOP OF THE STAIR AND THEN THE DOOR AUTOMATICALLY OPENS.
- 2. USER ENTERS ONTO PLATFORM LIFT AND USES CONTROLS TO OPERATE THE LIFTING DEVICE.
- 3. UPON ARRIVING AT THE BOTTOM OF THE STAIR LIFT, THE DOOR AUTOMATICALLY OPENS.


THUS ALLOWING EASY ACCESS ON/ OFF THE STAIR LIFT WITH DOORS AUTOMATICALLY OPEN/ CLOSE TO ASSIST USER AND NOT IMPEACHING WHEELCHAIR MOVEMENT SPACE.

IN THE EVENT OF AN EMERGENCY:


THE LIGHTWELL STAIR IS A FIRE ESCAPE ROUTE AND THEREFORE REQUIRES 1.2m MINIMUM CLEAR WIDTH TO ESCAPE. THEREFORE, THE STAIR LIFT SHOULD FAIL SAFE (CLOSED) IN THE EVENT OF AN EMERGENCY. I.E. THE STAIR LIFT SHOULD GO BACK TO ITS STARTING POSITION AND THE PLATFORM SHOULD CLOSE.


AUTOMATIC POWER ASSISTED OPENING DOORS SHOULD BE ABLE TO OPEN/ CLOSE AS NORMAL DOORS.



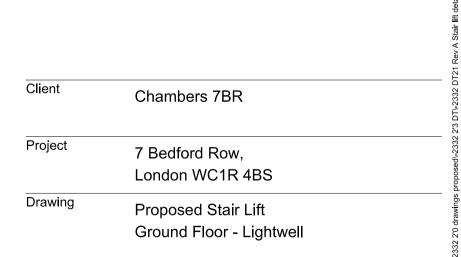

Scale 1:20/50@A1 Cad file -2332 DT21 Drawn by LC Project no. 172332 Checked by JM Drawing no. DT21 Date SEPT 2018 Revision A	Drawing Status	TENDER			2 drawin
Drawn byLCProject no.172332Checked byJMDrawing no.DT21DateSEPT 2018Revision	Scale	1:20/50@A1	Cad file	-2332 DT21	
Date SEPT 2018 Revision Δ	Drawn by	LC	Project no.	172332	7-/172
	Checked by	JM	Drawing no.	DT21	Δ.
	Date	SEPT 2018	Revision	А	

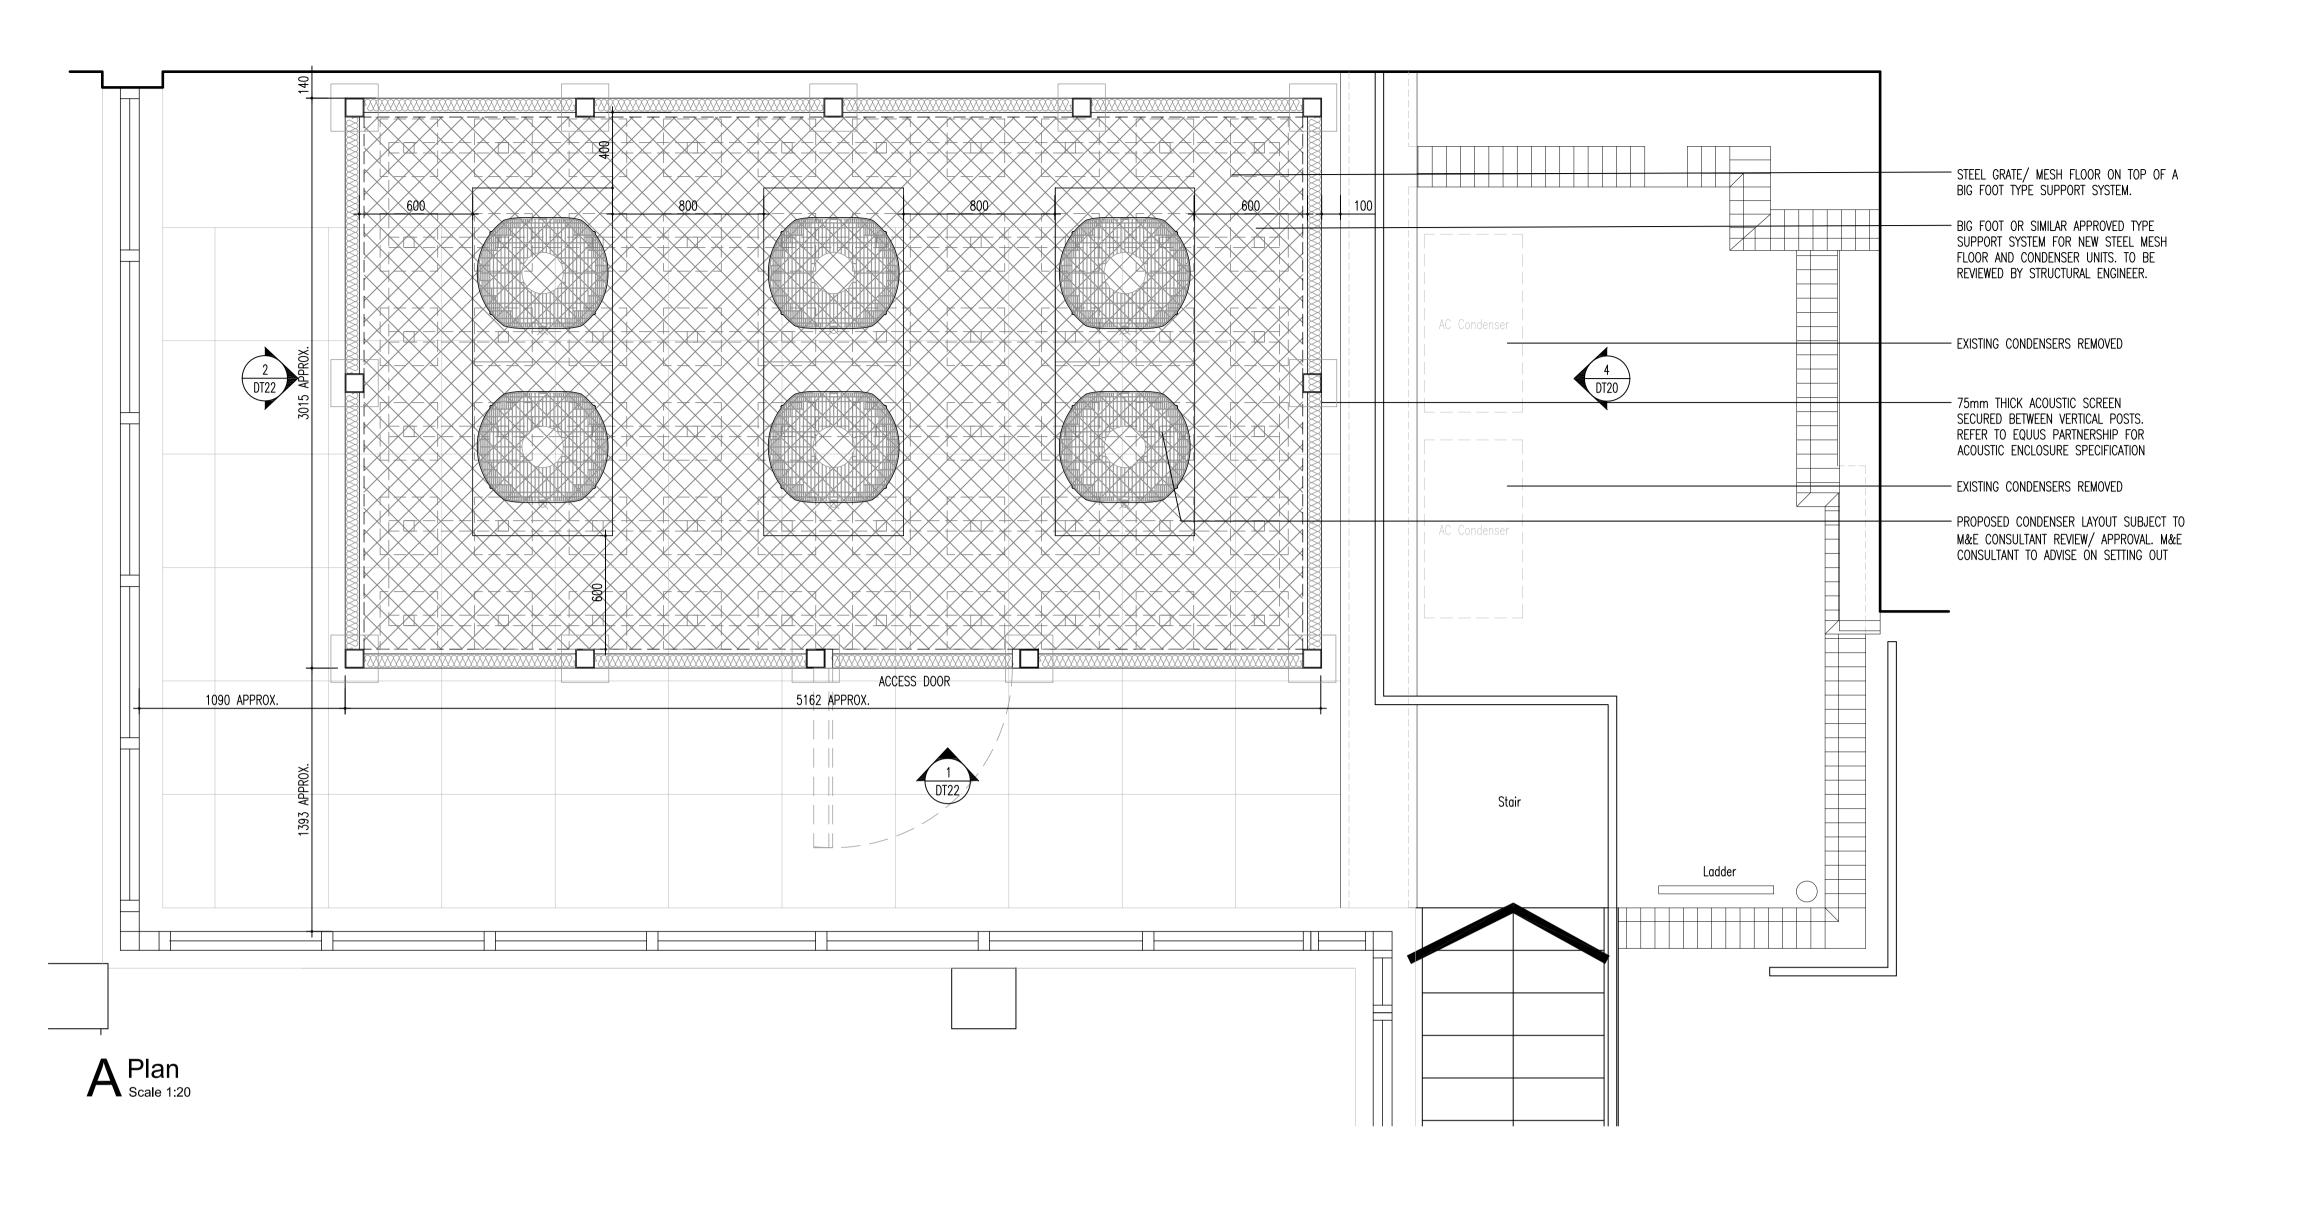

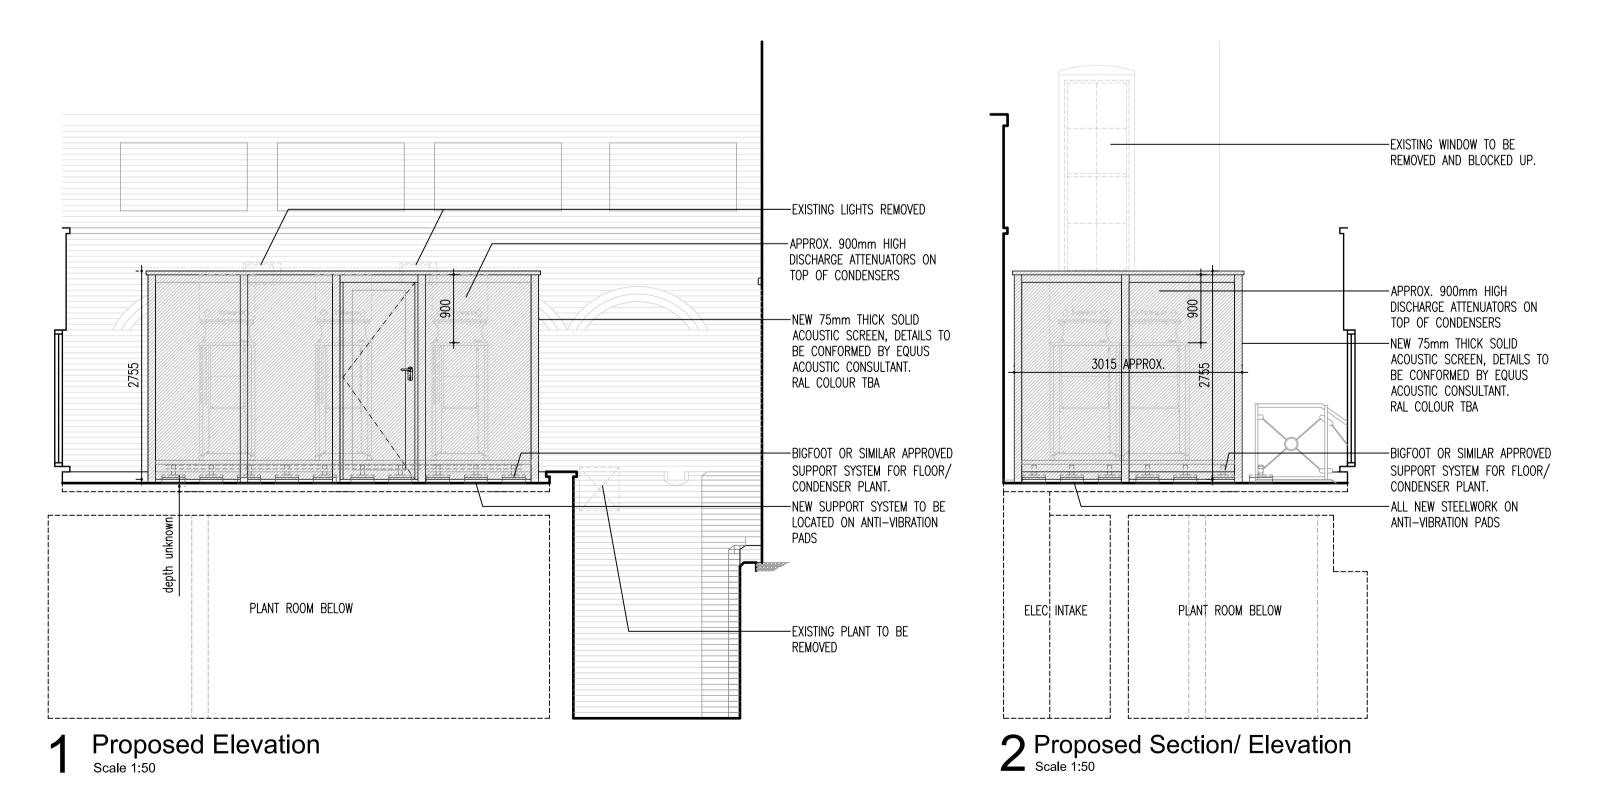

B LC Drawing revised following confirmation of acoustic/ plant data. 08.10.18
Issued for information and comment.

A LC Drawing revised following coordination meeting with acoustic consultant. 01.10.18

- LC Preliminary issue. 24.09.18


Rev. Drawn | Description | Date |




Client Chambers 7BR 7 Bedford Row, London WC1R 4BS Proposed A/C Plant Enclosure Plan & Elevations PRELIMINARY Cad file -2332 DT22 1:20/50@A1 Drawn by Project no 172332 Checked by Drawing no. DT22

Revision

SEPT 2018

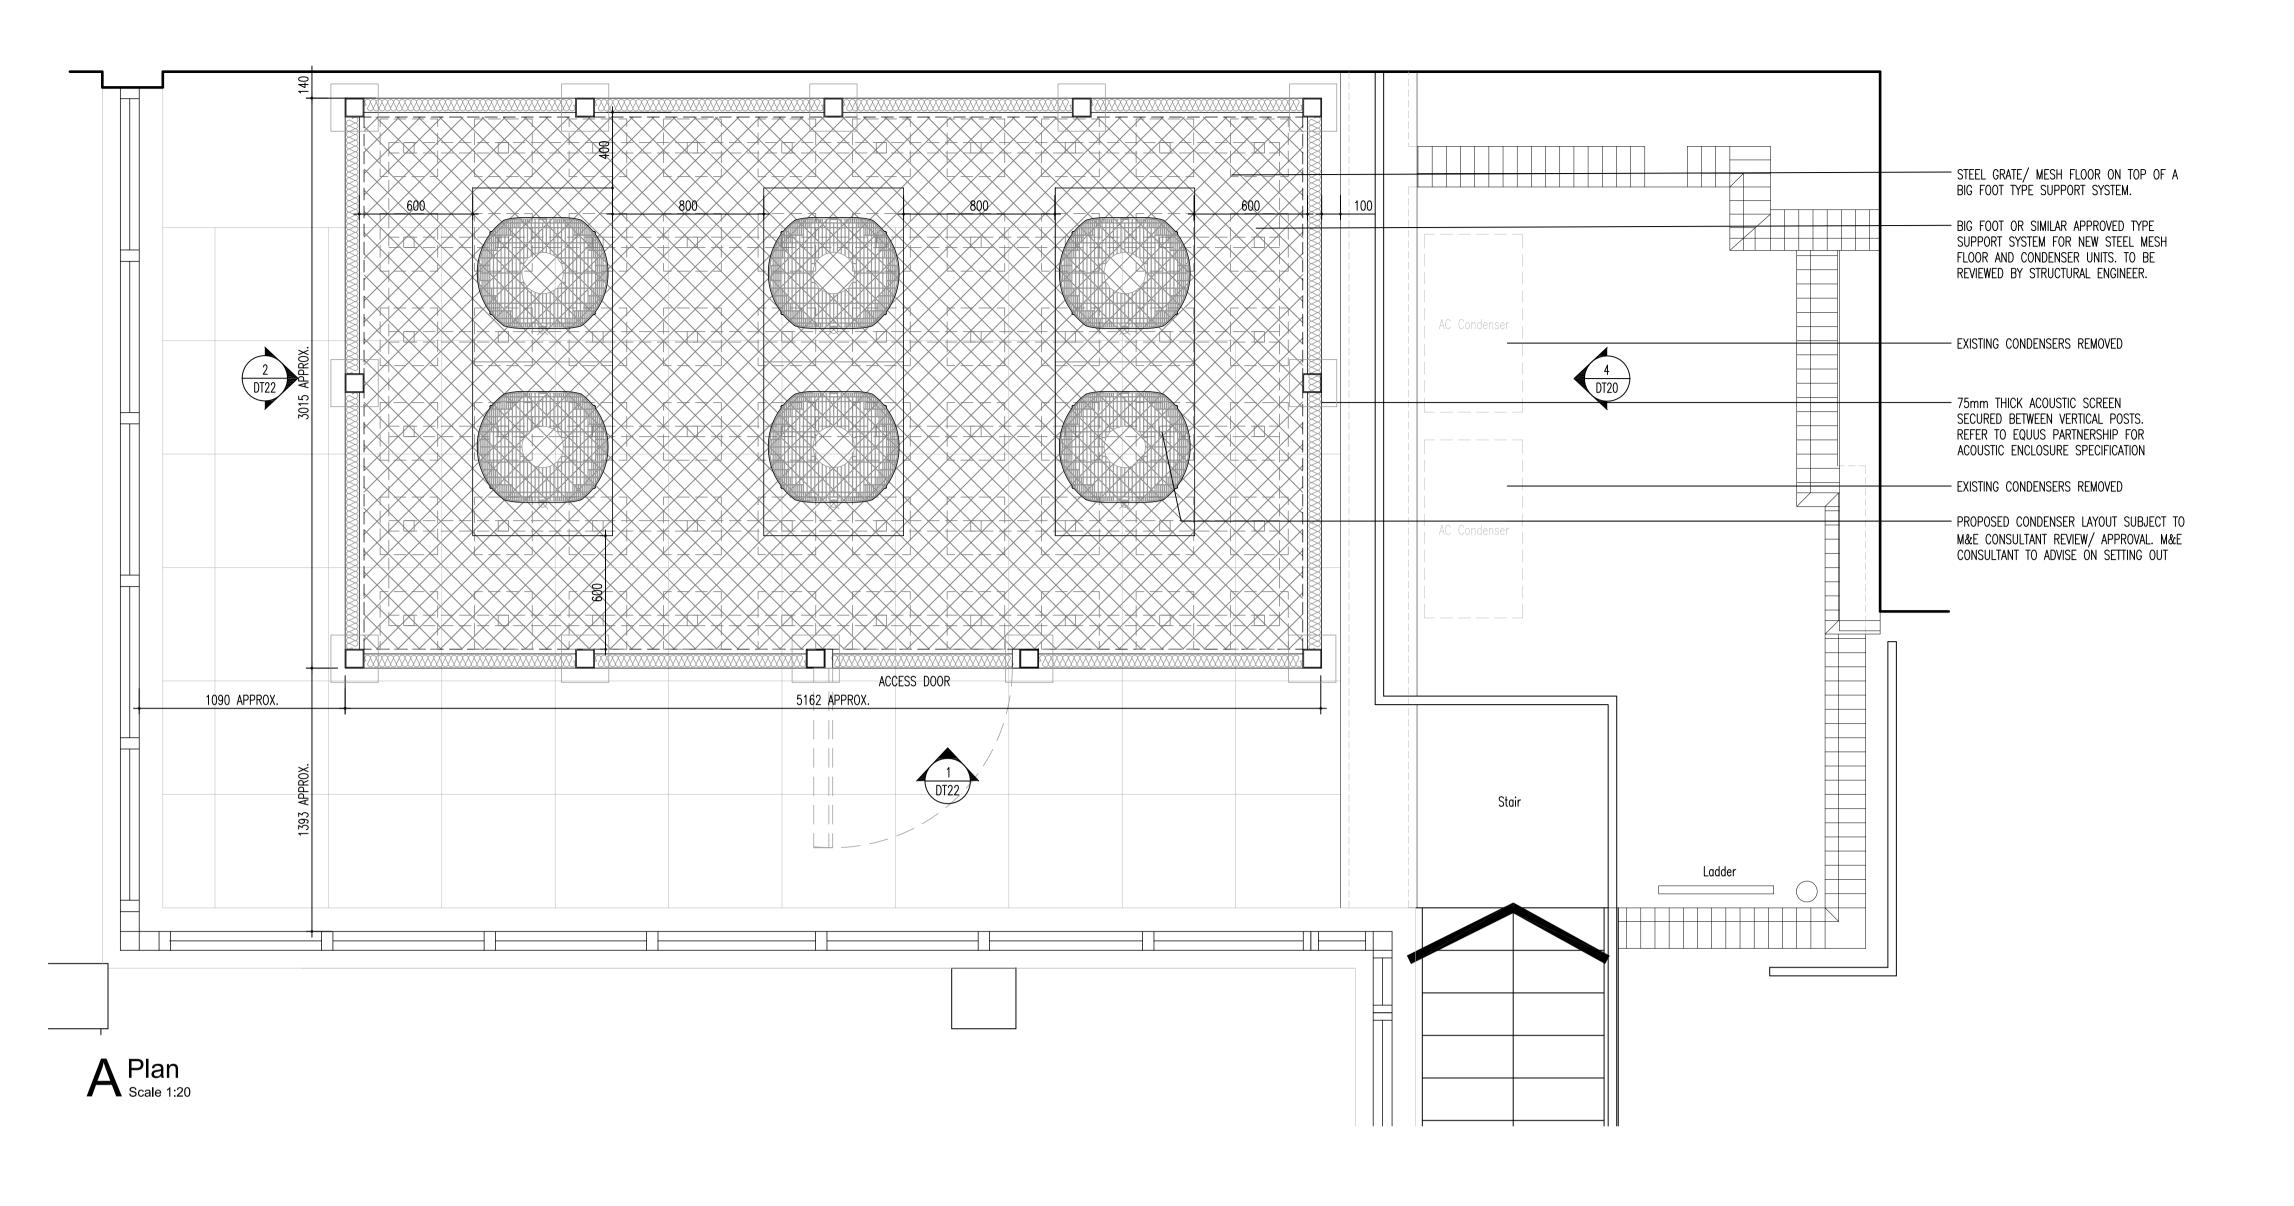

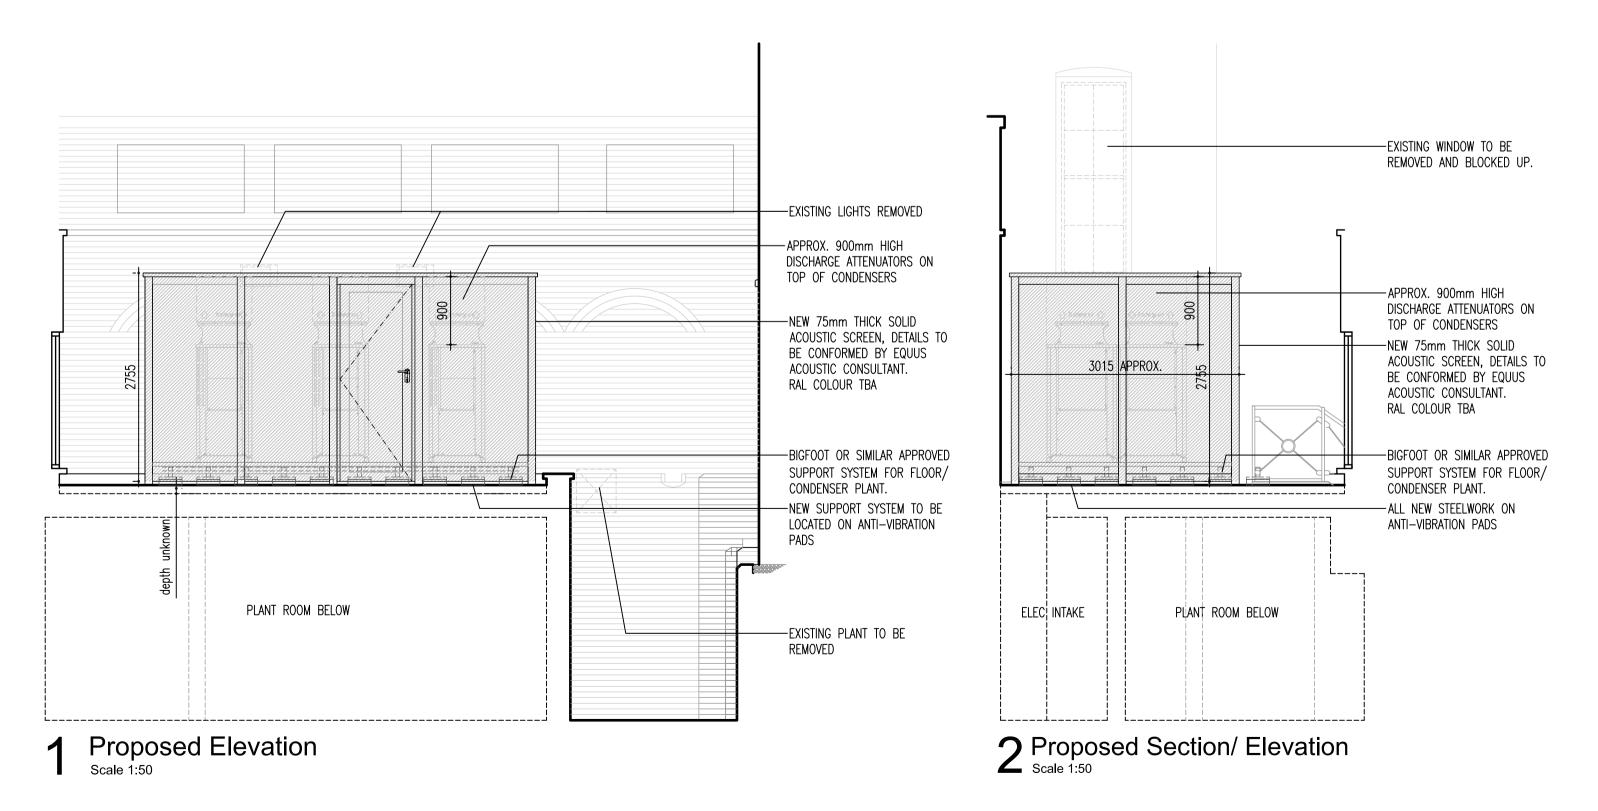

C LC Issued for Tender.
Drawing revised following confirmation of acoustic/ plant data.

B LC Drawing revised following confirmation of acoustic/ plant data.
Issued for information and comment.

A LC Drawing revised following coordination meeting with acoustic consultant.

- LC Preliminary issue.

11.10.18

08.10.18

15.10.18

16.10.18

17.10.18

18.10.19

19.10.19

10.10.19

10.10.19

10.10.1



Checked by

Client Chambers 7BR

Project 7 Bedford Row,
London WC1R 4BS

Drawing Proposed A/C Plant Enclosure
Plan & Elevations

PRELIMINARY

Scale 1:20/50@A1 Cad file -2332 DT22

Drawn by LC Project no. 172332

This drawing is the copyright of Mansfield Monk
All dimensions to be checked on site prior to commencement of work

Library House High Street Ingatestone Essex CM4 9EU T 01277 351981 W www.mansfieldmonk.co.uk

SEPT 2018

Drawing no.

Revision

DT22