



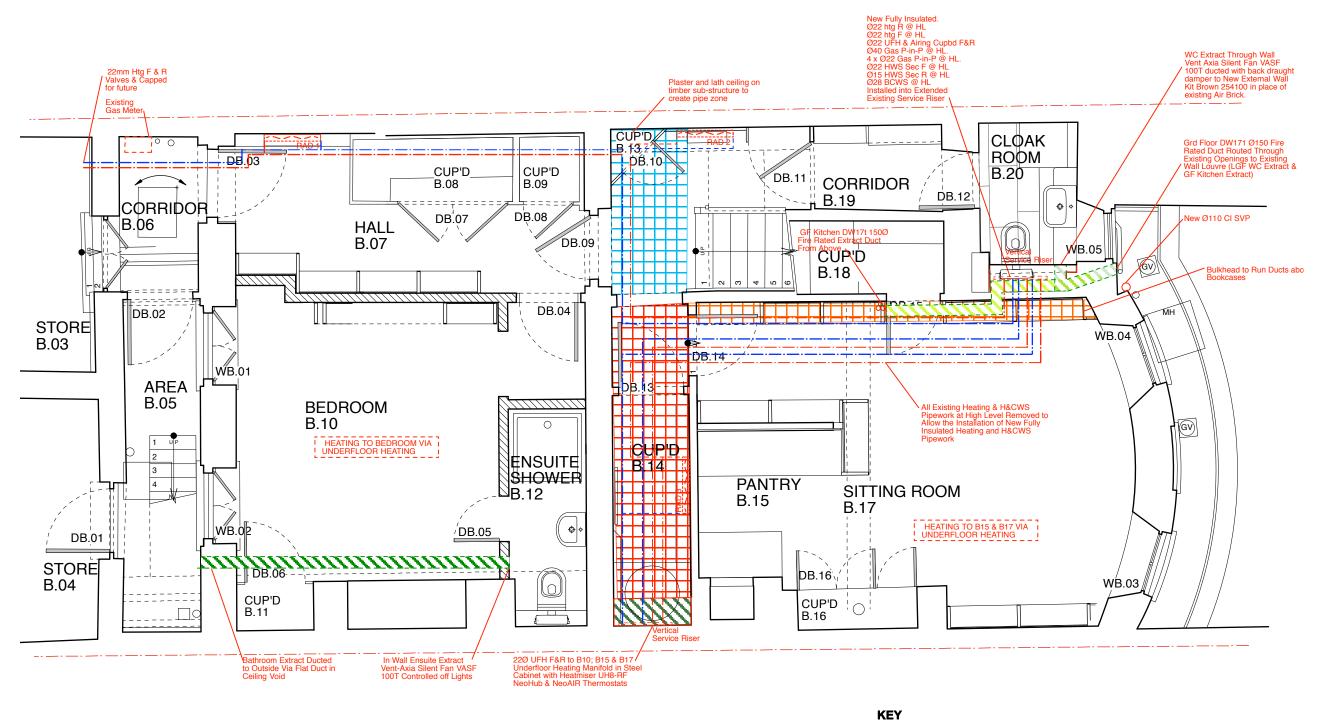

C20th Proposed Elements Proposed New Floor Proposed New Ceiling 24 Church Row Title: Proposed Lower Ground Floor Builders Works Plan Drawing No: 0919317/Sk81 Scale 1: 50 @ A3

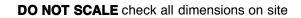



1:50

LOWER GROUND FLOOR PLAN

Butler Hegarty ArchitectsUnit 208 A2, 159-163 Marlborough Road, London, N19 4NF tel: 020 72638933 email: mail@butlerhegartyarchitects.co.uk



Plaster and Lath Ceiling to Create Pipe Zone

Bulkhead to Run Ducts
Above Bookshelves


Lowered Plasterboard Ceiling Electrical / Pipe zone

Radiator Pipes Below Floors Pipes at High Level

ZZZZ Duct in Ceiling Void

24 Church Row

Title: Proposed Lower Ground Floor Mechanical Services Installation Builders Works Plan Drawing No: 0919317/Sk75 Scale 1: 50 @ A3

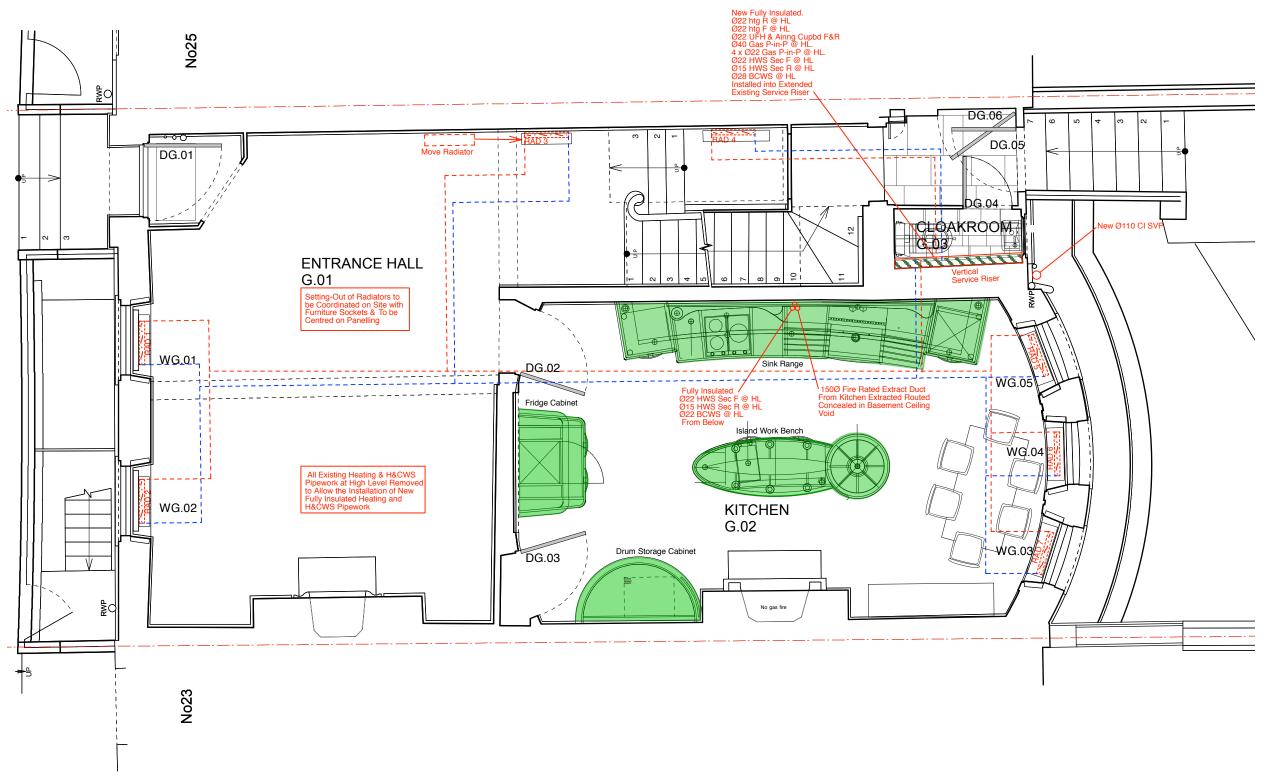

DO NOT SCALE check all dimensions on site



GROUND FLOOR PLAN

Butler Hegarty ArchitectsUnit 208 A2, 159-163 Marlborough Road, London, N19 4NF tel: 020 72638933 email: mail@butlerhegartyarchitects.co.uk





KEY

Radiator
 Pipes Below Floors
 Pipes at High Level

24 Church Row

Title: Proposed Ground Floor Mechanical Services Installation Builders Works Plan Drawing No: 0919317/Sk76 Scale 1: 50 @ A3

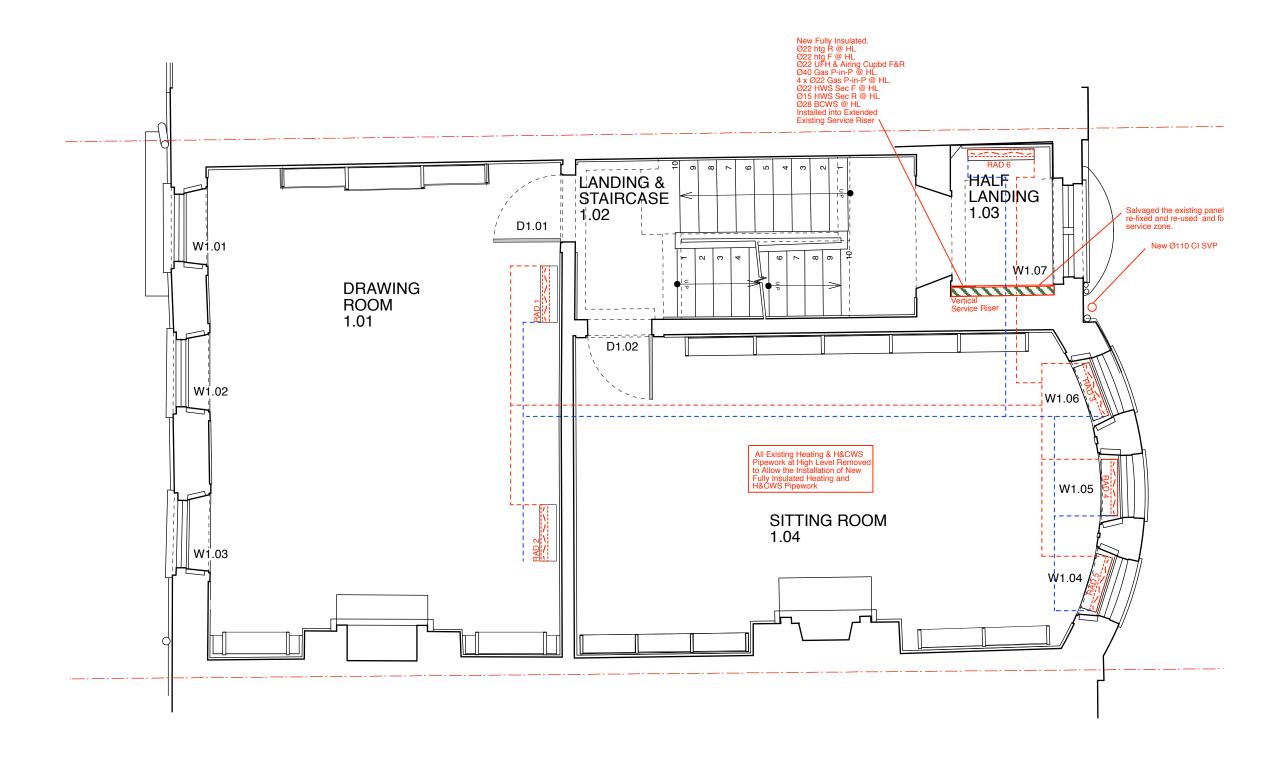

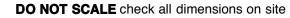

1:50

FIRST FLOOR PLAN

Butler Hegarty ArchitectsUnit 208 A2, 159-163 Marlborough Road, London, N19 4NF tel: 020 72638933 email: mail@butlerhegartyarchitects.co.uk





KEY

[5525525] Radiator Pipes Below Floors -----

24 Church Row

Title: Proposed First Floor Mechanical Services Installation Builders Works Plan Drawing No: 0919317/Sk77 Scale 1: 50 @ A3

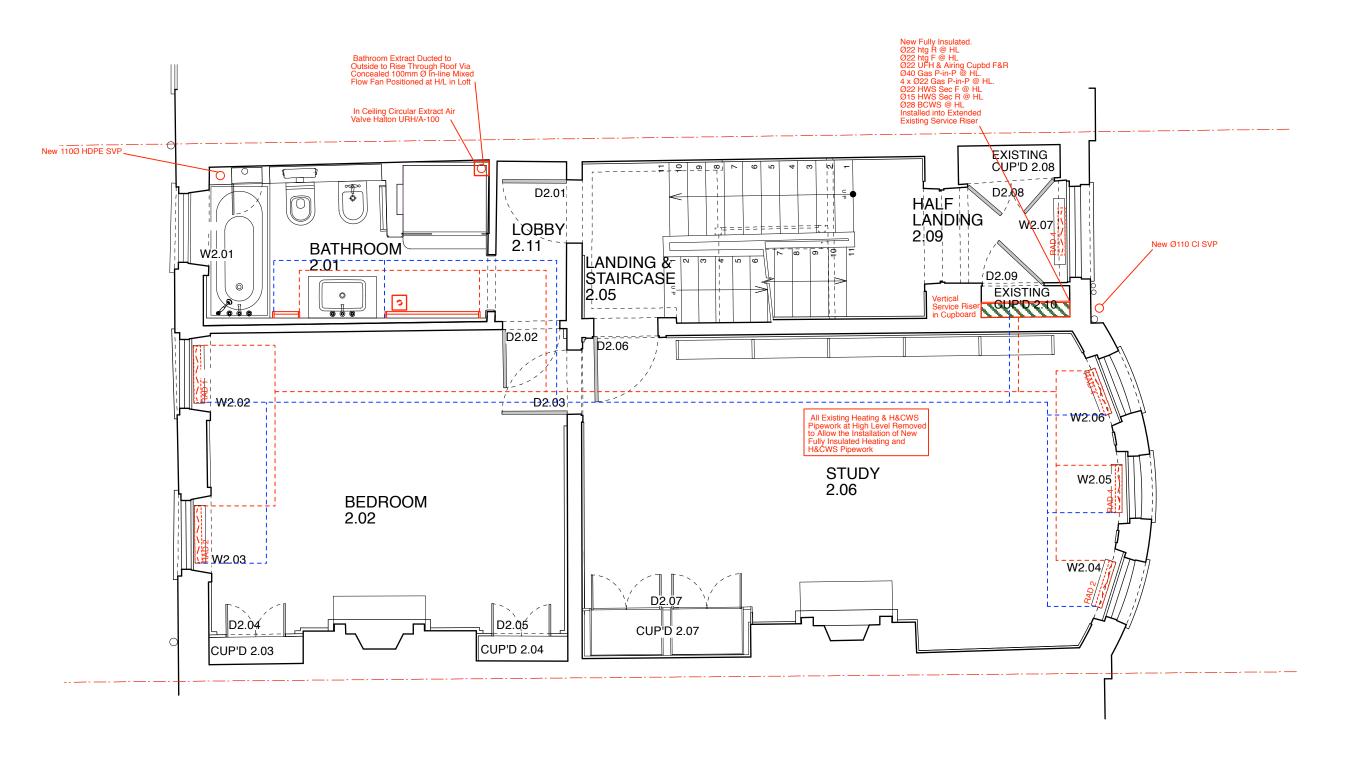

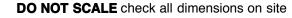



SECOND FLOOR PLAN


Butler Hegarty ArchitectsUnit 208 A2, 159-163 Marlborough Road, London, N19 4NF tel: 020 72638933 email: mail@butlerhegartyarchitects.co.uk




KEY

Radiator Pipes Below Floors

24 Church RowTitle: Proposed Second Floor Mechanical Services Installation Builders Works Plan
Drawing No: 0919317/Sk78 Scale 1: 50 @ A3

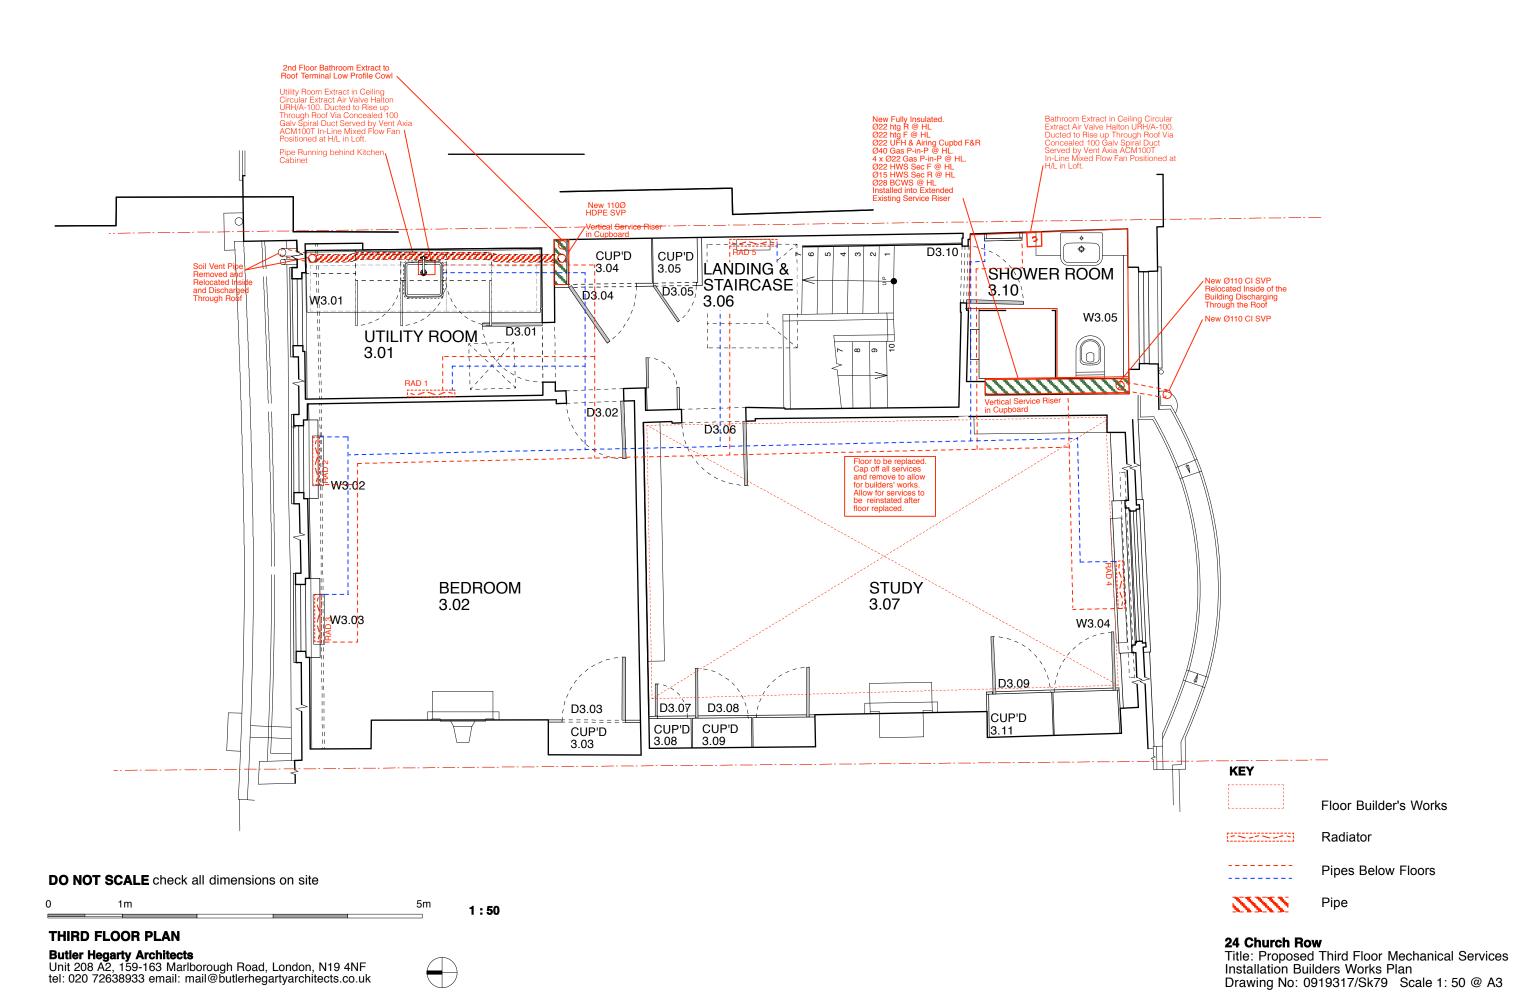

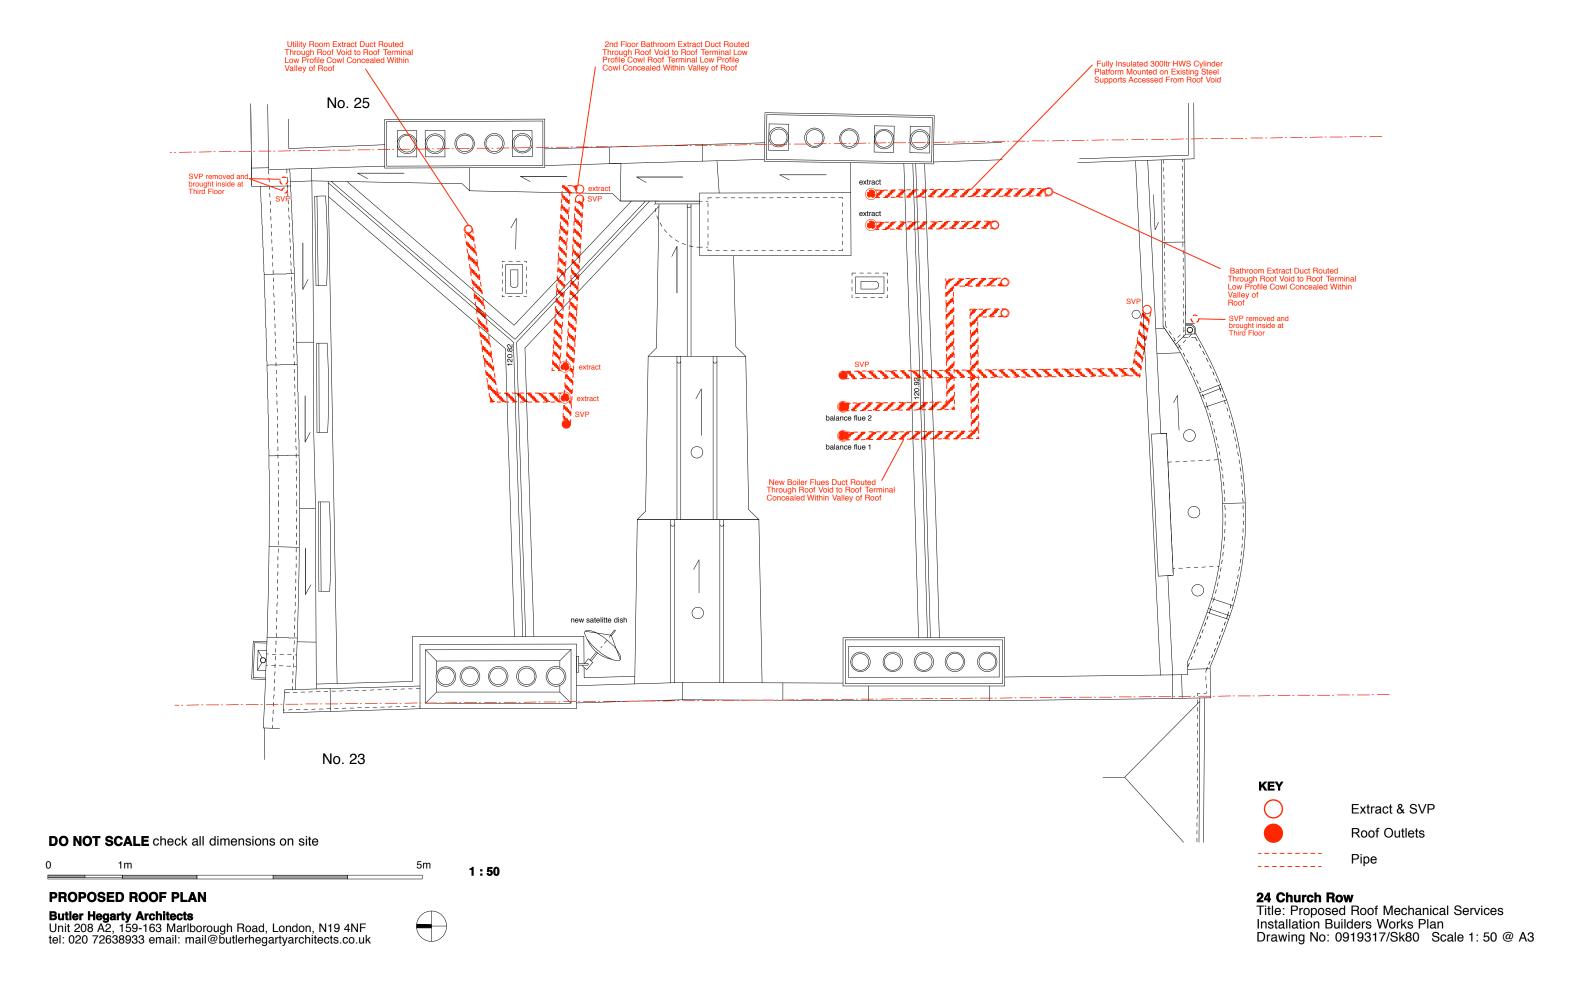




EXAMPLES OF PALETED FLOOR REPAIRS WHERE BOARDS HAD BEEN SCREWED INTO POSITION




DO NOT SCALE check all dimensions on site

NA	5m	1m					

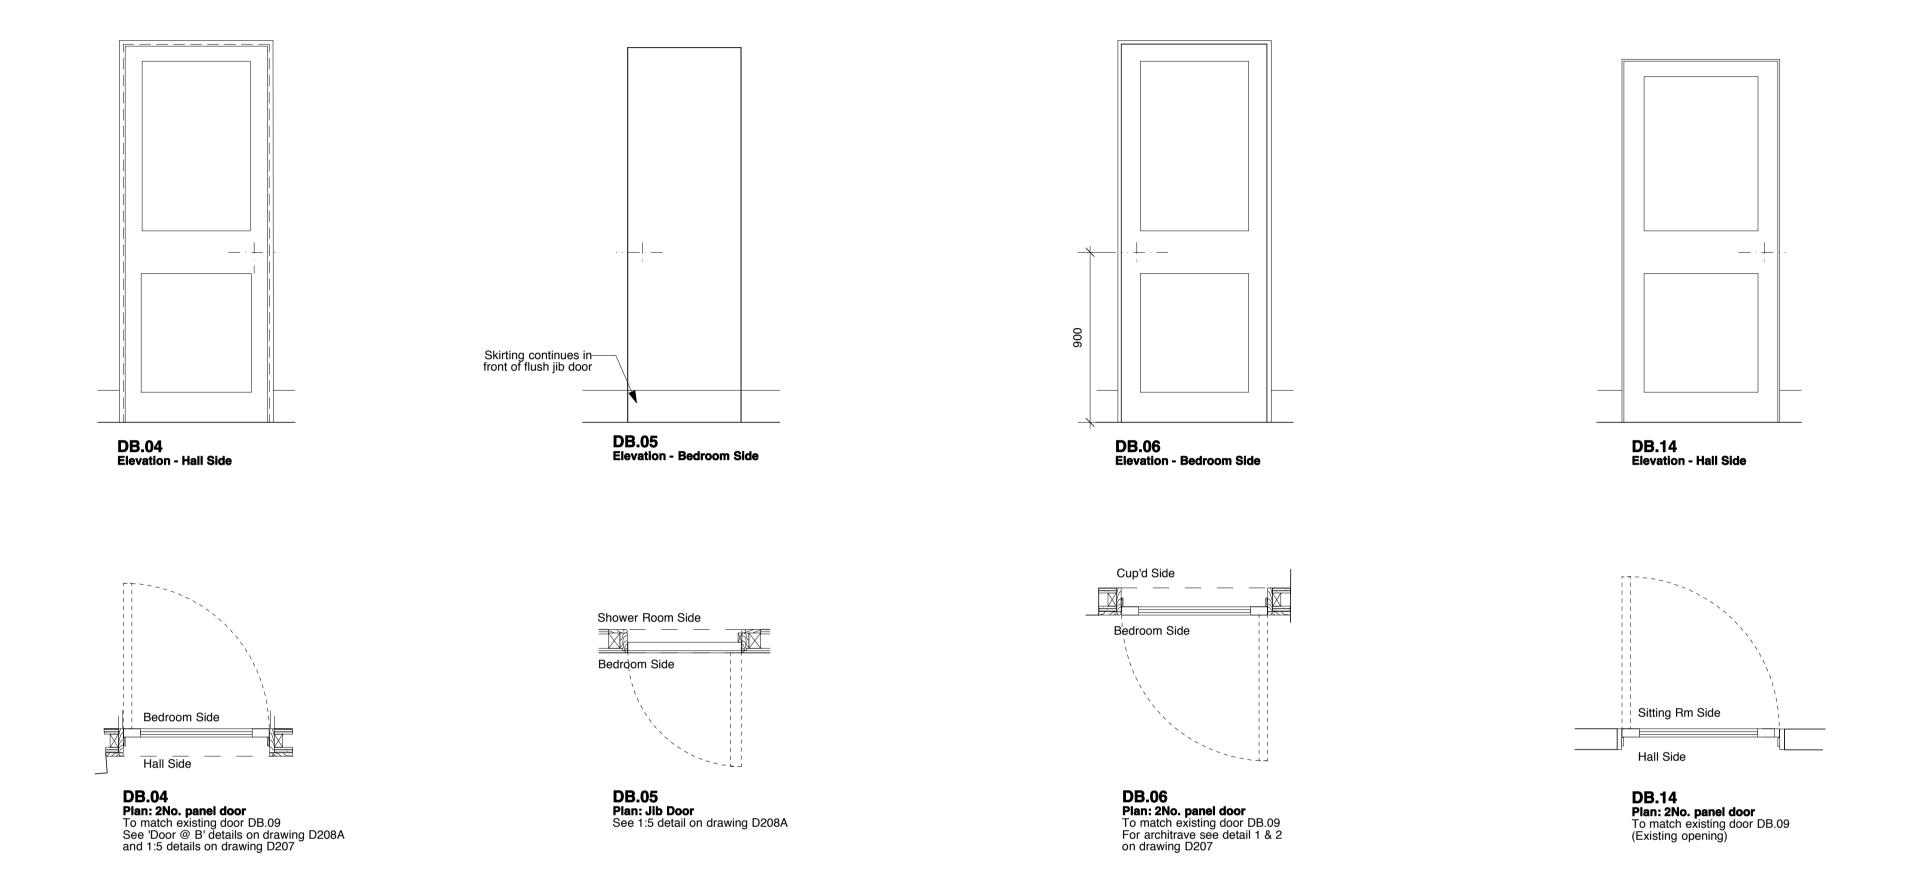

INTERNAL DOC	OR SCHEDULE								
Door No.	Location	Туре	Material	Finish	Existing Opening	Structural opening	Leaf size	Fire rating	Notes
						height x width	height x width x thickness		
Lower Ground Floor									For skirting see detail 3 on drawing D203
									Ironmongery TBC
									All sizes are approximate, confirm dimensions on site
DB.04	BEDROOM B.10	2 panelled	Timber Door	Painted		2000 x 825	1981 x 770 x 44	FD20	To match existing door DB.09, see door reveal details 'Door @ B' on drawing D208A and 1:5 jamb details on drawing D207.
DB.05	SHOWER B.12	Flush jib door	Timber Door	Painted		1987 x 674	1981 x 600 x 56		Jib door with skimmed plasterboard face to bedroom elevaton, see 1:5 details on drawing D208A.
DB.06	CUP'D B.11	2 panelled	Timber Door	Painted		2000 x 825	1981 x 770 x 44		To match existing door DB.09. For architrave see detail 1 & 2 on drawing D207.
DB.14	SITTING RM B.17	2 panelled	Timber Door	Painted		1920 x Confirm on site	1914 x 805 x 44	FD20	To match existing door DB.09

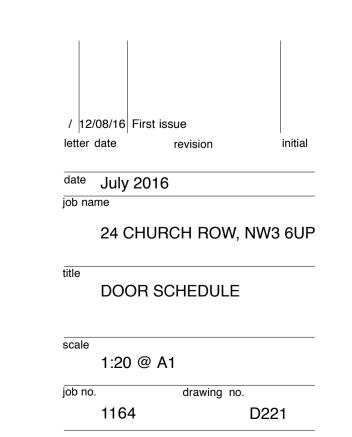

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