



**SITE LOCATION**  
(Scale 1:50000)

Ordnance Survey map extract based upon Landranger map series with the permission of the controller of Her Majesty's Stationery Office Licence No. 0100023487 Crown copyright.

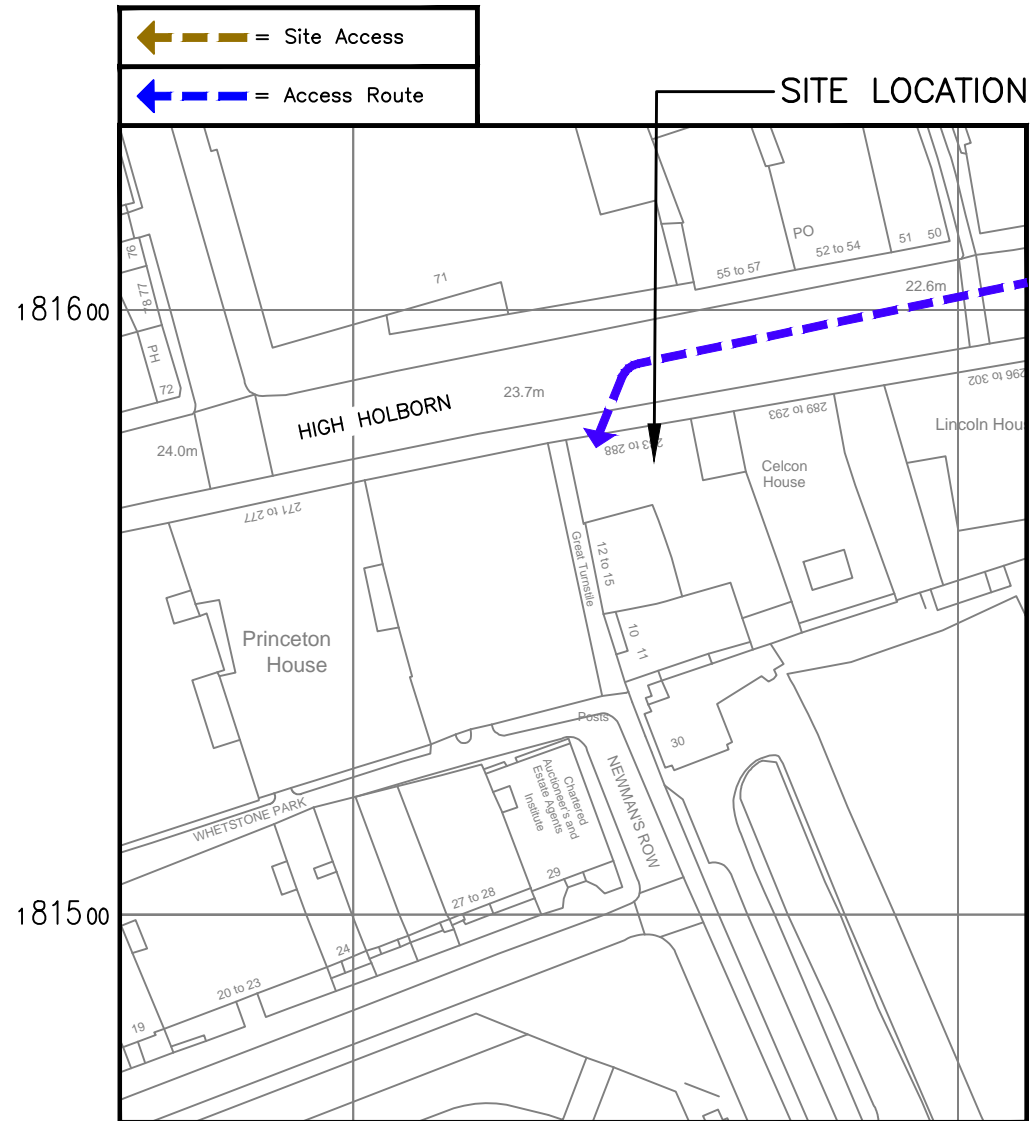


**SITE PHOTOGRAPH**

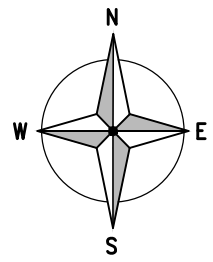

530800 530900  
181500 181600

**DETAILED SITE LOCATION**  
(Scale 1:1250)

Based upon Ordnance Survey map extract with the permission of the Controller of Her Majesty's Stationery Office. Crown copyright. Licence No. 100020449

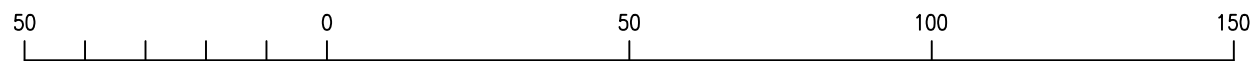

ORIGINAL SCALE AT A3 - 1:1250

ALL DIMENSIONS IN METRES

Notes:  
1 ALL DIMENSIONS ARE IN MM UNLESS NOTED OTHERWISE  
2 DRAWING TO SCALE WHEN PRINTED AT A3

N.G.R. E: 530833 N: 181578

CONCESSION REQUIRED	NO
---------------------	----

**DIRECTIONS TO SITE:**  
FROM THE END OF THE M4 HEAD SOUTH EAST ON THE A4 TOWARDS THE A3220 WARWICK ROAD. AT THE ROUNDABOUT TAKE THE 2ND EXIT ONTO THE A40. CONTINUE ONTO MARYLEBONE ROAD AND TURN RIGHT AT EVERSOLT STREET. FOLLOW THE A4200 ENTERING TOLL ZONE (WOBURN PLACE). TURN LEFT AT THE A40/THEOBOLDS ROAD, RIGHT AT DRAKE STREET AND ARRIVE AT HIGH HOLBORN.

A	Issued for Approval	SPD	DS	27.03.18
REV	MODIFICATION	BY	CH	DATE




Cell Name		Opt.
PENDEREL HOUSE		-
Cell ID No		
CTIL	TEF	VF
E319835	004868	80449
140779		


**Site Address / Contact Details**  
PENDEREL HOUSE  
283 HIGH HOLBORN  
LONDON  
GREATER LONDON  
WC1R 5DJ

Drawing Title: SITE LOCATION MAPS				
Purpose of issue: PLANNING				Dwg Rev:
Drawing Number: 100				A
Surveyed By: MS		Original Sheet Size: A3		Pack Issue:
Drawn: SPD	Date: 27.03.18	Checked: DS	Date: 27.03.18	A

The drawings comply with TEF & Vodafone Standard ICNIRP guidelines.  
Designed in accordance with CTIL document: SDN0008

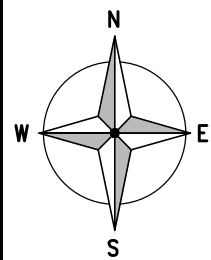


← = Site Access  
 ← = Access Route

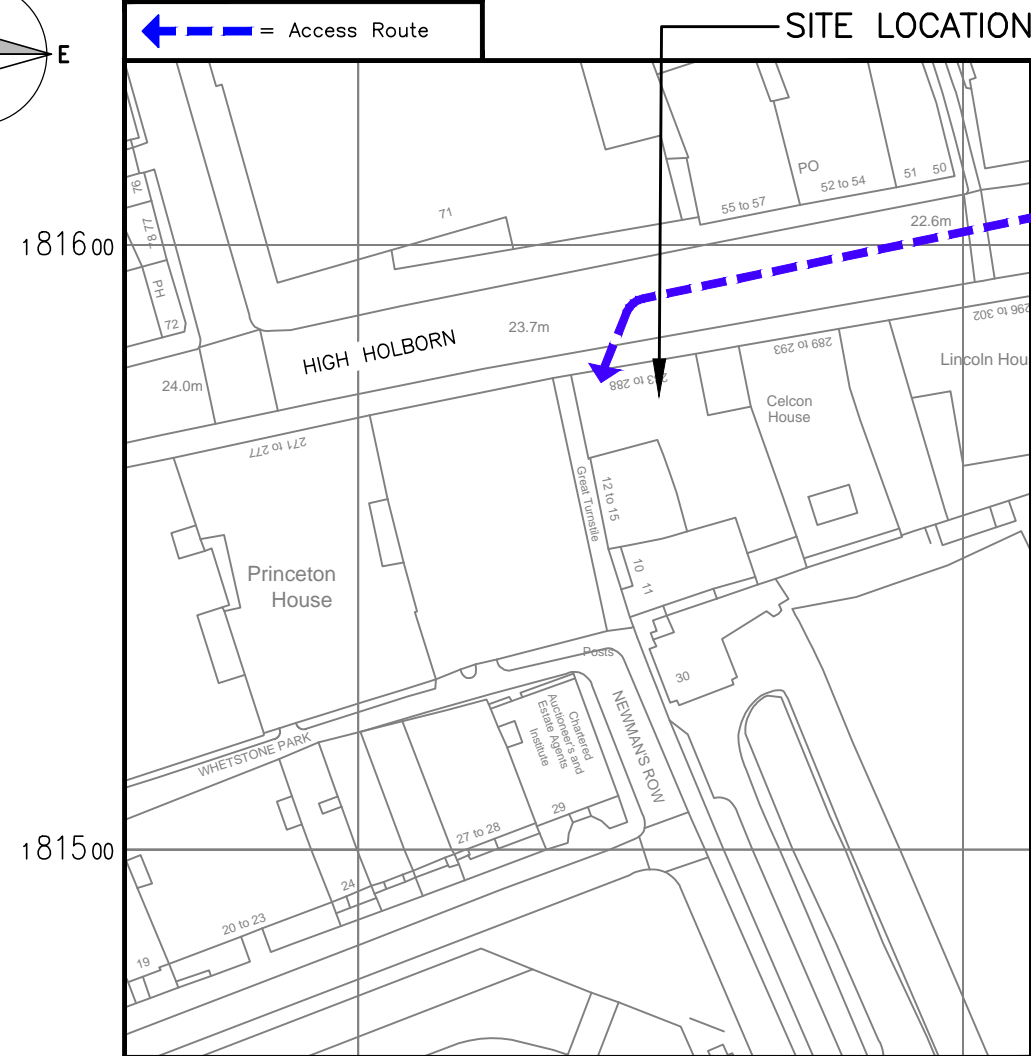

**DETAILED SITE LOCATION**  
 (Scale 1:1250)

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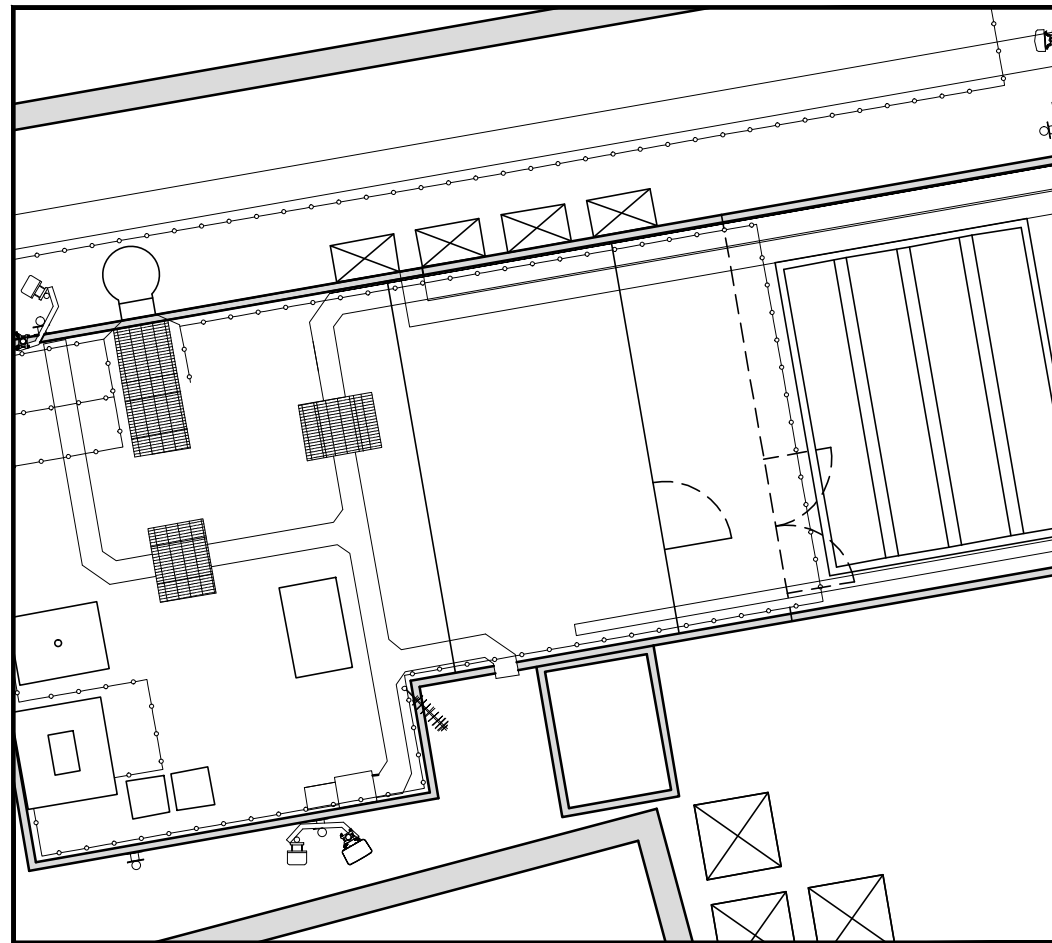


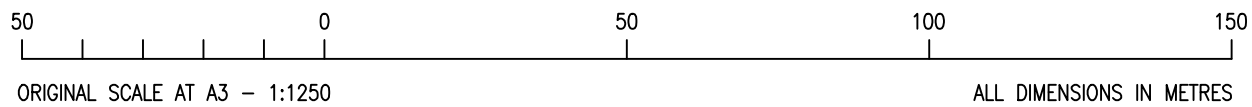ORIGINAL SCALE AT A3 - 1:1250


ALL DIMENSIONS IN METRES

**The drawings comply with TEF & Vodafone Standard ICNIRP guidelines.**  
 Designed in accordance with CTIL document: SDN0008

SITE LOCATION



**DEMISE PLAN**  
 (1:100)

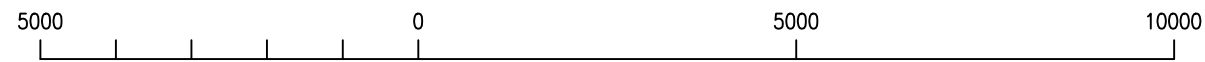

ORIGINAL SCALE AT A3 - 1:100

ALL DIMENSIONS IN MILLIMETRES

Notes:  
 1 ALL DIMENSIONS ARE IN MM UNLESS NOTED OTHERWISE  
 2 DRAWING TO SCALE WHEN PRINTED AT A3

N.G.R. E: 530833 N: 181578

CONCESSION REQUIRED NO

NOTES

A	Issued for Approval	SPD	DS	27.03.18
REV	MODIFICATION	BY	CH	DATE



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PENDEREL HOUSE	-

Cell ID No		
CTIL	TEF	VF
E319835	004868	80449
140779		

Site Address / Contact Details  
 PENDEREL HOUSE  
 283 HIGH HOLBORN  
 LONDON  
 GREATER LONDON  
 WC1R 5DJ


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Purpose of issue:  
 PLANNING


Drawing Number:  
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Surveyed By: MS Original Sheet Size: A3 Pack Issue: A

Drawn: SPD Date: 27.03.18 Checked: DS Date: 27.03.18



ELEVATION

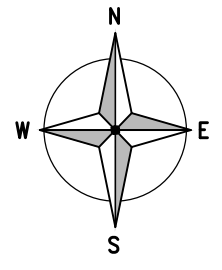


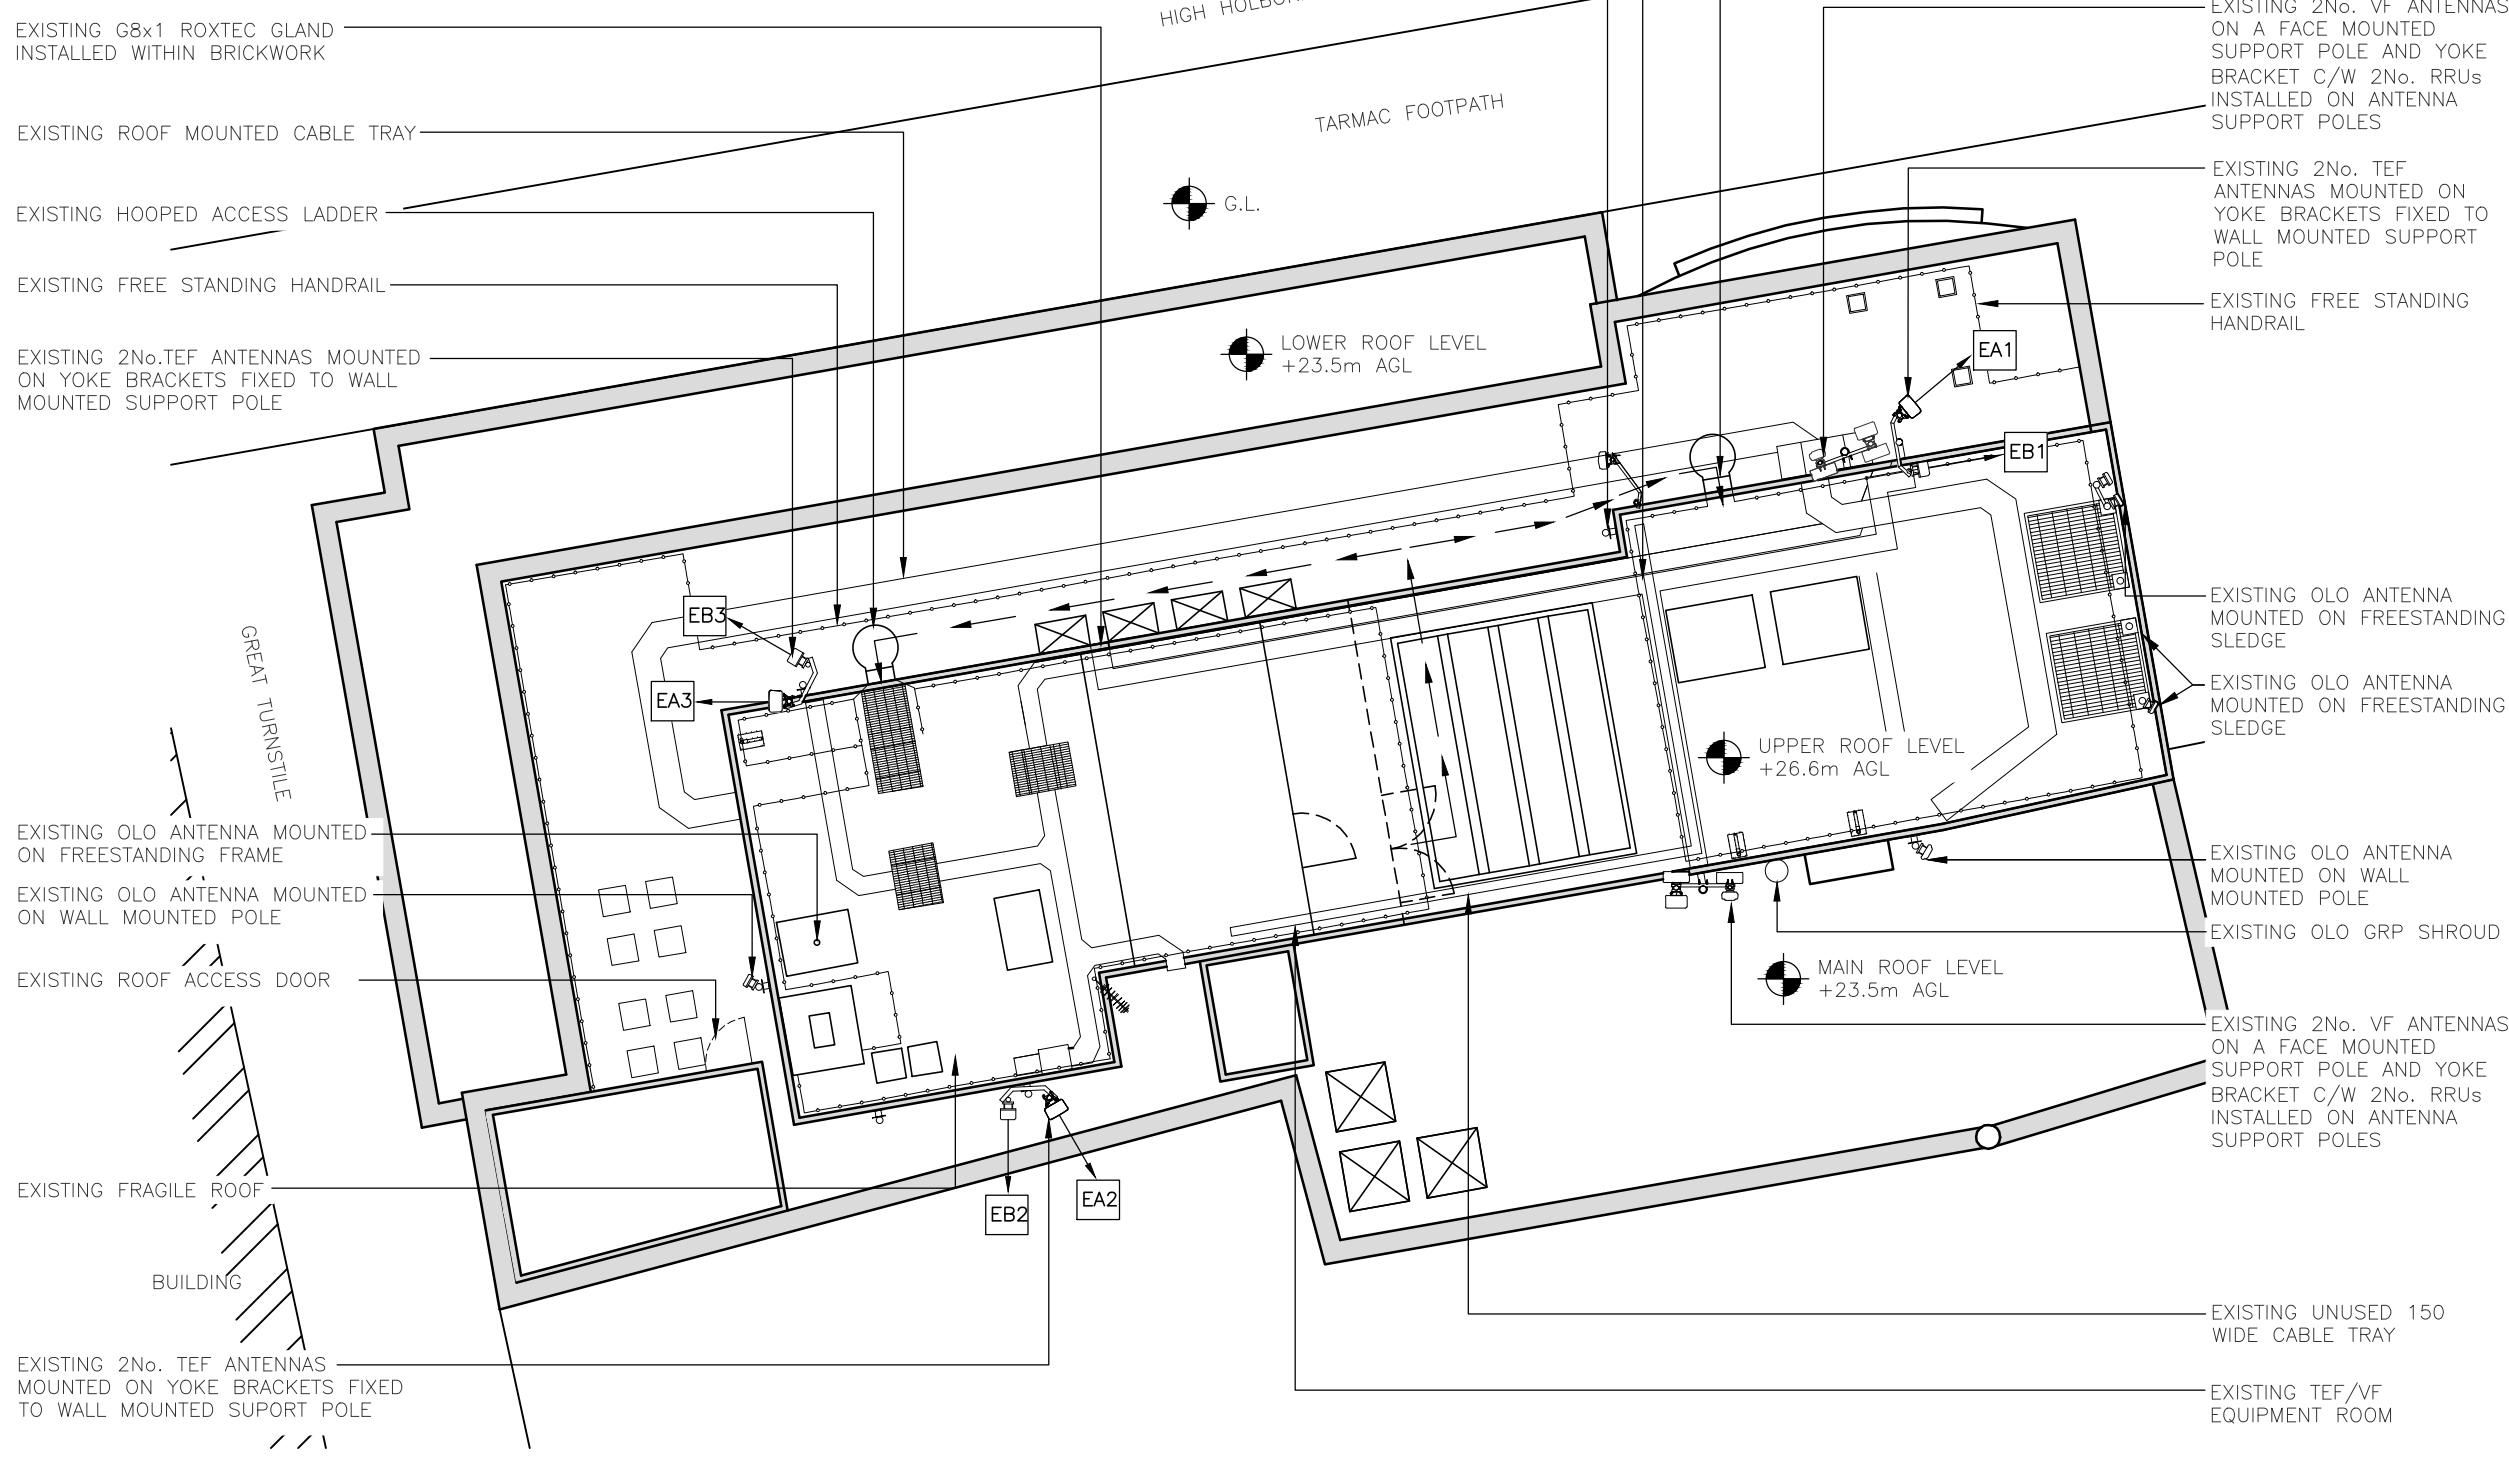Notes:  
 1 ALL DIMENSIONS ARE IN MM UNLESS NOTED OTHERWISE  
 2 DRAWING TO SCALE WHEN PRINTED AT A3

N.G.R | E: 530833 | N: 181578  
 CONCESSION REQUIRED | NO

NOTES:

A	Issued for Approval	SPD	DS	27.03.18
REV	MODIFICATION	BY	CH	DATE

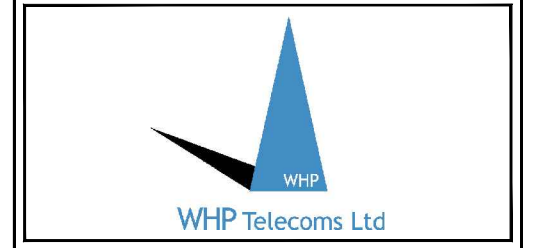

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Cell ID No		
CTIL	TEF	VF
E319835	004868	80449
140779		

Site Address / Contact Details  
 PENDEREL HOUSE  
 283 HIGH HOLBORN  
 LONDON  
 GREATER LONDON  
 WC1R 5DJ


Drawing Title:  
 EXISTING SITE PLAN


Purpose of issue: | Dwg Rev:  
 PLANNING | A

Drawing Number: |  
 200 |

Surveyed By: MS	Original Sheet Size: A3	Pack Issue:
Drawn: SPD	Date: 27.03.18	Checked: DS
Date: 27.03.18	Date: 27.03.18	A


EXISTING SITE PLAN  
 (1:125)

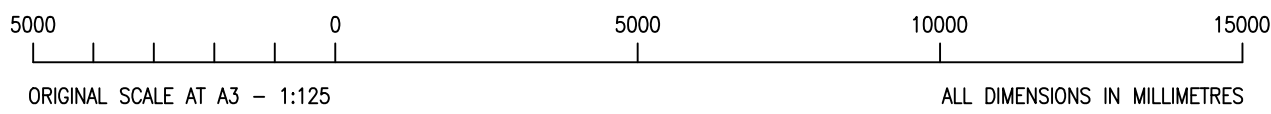

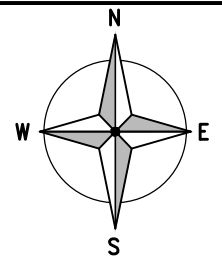


ELEVATION

- EXISTING G8x1 ROXTEC GLAND INSTALLED WITHIN BRICKWORK
- EXISTING ROOF MOUNTED CABLE TRAY
- EXISTING HOOPED ACCESS LADDER
- EXISTING FREE STANDING HANDRAIL
- PROPOSED 2No. M1 MHAs & 2No. C1(a) COMBINERS TO BE INSTALLED ON EXISTING CHS SUPPORT POLE
- PROPOSED REMOVAL AND REPLACEMENT OF EXISTING 1No. TEF ANTENNA MOUNTED ON YOKE BRACKET WITH 1No. PROPOSED TEF ANTENNA. EXISTING 1No. TEF ANTENNA TO REMAIN
- PROPOSED 5No. TEF RRUs ON NEW MAFI 4309 FREESTANDER MEDIUM
- EXISTING HANDRAILING TO BE MODIFIED TO ALLOW INSTALLATION OF RRU SUPPORT FRAME
- PROPOSED 5No. TEF RRUs ON NEW MAFI 4309 FREESTANDER MEDIUM
- EXISTING OLO ANTENNA MOUNTED ON FREESTANDING FRAME
- EXISTING OLO ANTENNA MOUNTED ON WALL MOUNTED POLE
- PROPOSED GPS MODULE TO BE INSTALLED ON MAFI BRACKET COMPLETE WITH 60.3ø CHS POLE
- EXISTING ROOF ACCESS DOOR
- EXISTING FRAGILE ROOF
- PROPOSED REMOVAL AND REPLACEMENT OF EXISTING 1No. TEF ANTENNA MOUNTED ON YOKE BRACKET WITH 1No. TEF ANTENNA. EXISTING 1No. TEF ANTENNA TO REMAIN
- PROPOSED 2No. M1 MHAs & 2No. C1(a) COMBINERS TO BE INSTALLED ON EXISTING CHS SUPPORT POLE

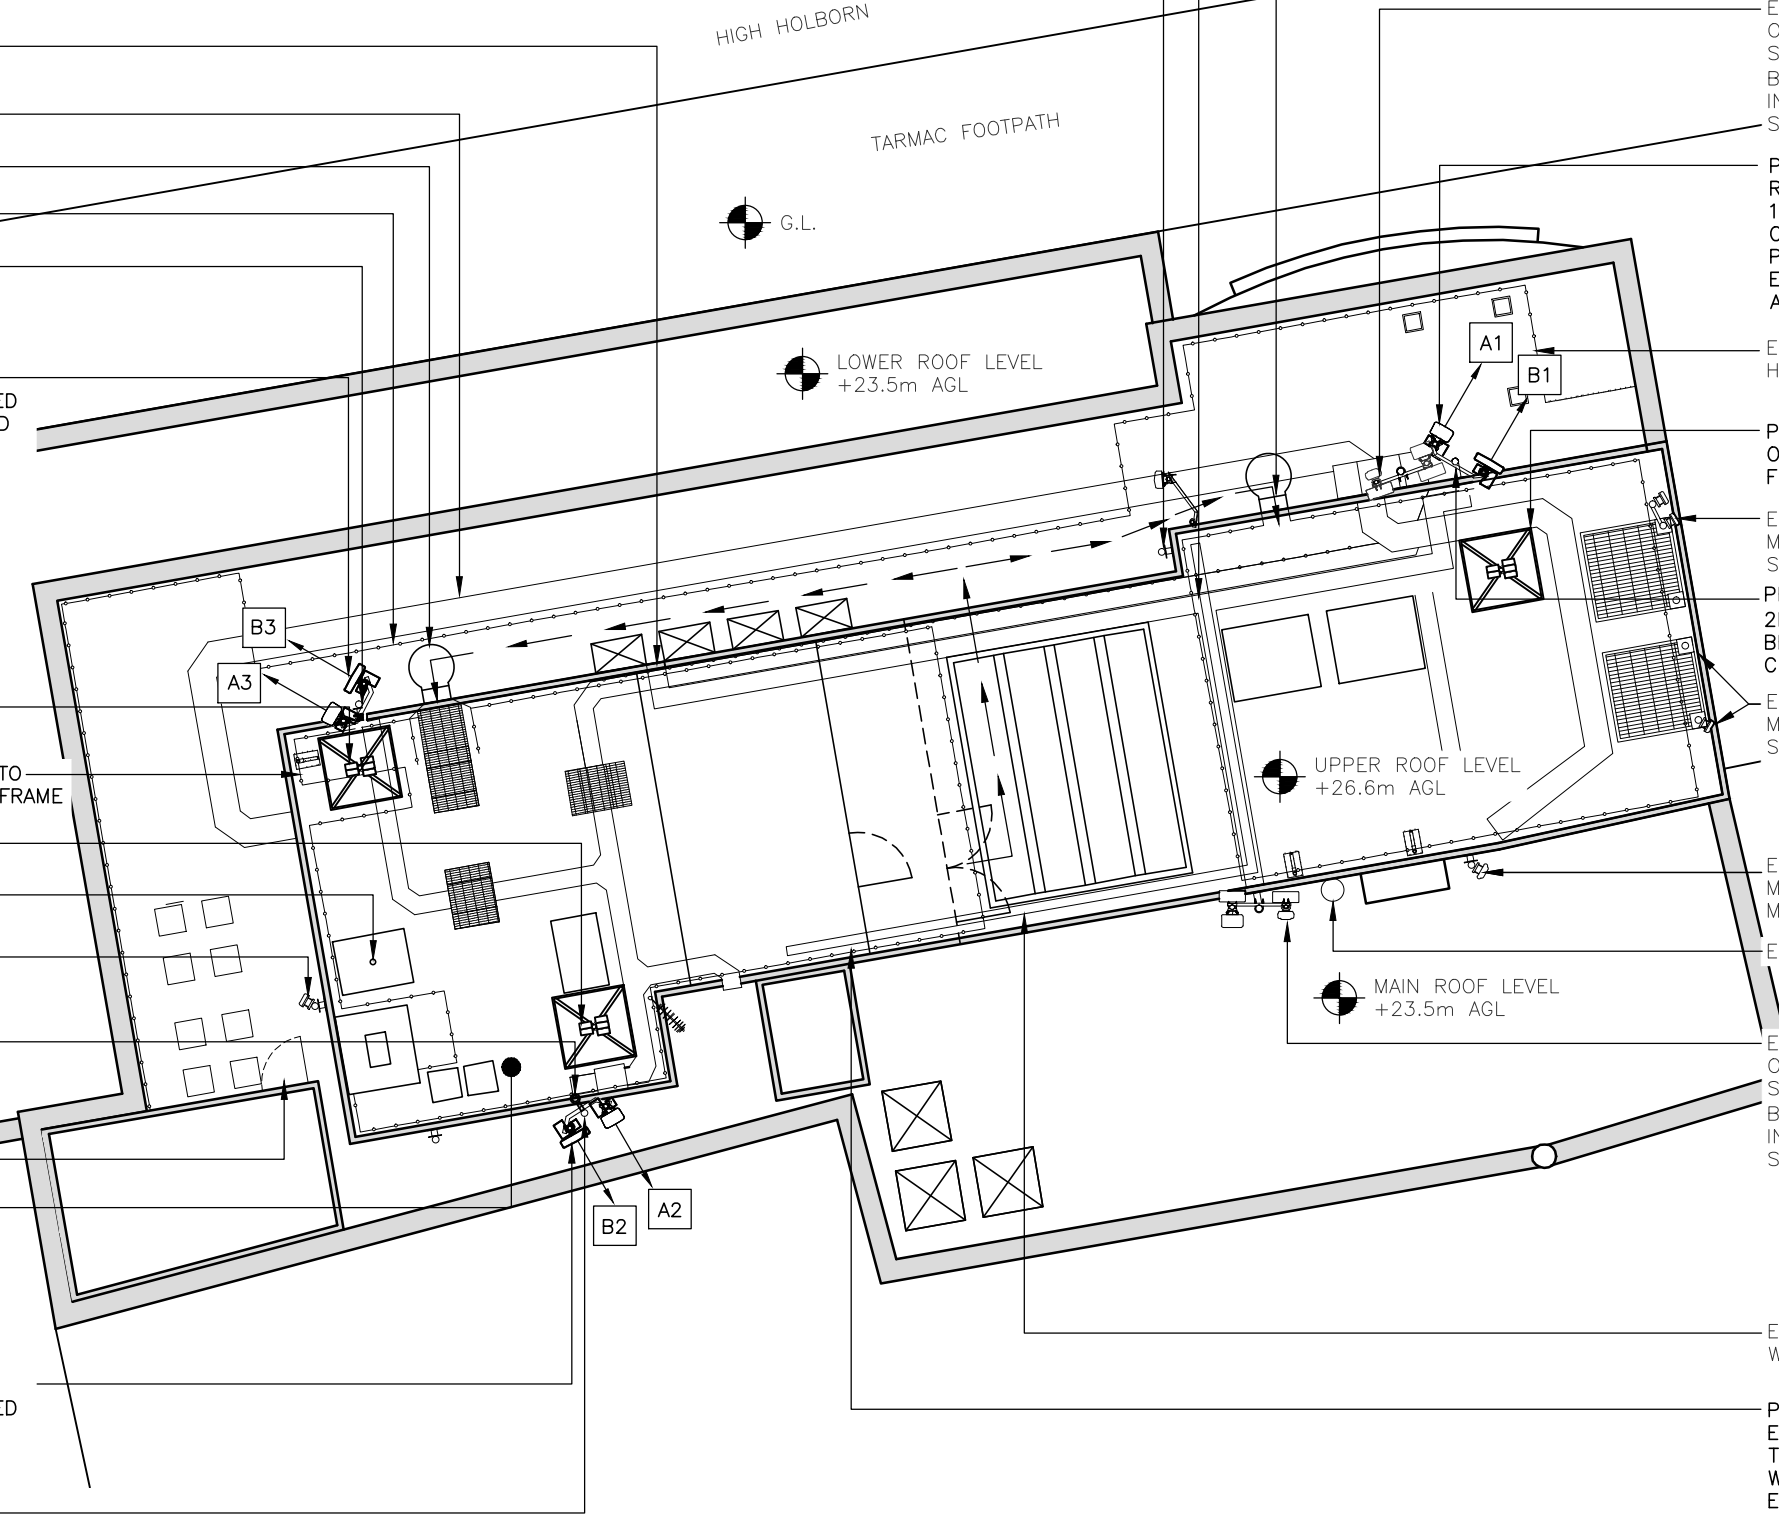

- EXISTING DISUSED ANTENNA SUPPORT POLE FIXED TO WALL
- EXISTING 300 WIDE CABLE TRAY
- EXISTING HOOPED ACCESS LADDER AND HANDRAIL
- EXISTING 2No. VF ANTENNAS ON A FACE MOUNTED SUPPORT POLE AND YOKE BRACKET C/W 2No. RRUs INSTALLED ON ANTENNA SUPPORT POLES
- PROPOSED REMOVAL AND REPLACEMENT OF EXISTING 1No. TEF ANTENNA MOUNTED ON YOKE BRACKET WITH 1No. PROPOSED TEF ANTENNA. EXISTING 1No. TEF ANTENNA TO REMAIN
- EXISTING FREE STANDING HANDRAIL
- PROPOSED 5No. TEF RRUs ON NEW MAFI 4309 FREESTANDER MEDIUM
- EXISTING OLO ANTENNA MOUNTED ON FREESTANDING SLEDGE
- PROPOSED 2No. M1 MHAs & 2No. C1(a) COMBINERS TO BE INSTALLED ON EXISTING CHS SUPPORT POLE
- EXISTING OLO ANTENNA MOUNTED ON FREESTANDING SLEDGE
- EXISTING OLO ANTENNA MOUNTED ON WALL MOUNTED POLE
- EXISTING OLO GRP SHROUD
- EXISTING 2No. VF ANTENNAS ON A FACE MOUNTED SUPPORT POLE AND YOKE BRACKET C/W 2No. RRUs INSTALLED ON ANTENNA SUPPORT POLES
- EXISTING UNUSED 150 WIDE CABLE TRAY
- PROPOSED TEF EQUIPMENT UPGRADE TO BE UNDERTAKEN WITHIN EXISTING TEF EQUIPMENT ROOM

PROPOSED SITE PLAN  
(1:125)

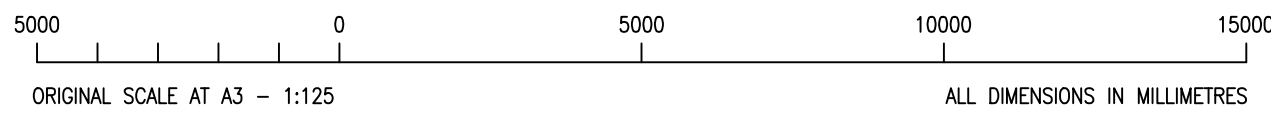

The drawings comply with TEF & Vodafone Standard ICNIRP guidelines.  
Designed in accordance with CTIL document: SDN0008

Notes:  
1 ALL DIMENSIONS ARE IN MM UNLESS NOTED OTHERWISE  
2 DRAWING TO SCALE WHEN PRINTED AT A3

N.G.R E: 530833 N: 181578

CONCESSION REQUIRED NO

NOTES:

Issued for Approval	SPD DS	27.03.18
MODIFICATION	BY CH	DATE

Cell Name		Opt.
PENDEREL HOUSE		-
Cell ID No		
CTIL	TEF	VF
E319835	004868	80449
140779		
Site Address / Contact Details		
PENDEREL HOUSE 283 HIGH HOLBORN LONDON GREATER LONDON WC1R 5DJ		
Drawing Title: PROPOSED SITE PLAN		
Purpose of issue: PLANNING		Dwg Rev: A
Drawing Number: 201		
Surveyed By: MS	Original Sheet Size: A3	Pack Issue: A
Drawn: SPD	Date: 27.03.18	Checked: DS
	Date: 27.03.18	

EXISTING 2No. VF ANTENNAS ON A FACE MOUNTED SUPPORT POLE AND YOKE BRACKET C/W 2No. RRUs INSTALLED ON ANTENNA SUPPORT POLES

EXISTING 2No. TEF ANTENNAS MOUNTED ON YOKE BRACKETS FIXED TO WALL MOUNTED SUPPORT POLE

TOP OF EXISTING TEF ANTENNAS  
29.3m AGL

U/S OF EXISTING TEF ANTENNAS  
27.3m AGL

U/S OF EXISTING TEF ANTENNAS  
27.0m AGL

EXISTING OLO ANTENNAS MOUNTED ON FREESTANDING EXISTING HOOPED ACCESS LADDER

ROOF LEVEL  
+23.5m AGL

EXISTING 2No. VF ANTENNAS ON A FACE MOUNTED SUPPORT POLE AND YOKE BRACKET C/W 2No. RRUs INSTALLED ON ANTENNA SUPPORT POLES

EXISTING OLO ANTENNAS MOUNTED ON POLE

EXISTING DISUSED ANTENNA SUPPORT POLE FIXED WALL

TOP OF EXISTING VF ANTENNAS 29.3m AGL

U/S OF EXISTING VF ANTENNAS 27.3m AGL

EXISTING 2No. TEF ANTENNAS MOUNTED ON YOKE BRACKETS FIXED TO WALL MOUNTED SUPPORT POLE


EXISTING 2No. TEF ANTENNAS MOUNTED ON YOKE BRACKETS FIXED TO WALL MOUNTED SUPPORT POLE

EXISTING OLO ANTENNAS MOUNTED ON POLE

ROOF LEVEL  
+26.6m AGL

EXISTING HOOPED ACCESS LADDER

EXISTING TEF EQUIPMENT ROOM AREA

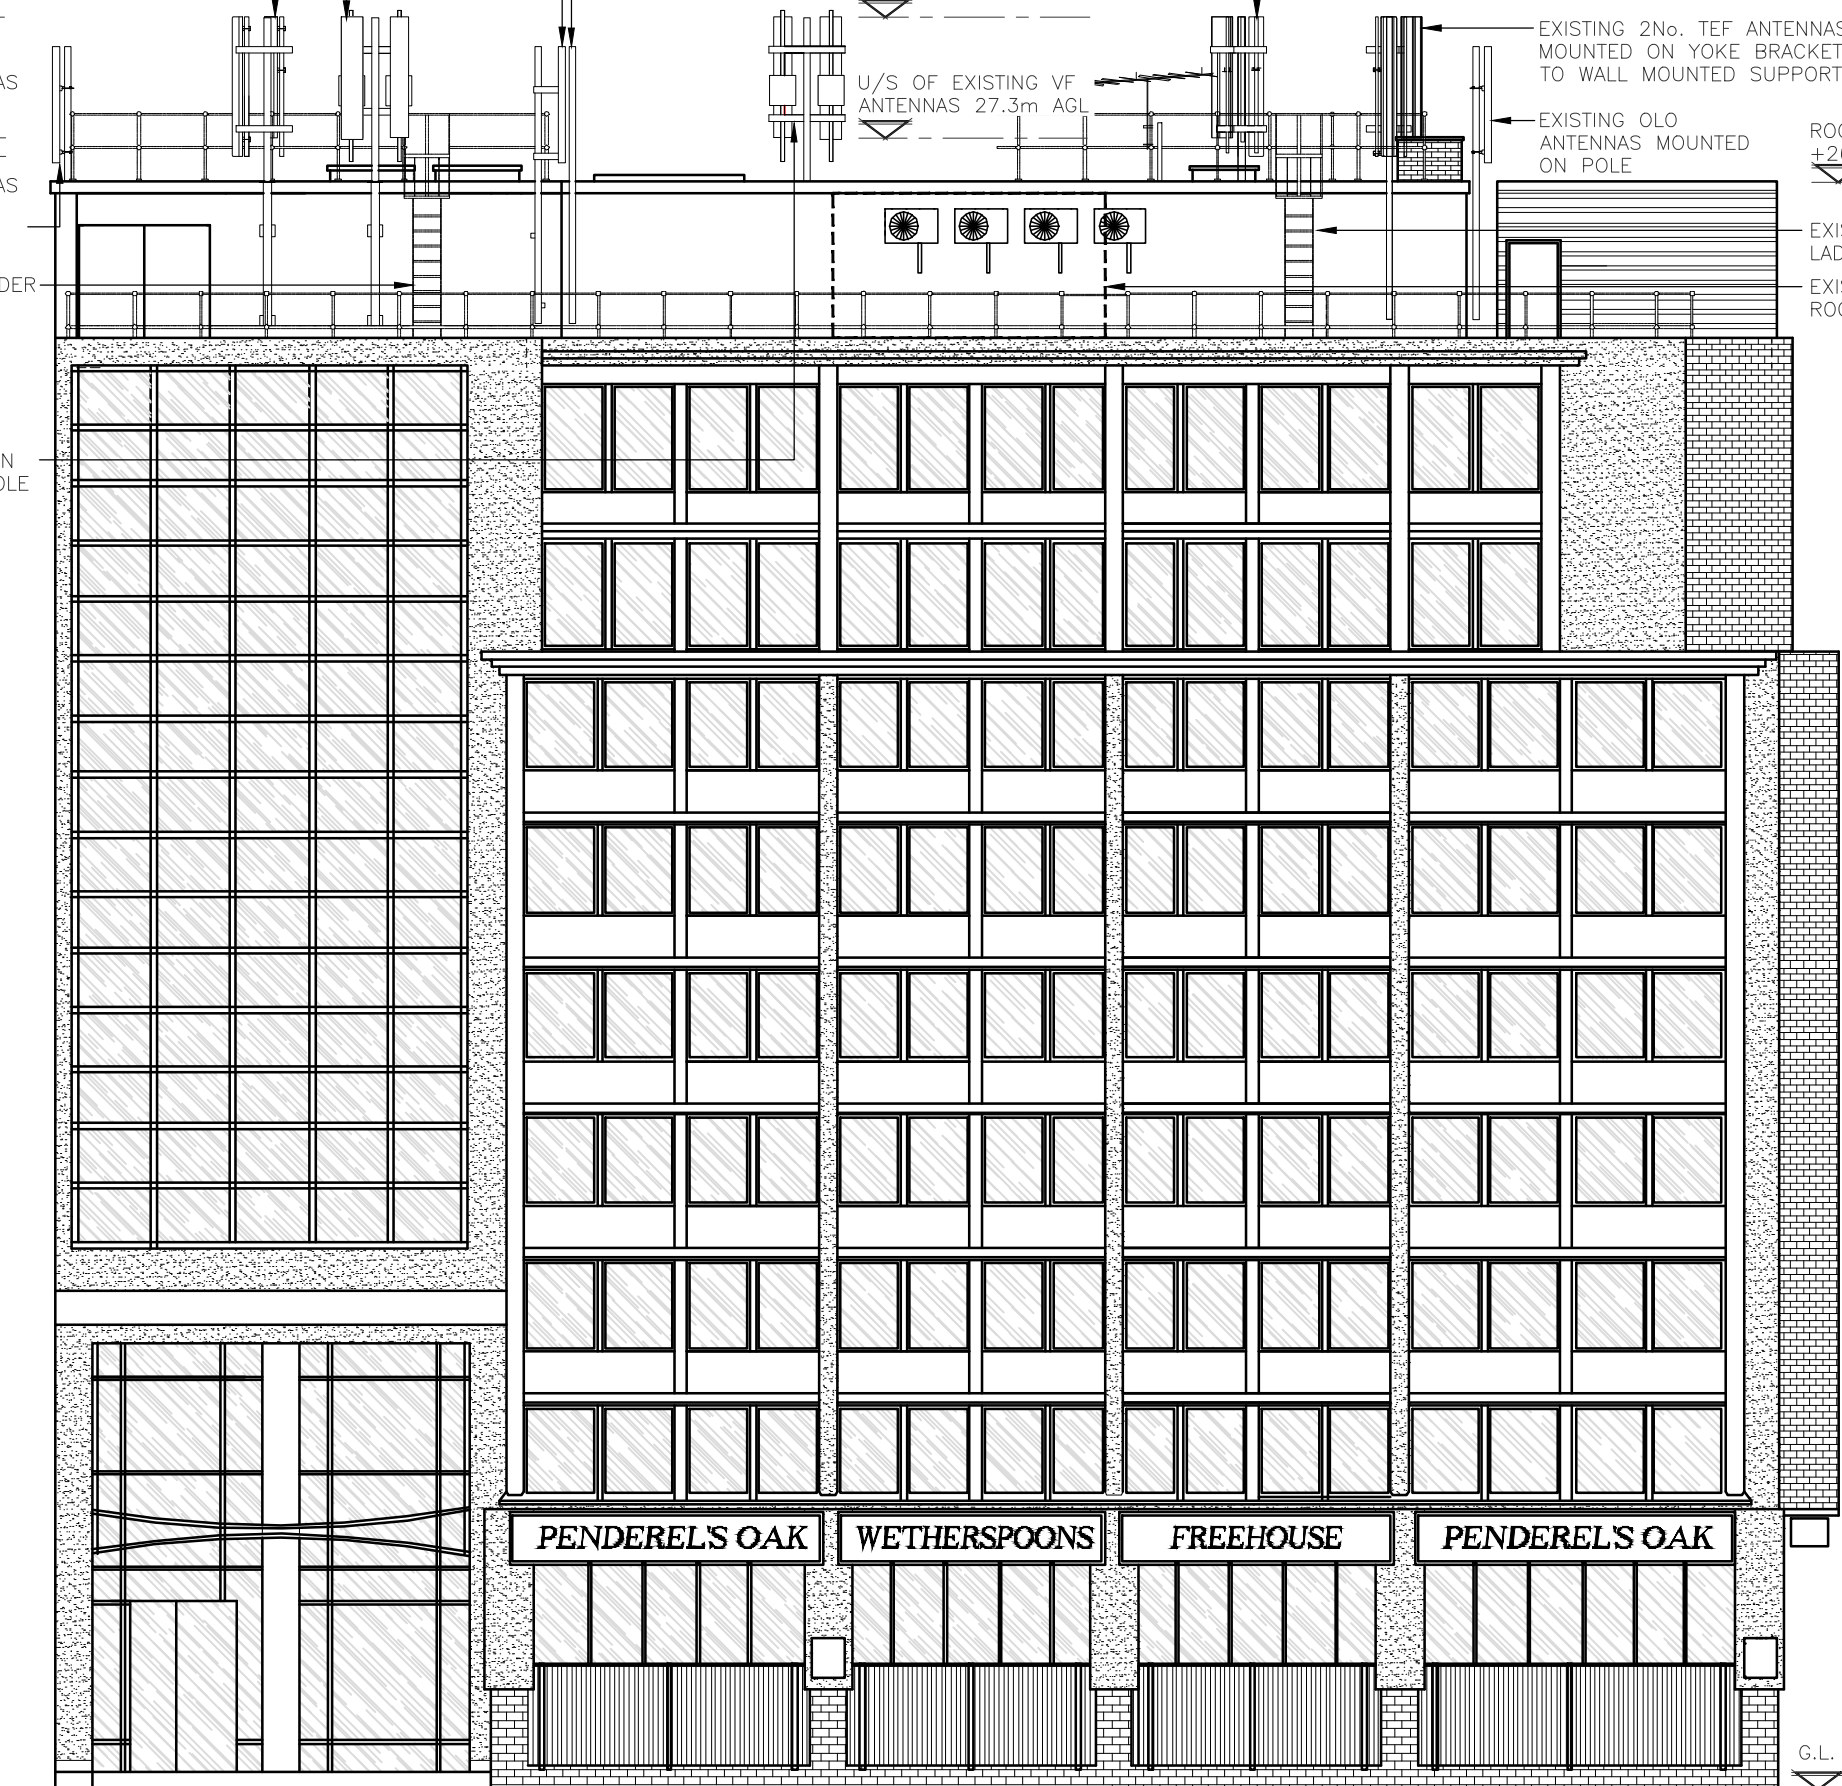

EXISTING NORTH ELEVATION

(1:125)

5000 0 5000 10000 15000

ORIGINAL SCALE AT A3 - 1:125

ALL DIMENSIONS IN MILLIMETRES

Notes:

1 ALL DIMENSIONS ARE IN MM UNLESS NOTED OTHERWISE  
2 DRAWING TO SCALE WHEN PRINTED AT A3

N.G.R E: 530833 N: 181578

CONCESSION REQUIRED NO

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REV	MODIFICATION	BY	CH	DATE



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Cell Name Opt.

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Cell ID No

CTIL	TEF	VF
E319835		
140779	004868	80449

Site Address / Contact Details

PENDEREL HOUSE  
283 HIGH HOLBORN  
LONDON  
GREATER LONDON  
WC1R 5DJ

Drawing Title:  
EXISTING NORTH ELEVATION

Purpose of issue: PLANNING Dwg Rev:

Drawing Number: 300 A

Surveyed By: MS Original Sheet Size: A3 Pack Issue:

Drawn: SPD Date: 27.03.18 Checked: DS Date: 27.03.18 A

EXISTING 2No. VF ANTENNAS ON A FACE MOUNTED SUPPORT POLE AND YOKE BRACKET C/W 2No. RRUs INSTALLED ON ANTENNA SUPPORT POLES

PROPOSED REMOVAL AND REPLACEMENT OF EXISTING 1No. TEF ANTENNA MOUNTED ON YOKE BRACKET WITH 1No. TEF ANTENNA. EXISTING 1No. TEF ANTENNA TO REMAIN.  
TOP OF EXISTING/PROPOSED TEF ANTENNAS 29.3m AGL

U/S OF EXISTING/PROPOSED TEF ANTENNAS 27.3m AGL

EXISTING OLO ANTENNAS MOUNTED ON FREESTANDING SLEDGES

ROOF LEVEL +23.5m AGL

PROPOSED 5No. TEF RRUs ON NEW MAFI 4309 FREESTANDER MEDIUM

PROPOSED 2No. M1 MHAs & 2No. C1(a) COMBINERS TO BE INSTALLED ON EXISTING CHS SUPPORT POLE.

EXISTING HOOPED ACCESS LADDER

EXISTING 2No. VF ANTENNAS ON A FACE MOUNTED SUPPORT POLE AND YOKE BRACKET C/W 2No. RRUs INSTALLED ON ANTENNA SUPPORT POLES

EXISTING OLO ANTENNAS MOUNTED ON POLE

EXISTING DISUSED ANTENNA SUPPORT POLE FIXED WALL

TOP OF EXISTING VF ANTENNAS 29.3m AGL

U/S OF EXISTING VF ANTENNAS 27.3m AGL

PROPOSED 5No. TEF RRUs ON NEW MAFI 4309 FREESTANDER MEDIUM

PROPOSED GPS MODULE TO BE INSTALLED ON MAFI BRACKET COMPLETE WITH 60.3ø CHS POLE

PROPOSED REMOVAL AND REPLACEMENT OF EXISTING 1No. TEF ANTENNA MOUNTED ON YOKE BRACKET WITH 1No. TEF ANTENNA. EXISTING 1No. TEF ANTENNA TO REMAIN.

PROPOSED REMOVAL AND REPLACEMENT OF EXISTING 1No. TEF ANTENNA MOUNTED ON YOKE BRACKET WITH 1No. TEF ANTENNA. EXISTING 1No. TEF ANTENNA TO REMAIN.

EXISTING OLO ANTENNAS MOUNTED ON POLE


ROOF LEVEL +26.6m AGL

PROPOSED 2No. M1 MHAs & 2No. C1(a) COMBINERS TO BE INSTALLED ON EXISTING CHS SUPPORT POLE

EXISTING HOOPED ACCESS LADDER

PROPOSED 2No. M1 MHAs & 2No. C1(a) COMBINERS TO BE INSTALLED ON EXISTING CHS SUPPORT POLE.

EXISTING TEF EQUIPMENT ROOM AREA

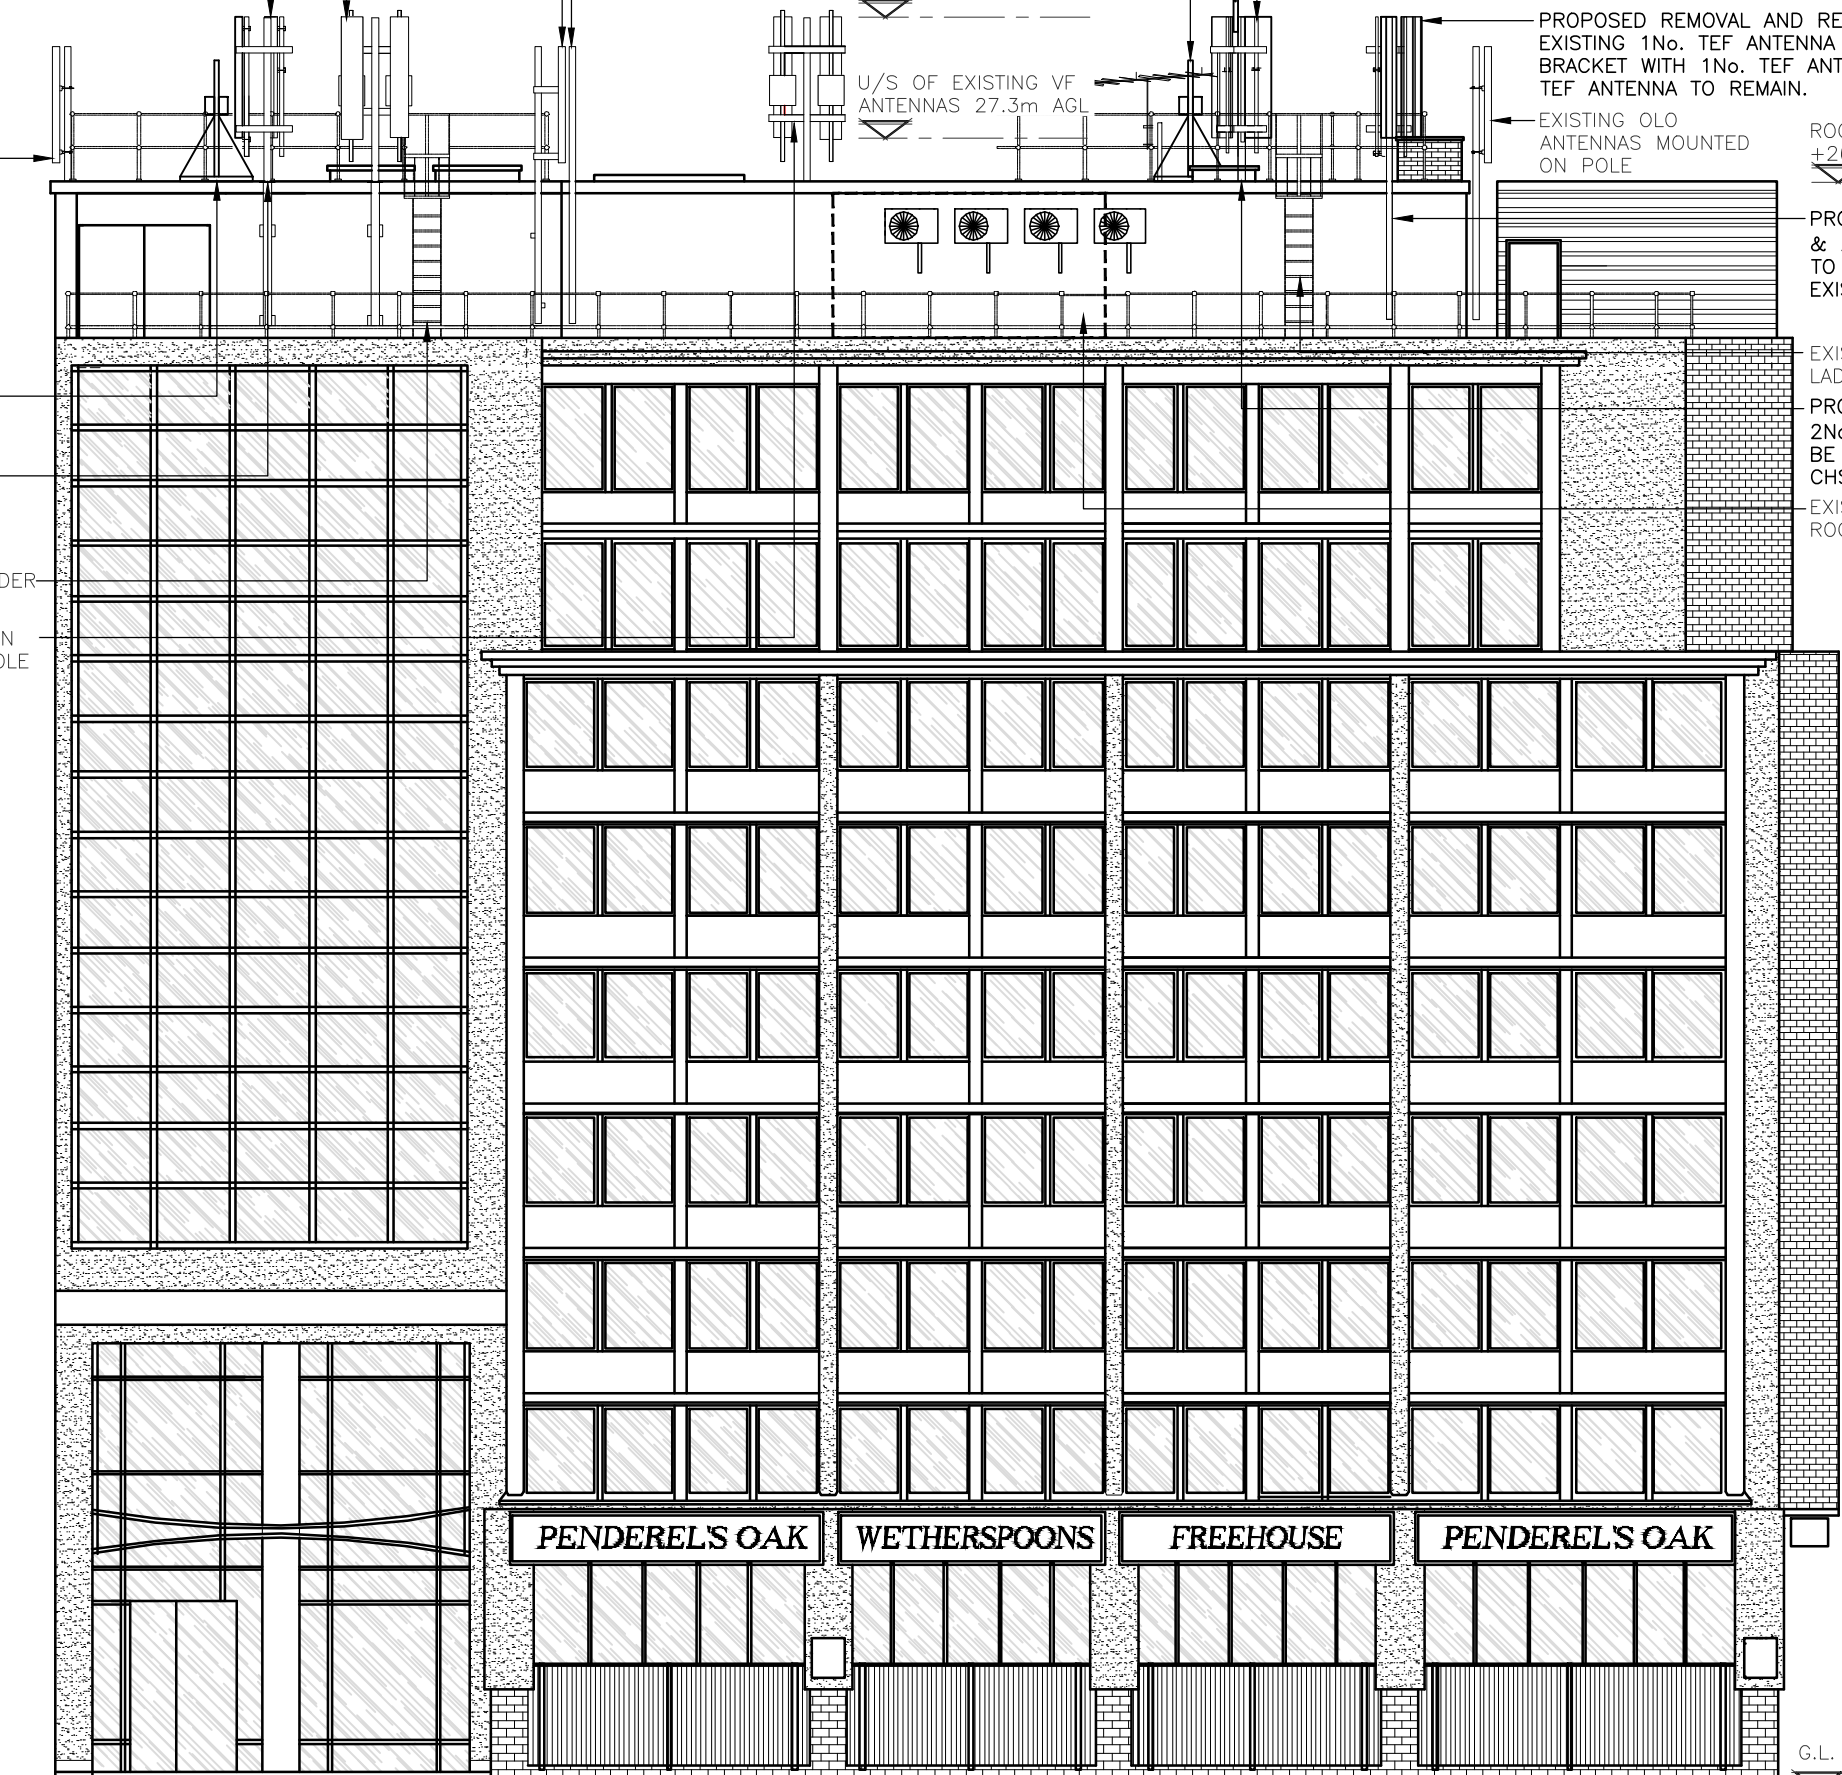

PROPOSED NORTH ELEVATION

(1:125)

5000 0 5000 10000 15000

ORIGINAL SCALE AT A3 - 1:125

ALL DIMENSIONS IN MILLIMETRES

Notes:


1 ALL DIMENSIONS ARE IN MM UNLESS NOTED OTHERWISE  
2 DRAWING TO SCALE WHEN PRINTED AT A3

N.G.R E: 530833 N: 181578

CONCESSION REQUIRED NO

NOTES:

A	Issued for Approval	SPD	DS	27.03.18
REV	MODIFICATION	BY	CH	DATE

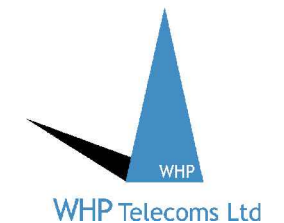

Cell Name Opt.

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Cell ID No

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E319835		
140779	004868	80449

Site Address / Contact Details

PENDEREL HOUSE  
283 HIGH HOLBORN  
LONDON  
GREATER LONDON  
WC1R 5DJ





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Purpose of issue: PLANNING Dwg Rev:

Drawing Number: 301 A

Surveyed By: MS Original Sheet Size: A3 Pack Issue:

Drawn: SPD Date: 27.03.18 Checked: DS Date: 27.03.18 A

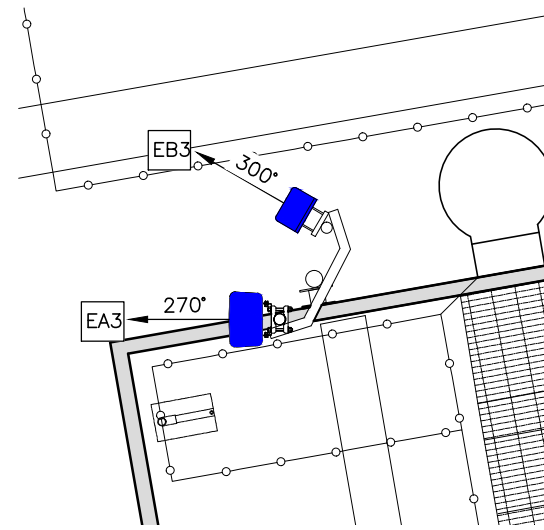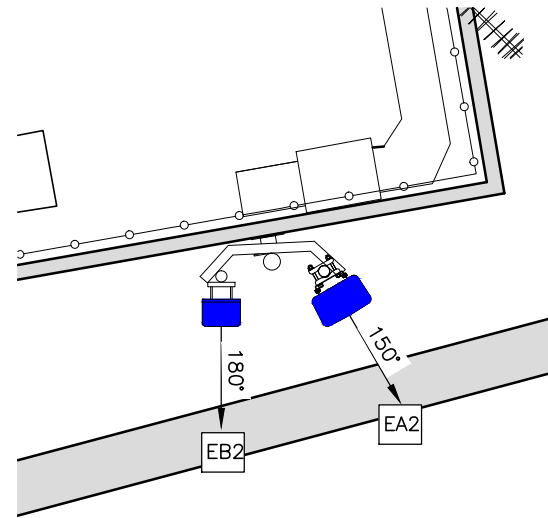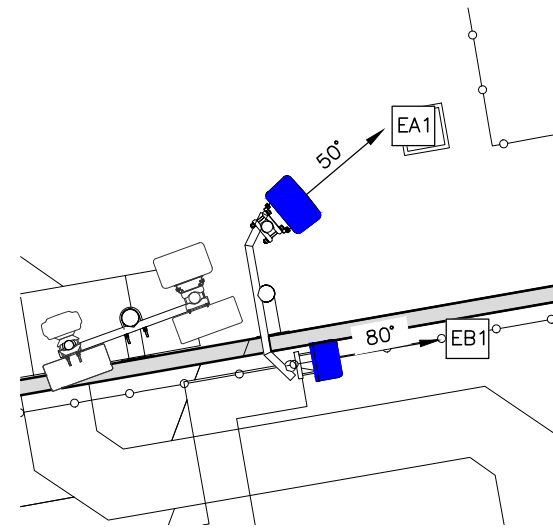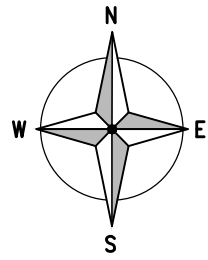

**EXISTING ANTENNA PLAN**

(1:50)

Notes:  
1 ALL DIMENSIONS ARE IN MM UNLESS NOTED OTHERWISE  
2 DRAWING TO SCALE WHEN PRINTED AT A3


N.G.R: E: 530833 N: 181578

CONCESSION REQUIRED: NO


NOTES:

COLOUR KEY	
Shared Equipment	
VF Allocated Equipment	
TEF Allocated Equipment	
Shared Allocated Footprint	
VF Allocated Footprint	
TEF Allocated Footprint	
Unusable Space	

REV	MODIFICATION	BY	CH	DATE
A	Issued for Approval	SPD	DS	27.03.18

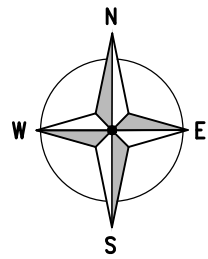

PROPOSED 2No. M2 MHAs & 2No. C1(a) COMBINERS FIXED TO ANTENNA SUPPORT POLES

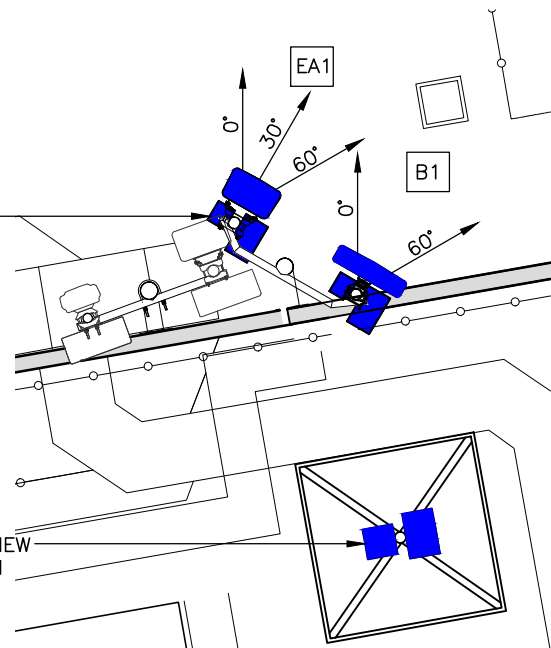


PROPOSED 4No. TEF RRUs ON NEW MAFI 4309 FREESTANDER MEDIUM

PROPOSED 4No. TEF RRUs ON NEW MAFI 4309 FREESTANDER MEDIUM


PROPOSED 2No. M2 MHAs & 2No. C1(a) COMBINERS FIXED TO ANTENNA SUPPORT POLES

PROPOSED GPS MODULE ON EXISTING CHS SUPPORT POLE VIA GPS MOUNTING BRACKET

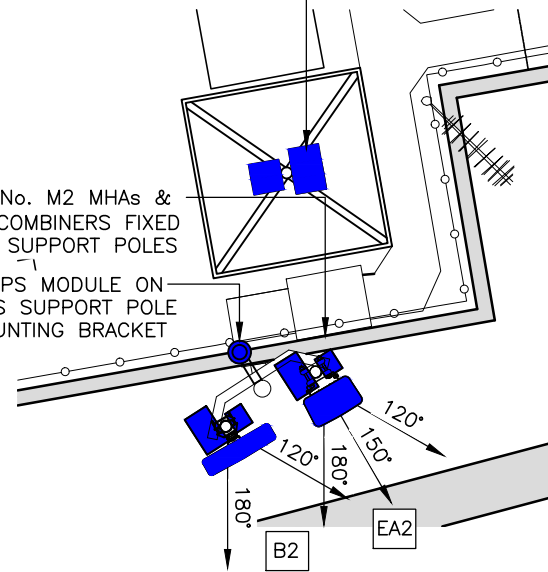

**PROPOSED ANTENNA PLAN**

(1:50)

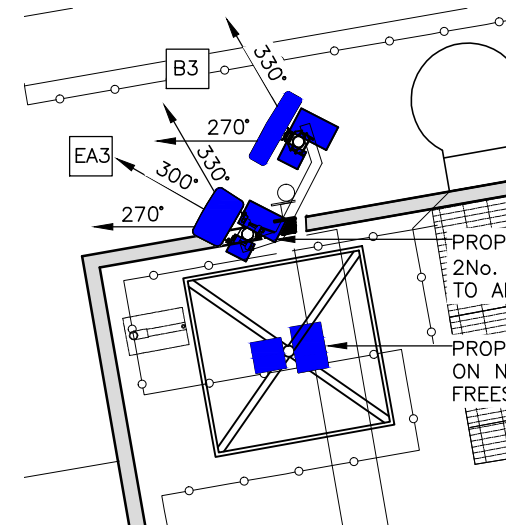

PROPOSED 2No. M2 MHAs & 2No. C1(a) COMBINERS FIXED TO ANTENNA SUPPORT POLES

PROPOSED 4No. TEF RRUs ON NEW MAFI 4309 FREESTANDER MEDIUM



ORIGINAL SCALE AT A1 - 1:50

ALL DIMENSIONS IN MILLIMETRES



CTIL - LONDON

Cell Name

PENDEREL HOUSE

Cell ID No

CTIL	TEF	VF
E319835	004868	80449
140779		

Site Address / Contact Details

PENDEREL HOUSE  
283 HIGH HOLBORN  
LONDON  
GREATER LONDON  
WC1R 5DJ

Drawing Title: ANTENNA LAYOUT

Purpose of issue: PLANNING

Drawing Number: 400

Surveyed By: MS

Original Sheet Size: A3

Drawn: SPD Date: 27.03.18 Checked: DS Date: 27.03.18

The drawings comply with TEF & Vodafone Standard ICNIRP guidelines.  
Designed in accordance with CTIL document: SDN0008



EXISTING ERICSSON RBS6201  
INDOOR CABINET (L8, L26)

EXISTING TEF NOKIA  
DF34 G1800 CABINET

EXISTING TEF 18-WAY  
ROXTEC GLAND, NO  
SPARE WAYS LEFT

EXISTING DISTRIBUTION BOARD

EXISTING BT NTE,  
WALL MOUNTED

EXISTING 2No. ALIFABS 6U WALL  
MOUNTS C/W MEAS UNIT.

EXISTING ERICSSON RBS6201  
INDOOR CABINET (G9/U9 & U21)

PROPOSED REMOVAL & REPLACEMENT  
OF EXISTING TEF NOKIA ULTRASITE  
(G900) CABINET WITH NEW 42U RACK  
(FUTURE)

PROPOSED REMOVAL & REPLACEMENT  
OF EXISTING ELTEK PSU WITH NEW  
ELTEK 4TH GEN PSU

EXISTING G8x1 ROXTEC GLAND


EXISTING 2No. TOSHIBA  
RAV566 10kW A/C SYSTEM

PROPOSED REMOVAL & REPLACEMENT OF  
EXISTING TEF EMPOWER 1100 PSU WITH  
NEW 42U RACK (1) (GU9, L08 L18, L21  
& C11 COMBINERS)


PROPOSED REMOVAL & REPLACEMENT OF  
EXISTING TEF NOKIA ULTRASITE 3G  
CABINET C/W 6-SECTOR FLEXI BTS UNITS  
FOR U2100 WITH NEW 42U RACK (2)  
(U9, L08, L18, L21 & C11 COMBINERS)

EXISTING FIRE CONTROL

EXISTING TEF ALIFABS 27U FLAT PACK  
FRAME C/W FLEXI BTS UNITS FOR U900.  
TO BE RETAINED FOR FUTURE COMMS.

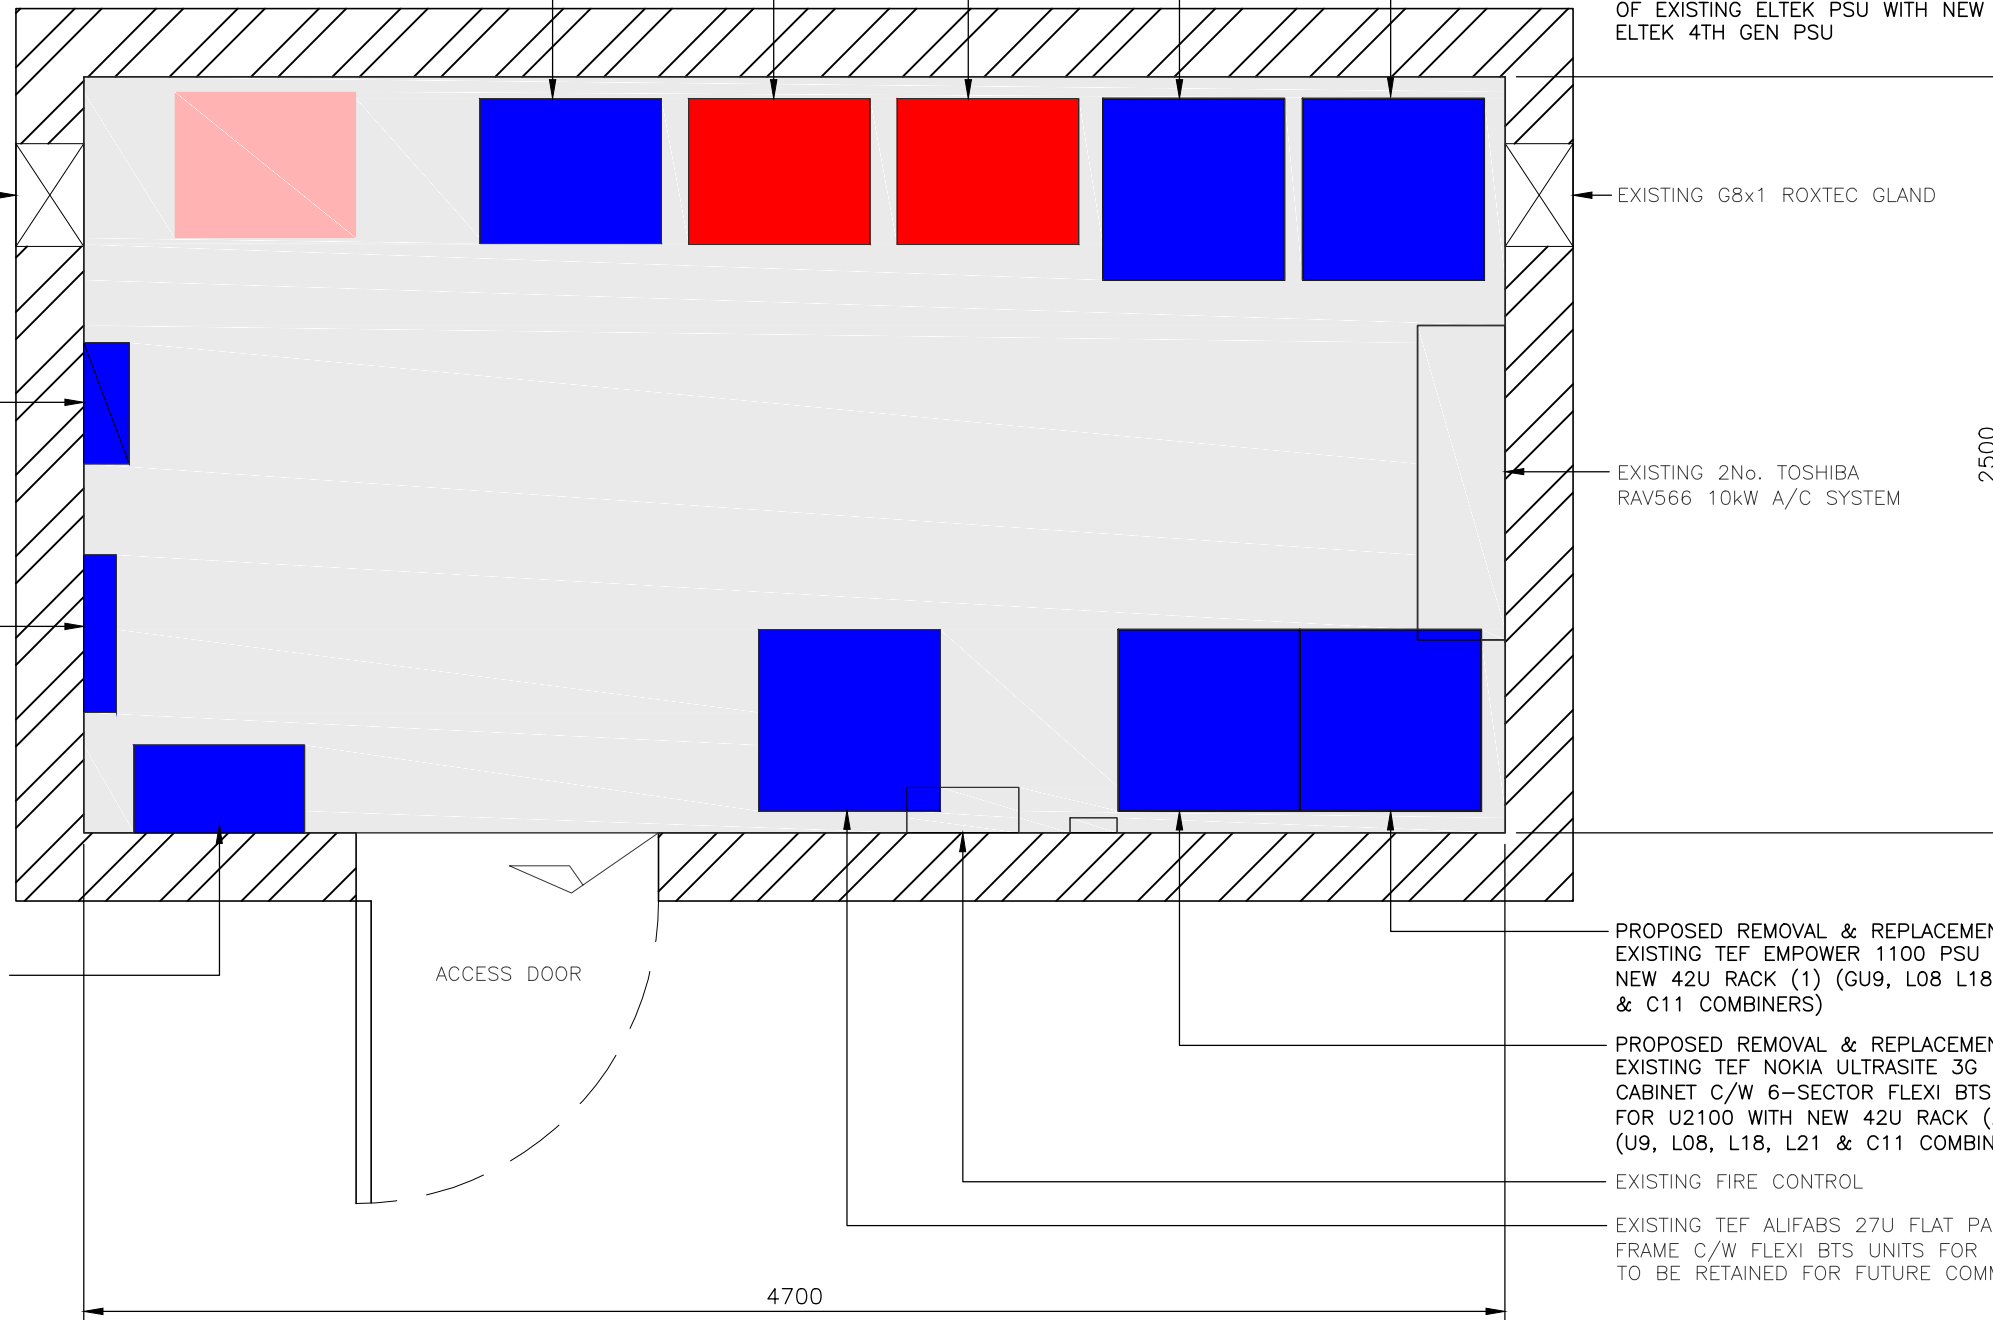

EQUIPMENT ROOM LAYOUT  
(1:25)

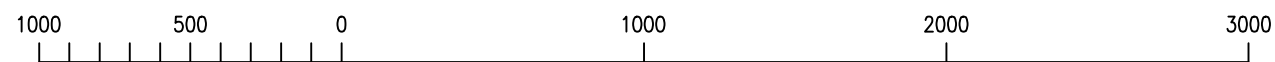

ORIGINAL SCALE AT A3 - 1:25

ALL DIMENSIONS IN MILLIMETRES

Notes:  
1 ALL DIMENSIONS ARE IN MM UNLESS NOTED OTHERWISE  
2 DRAWING TO SCALE WHEN PRINTED AT A3


N.G.R | E: 530833 N: 181578

CONCESSION REQUIRED | NO

NOTES:

COLOUR KEY	
Shared Equipment	
VF Allocated Equipment	
TEF Allocated Equipment	
Shared Allocated Footprint	
VF Allocated Footprint	
TEF Allocated Footprint	
Unusable Space	

REV	MODIFICATION	BY	CH	DATE
A	Issued for Approval	SPD	DS	27.03.18

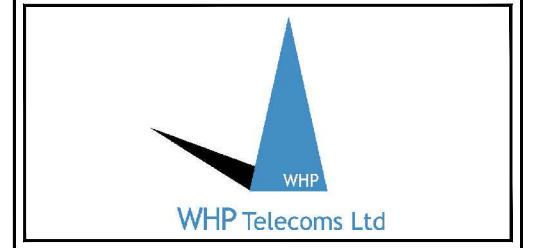

Cell Name | Opt.  
PENDEREL HOUSE | -

Cell ID No		
CTIL	TEF	VF
E319835 140779	004868	80449

Site Address / Contact Details  
PENDEREL HOUSE  
283 HIGH HOLBORN  
LONDON  
GREATER LONDON  
WC1R 5DJ

Drawing Title:  
EQUIPMENT ROOM LAYOUT

Purpose of issue: PLANNING | Dwg Rev: A

Drawing Number: 401 | A

Surveyed By: MS | Original Sheet Size: A3 | Pack Issue: A

Drawn: SPD | Date: 27.03.18 | Checked: DS | Date: 27.03.18 | A

The drawings comply with TEF & Vodafone Standard ICNIRP guidelines.  
Designed in accordance with CTIL document: SDN0008

EXISTING ANTENNA SCHEDULE																												
EXISTING ANTENNAS	OPERATOR	FUNCTION	FEEDER/DC/FIBRE							MHAs/RRUs/BIAS T's/JUMPERS/COMBINERS							ANTENNAS											
			LENGTH(m) & DIAMETER (SEE GUIDANCE NOTES BELOW)				TYPE (COAX OR DC/FIBRE)	FEEDERS QTY		DC/FIBRE QTY	DC/FIBRE LENGTH	MHA NOKIA QTY	MHA E'SSON QTY	RRU QTY	BIAS T QTY	RRU TO ANTENNA JUMPER LENGTH (TO BE WITHIN MAX LENGTH ALLOWED AS PER CTIL DESIGN SPEC)	MHA TO ANTENNA JUMPER LENGTH (m) - RTOPS & GFIELDS)	COMBINERS (HIGH LEVEL)	COMBINERS (LOW LEVEL IN CABINET, CABIN ETC)	ANT. REF.	ANTENNA MANUFACTURERS PART No.	BRG*	HEIGHT TO TOP (m)	HEIGHT TO U/S (m)	HEIGHT TO C/L (m)	LOCATION (POLE MOUNTED, HEADFRAME, WITHIN SHROUD ETC)	STATUS	COMMENTS
			MF1	MF(J1)	MF(J2)	TOTAL		EX'TNG	PROP																			
SEC 1	E	TEF	SPARE	-	-	-	-	-	-	-	-	-	-	-	-	-	-	-	EA1a	COMMSCOPE CVV2NPX308_208R (Q-CODE: H65DUU33WW20C10)	50	29.3	27.2	28.3	POLE MOUNT	REMAIN	-	
		TEF	SPARE	-	-	-	-	-	-	-	-	-	-	-	-	-	-	-	EA1b									
		TEF	SPARE	-	-	-	-	-	-	-	-	-	-	-	-	-	-	-	-									EA1c
		TEF	1U21	25m	-	-	25m	COAX	2	-	-	-	-	-	-	-	-	-	-									EA1d
		TEF	1U21	25m	-	-	25m	COAX	2	-	-	-	-	-	-	-	-	-	-									EA1e
E	TEF	1G09	25m	-	-	25m	COAX	2	-	-	-	-	-	-	-	-	-	-	EB1	JAYBEAM 60X4DF	80	29.3	26.9	28.1	POLE MOUNT	REMOVE	-	
SEC 2	E	TEF	SPARE	-	-	-	-	-	-	-	-	-	-	-	-	-	-	-	EA2a	COMMSCOPE CVV2NPX308_208R (Q-CODE: H65DUU33WW20C10)	150	29.3	27.2	28.3	POLE MOUNT	REMAIN	-	
		TEF	SPARE	-	-	-	-	-	-	-	-	-	-	-	-	-	-	-	-									EA2b
		TEF	SPARE	-	-	-	-	-	-	-	-	-	-	-	-	-	-	-	-									EA2c
		TEF	2U21	10m	-	-	10m	COAX	2	-	-	-	-	-	-	-	-	-	-									EA2d
		TEF	2U21	10m	-	-	10m	COAX	2	-	-	-	-	-	-	-	-	-	-									EA2e
E	TEF	2G09	10m	-	-	10m	COAX	2	-	-	-	-	-	-	-	-	-	-	EB2	JAYBEAM 60X4DF	180	29.3	26.9	28.1	POLE MOUNT	REMOVE	-	
SEC 3	E	TEF	SPARE	-	-	-	-	-	-	-	-	-	-	-	-	-	-	-	EA3a	COMMSCOPE CVV2NPX308_208R (Q-CODE: H65DUU33WW20C10)	270	29.3	27.2	28.3	POLE MOUNT	REMAIN	-	
		TEF	SPARE	-	-	-	-	-	-	-	-	-	-	-	-	-	-	-	-									EA3b
		TEF	SPARE	-	-	-	-	-	-	-	-	-	-	-	-	-	-	-	-									EA3c
		TEF	3U21	18m	-	-	18m	COAX	2	-	-	-	-	-	-	-	-	-	-									EA3d
		TEF	3U21	18m	-	-	18m	COAX	2	-	-	-	-	-	-	-	-	-	-									EA3e
E	TEF	3G09	18m	-	-	18m	COAX	2	-	-	-	-	-	-	-	-	-	-	EB3	JAYBEAM 60X4DF	300	29.3	26.9	28.1	POLE MOUNT	REMOVE	-	



Notes:  
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2 DRAWING TO SCALE WHEN PRINTED AT A3

N.G.R | E: 530833 N: 181578

CONCESSION REQUIRED | NO

NOTES:

REV	A	Issued for Approval	SPD	DS	27.03.18
REV		MODIFICATION	BY	CH	DATE

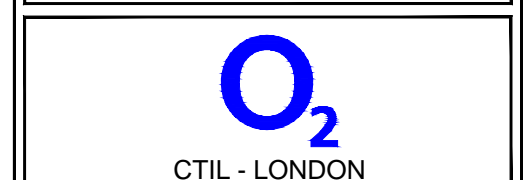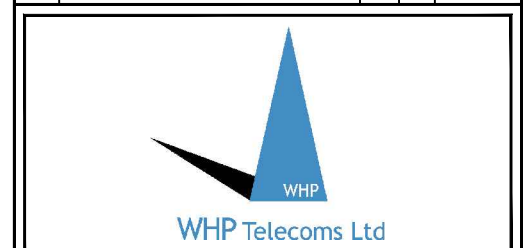

Cell Name	Opt.	
PENDEREL HOUSE	-	
Cell ID No		
CTIL	TEF	VF
E319835		
140779	004868	80449

Site Address / Contact Details

PENDEREL HOUSE  
283 HIGH HOLBORN  
LONDON  
GREATER LONDON  
WC1R 5DJ

Drawing Title: EXISTING ANTENNA SCHEDULE				
Purpose of issue: PLANNING				Dwg Rev:
Drawing Number: 500				A
Surveyed By: MS		Original Sheet Size: A3		Pack Issue:
Drawn: SPD	Date: 27.03.18	Checked: DS	Date: 27.03.18	A

PROPOSED ANTENNA SCHEDULE

PROPOSED & EXISTING ANTENNAS	OPERATOR	FUNCTION	FEEDER/DC/FIBRE						MHAs/RRUs/BIAS T's/JUMPERS/COMBINERS										ANTENNAS							COMMENTS											
			LENGTH(m) & DIAMETER (SEE GUIDANCE NOTES BELOW)				TYPE (COAX OR DC/FIBRE)	FEEDERS QTY		DC/FIBRE QTY	DC/FIBRE LENGTH	MHA NOKIA QTY	MHA ERSSON QTY	RRU/ERS QTY	BIAS T QTY	RRU TO ANTENNA JUMPER LENGTH (TO BE WITHIN MAX LENGTH ALLOWED AS PER CTIL DESIGN SPEC)	MHA TO ANTENNA JUMPER LENGTH (m) - RTOPS & GFIELDS)	COMBINERS (HIGH LEVEL)	COMBINERS (LOW LEVEL IN CABINET, CABIN ETC)	ANT. REF.	ANTENNA MANUFACTURERS PART No.	BRG*	HEIGHT TO TOP (m)	HEIGHT TO U/S (m)	HEIGHT TO C/L (m)		LOCATION (POLE MOUNTED, HEADFRAME, WITHIN SHROUD ETC)	STATUS									
			MF1	MF(J1)	MF(J2)	TOTAL		EX'TNG	PROP																												
SEC 1/2	P	TEF	1G09	25m	-	-	25	COAX	2	-	-	-	-	-	-	-	-	-	-	EA1a	COMMSCOPE CVW2NPX308_208R (Q-CODE: H65DUU33WW20C10)	30	29.3	27.3	28.3	POLE MOUNT	REUSE	-									
		SPARE	-	-	-	-	-	-	-	-	-	-	-	-	-	-	-	-	-	EA1b								-									
		SPARE	-	-	-	-	-	-	-	-	-	-	-	-	-	-	-	-	-	EA1c								-									
		TEF	1L18	22m	1/2=2m	1/2=1m	25	COAX	2	-	-	-	-	-	-	0.5m	2No. C1(a) (L08-U09)- (L18-LU21) COMBINERS	2No. C11 (L08/U09/ L18/LU21) COMBINERS	EA1d	0								-	-	-	-	-	-	-			
		TEF	1L21	22m	1/2=2m	1/2=1m	25	COAX	2	-	-	-	-	-	-	0.5m	2No. C1(a) (L08-U09)- (L18-LU21) COMBINERS	2No. C11 (L08/U09/ L18/LU21) COMBINERS	EA1e	60								-	-	-	-	-	-	-	-		
		TEF	2L18	22m	1/2=2m	1/2=1m	25	COAX	2	-	-	-	-	-	-	0.5m	2No. C1(a) (L08-U09)- (L18-LU21) COMBINERS	2No. C11 (L08/U09/ L18/LU21) COMBINERS	EA1e	60								-	-	-	-	-	-	-	-	-	
	P	TEF	1L08	22m	1/2=2m	1/2=1m	25	COAX	2	-	-	-	-	-	-	-	-	-	-	B1a	COMMSCOPE 2CPX208R-V1 (Q-CODE: DB35GG21C4)	0	29.3	27.3	28.3	POLE MOUNT	NEW	-									
		TEF	1U09	22m	1/2=2m	1/2=1m	25	COAX	2	-	-	-	-	-	-	-	-	-	-	B1b								60	-	-	-	-	-	-	-	-	
		TEF	2L08	22m	1/2=2m	1/2=1m	25	COAX	2	-	-	-	-	-	-	-	-	-	-	B1b								60	-	-	-	-	-	-	-	-	-
		TEF	2U09	22m	1/2=2m	1/2=1m	25	COAX	2	-	-	-	-	-	-	-	-	-	-	B1b								60	-	-	-	-	-	-	-	-	-
TEF		2G09	10m	-	-	10	COAX	2	-	-	-	-	-	-	-	-	-	-	-	EA2a								COMMSCOPE CVW2NPX308_208R (Q-CODE: H65DUU33WW20C10)	150	29.3	27.3	28.3	POLE MOUNT	REUSE	-		
SPARE		-	-	-	-	-	-	-	-	-	-	-	-	-	-	-	-	-	-	EA2b															-		
SPARE	-	-	-	-	-	-	-	-	-	-	-	-	-	-	-	-	-	-	EA2c	-																	
TEF	3L18	7m	1/2=2m	1/2=1m	10	COAX	2	-	-	-	-	-	-	0.5m	2No. C1(a) (L08-U09)- (L18-LU21) COMBINERS	2No. C11 (L08/U09/ L18/LU21) COMBINERS	EA2d	120	-	-	-	-	-	-	-	-	-										
TEF	3L21	7m	1/2=2m	1/2=1m	10	COAX	2	-	-	-	-	-	-	0.5m	2No. C1(a) (L08-U09)- (L18-LU21) COMBINERS	2No. C11 (L08/U09/ L18/LU21) COMBINERS	EA2e	180	-	-	-	-	-	-	-	-	-										
TEF	4L18	7m	1/2=2m	1/2=1m	10	COAX	2	-	-	-	-	-	-	0.5m	2No. C1(a) (L08-U09)- (L18-LU21) COMBINERS	2No. C11 (L08/U09/ L18/LU21) COMBINERS	EA2e	180	-	-	-	-	-	-	-	-	-										
P	TEF	3L08	7m	1/2=2m	1/2=1m	10	COAX	2	-	-	-	-	-	-	-	-	-	-	B2a	COMMSCOPE 2CPX208R-V1 (Q-CODE: DB35GG21C4)	120	29.3	27.3	28.3	POLE MOUNT	NEW	-										
	TEF	3U09	7m	1/2=2m	1/2=1m	10	COAX	2	-	-	-	-	-	-	-	-	-	-	B2b								180	-	-	-	-	-	-	-	-		
	TEF	4L08	7m	1/2=2m	1/2=1m	10	COAX	2	-	-	-	-	-	-	-	-	-	-	B2b								180	-	-	-	-	-	-	-	-	-	
	TEF	4U09	7m	1/2=2m	1/2=1m	10	COAX	2	-	-	-	-	-	-	-	-	-	-	B2b								180	-	-	-	-	-	-	-	-	-	
	TEF	3G09	18m	-	-	18	COAX	2	-	-	-	-	-	-	-	-	-	-	-								EA3a	COMMSCOPE CVW2NPX308_208R (Q-CODE: H65DUU33WW20C10)	300	29.3	27.3	28.3	POLE MOUNT	REUSE	-		
	SPARE	-	-	-	-	-	-	-	-	-	-	-	-	-	-	-	-	-	-								EA3b								-		
SPARE	-	-	-	-	-	-	-	-	-	-	-	-	-	-	-	-	-	-	EA3c	-																	
TEF	5L18	15m	1/2=2m	1/2=1m	18	COAX	2	-	-	-	-	-	-	0.5m	2No. C1(a) (L08-U09)- (L18-LU21) COMBINERS	2No. C11 (L08/U09/ L18/LU21) COMBINERS	A3dE	270	-	-	-	-	-	-	-	-											
TEF	5L21	15m	1/2=2m	1/2=1m	18	COAX	2	-	-	-	-	-	-	0.5m	2No. C1(a) (L08-U09)- (L18-LU21) COMBINERS	2No. C11 (L08/U09/ L18/LU21) COMBINERS	A3dE	330	-	-	-	-	-	-	-	-											
TEF	6L18	15m	1/2=2m	1/2=1m	18	COAX	2	-	-	-	-	-	-	0.5m	2No. C1(a) (L08-U09)- (L18-LU21) COMBINERS	2No. C11 (L08/U09/ L18/LU21) COMBINERS	A3dE	330	-	-	-	-	-	-	-	-											
P	TEF	5L08	15m	1/2=2m	1/2=1m	18	COAX	2	-	-	-	-	-	-	-	-	-	-	B3a	COMMSCOPE 2CPX208R-V1 (Q-CODE: DB35GG21C4)	270	29.3	27.3	28.3	POLE MOUNT	NEW	-										
	TEF	5U09	15m	1/2=2m	1/2=1m	18	COAX	2	-	-	-	-	-	-	-	-	-	-	B3b								330	-	-	-	-	-	-	-			
	TEF	6L08	15m	1/2=2m	1/2=1m	18	COAX	2	-	-	-	-	-	-	-	-	-	-	B3b								330	-	-	-	-	-	-	-	-		
	TEF	6U09	15m	1/2=2m	1/2=1m	18	COAX	2	-	-	-	-	-	-	-	-	-	-	B3b								330	-	-	-	-	-	-	-	-		

Notes:  
 1 ALL DIMENSIONS ARE IN MM UNLESS NOTED OTHERWISE  
 2 DRAWING TO SCALE WHEN PRINTED AT A3

N.G.R | E: 530833 N: 181578


CONCESSION REQUIRED | NO

DESIGN CONCESSION LIST


No.	DESCRIPTION OF CONCESSION REQUIRED	
-	-	
CONCESSION TYPE	CONCESSION NUMBER	
-	-	
CONCESSION TYPE	CONCESSION NUMBER	APPROVAL DATE
-	-	-

NOTES:

A	Issued for Approval	SPD	DS	27.03.18
REV	MODIFICATION	BY	CH	DATE

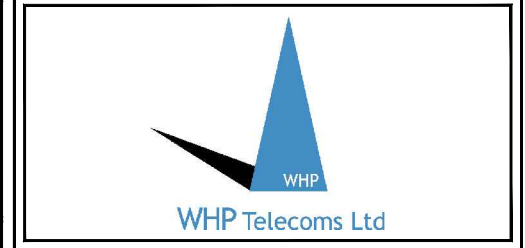


Cell Name		Opt.
PENDEREL HOUSE		-
Cell ID No		
CTIL	TEF	VF
E319835		
140779	004868	80449
Site Address / Contact Details		
PENDEREL HOUSE 283 HIGH HOLBORN LONDON GREATER LONDON WC1R 5DJ		
Drawing Title: PROPOSED ANTENNA SCHEDULE		
Purpose of issue: PLANNING		Dwg Rev:
Drawing Number: 501		A
Surveyed By: MS	Original Sheet Size: A3	Pack Issue:
Drawn: SPD	Date: 27.03.18	Checked: DS
Date: 27.03.18	Date: 27.03.18	A

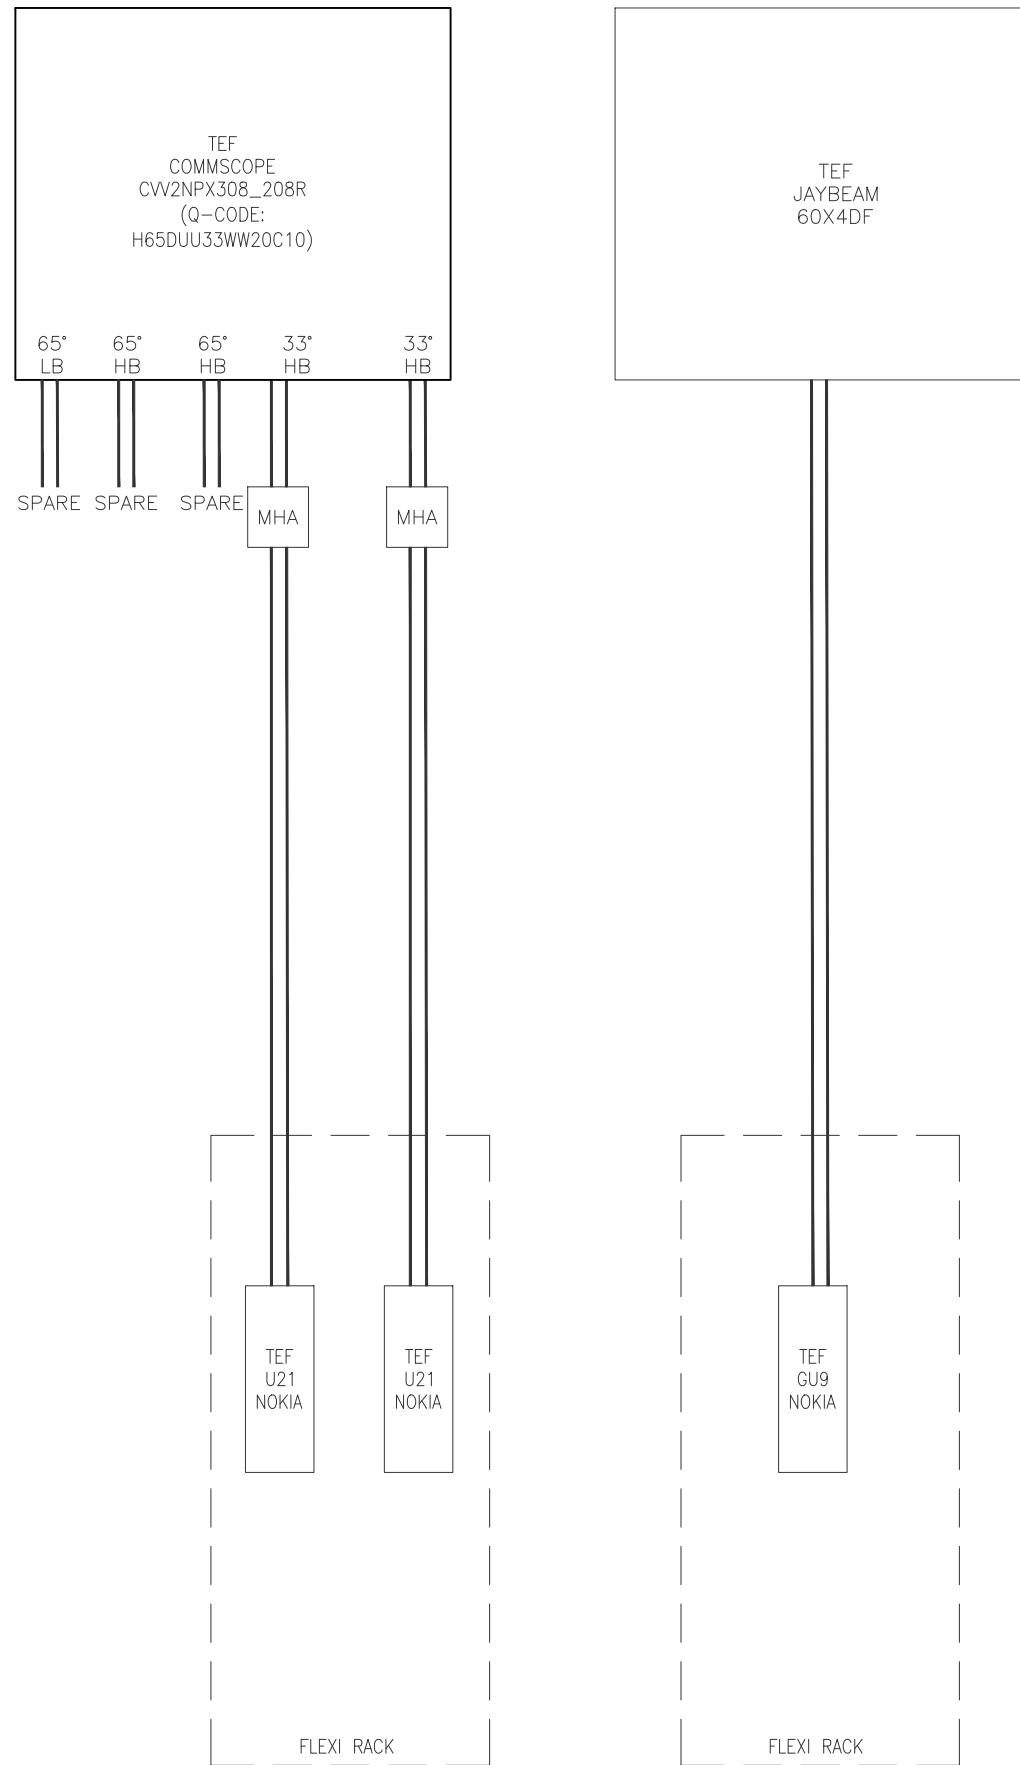

EXISTING TEF ANTENNA AND  
RF SYSTEM DESIGN SCHEMATIC  
(NTS)

LGD2-G-M66-BN

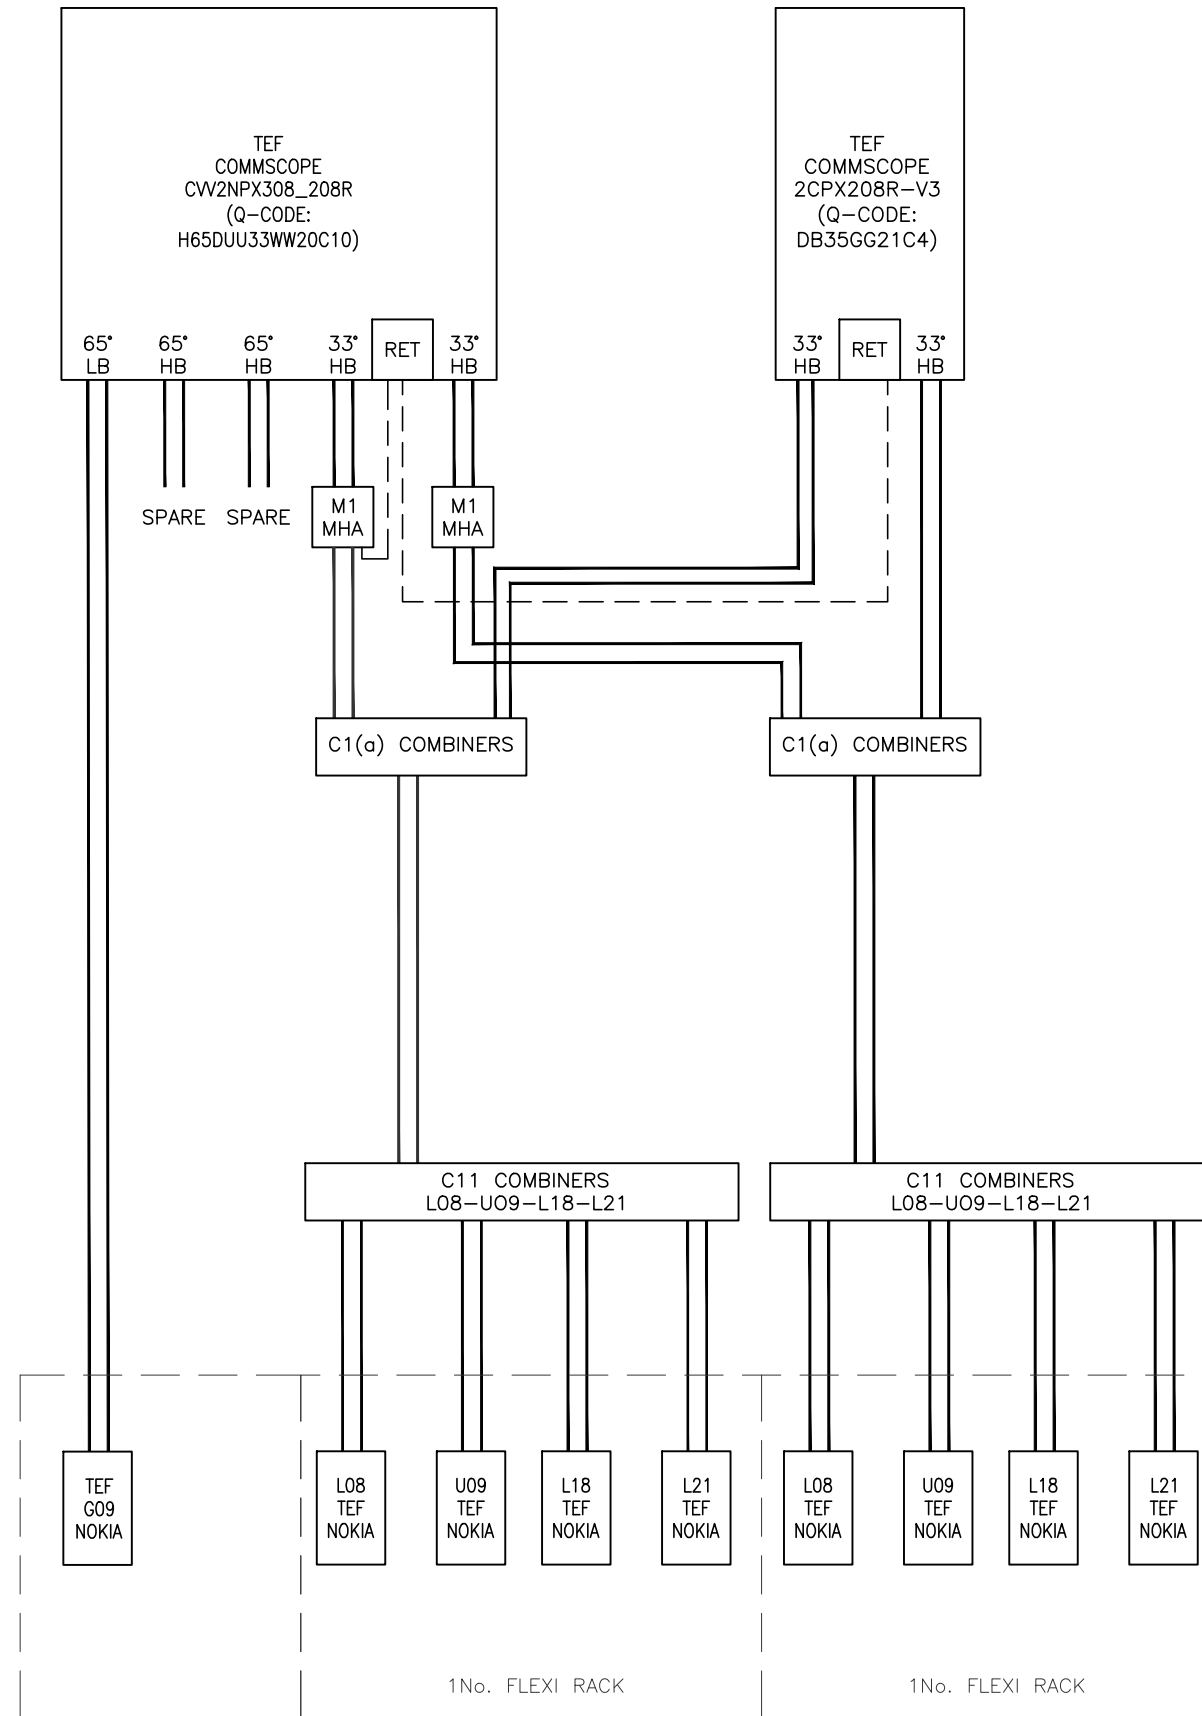

PROPOSED ANTENNA  
AND RF SYSTEM SCHEMATIC  
(NTS)

Notes:  
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N.G.R | E: 530833 N: 181578

CONCESSION REQUIRED | NO

NOTES:

A	Issued for Approval	SPD	DS	27.03.18
REV	MODIFICATION	BY	CH	DATE



Cell Name		Opt.
PENDEREL HOUSE		-
Cell ID No		
CTIL	TEF	VF
E319835	004868	80449
140779		

Site Address / Contact Details  
PENDEREL HOUSE  
283 HIGH HOLBORN  
LONDON  
GREATER LONDON  
WC1R 5DJ

Drawing Title: R.F. SYSTEM SCHEMATIC				
Purpose of issue: PLANNING				Dwg Rev:
Drawing Number: 502				A
Surveyed By: MS		Original Sheet Size: A3		Pack Issue:
Drawn: SPD	Date: 27.03.18	Checked: DS	Date: 27.03.18	A

SUPPORT STRUCTURE SCHEDULE									
EXISTING/ PROPOSED	OPERATOR	MANUFACTURER	MODEL	STRUCTURE HEIGHT	FOUNDATION TYPE (ROOT/PAD/GRILLAGE)	FOUNDATION DIMENSIONS (WxDxH)	COLOUR/ FINISH	STATUS	COMMENTS
EXISTING	TEF	-	114.3Ø CHS POLE	-	-	-	GALVANISED	REMAIN	3No.
EXISTING	TEF	-	60.3Ø CHS POLE	-	-	-	GALVANISED	REMAIN	6No.
EXISTING	TEF	-	OFFSET BRACKET	-	-	-	GALVANISED	REMAIN	6No.
PROPOSED	TEF	-	GPS BRACKET	-	-	-	GALVANISED	NEW	SXK 107 2860/1
PROPOSED	TEF	MAFI	4309 FREESTANDER MEDIUM	-	-	-	GALVANISED	NEW	3No.

ENCLOSURE SCHEDULE								
EXISTING/ PROPOSED	OPERATOR	MANUFACTURER	MODEL	DIMENSIONS (WxDxH)	LOCATION	COLOUR/ FINISH	STATUS	COMMENTS
EXISTING	TEF/VF	-	EQUIPMENT ROOM	4700x2500x2500	-	-	REMAIN	-
EXISTING	TEF	NOKIA	1/2HT FLEXI RACK	600x600x1000	EQUIPMENT ROOM	GREY	REMAIN	G9, U9
EXISTING	TEF	NOKIA	DE34	600x600x1800	EQUIPMENT ROOM	GREY	REMAIN	-
EXISTING	TEF	ELTEK	2ND GEN PSU	600x600x1500	EQUIPMENT ROOM	GREY	REMOVE	-
EXISTING	TEF	EMPOWER	1100-14 PSU	600x480x1600	EQUIPMENT ROOM	GREY	REMOVE	-
EXISTING	VF	ERICSSON	RBS6201	600x485x1600	EQUIPMENT ROOM	GREY	REMAIN	U9, U21
EXISTING	VF	ERICSSON	RBS6201	600x485x1600	EQUIPMENT ROOM	GREY	REMAIN	L08, L21, L26
PROPOSED	TEF	NOKIA	42U FLEXI RACK 1	600x600x1800	EQUIPMENT ROOM	GREY	NEW	L08, G9, U9, L18, L21
PROPOSED	TEF	NOKIA	42U FLEXI RACK 2	600x600x1800	EQUIPMENT ROOM	GREY	NEW	L08, U9, L18, L21
PROPOSED	TEF	ELTEK	4TH GEN ID PSU	600x600x1500	EQUIPMENT ROOM	GREY	NEW	-

RF EQUIPMENT SCHEDULE									
EXISTING/ PROPOSED	OPERATOR	MANUFACTURER	MODEL	DIMENSIONS (WxDxH)	LOCATION	QUANTITY	COLOUR/ FINISH	STATUS	COMMENTS
EXISTING	TEF	NOKIA	FLEXI MODULES	490x560x133	FPR	4	GREY	REMOVE	G9, U9, U21
PROPOSED	TEF	NOKIA	FXDB	490x560x133	FLATPACK FRAME (1)	1	GREY	NEW	G900
PROPOSED	TEF	NOKIA	FSMF	490x560x133	FLATPACK FRAME (1)	1	GREY	NEW	G900
PROPOSED	TEF	NOKIA	FXDB1	490x560x133	FLATPACK FRAME (1)	1	GREY	NEW	U900
PROPOSED	TEF	NOKIA	FRGU1	490x560x133	FLATPACK FRAME (1)	1	GREY	NEW	L2100
PROPOSED	TEF	NOKIA	FXED1	490x560x133	FLATPACK FRAME (1)	1	GREY	NEW	L1800
PROPOSED	TEF	NOKIA	FRMC/F	490x560x133	FLATPACK FRAME (1)	1	GREY	NEW	L800
PROPOSED	TEF	NOKIA	FXDB2	490x560x133	FLATPACK FRAME (2)	1	GREY	NEW	U900
PROPOSED	TEF	NOKIA	FSMF2	490x560x133	FLATPACK FRAME (2)	1	GREY	NEW	U900
PROPOSED	TEF	NOKIA	FSMF1	490x560x133	FLATPACK FRAME (2)	1	GREY	NEW	U900
PROPOSED	TEF	NOKIA	FRGU2	490x560x133	FLATPACK FRAME (2)	1	GREY	NEW	L2100
PROPOSED	TEF	NOKIA	FXED2	490x560x133	FLATPACK FRAME (2)	1	GREY	NEW	L1800
PROPOSED	TEF	NOKIA	FRMC/F2	490x560x133	FLATPACK FRAME (2)	1	GREY	NEW	L800
PROPOSED	TEF	NOKIA	FSMF2	490x560x133	FLATPACK FRAME (2)	1	GREY	NEW	L8/L18/L21
PROPOSED	TEF	NOKIA	FSMF1	490x560x133	FLATPACK FRAME (2)	1	GREY	NEW	L8/L18/L21
PROPOSED	TEF	NOKIA	FXDB	490x560x133	FPR (2)	1	GREY	NEW	U09
EXISTING	TEF	RADIO DESIGN	TYPE 5 COMBINERS	-	CABIN CEILING	3	GREY	REMOVE	G9, U9, G18
PROPOSED	TEF	KATHREIN	M1 18/21 MHA	168x274x120	CHS SUPPORT POLE	6	GREY	NEW	-
PROPOSED	TEF	NOKIA	C11	253x328x131	FLATPACK FRAME (1)	3	GREY	NEW	08/U9/L18/L21
PROPOSED	TEF	NOKIA	C11	253x328x131	FLATPACK FRAME (2)	3	GREY	NEW	08/U9/L18/L21
PROPOSED	TEF	COMMScope	C1 (a)	125x145x38	CHS SUPPORT POLE	6	GREY	NEW	08/U9/L18/L21
PROPOSED	TEF	ROSENBERGER	GPS 0307	-	TX RACK	1	GREY	NEW	-
PROPOSED	TEF	ROSENBERGER	GPS MODULE	109Øx120	SECTOR 1 POLE	1	GREY	NEW	-

Notes:  
1 ALL DIMENSIONS ARE IN MM UNLESS NOTED OTHERWISE  
2 DRAWING TO SCALE WHEN PRINTED AT A3

N.G.R | E: 530833 N: 181578

CONCESSION REQUIRED | NO

DESIGN CONCESSION LIST

No.	DESCRIPTION OF CONCESSION REQUIRED	
-	-	
CONCESSION TYPE	CONCESSION NUMBER	APPROVAL DATE
-	-	-

NOTES:

REV	Issued for Approval	SPD	DS	27.03.18
	MODIFICATION	BY	CH	DATE



Cell Name | Opt.  
PENDEREL HOUSE | -

Cell ID No  
CTIL | TEF | VF  
E319835 | 004868 | 80449  
140779

Site Address / Contact Details  
PENDEREL HOUSE  
283 HIGH HOLBORN  
LONDON  
GREATER LONDON  
WC1R 5DJ

Drawing Title:  
EQUIPMENT SCHEDULE

Purpose of issue: | Dwg Rev:  
PLANNING | A

Drawing Number: | A  
503

Surveyed By: | Original Sheet Size: | Pack Issue:  
MS | A3 | A

Drawn: | Date: | Checked: | Date: | A  
SPD | 27.03.18 | DS | 27.03.18

AC POWER SUPPLY SCHEDULE								
EXISTING/ PROPOSED	OPERATOR	MANUFACTURER	MODEL	SUPPLY TYPE (DNG/LL)	PHASE (SINGLE/THREE)	SUPPLY RATING (AMPS)	EARTHING (TN-C-S/TT)	COMMENTS
EXISTING	TEF	-	-	-	UNKNOWN	-	-	-
EXISTING	TEF	MEMSHIELD	DISTRIBUTION BOARD	DNO	THREE	100	-	-

DC POWER SUPPLY UNIT SCHEDULE									
EXISTING/ PROPOSED	OPERATOR	MANUFACTURER	MODEL	LOCATION	AC SUPPLY TO PSU BREAKER SIZE (AMPS)	RECTIFIER SIZE (kW)	RECTIFIER QUANTITY	UPGRADE REQUIRED (Y/N)	COMMENTS
EXISTING	TEF	ELTEK	2ND GEN PSU	EQUIPMENT ROOM	32 x 3	2.0	5	Y	REMOVE
EXISTING	TEF	EMPOWER	1100-14 PSU	EQUIPMENT ROOM	20 x 3	-	3	N	-
PROPOSED	TEF	ELTEK	4TH GEN PSU	EQUIPMENT ROOM	TBC	3.0	6	N	-

TRANSMISSION SUPPLY SCHEDULE								
EXISTING/ PROPOSED (ENCLOSURE)	OPERATOR		TRANSMISSION ENCLOSURE	TRANSMISSION SOLUTION (MICROWAVE ONLY/FIBRE ONLY/ MICROWAVE+FIBRE (WITH PROVIDER NAME))	U SPACE AVAILABLE	CURRENT TRANSMISSION EQUIPMENT LOCATION	PROPOSED TRANSMISSION EQUIPMENT LOCATION	COMMENTS
	HOST	SHARER						
EXISTING	TEF	VF	WALL MOUNTED RACK	FIBRE ONLY (BT MEAS)	3U + 4U	X	-	2No.

COOLING SCHEDULE										
EXISTING/ PROPOSED	OPERATOR	COOLING SYSTEM MANUFACTURER	COOLING SYSTEM MODEL	TYPE (FREE AIR/ PACKAGED/AC)	COOLING CALCULATOR VERSION	COOLING CAPACITY (kW)	SITE HEAT LOAD (kW)	UPGRADE REQUIRED (Y/N)	STATUS	COMMENTS
EXISTING	TEF	TOSHIBA	RAV-SM1104ATP-E	AC	1.53	10	10.2	N	REMAIN	2No.

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N.G.R | E: 530833 N: 181578

CONCESSION REQUIRED | NO

DESIGN DEPENDENCIES | COMPLETED

STAT SEARCH RESULTS | NO | -

ASBESTOS REPORT | ✓ | TBC

RADAR SCAN REPORT | NO | -

COOLING CALCS | ✓ | 27.03.2018

LL FIRE ALARM ASSESS | ✓ | TBC

GDC LEVEL | 2 | NO | -

STRUCTURAL CALCS | ✓ | TBC

HD BOLT GRADE TEST | NO | -

FOUNDATION CALCS | NO | -

BOREHOLE REPORT | NO | -

TRIAL HOLE REPORT | NO | -

BOLT PULL TEST | NO | -

BUILDING REG'S APP. | NO | -

NET RAIL TECH PACK | NO | -


DNO QUOTE APPROVAL | NO | -

HOOPED LADDER | NO | -

REFER TO THE SITE SPECIFIC DRAWING SUBMISSION CHECKLIST (SDN0020) FOR A COMPREHENSIVE LIST AND INSTRUCTION ON WHERE TO FIND ALL ACCOMPANYING DESIGN DOCUMENTATION.

A Issued for Approval | SPD DS | 27.03.18

REV | MODIFICATION | BY | CH | DATE

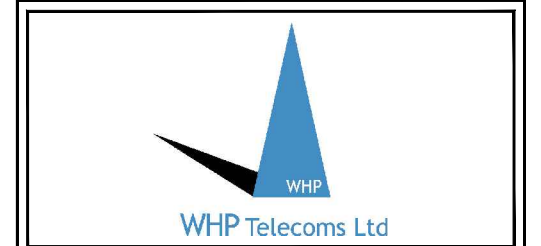

Cell Name | Opt.  
PENDEREL HOUSE | -

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Site Address / Contact Details

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283 HIGH HOLBORN  
LONDON  
GREATER LONDON  
WC1R 5DJ

Drawing Title:  
EQUIPMENT SCHEDULE

Purpose of issue: PLANNING | Dwg Rev:

Drawing Number: 504 | A

Surveyed By: MS | Original Sheet Size: A3 | Pack Issue:

Drawn: SPD | Date: 27.03.18 | Checked: DS | Date: 27.03.18 | A