


GENERAL NOTES:

- G1 For Site and Grid setting out refer to AVXXXX/3000
- G2 All dimensions to be checked on site
- G3 Any discrepancies between drawings to be reported to the Architect immediately.
- G4 All Levels are above Ordnance datum (AOD)
New Levels are shown thus: 20.349
Existing Levels are shown thus: EX 20.345
Retained Existing Levels: EX20.349
- G5 Use figured dimensions only; Do not scale from drawings. IF IN DOUBT, ASK.
- G6 Refer to Engineers drawings for all structural and services information.
- G7 For tolerances see the Design Drawings and Specifications
- G8 For elements of work subject to Contractor's Design, this drawing is indicative of the Visual & performance requirements only. The Contractor is responsible for the detailed design and co-ordination of the installation with other trades and services. All dimensions shown on design drawings, contract terms and contract documents.
- G9 Room numbers are shown thus: 115
- G10 Door(D) & Window (W) References
Door No. DLG-006 60 Fire Rating
are shown thus: R402 -
Homogeneity Type
- G11 Clear height to be shown thus 2720
- G12 T Sheet Reference shown thus IWS-01
- G13 Finishes are shown thus:

WALL	CEILING	FLOOR	WALL
▽	△	▽	▽
- G14 Setting Out Points shown thus: SOP ⊕
- G15 Refer to AVxxx9100 for T Sheet references, and to AVxxx9110 to 9167 for Architectural Specifications.

NOTES:

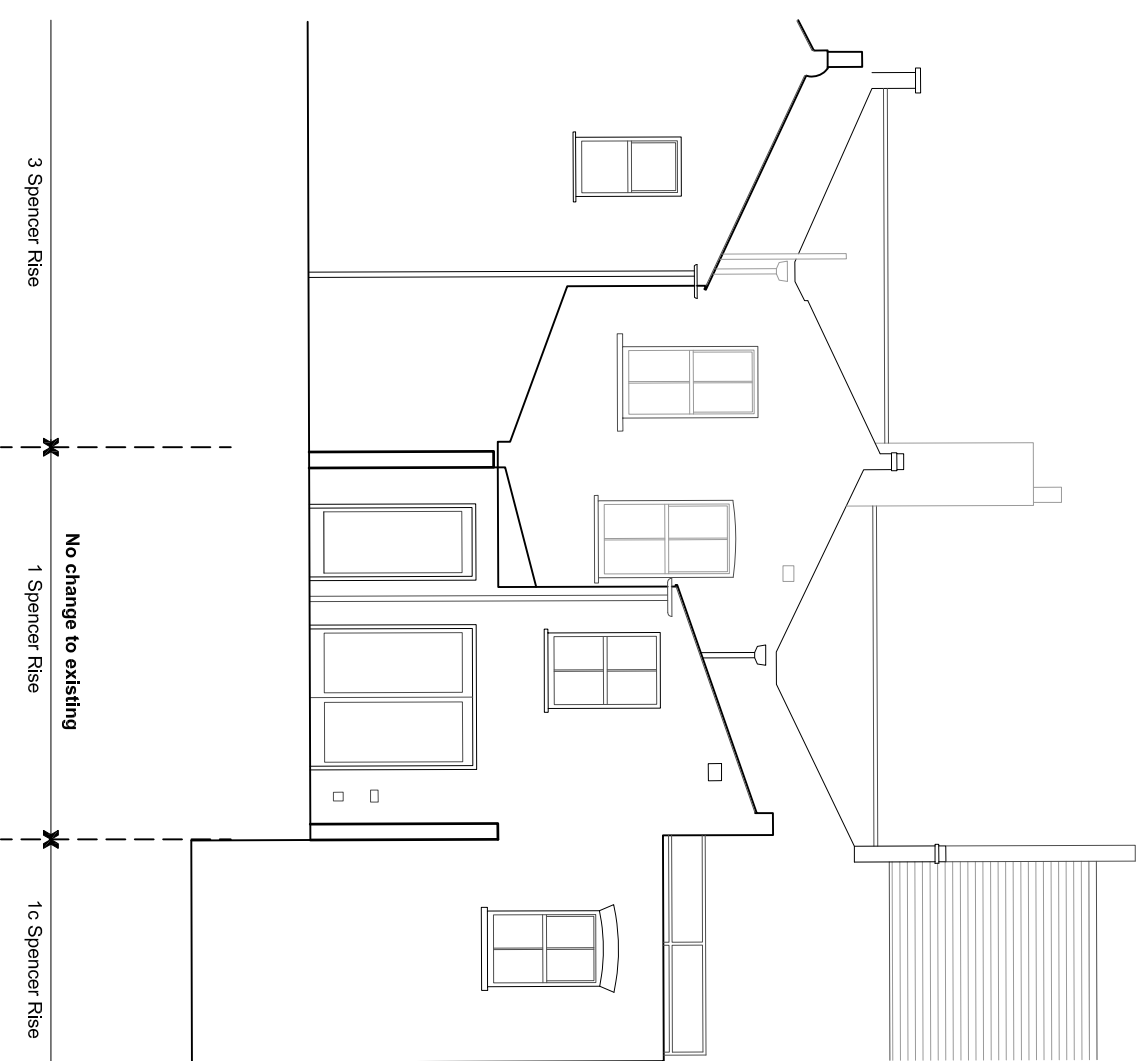

Date	Revision	Status
25.06.18	A	Issued to Camden

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Project: 1 Spencer Rise

Subject: Proposed Rear Elevation

Scale: 1 : 100 @ A3

Sort Code	Drawing No.	Revision
A/1SR	1036	A