

1-1A MS Listed Building Consent - 2017/4724/L Information to discharge condition No. 5a, b, & c

The British Museum 1-1A Montague Street

June 2018



Condition No. 5

Notwithstanding the details of the locations of the radiators shown on the approved ground and first floor plans, detailed drawings in respect of the following shall be submitted to and approved in writing by the local planning authority before the relevant part of the work is begun:

(a) 1:50 scale layout floor plans of radiators and associated pipework routes;

(b) elevations showing radiators at 1:10/ 1:20 on internal elevations; (c) sections showing notching at minimum scale 1:5 (all fully annotated).

The relevant part of the works shall not be carried out otherwise than in accordance with the details thus approved.

Executive summary

This report provides details of the location of the radiators in the ground and first floor of 1 and 1A Montague Street. The proposed locations of new radiators have been revised in line with informative 3 of the listed building consent decision notice. These are to be situated away from the niches either side of the fires places. In general radiators have been located in the same place as the previous radiators, leading to the re-use of the existing pipe routes and minimising the damage to the historic fabric through the need to make new penetrations.

On site investigates have revealed that, in general there is very little need for new notching to the existing floor joists. In the ground floor we have been able to locate the radiators in their original positions, and other than some localised notching to a few joists directly in front of the mechanical riser we are able to reuse the existing routes, either running between joists or where there is existing notching. In the first floor the floor build up allows for pipes to be run between the two sets of joists, and no new notching is required.

The following internal elevations show the size, scale and location of the radiators in each room on ground and first floor, the following plans demonstrate the minimal requirement for new notching.

Contents


- Radiator routes Plans а b Internal elevations
- Radiator routes Sections С
- d Pictures of existing routes

a Radiator routes - Plans





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	AND ISSUED.	S SHOULD BE CHECKED ON SITE.		
	DO NOT SCALE FROM THIS DRAWING. ANY DRAWING ERRORS OR DIVERGENCES SHOULD BE BROUGHT TO THE ATTENTION OF BUILDING DESIGN PARTNERSHIP LTD AT THE ADDRESS SHOWN BELOW.			
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		NEW NOTCHING REQUIRED		
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	DRAWING TITLE 1-1A Monta Ground Flo		scale 1:50@A1	
10m		adiator routes	DATE May '18	
	(50)AP01	2	REVISION	

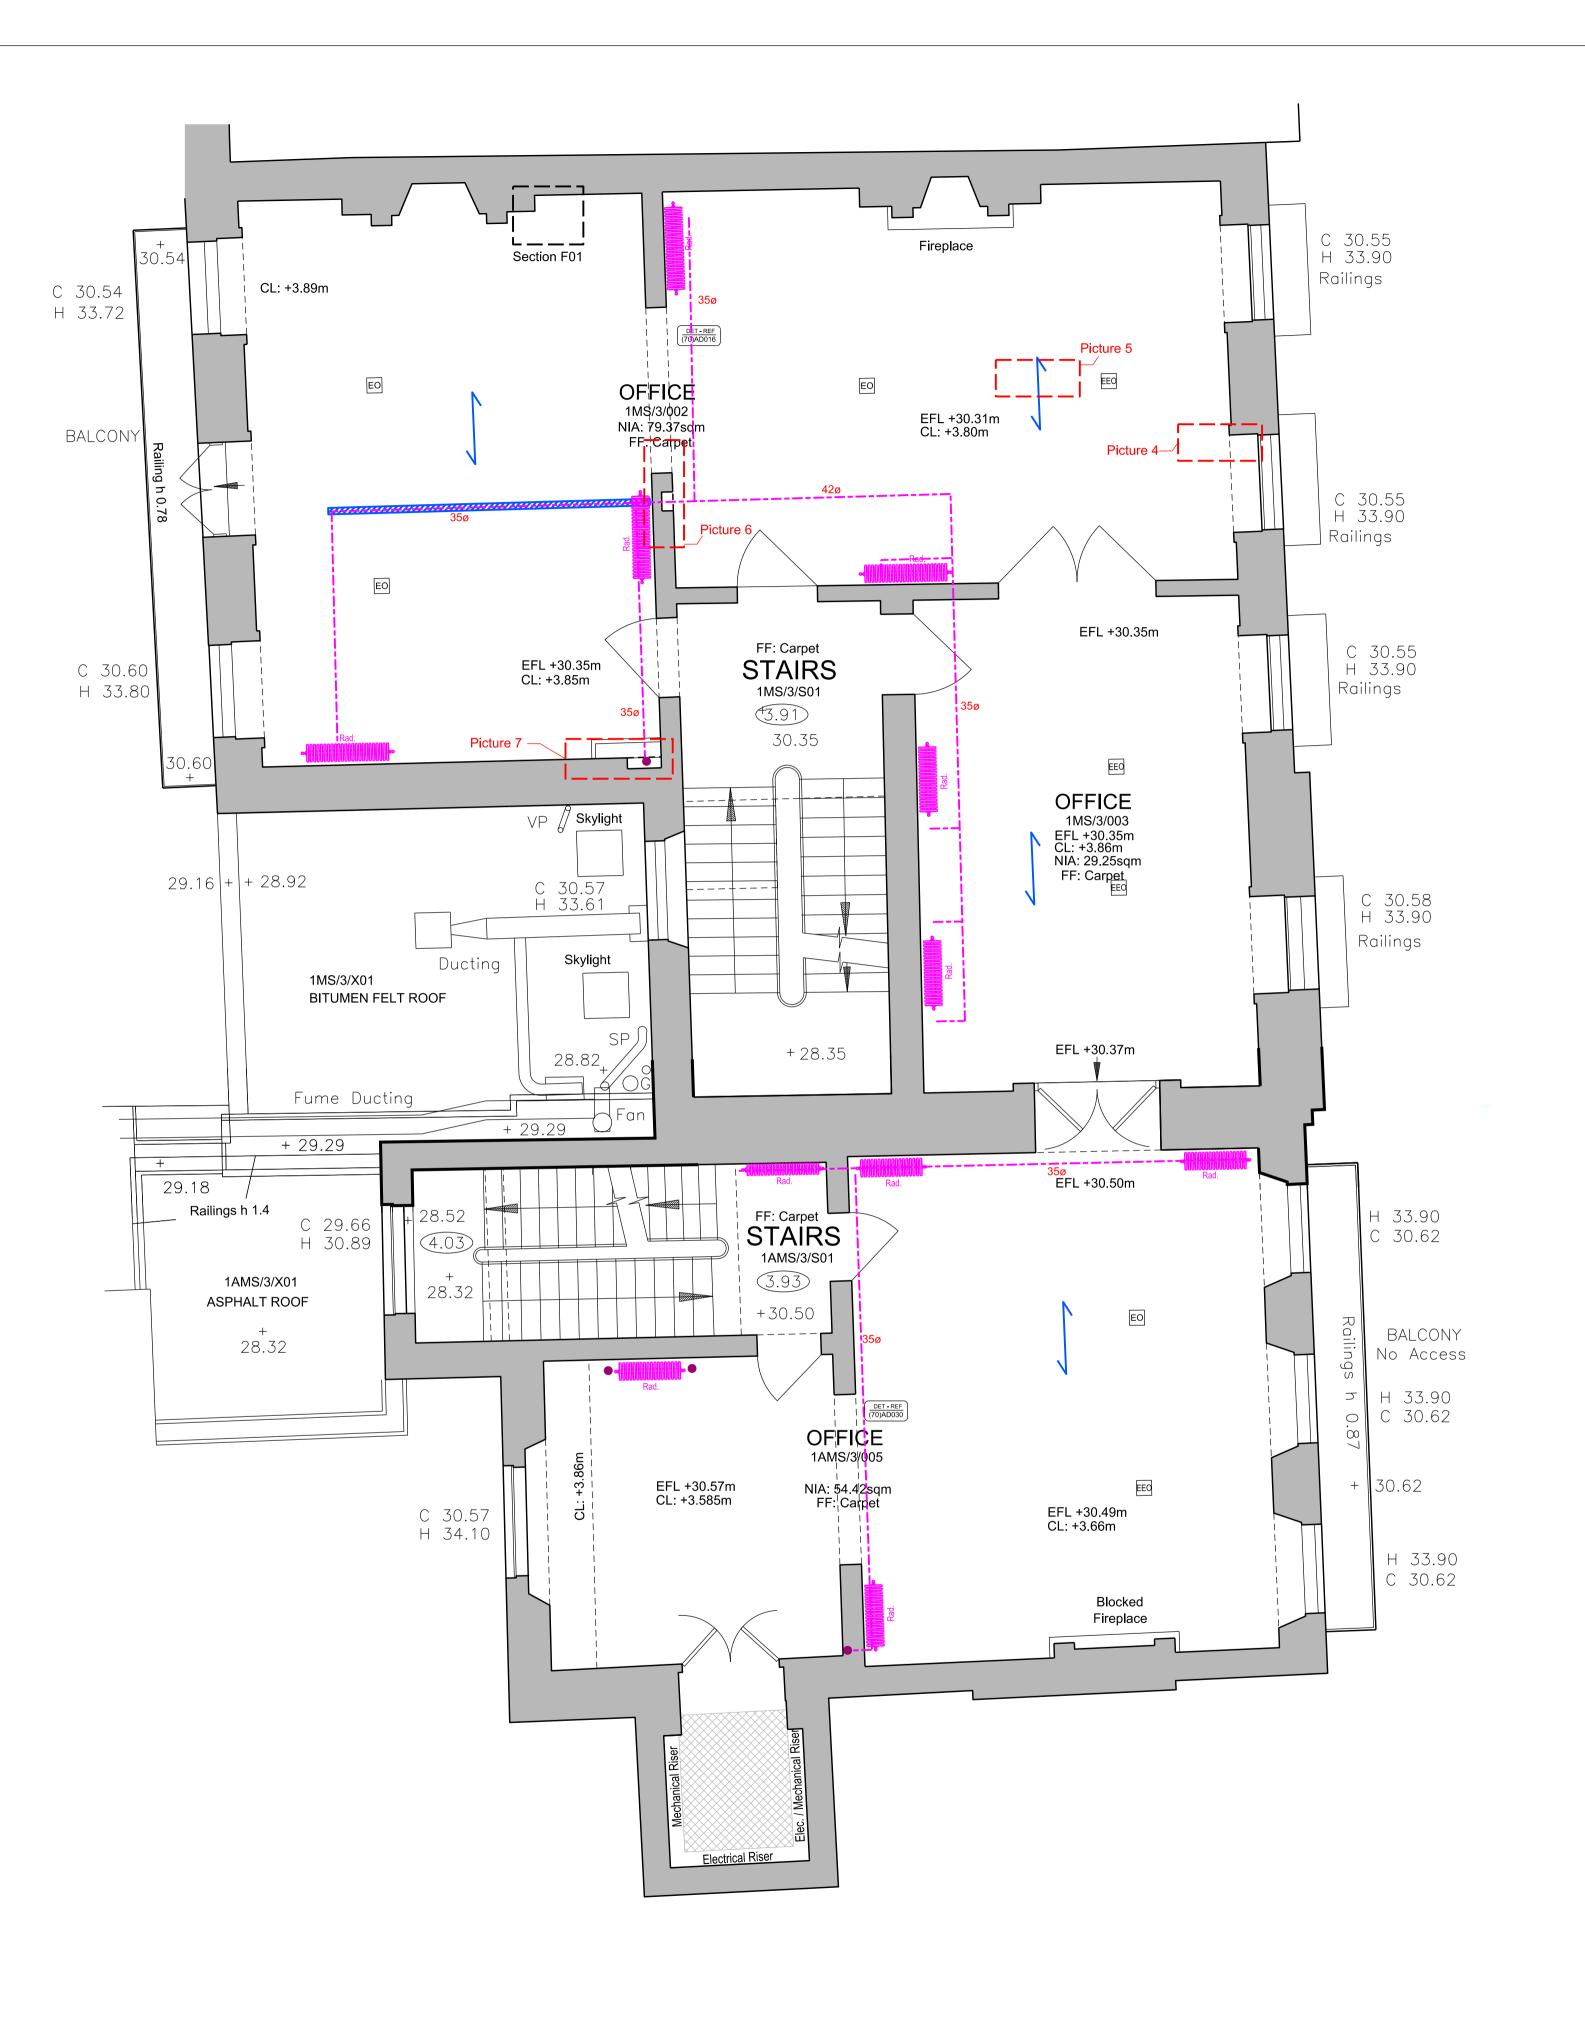


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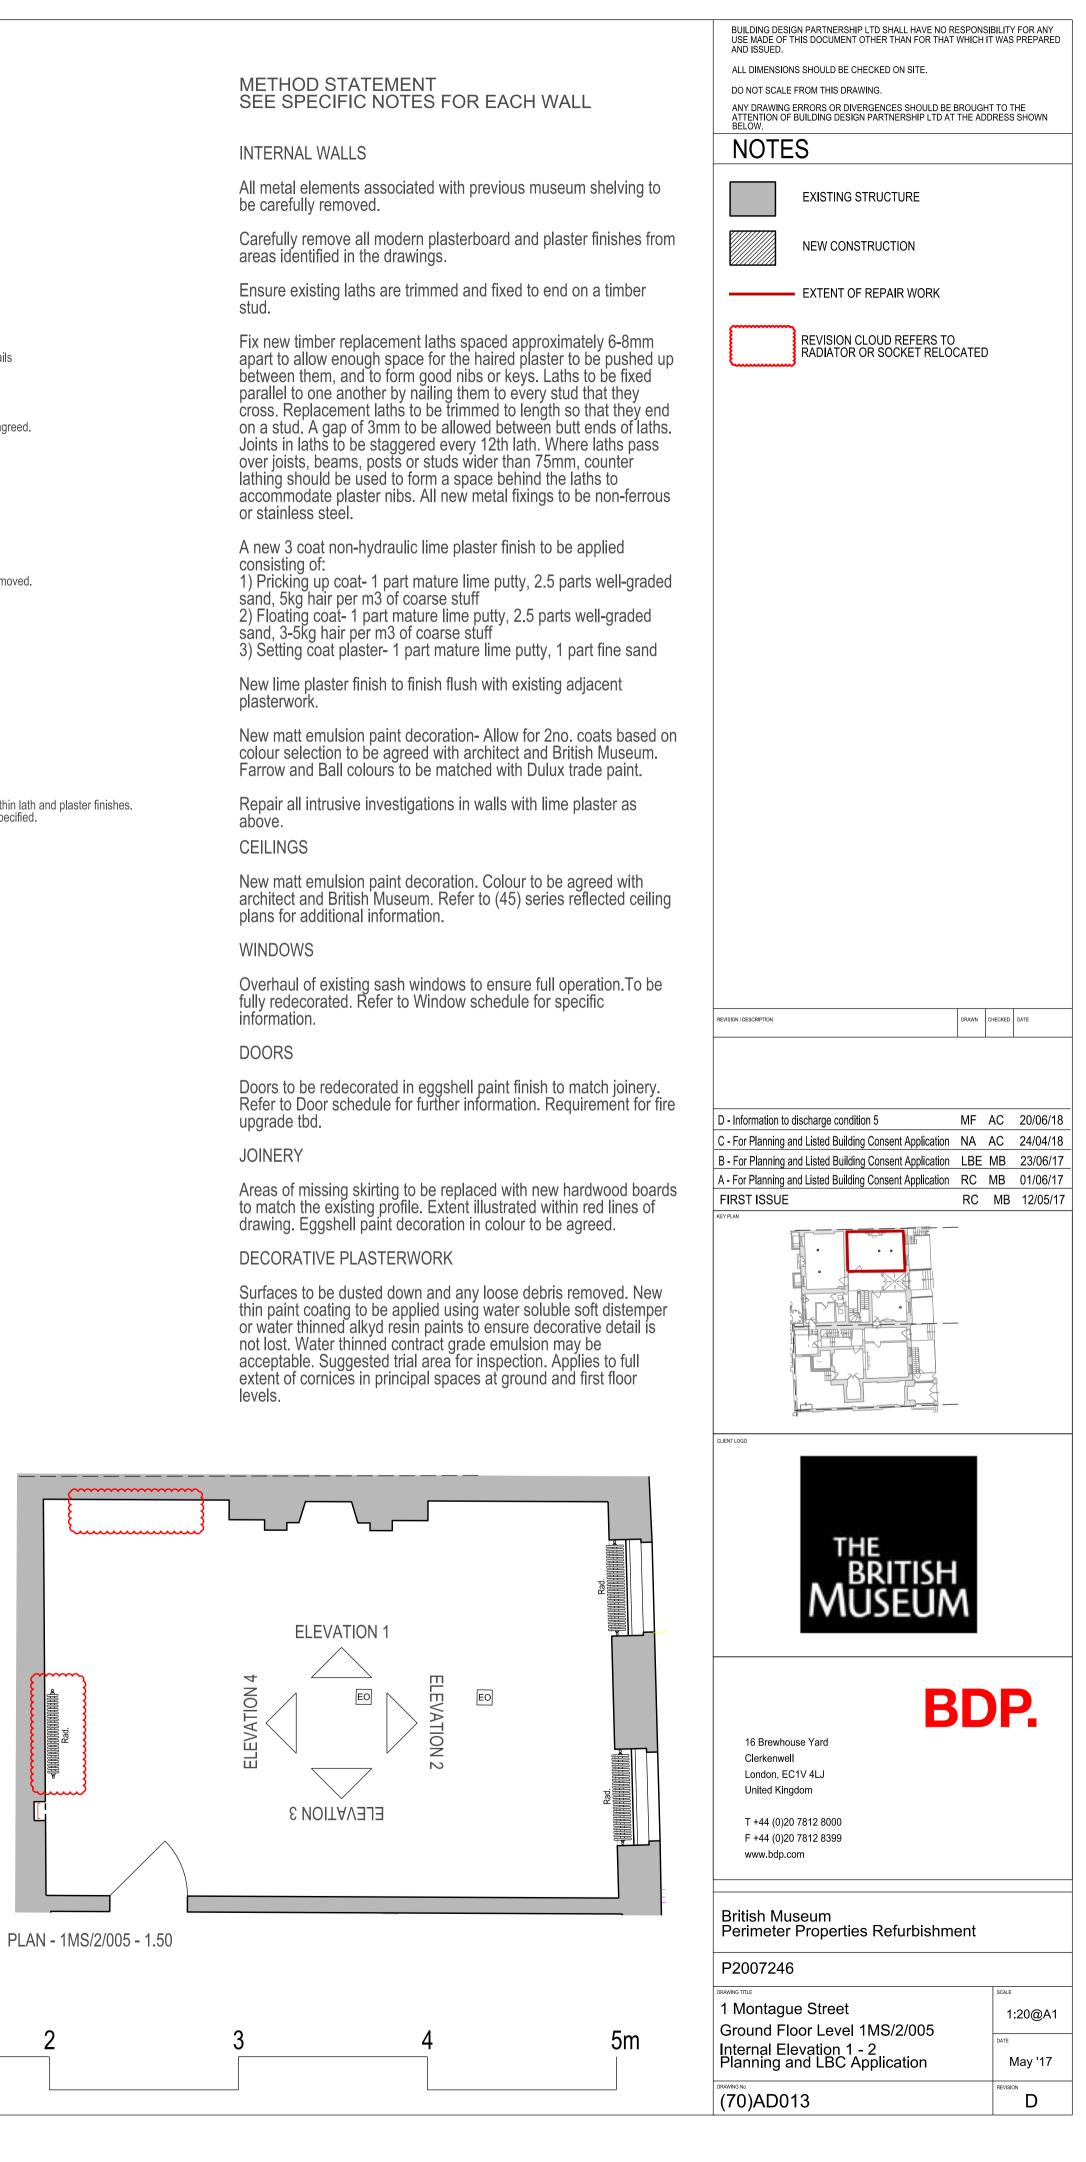
	BUILDING DESIGN PARTNERSHIP LTD SHALL HAVE NO RESPONSIBILITY FOR ANY USE MADE OF THIS DOCUMENT OTHER THAN FOR THAT WHICH IT WAS PREPARED AND ISSUED.				
	ALL DIMENSIONS SHOULD BE CHECKED ON SITE.				
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	BELOW. NOTES				
	EXISTING NOTCHES FOR PIPE RUNS TO BE RE-USED				
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	SPAN OF TIMBER JOISTS				
	RADIATOR ROUTES THROUGH EXISTING NOTCHING				
	NEW NOTCHING REQUIRED				
	RADIATOR PIPEWORK ROUTE RUN BETWEEN JOISTS				
	OPENING THROUGH CONCRETE SCREED REQUIRED AT FLOOR LEVEL				
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	British Museum Perimeter Properties Refurbishment				
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	1-1A Montague Street 1:500 First Floor Plan	@A1			
10m	Proposed radiator routes May	'18			
	drawing no. (50)AP013 -				

b Internal elevations



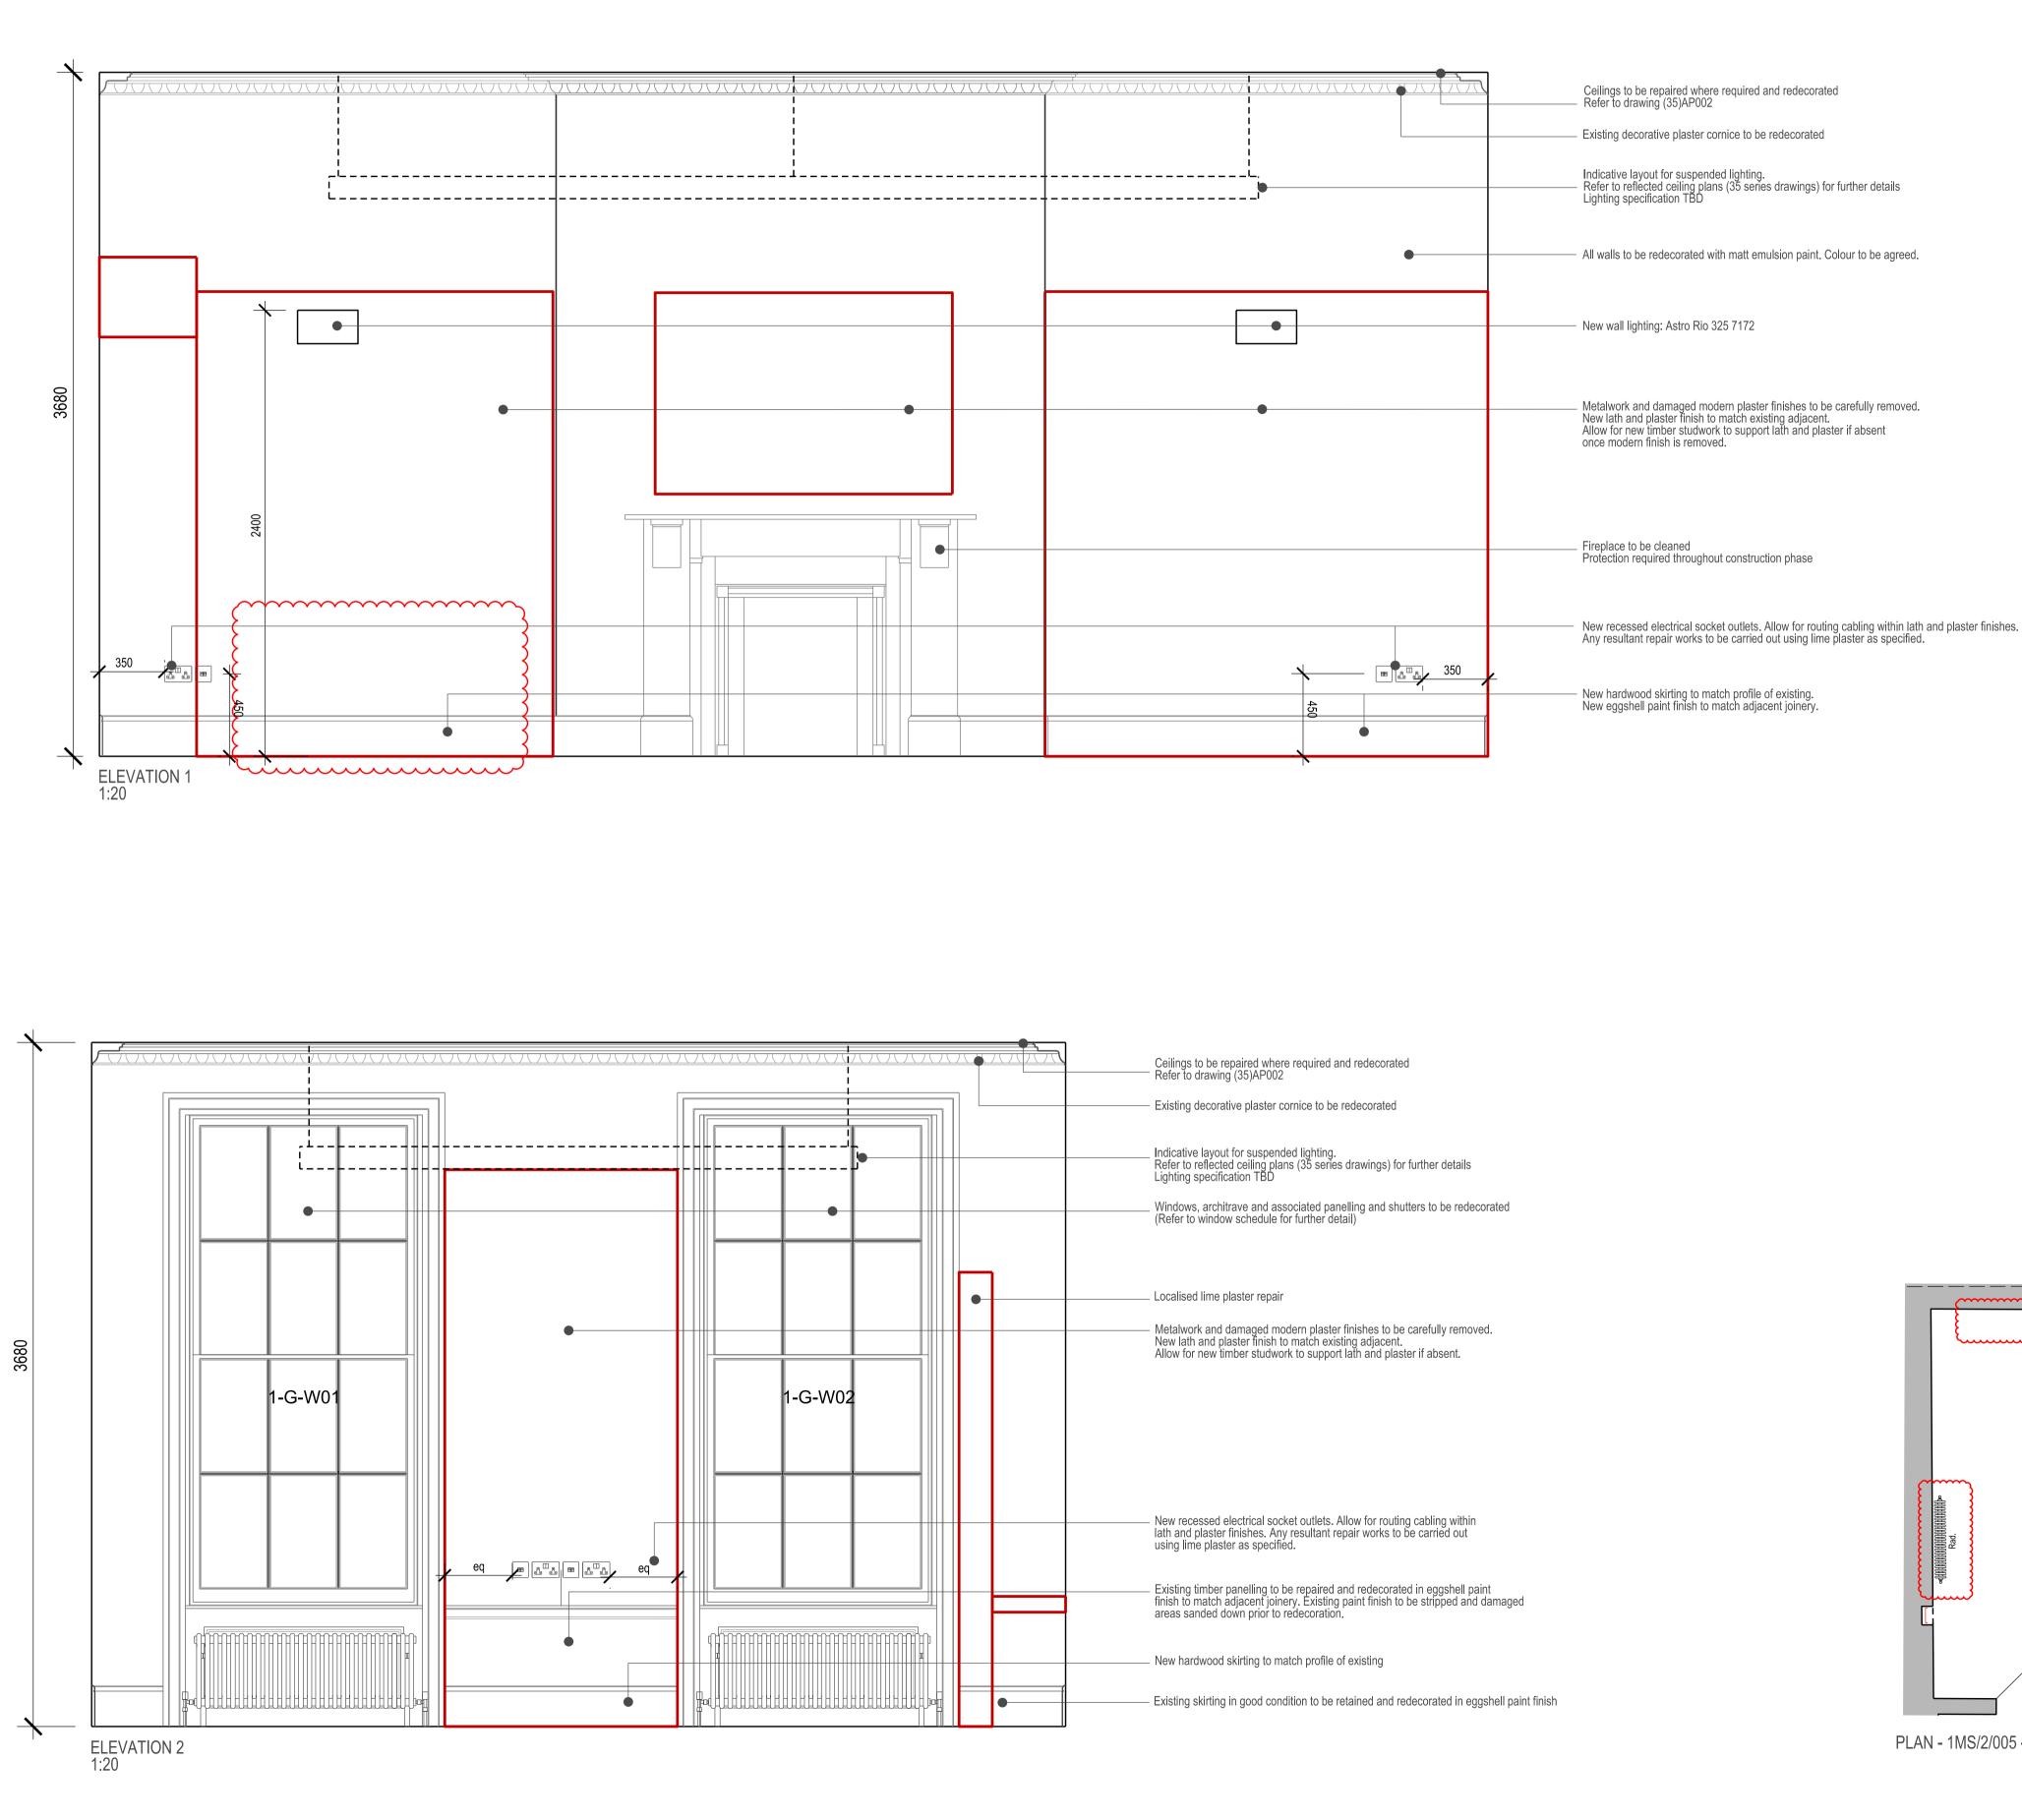


upgrade tbd.



Scale bar

1:20

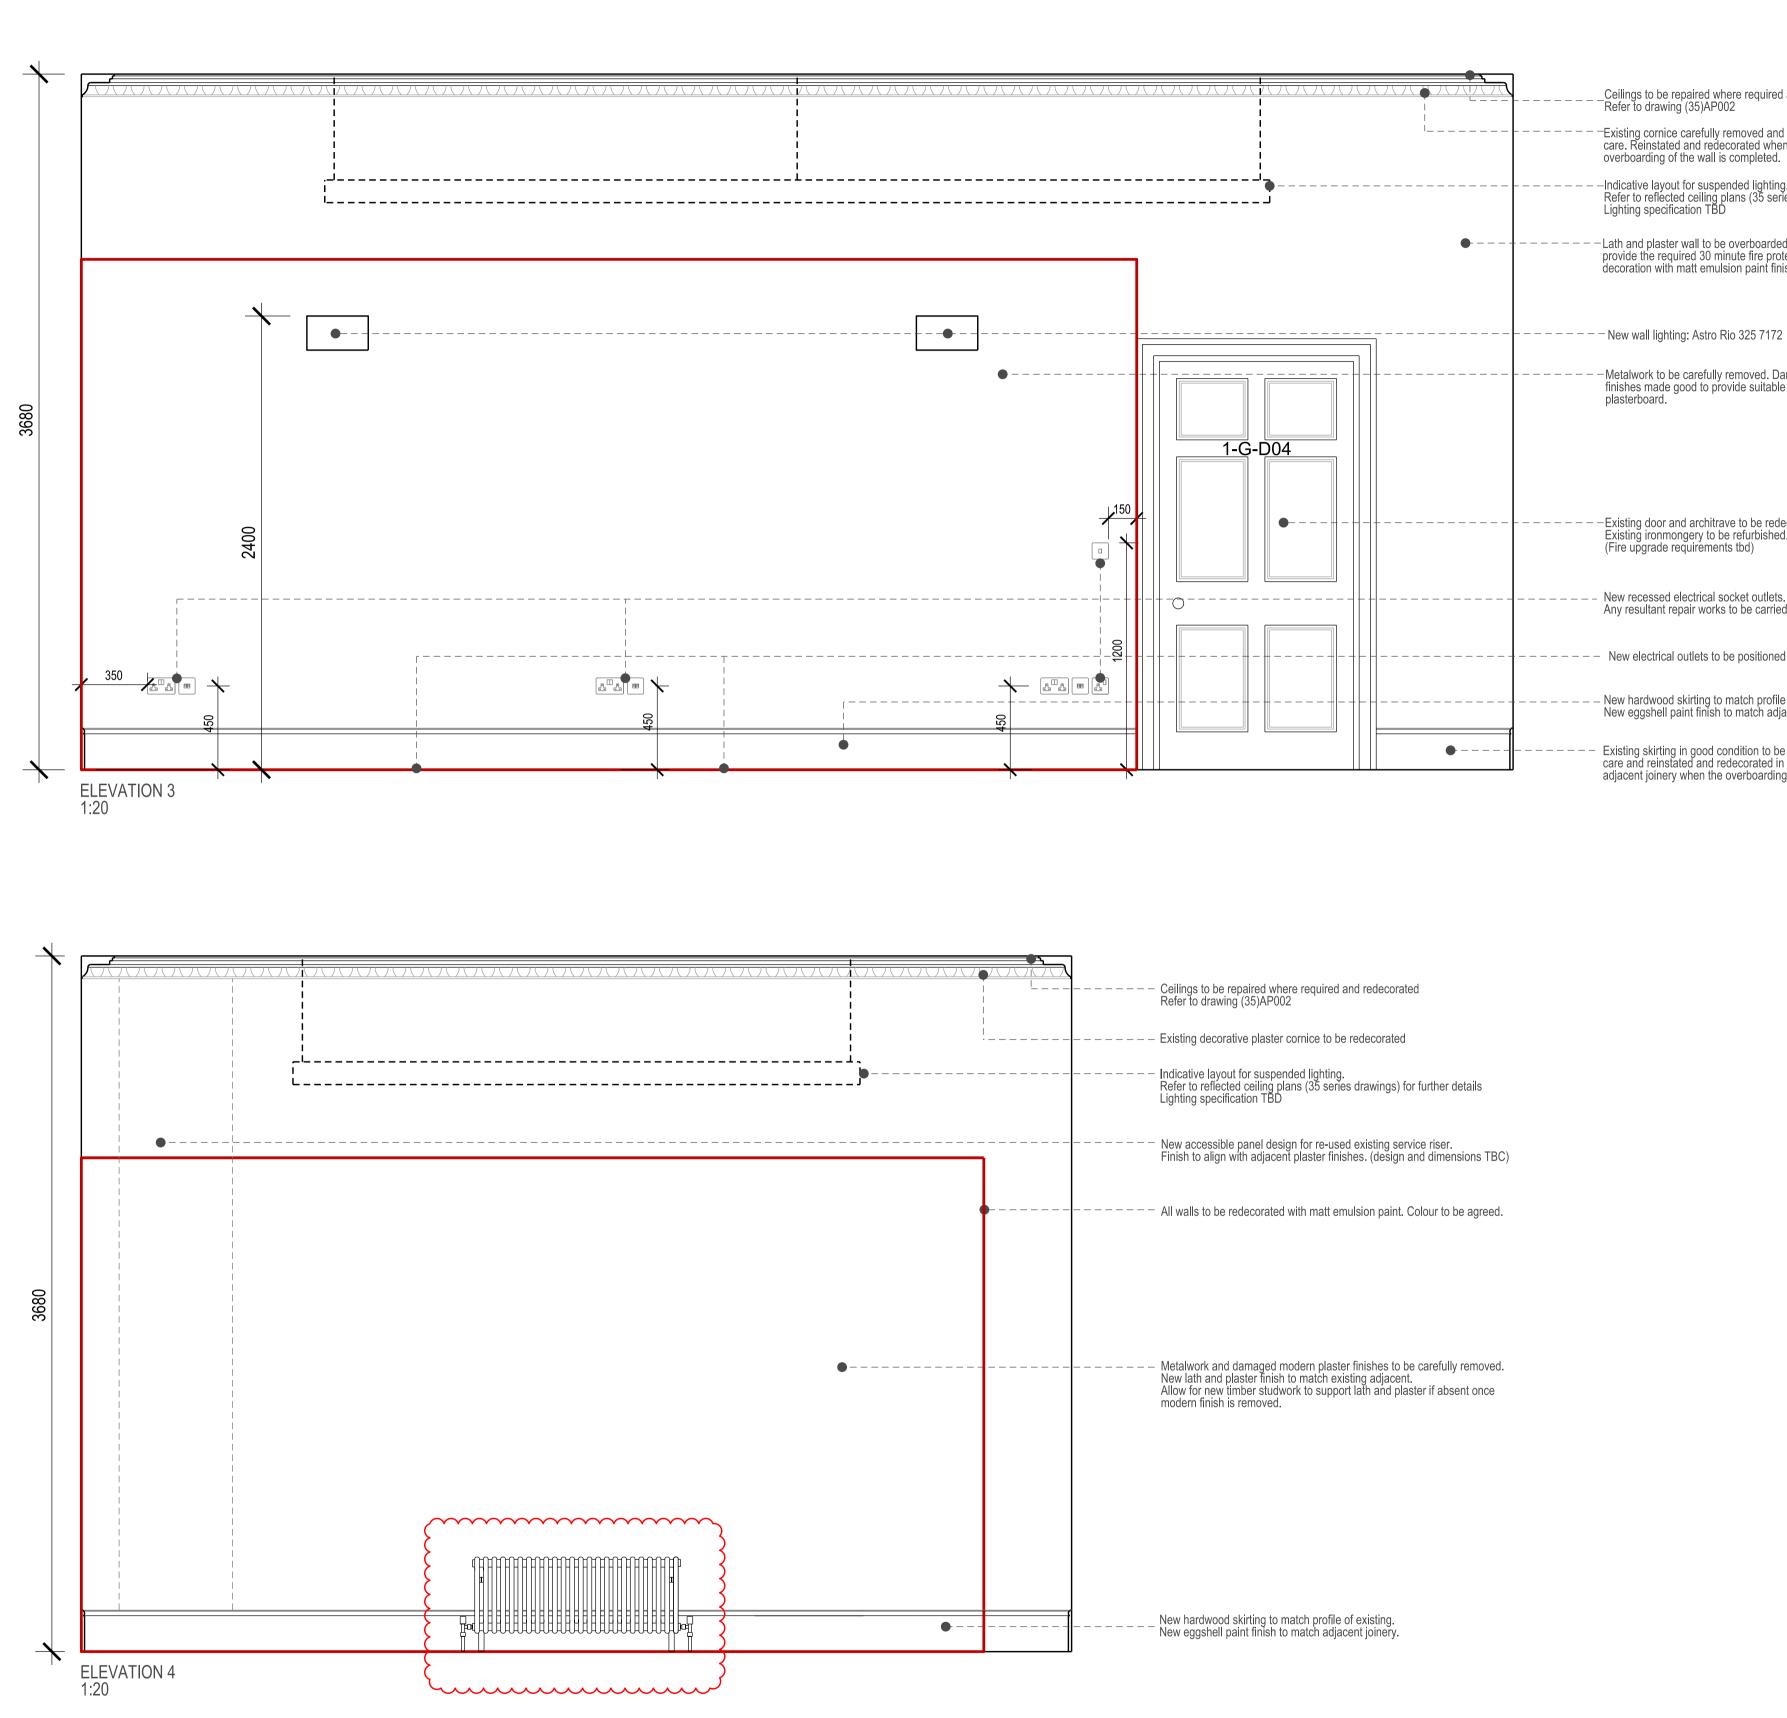


stud.

consisting of:

above. CEILINGS

information.

upgrade tod.

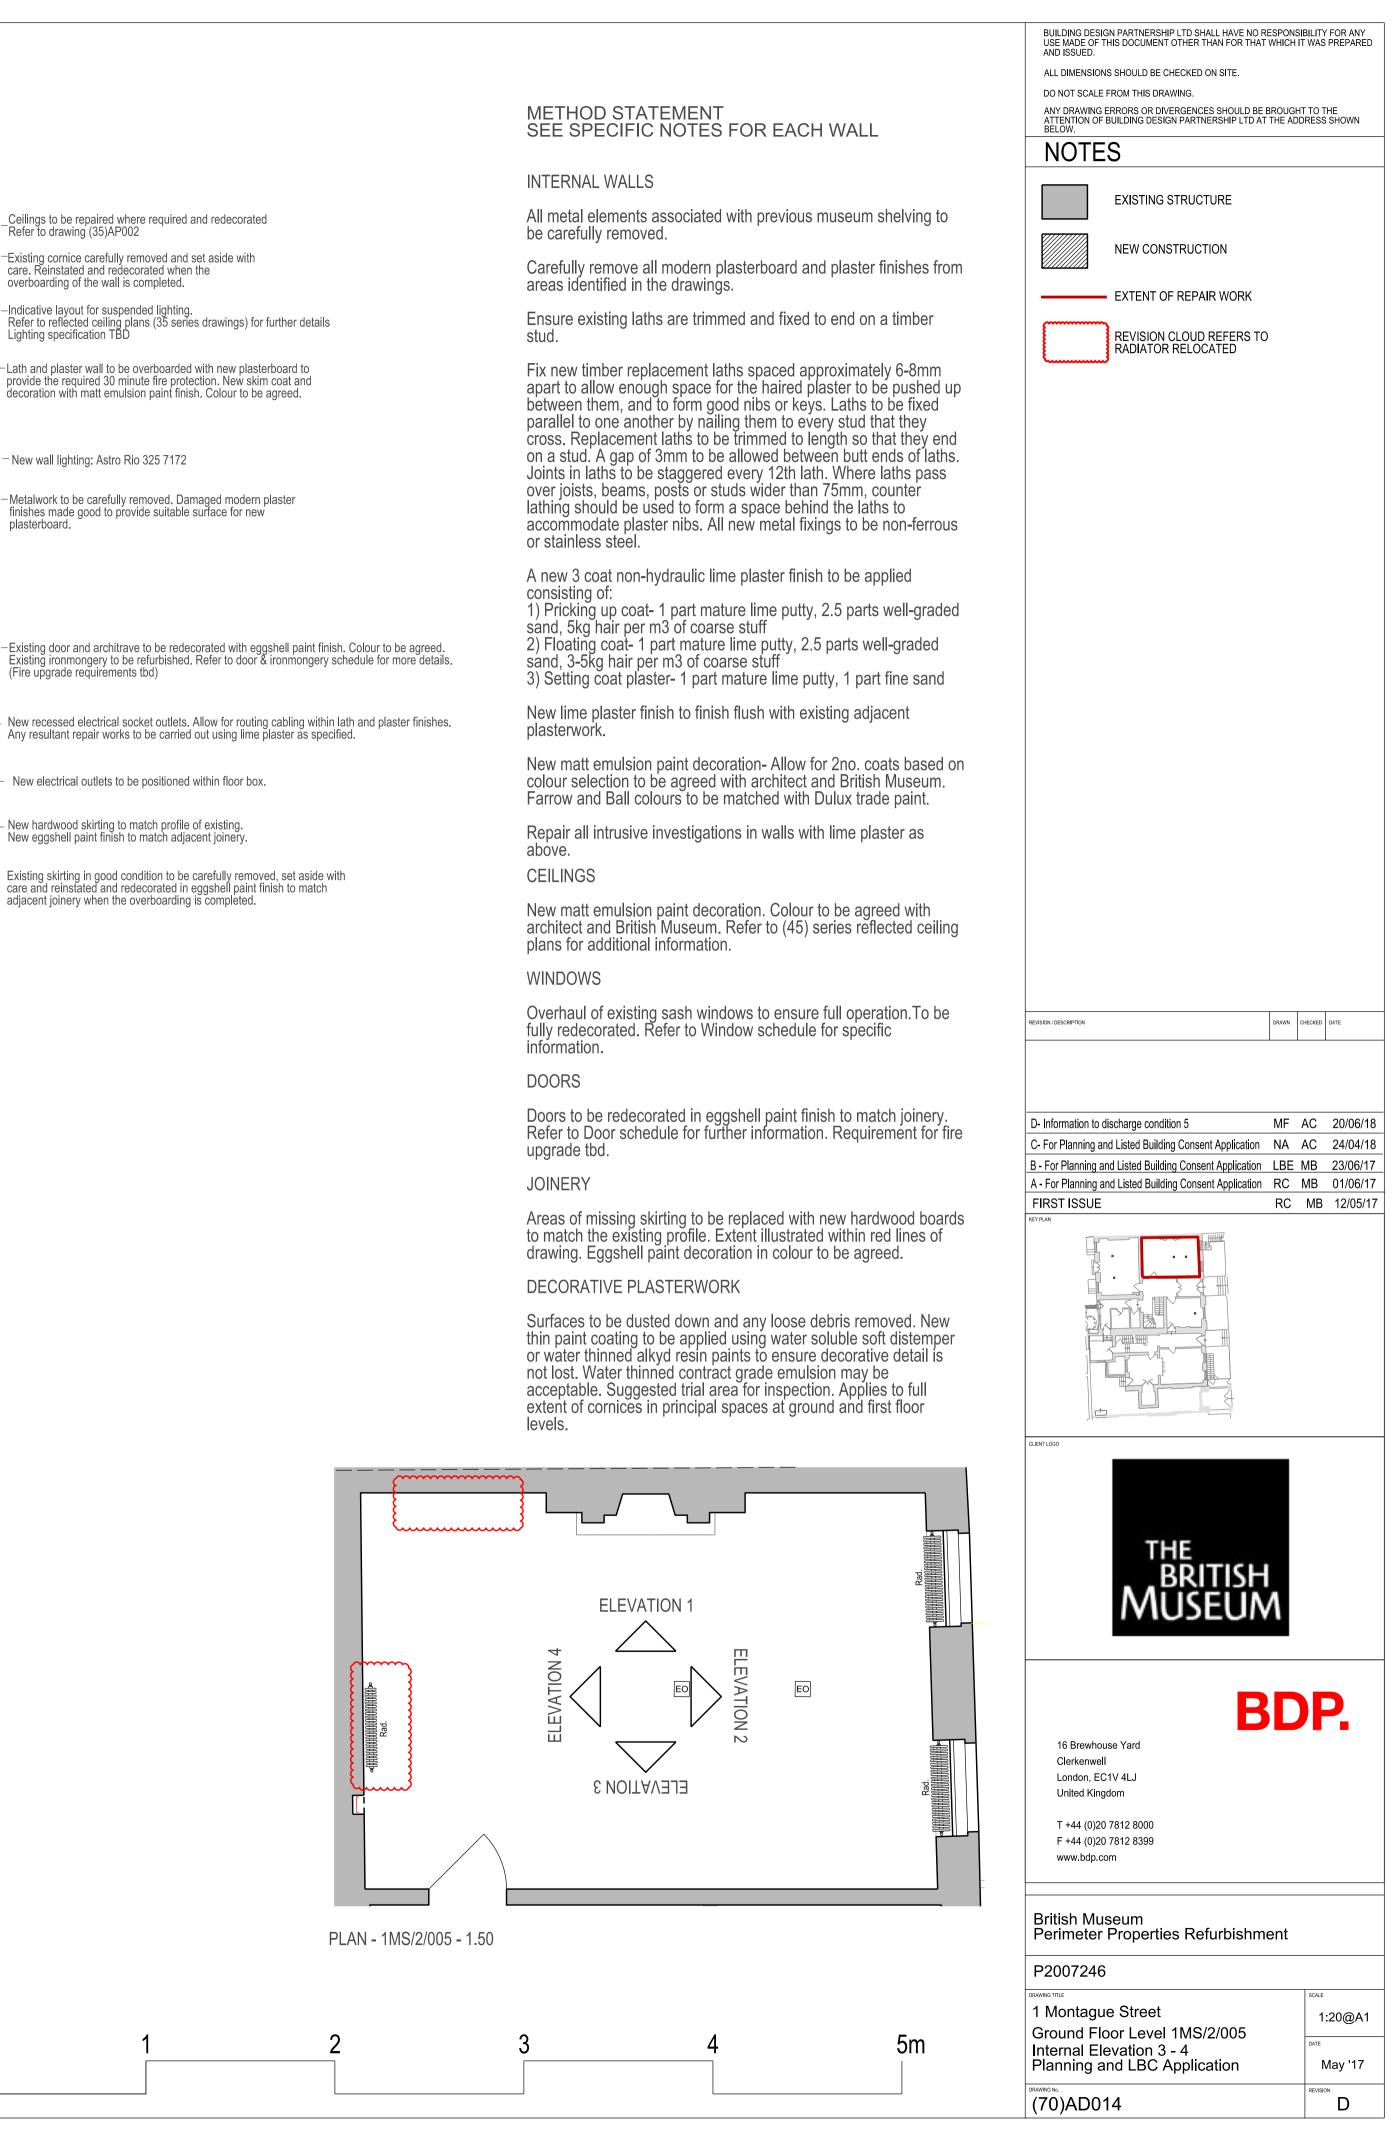

Scale bar 1:20

Ceilings to be repaired where required and redecorated Refer to drawing (35)AP002

- Lath and plaster wall to be overboarded with new plasterboard to

provide the required 30 minute fire protection. New skim coat and

decoration with matt emulsion paint finish. Colour to be agreed.

-Metalwork to be carefully removed. Damaged modern plaster

finishes made good to provide suitable surface for new

New electrical outlets to be positioned within floor box.

New hardwood skirting to match profile of existing.
New eggshell paint finish to match adjacent joinery.

adjacent joinery when the overboarding is completed.

care and reinstated and redecorated in eggshell paint finish to match

plasterboard.

Existing cornice carefully removed and set aside with care. Reinstated and redecorated when the

overboarding of the wall is completed.