




- 1. The use of this data by the recipient acts as an agreement of the following statements. Do not use this data if you do not agree with any of the following statements.
- This drawing remains the copyright of Landform Consultants Ltd.
 Do not scale the drawing. All dimensions are in millimetres unless otherwise indicated. Use figured dimensions in all cases. Check all
- 4. Report any discrepancies or omissions to the Landscape Architects before
- proceeding.

 5. This document is to be read in conjunction with the specification and all other project documentation.

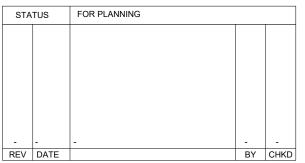


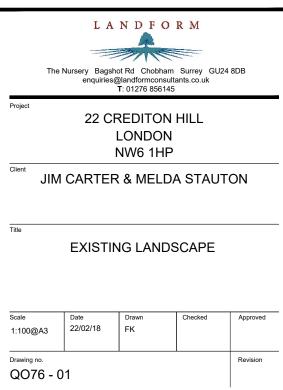


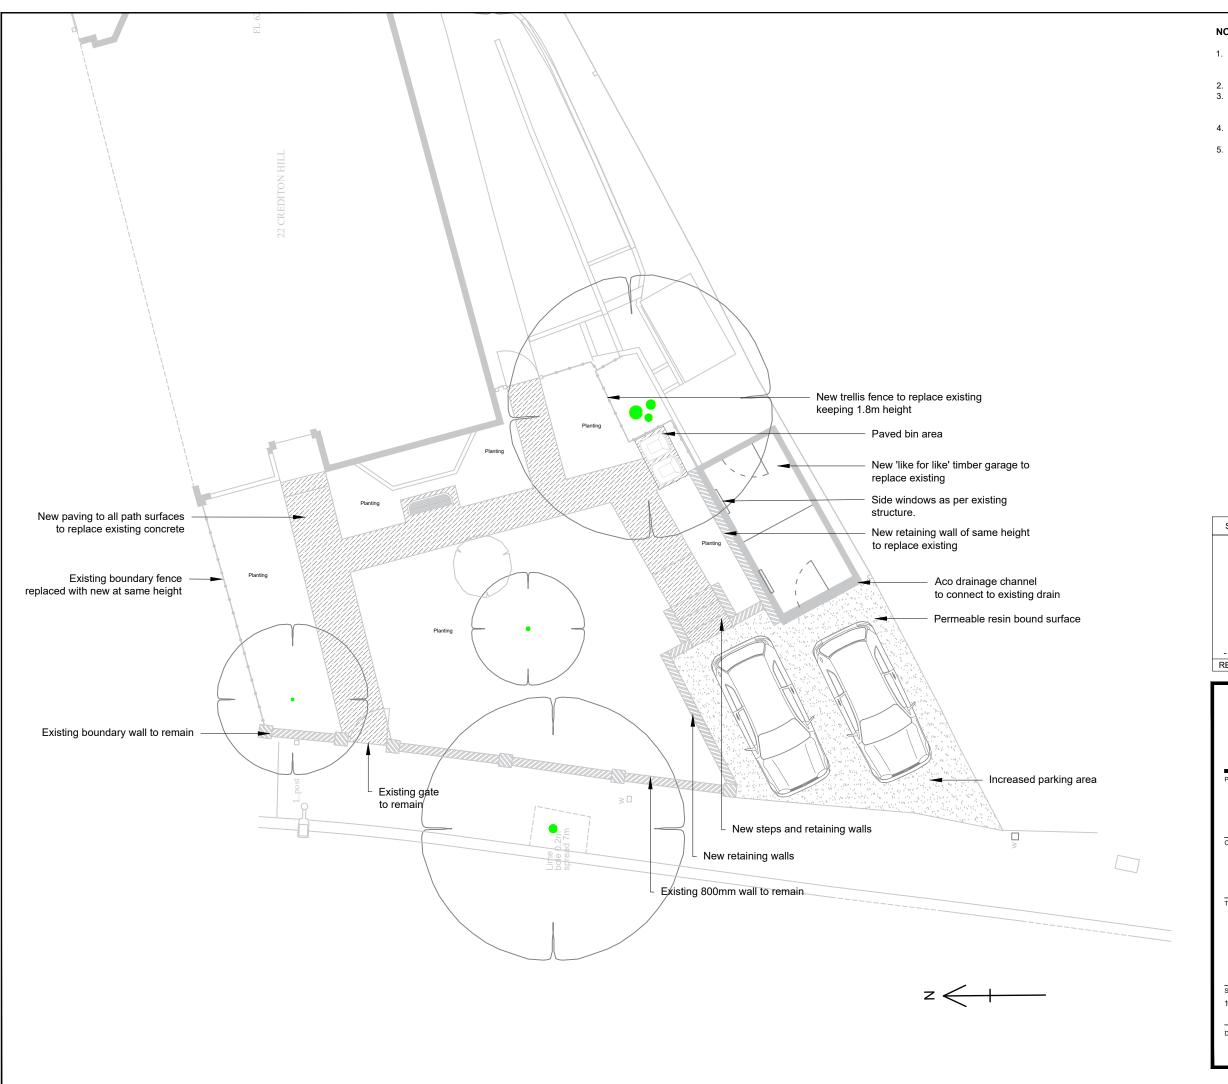

- 1. The use of this data by the recipient acts as an agreement of the following statements. Do not use this data if you do not agree with any of the following statements.
- This drawing remains the copyright of Landform Consultants Ltd.
 Do not scale the drawing. All dimensions are in millimetres unless otherwise indicated. Use figured dimensions in all cases. Check all
- 4. Report any discrepancies or omissions to the Landscape Architects before
- This document is to be read in conjunction with the specification and all other project documentation.




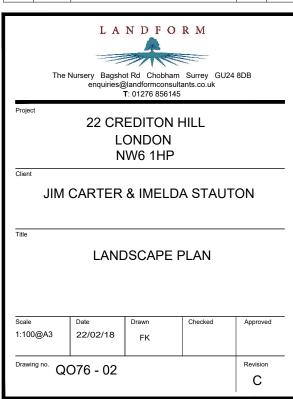


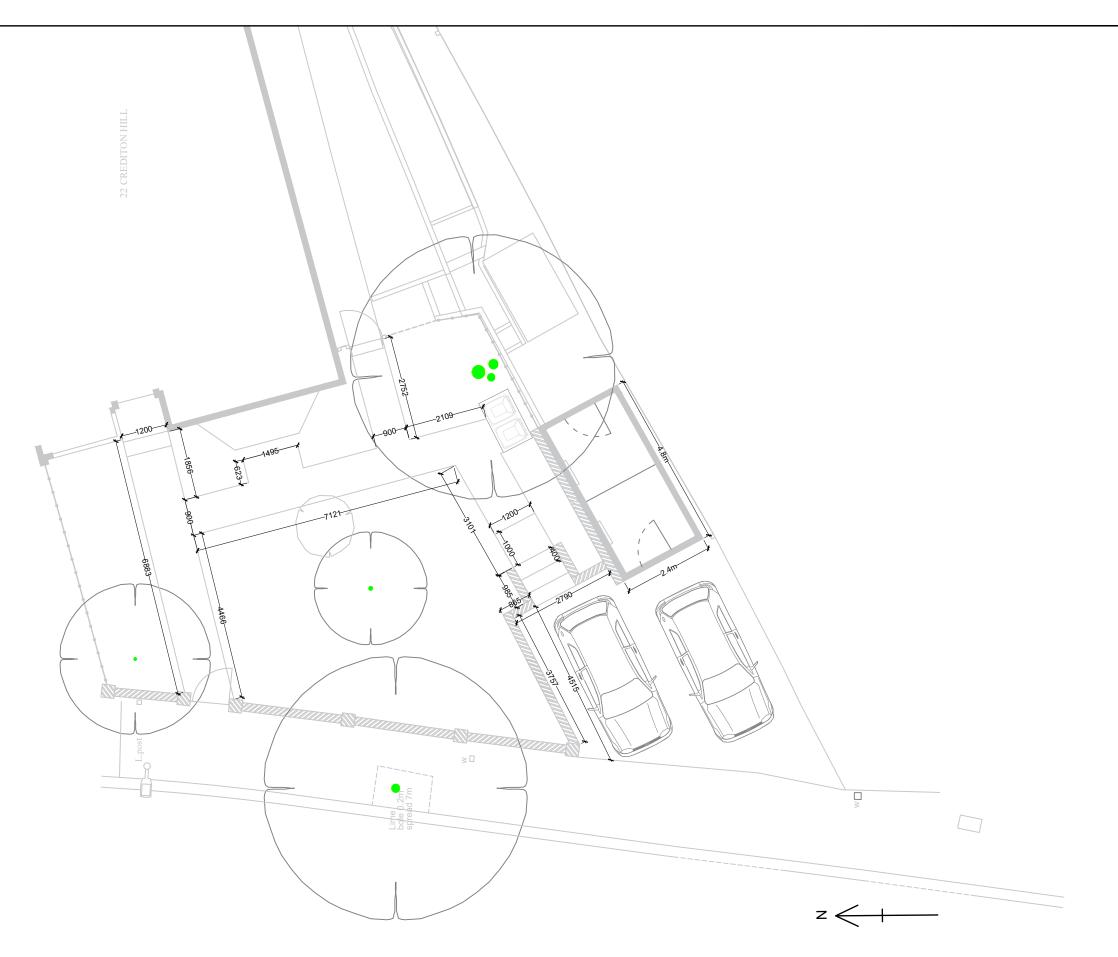

- 1. The use of this data by the recipient acts as an agreement of the following statements. Do not use this data if you do not agree with any of the following statements.
- This drawing remains the copyright of Landform Consultants Ltd.
 Do not scale the drawing. All dimensions are in millimetres unless otherwise indicated. Use figured dimensions in all cases. Check all
- 4. Report any discrepancies or omissions to the Landscape Architects before
- proceeding.

 5. This document is to be read in conjunction with the specification and all other project documentation.

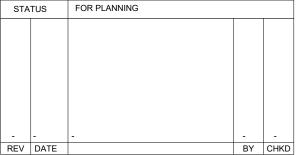

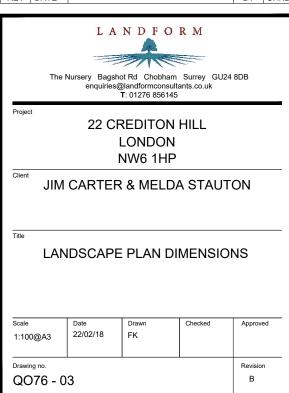

60.92

NOTES


- 1. The use of this data by the recipient acts as an agreement of the following statements. Do not use this data if you do not agree with any of the following statements.
- This drawing remains the copyright of Landform Consultants Ltd.
 Do not scale the drawing. All dimensions are in millimetres unless otherwise indicated. Use figured dimensions in all cases. Check all
- 4. Report any discrepancies or omissions to the Landscape Architects before
- proceeding.


 5. This document is to be read in conjunction with the specification and all other project documentation.


KEY

61.62 EXISTING LEVELS

60.43 NEW LEVELS

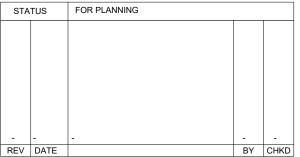

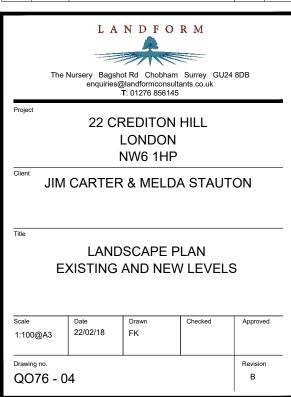

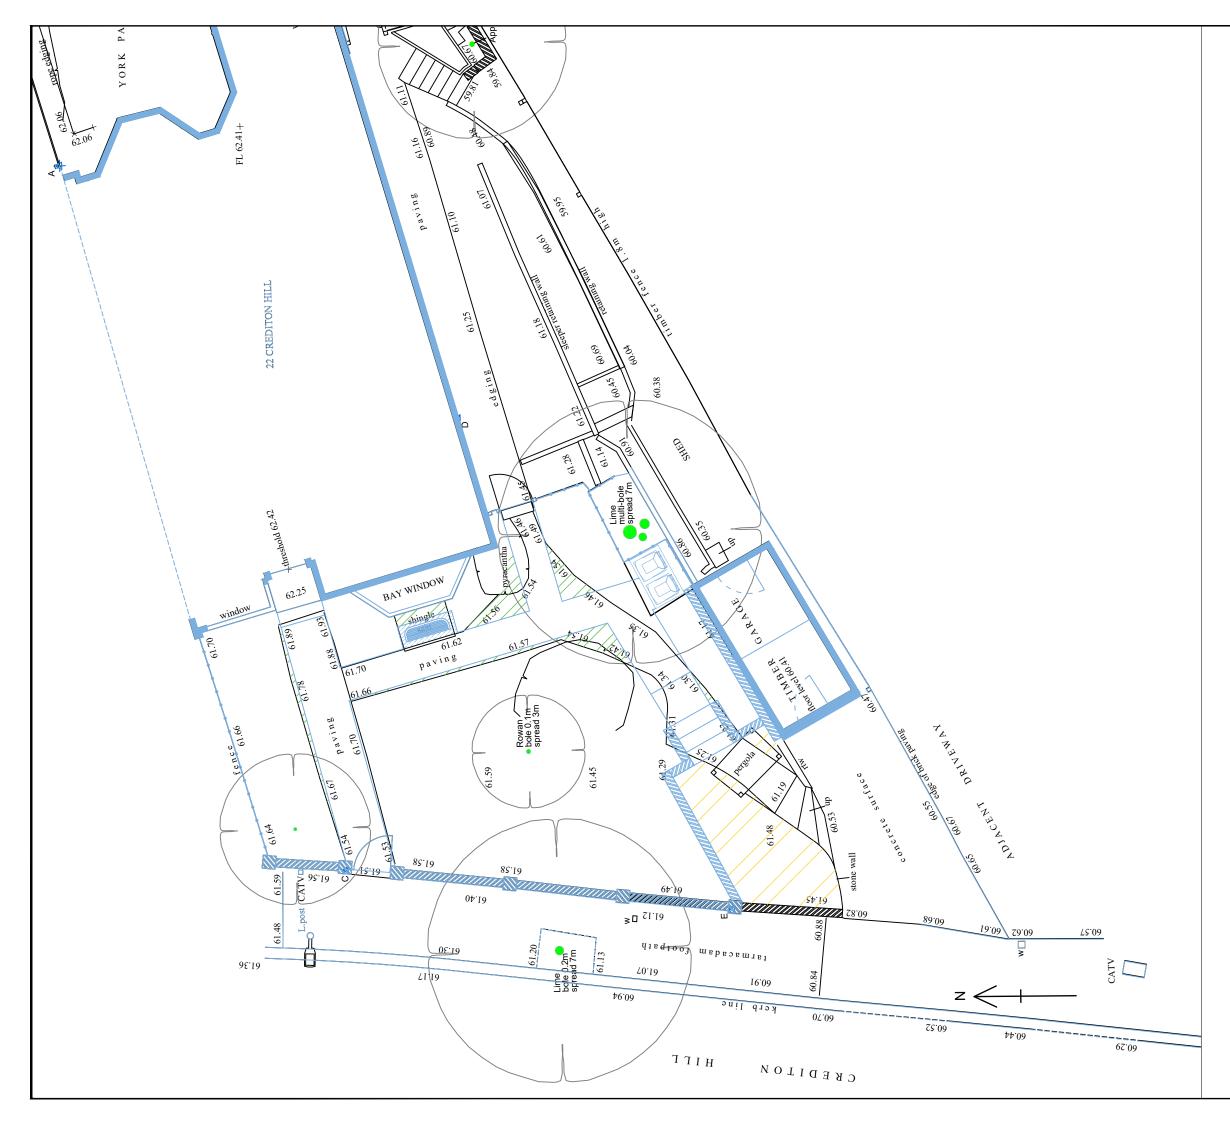

- 1. The use of this data by the recipient acts as an agreement of the followir statements. Do not use this data if you do not agree with any of the following statements.
- This drawing remains the copyright of Landform Consultants Ltd.
 Do not scale the drawing. All dimensions are in millimetres unless otherwise indicated. Use figured dimensions in all cases. Check all
- 4. Report any discrepancies or omissions to the Landscape Architects befo
- This document is to be read in conjunction with the specification and all other project documentation.

KEY

EXISTING LAYOUT IN BLACK

NEW LAYOUT IN BLUE

LOSS OF PLANTING

INCREASE IN PLANTING

AREA	EXISTING m ²	NEW m ²	+/- m ²
Footpaths (concrete/paving)	32.9m ²	24.5m ²	- 8.4m²
Drive (non permeable concrete)	19.4m²		
Drive (permeable surface)		32m ²	+ 12.6m ²
Planting	83.1m ²	78.9m ²	- 4.2m²
Total Area	135.4m ²	135.4m ²	
·			

Non permeable surface presently covers 52.3m² of front garden. This would be decreased to 24.5m² due the reduced surface area of the path and replacement of concrete drive with permeable resin bound gravel surface. This would therefore increase the permeable surface of the garden from 83.1m² to 110.9m². There would be a small loss of planting (area of 4.2m²) however this loss of space will be replaced with vertical planting along trellis to replace any loss of bio diversity.

To reiterate the area of non permeable surfacing is decreased which will decrease the surface run off.

STATUS		FOR PLANNING		
С	10/04/18	OVERLAY OF OLD AND NEW LAYOUT	FK	-
REV	DATE		BY	CHKD

LANDFORM




The Nursery Bagshot Rd Chobham Surrey GU24 8DB enquiries@landformconsultants.co.uk
T: 01276 856145


22 CREDITON HILL LONDON NW6 1HP

JIM CARTER & MELDA STAUTON

LANDSCAPE PLAN **EXISTING AND NEW LAYOUT**

Date 10/04/18	FK Drawn	Checked	Approved
wing no. O76 - 05			
	10/04/18	10/04/18 FK	10/04/18 FK

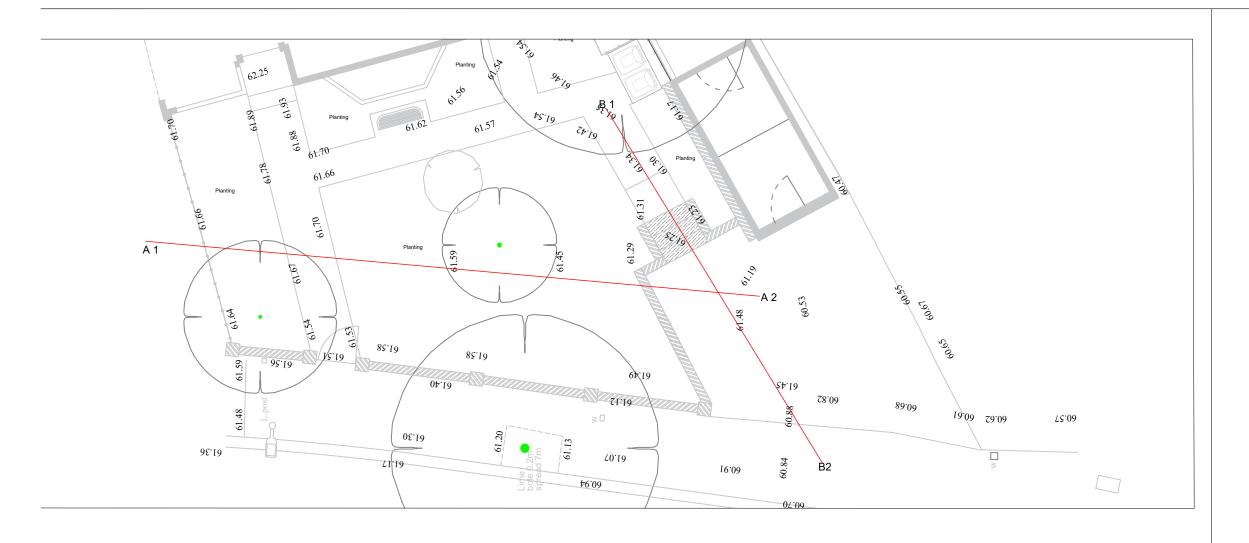

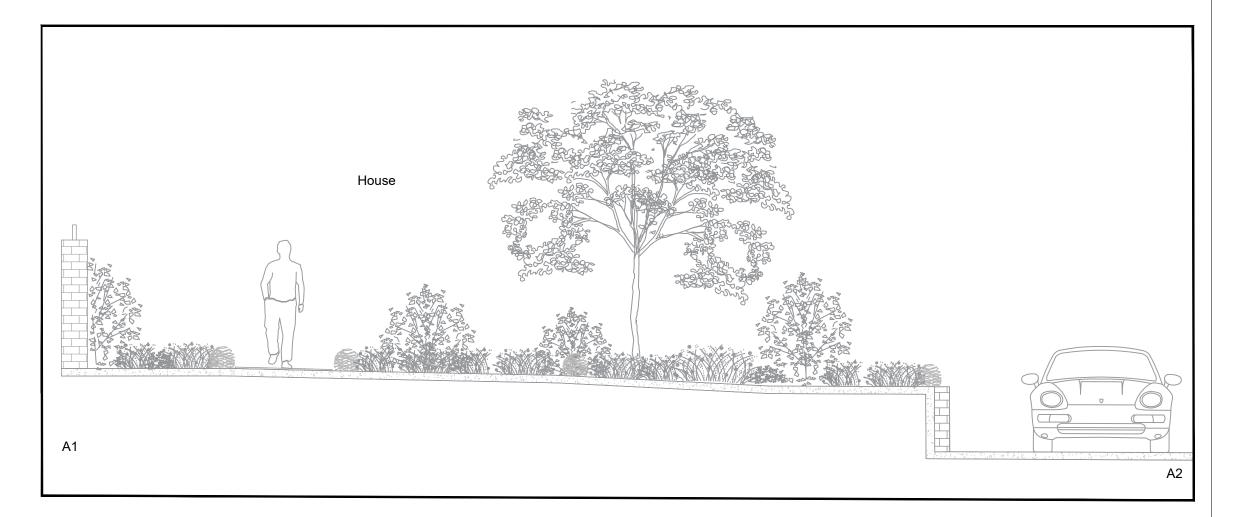

- The use of this data by the recipient acts as an agreement of the following statements. Do not use this data if you do not agree with any of the
- following statements.


 This drawing remains the copyright of Landform Consultants Ltd.


 Do not scale the drawing. All dimensions are in millimetres unless otherwise indicated. Use figured dimensions in all cases. Check all
- 4. Report any discrepancies or omissions to the Landscape Architects before
- proceeding.

 5. This document is to be read in conjunction with the specification and all other project documentation.


KEY



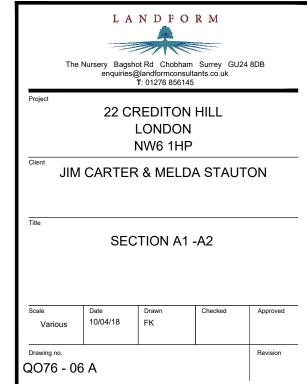


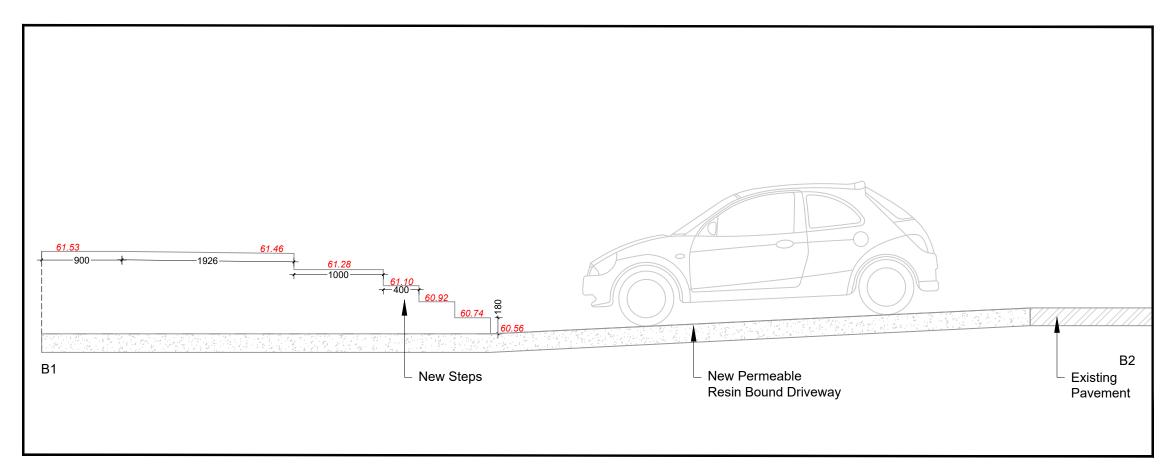

SECTION B1 - B2 (see drawing QO76 - 06A)

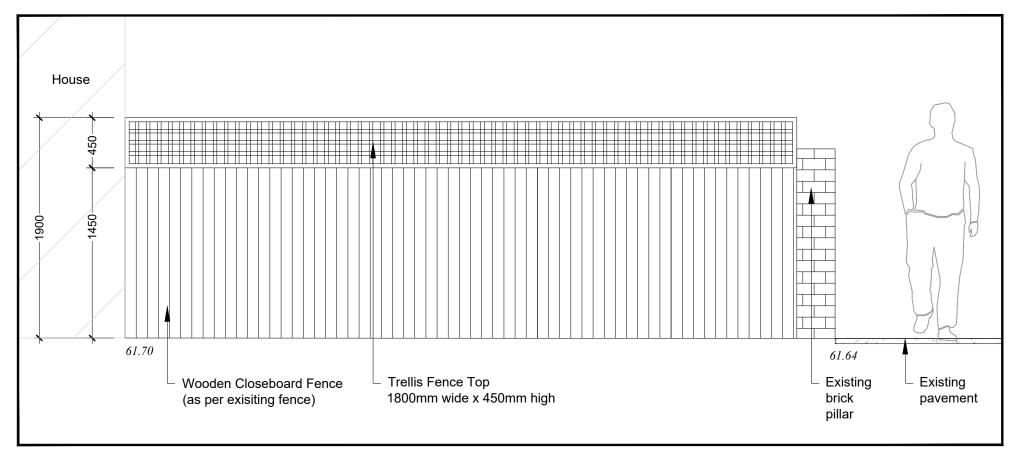




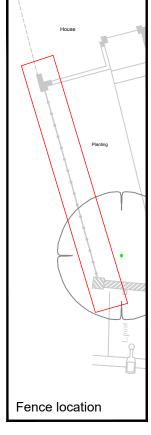



- 1. The use of this data by the recipient acts as an agreement of the following statements. Do not use this data if you do not agree with any of the following statements.
- This drawing remains the copyright of Landform Consultants Ltd.
 Do not scale the drawing. All dimensions are in millimetres unless otherwise indicated. Use figured dimensions in all cases. Check all
- 4. Report any discrepancies or omissions to the Landscape Architects before
- 5. This document is to be read in conjunction with the specification and all other project documentation.


KEY


61.62

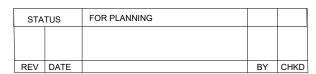

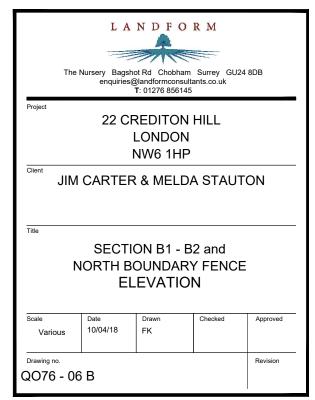

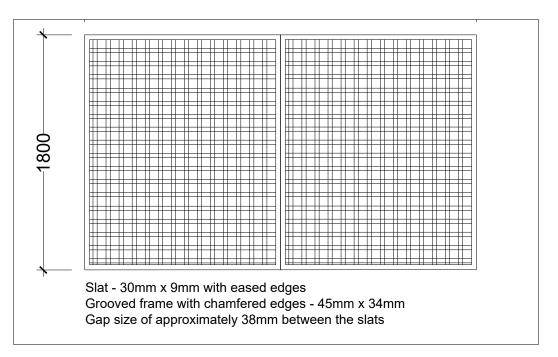

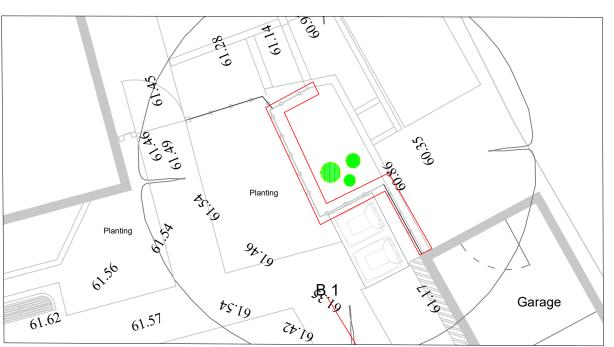

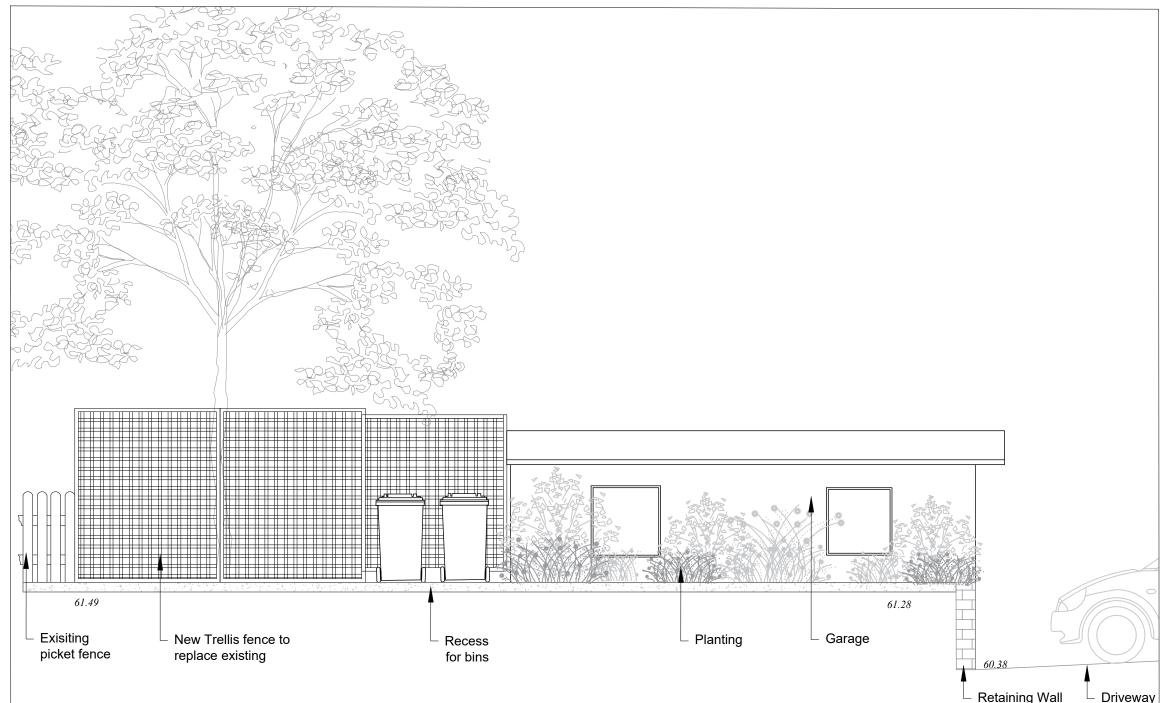



- 1. The use of this data by the recipient acts as an agreement of the following statements. Do not use this data if you do not agree with any of the following statements.
- This drawing remains the copyright of Landform Consultants Ltd.
 Do not scale the drawing. All dimensions are in millimetres unless otherwise indicated. Use figured dimensions in all cases. Check all
- 4. Report any discrepancies or omissions to the Landscape Architects before
- 5. This document is to be read in conjunction with the specification and all other project documentation


KEY

61.17 Levels

New Trellis Location to replace existing closeboard fence

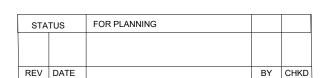

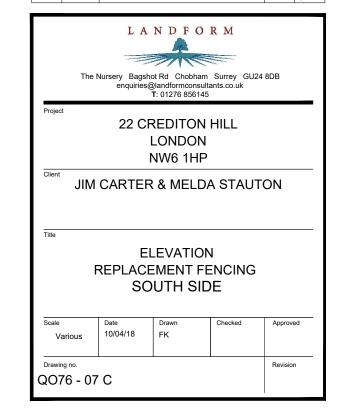

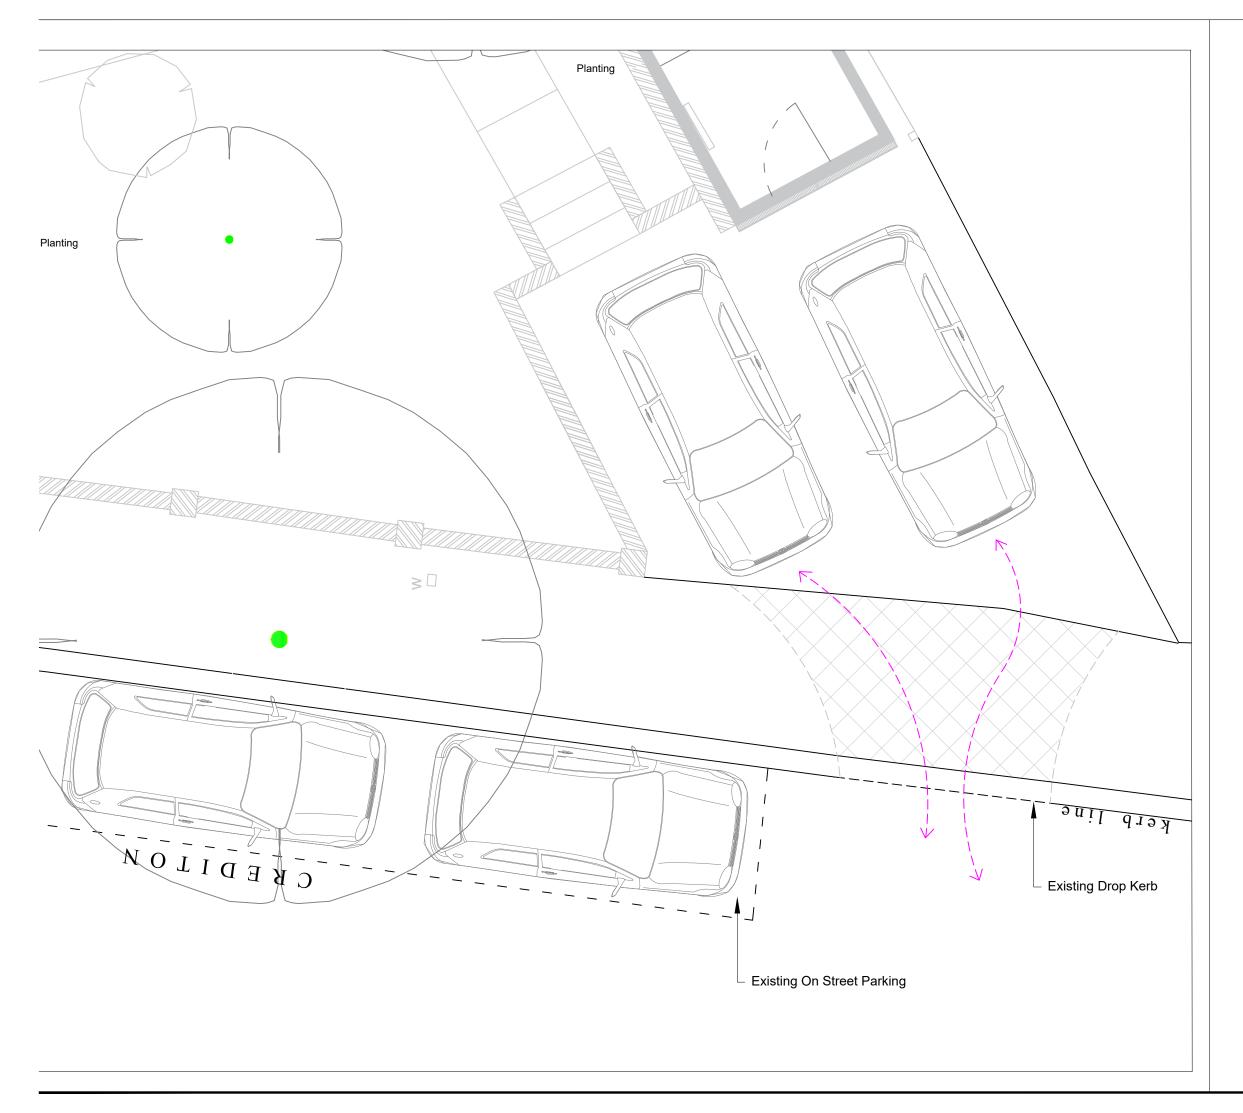

- 1. The use of this data by the recipient acts as an agreement of the following statements. Do not use this data if you do not agree with any of the following statements.
- This drawing remains the copyright of Landform Consultants Ltd.
 Do not scale the drawing. All dimensions are in millimetres unless otherwise indicated. Use figured dimensions in all cases. Check all
- 4. Report any discrepancies or omissions to the Landscape Architects before
- proceeding.

 5. This document is to be read in conjunction with the specification and all other project documentation.





Access and Egress to property




Crossover area. The existing area allows access and egress to the property without any alterations to the dropkerb or removal of on street parking.


NOTE:

The increase in width of the driveway and parking area at the property will not affect the existing on street parking or the need to increase the dropped kerb width. Access can be easily gained with the existing road / kerb / pavement layout.


The only difference to the property frontage will be the removal of a small section of wall.

STATUS		FOR PLANNING		
RFV	DATE		BY	CHKD

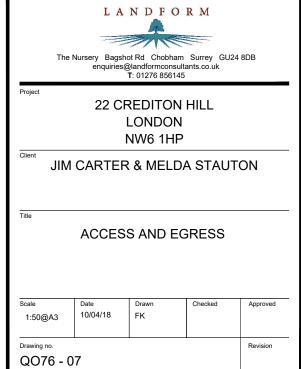

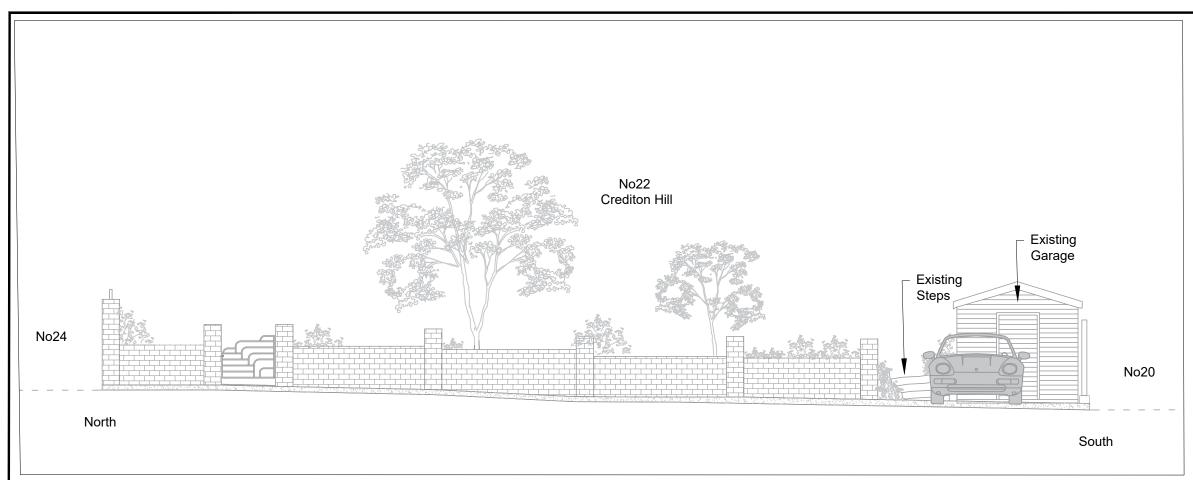

EXISTING STREET FRONT ELEVATION

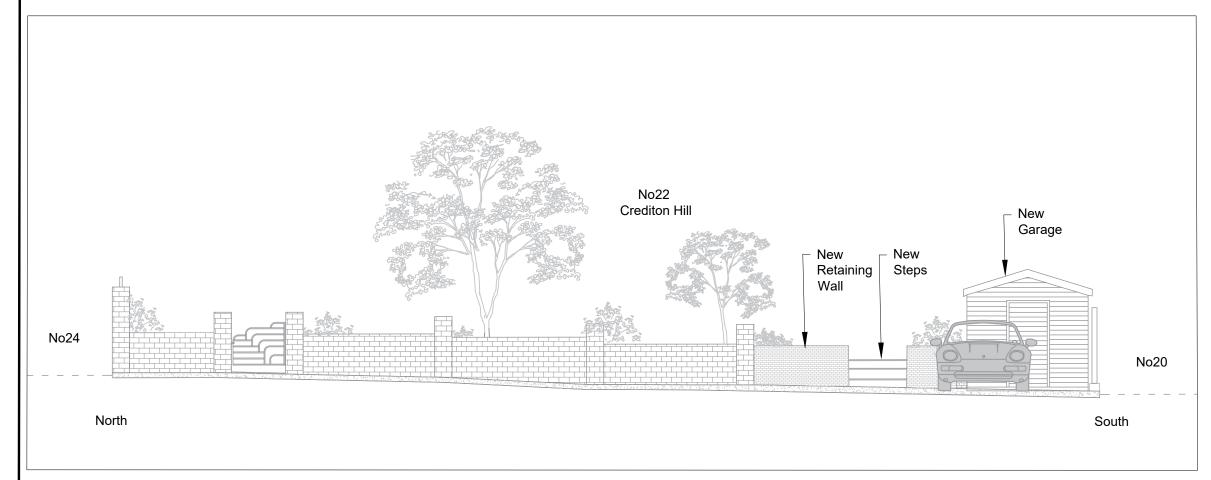


PROPOSED STREET FRONT ELEVATION

NOTES


- 1. The use of this data by the recipient acts as an agreement of the following statements. Do not use this data if you do not agree with any of the
- This drawing remains the copyright of Landform Consultants Ltd.
 Do not scale the drawing. All dimensions are in millimetres unless otherwise indicated. Use figured dimensions in all cases. Check all
- 4. Report any discrepancies or omissions to the Landscape Architects before
- This document is to be read in conjunction with the specification and all other project documentation.

KEY

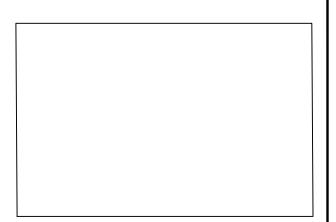

FOR PLANNING

STATUS

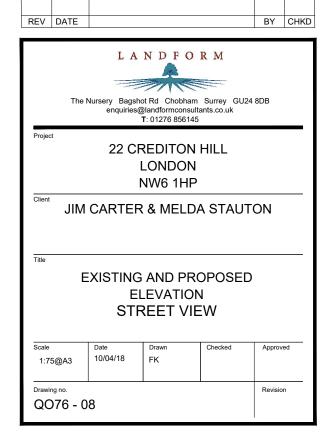



Scale 1:1250 (Do not scale from this drawing)




THE NURSERY, BAGSHOT ROAD, CHOBHAM, GU24 8DB

SITE ADDRESS: 22 CREDITON HILL CLIENT: JIM CARTER

DESCRIPTION: SITE LOCATION PLAN

DRAWING NO: Q076-PL01



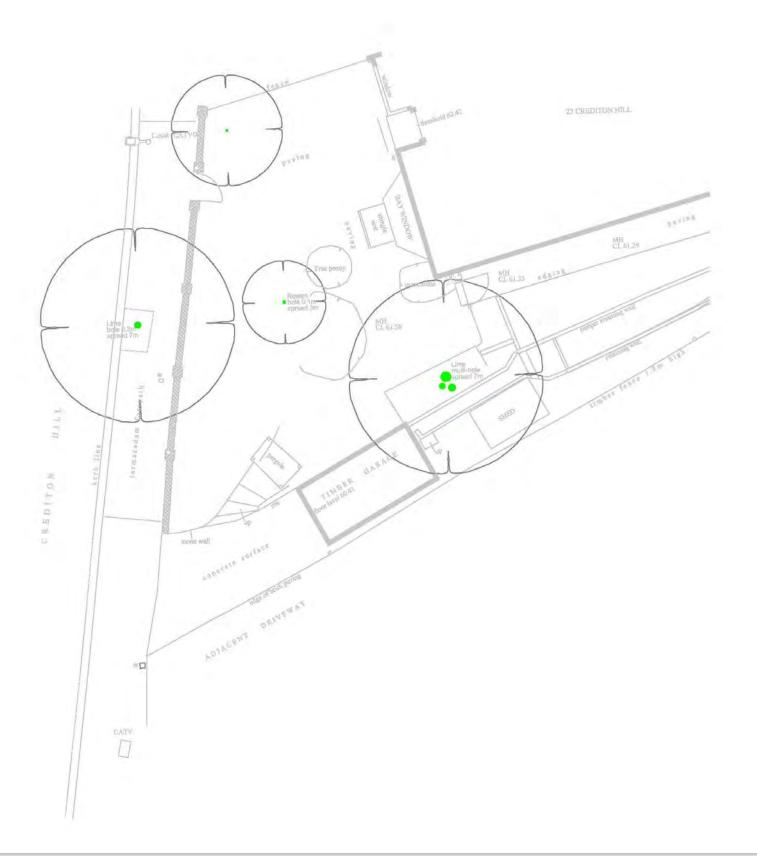

Location of Existing Trees Scale NTS (Do not scale from this drawing)




LANDFORM CONSULTANTS LTD

THE NURSERY, BAGSHOT ROAD, CHOBHAM, GU24 8DB


SITE ADDRESS: 22 CREDITON HILL CLIENT: JIM CARTER

DESCRIPTION: EXISTING TREES

DRAWING NO: Q076-PL02

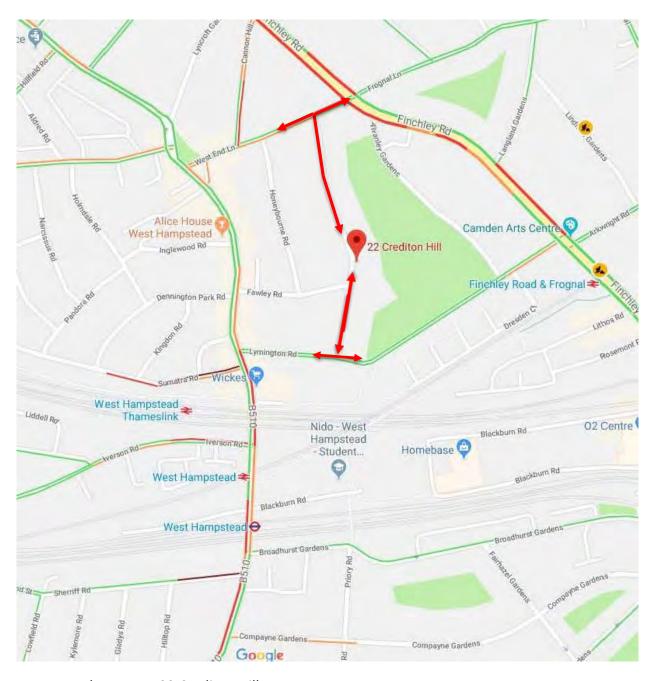

Access and Egress to 22 Crediton Hill

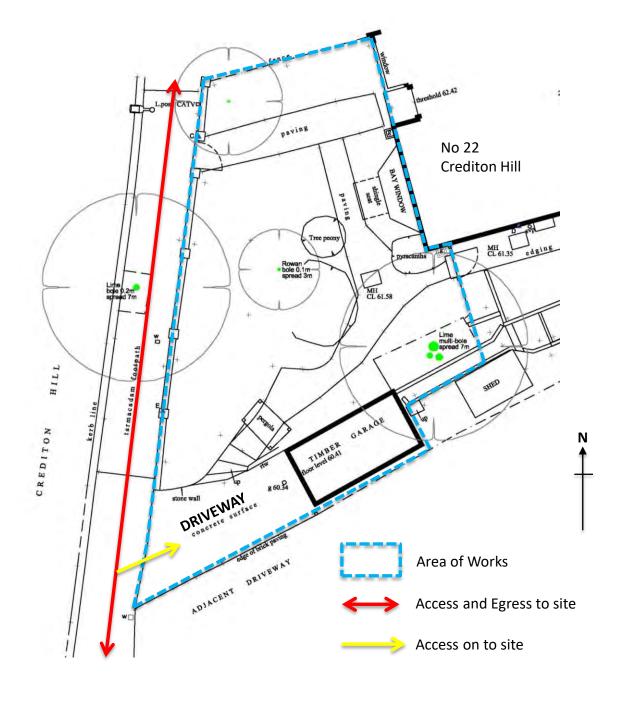

Access and Egress Scale: NTS (Do not scale from this drawing)




THE NURSERY, BAGSHOT ROAD, CHOBHAM, GU24 8DB


SITE ADDRESS: 22 CREDITON HILL CLIENT: JIM CARTER

DESCRIPTION: ACCESS AND EGRESS

DRAWING NO: Q076-PL03



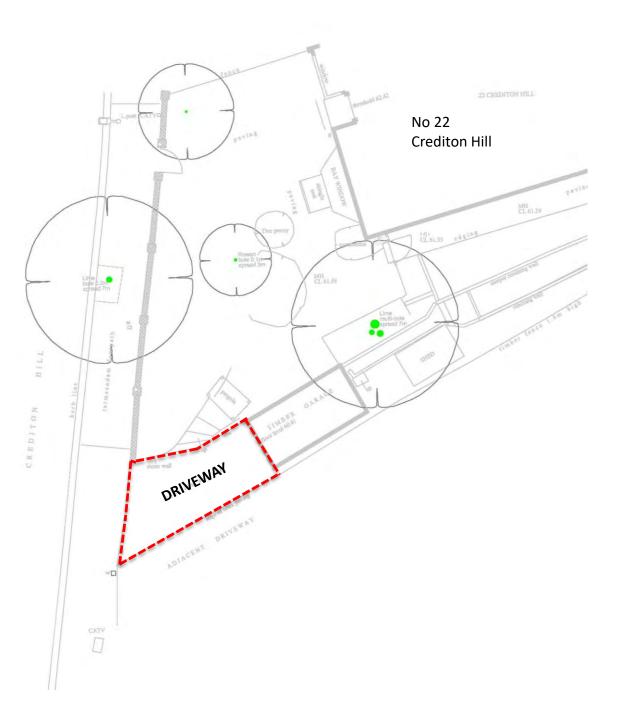

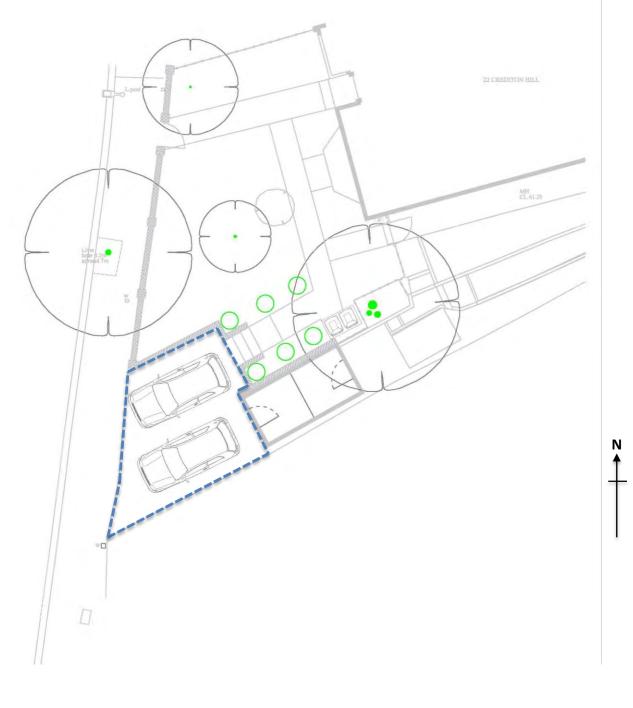

PROPOSED PARKING **EXISTING PARKING**

Parking

Scale: 1:100@A3

(Do not scale from this drawing)



LANDFORM CONSULTANTS LTD

THE NURSERY, BAGSHOT ROAD, CHOBHAM, GU24 8DB

SITE ADDRESS: 22 CREDITON HILL CLIENT: JIM CARTER

DESCRIPTION: EXISTING AND PROPOSED PARKING

DRAWING NO: Q076-PL04



Scale: NTS

(Do not scale from this drawing)



LANDFORM CONSULTANTS LTD

THE NURSERY, BAGSHOT ROAD, CHOBHAM, GU24 8DB

SITE ADDRESS: 22 CREDITON HILL

CLIENT: JIM CARTER

DESCRIPTION: PROPOSED LANDSCAPE SKETCH

DRAWING NO: Q076-PL05



PAVING – AUTUMN BROWN SANDSTONE TO MATCH EXISTING



HARD WOOD TRELLIS FENCING TO REPLACE EXISTING FEATHERBOARD FENCE. (TO MATCH EXISTING TRELLIS FENCE).



NORTH BOUNDARY FENCE TO BE REPLACED AND TOPPED WITH SMALL TRELLIS AS PER IMAGE ABOVE.



BARLEY BEACH PERMEABLE RESIN BOUND GRAVEL DRIVEWAY



BARLEY BEACH PERMEABLE RESIN BOUND GRAVEL



NEW RETAINING WALL TO MATCH EXISTING BRICK



NEW RETAINING WALL FOR STEPS TO MATCH EXISTING BRICK



LANDFORM CONSULTANTS LTD

THE NURSERY, BAGSHOT ROAD, CHOBHAM, GU24 8DB

SITE ADDRESS: 22 CREDITON HILL CLIENT: JIM CARTER

DESCRIPTION: MATERIALS

DRAWING NO: Q076-PL06



EXITING CONCRETE DRIVEWAY, SHED AND STEPS



EXISTING CONDITION OF SHED. TO BE REPLACED WITH SAME STYLE SHED.



EXITING CONCRETE PATHS.



EXITING CONCRETE PATHS TO BE REPLACED WITH SANDSTONE PAVING.



NORTHERN BOUNDARY FENCE, TO BE REPLACED WITH CLOSEBARD FENCE TO TOP OF PILLAR WITH TRELLIS ON TOP.



FEATHEREDGE FENCE AROUND TREE COVERED IN IVY. TO BE REPLACED WITH TRELLIS. (PICKET FENCE TO REMAIN).



EXITING DRIVE, DROP KERB AND FRONT WALL. SMALL SECTION OF WALL WOULD BE REMOVED TO MAKE DRIVE WIDER.



CONDITION OF EXISTING DRIVEWAY / **PARKING AREA**



LANDFORM CONSULTANTS LTD

THE NURSERY, BAGSHOT ROAD, CHOBHAM, GU24 8DB

SITE ADDRESS: 22 CREDITON HILL CLIENT: JIM CARTER

DESCRIPTION: EXISTING SITE AND MATERIALS

DRAWING NO: Q076-PL07