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Report Ref: EMS-444986\_596606  
Grid Ref: 530136, 181353

Map Name: County Series


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Revised 1895  
Edition N/A  
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Map Name: County Series



Map date: 1895  
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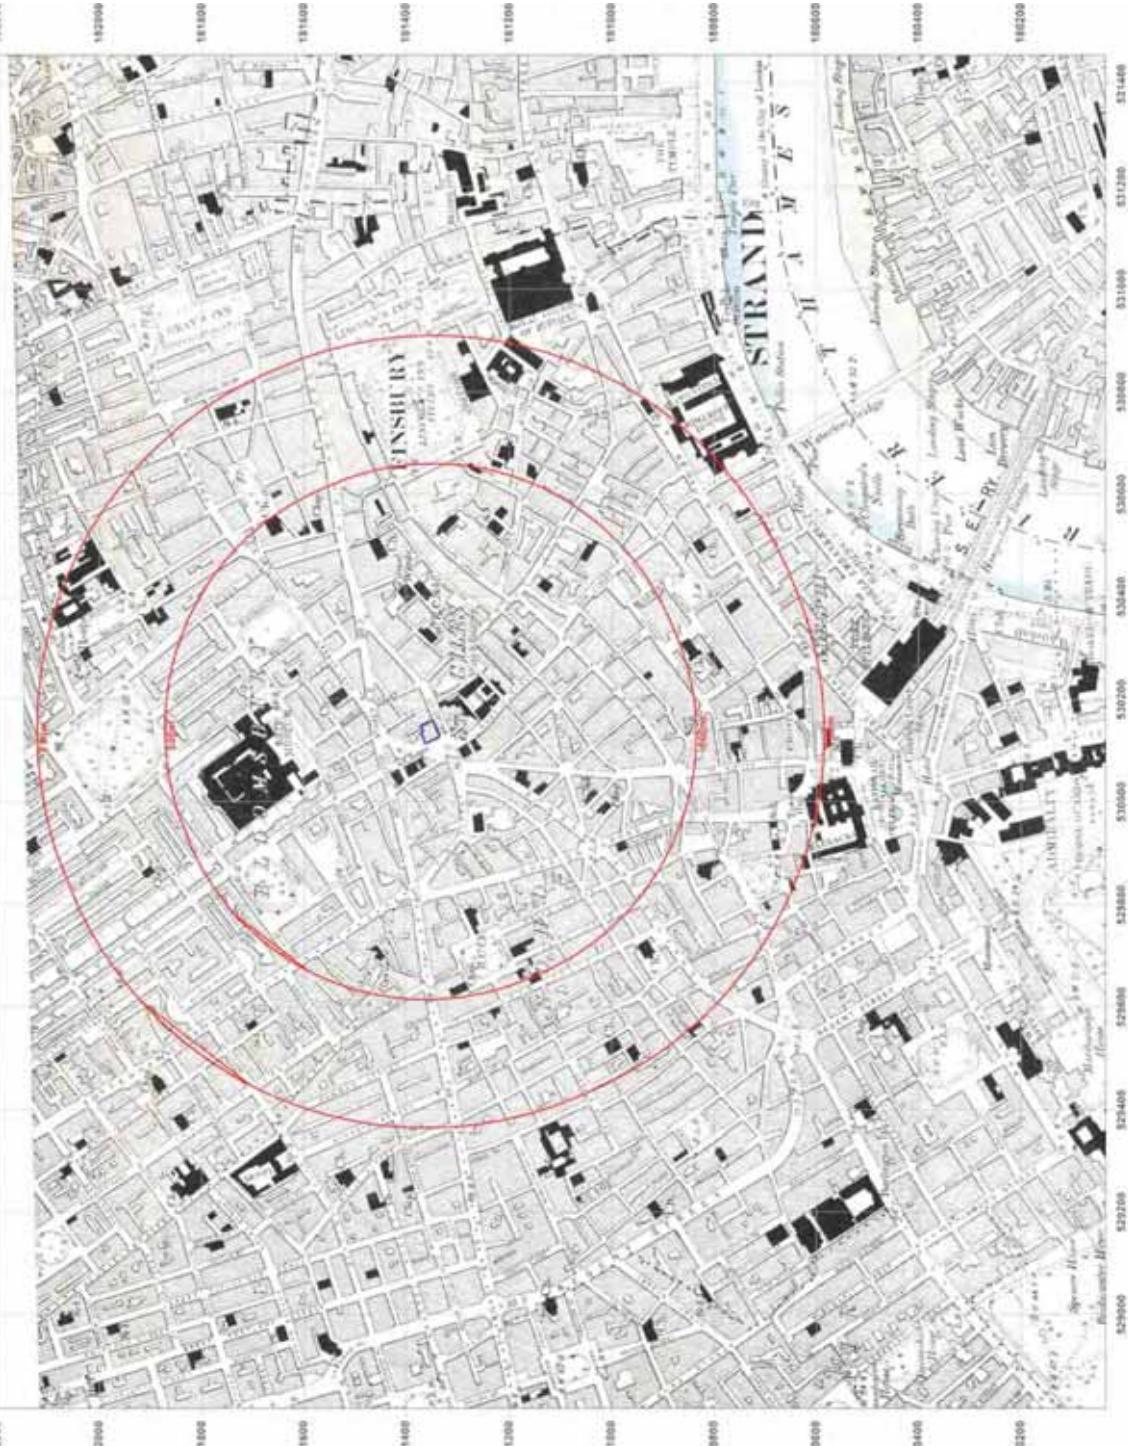


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Map Name: County Series

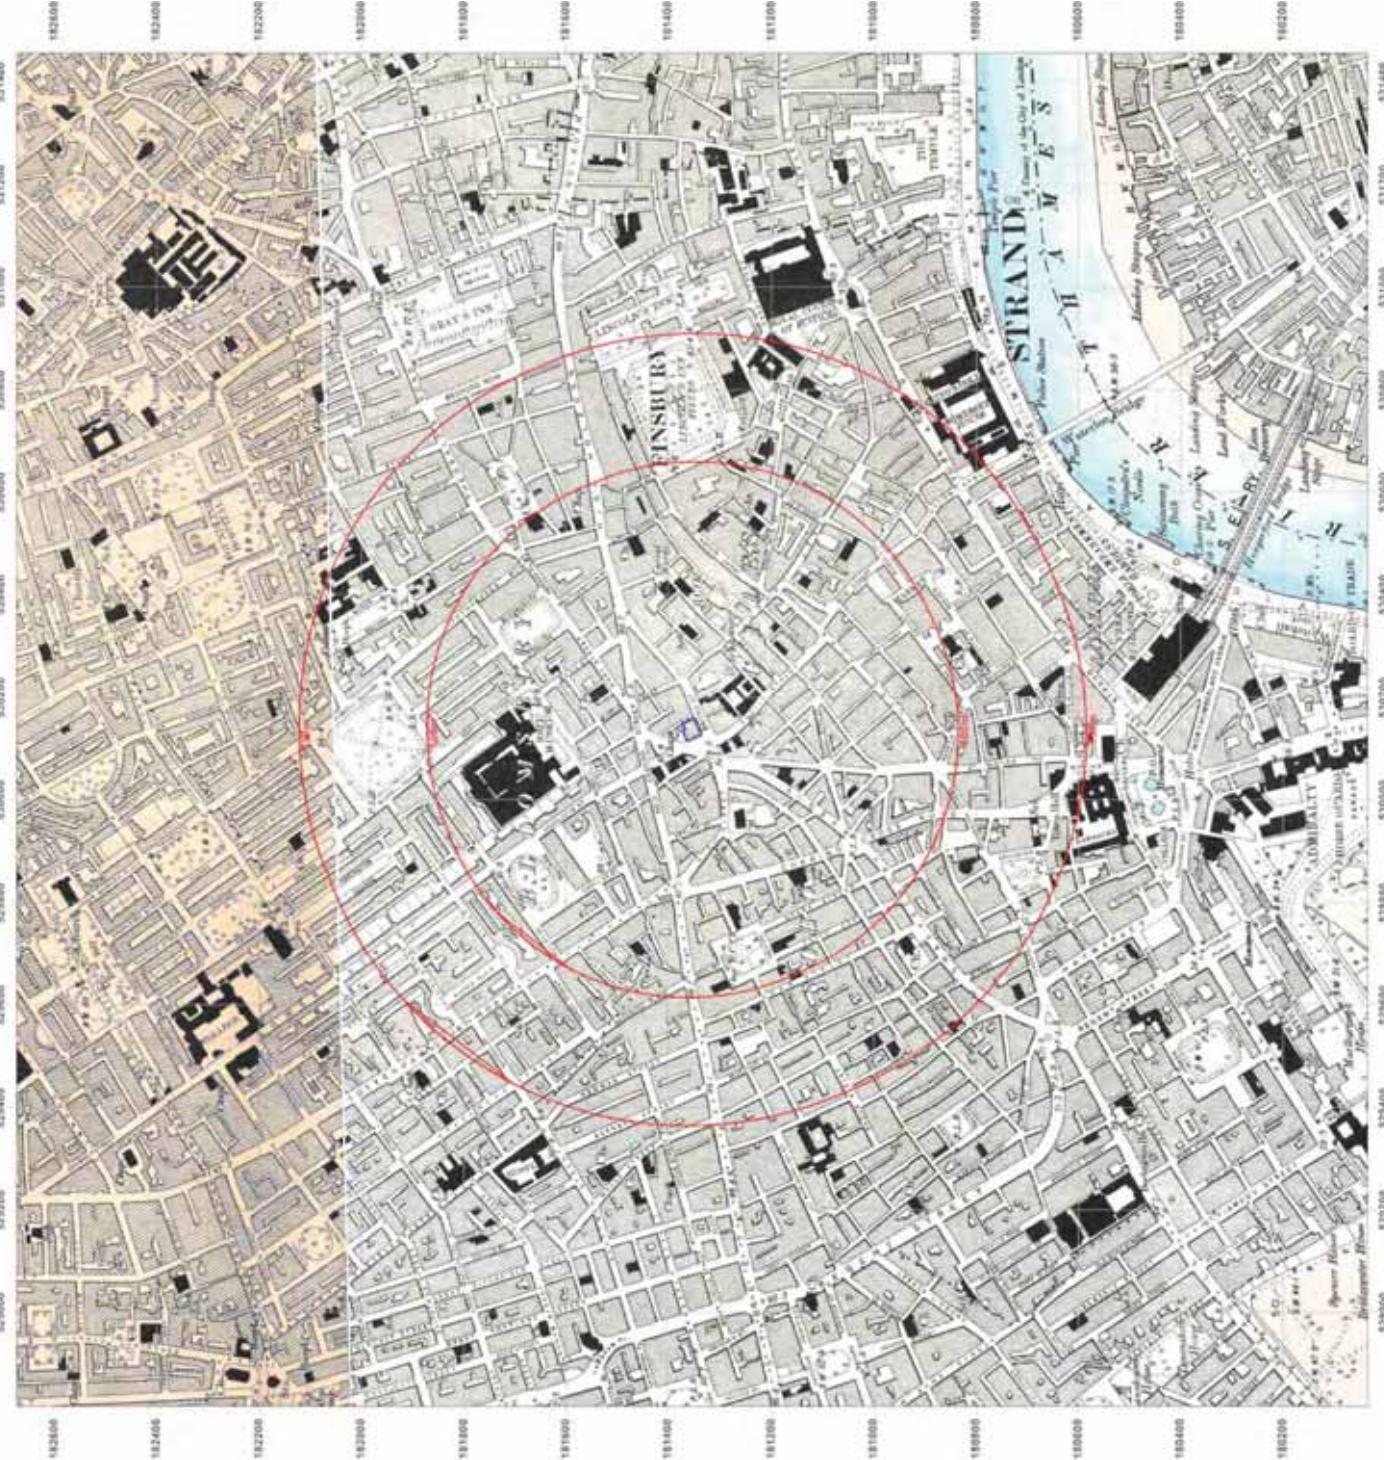

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Edition 1898  
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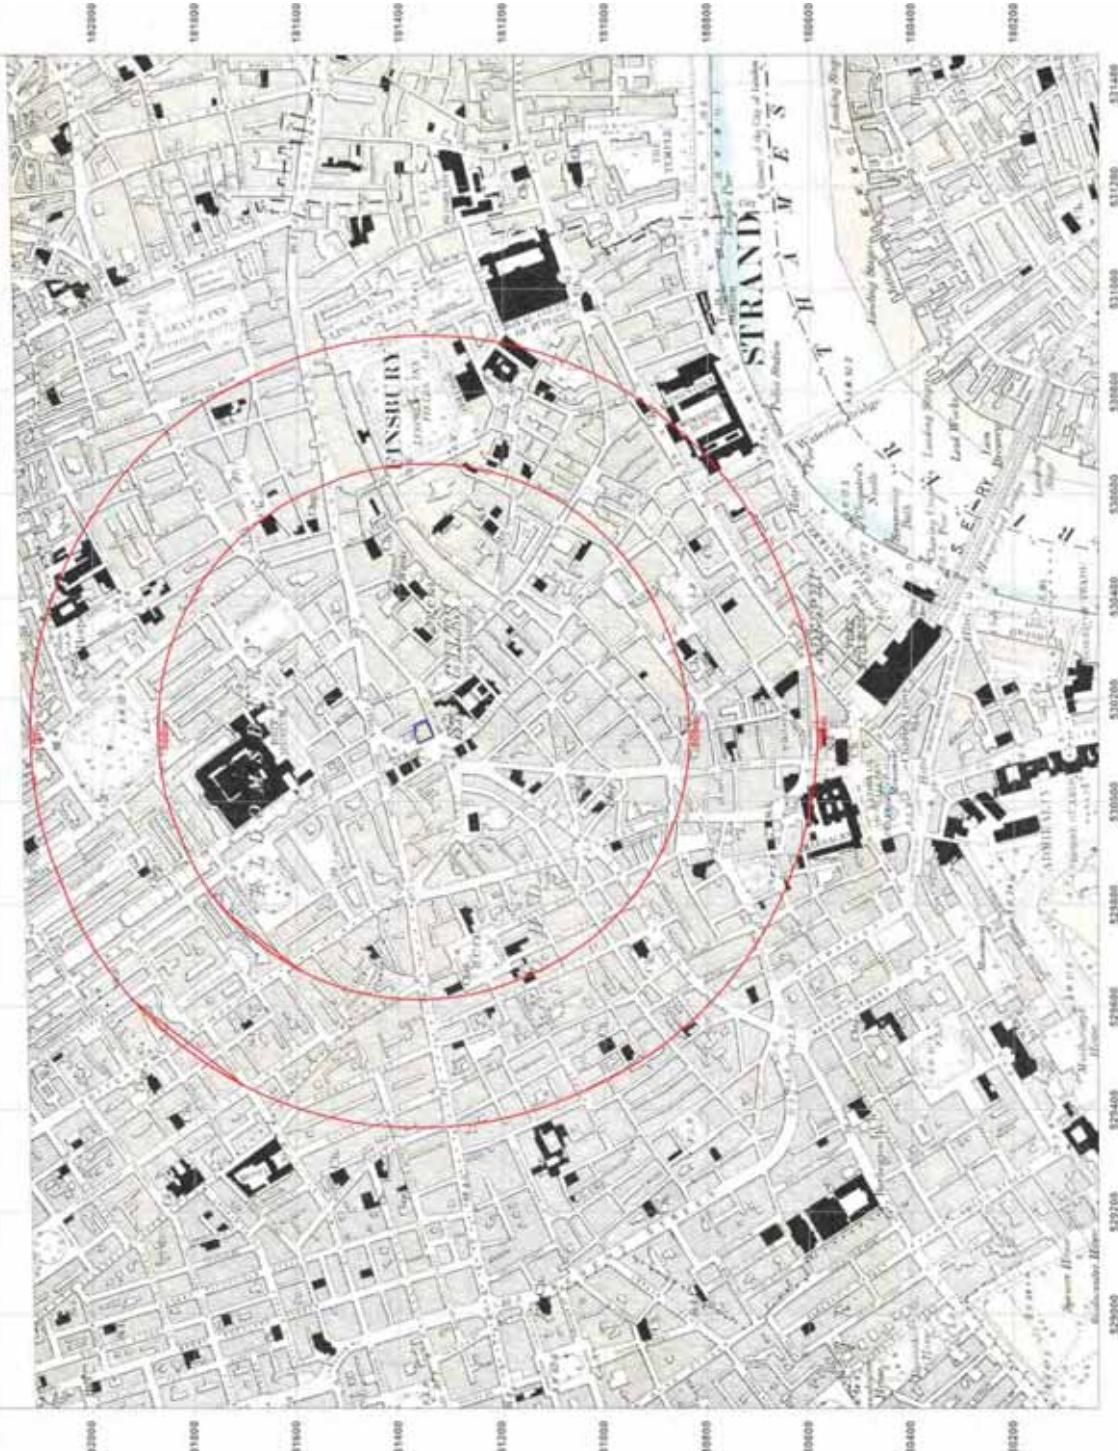


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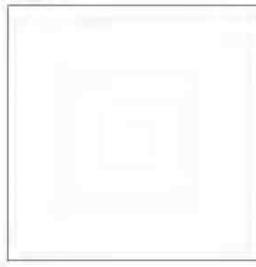
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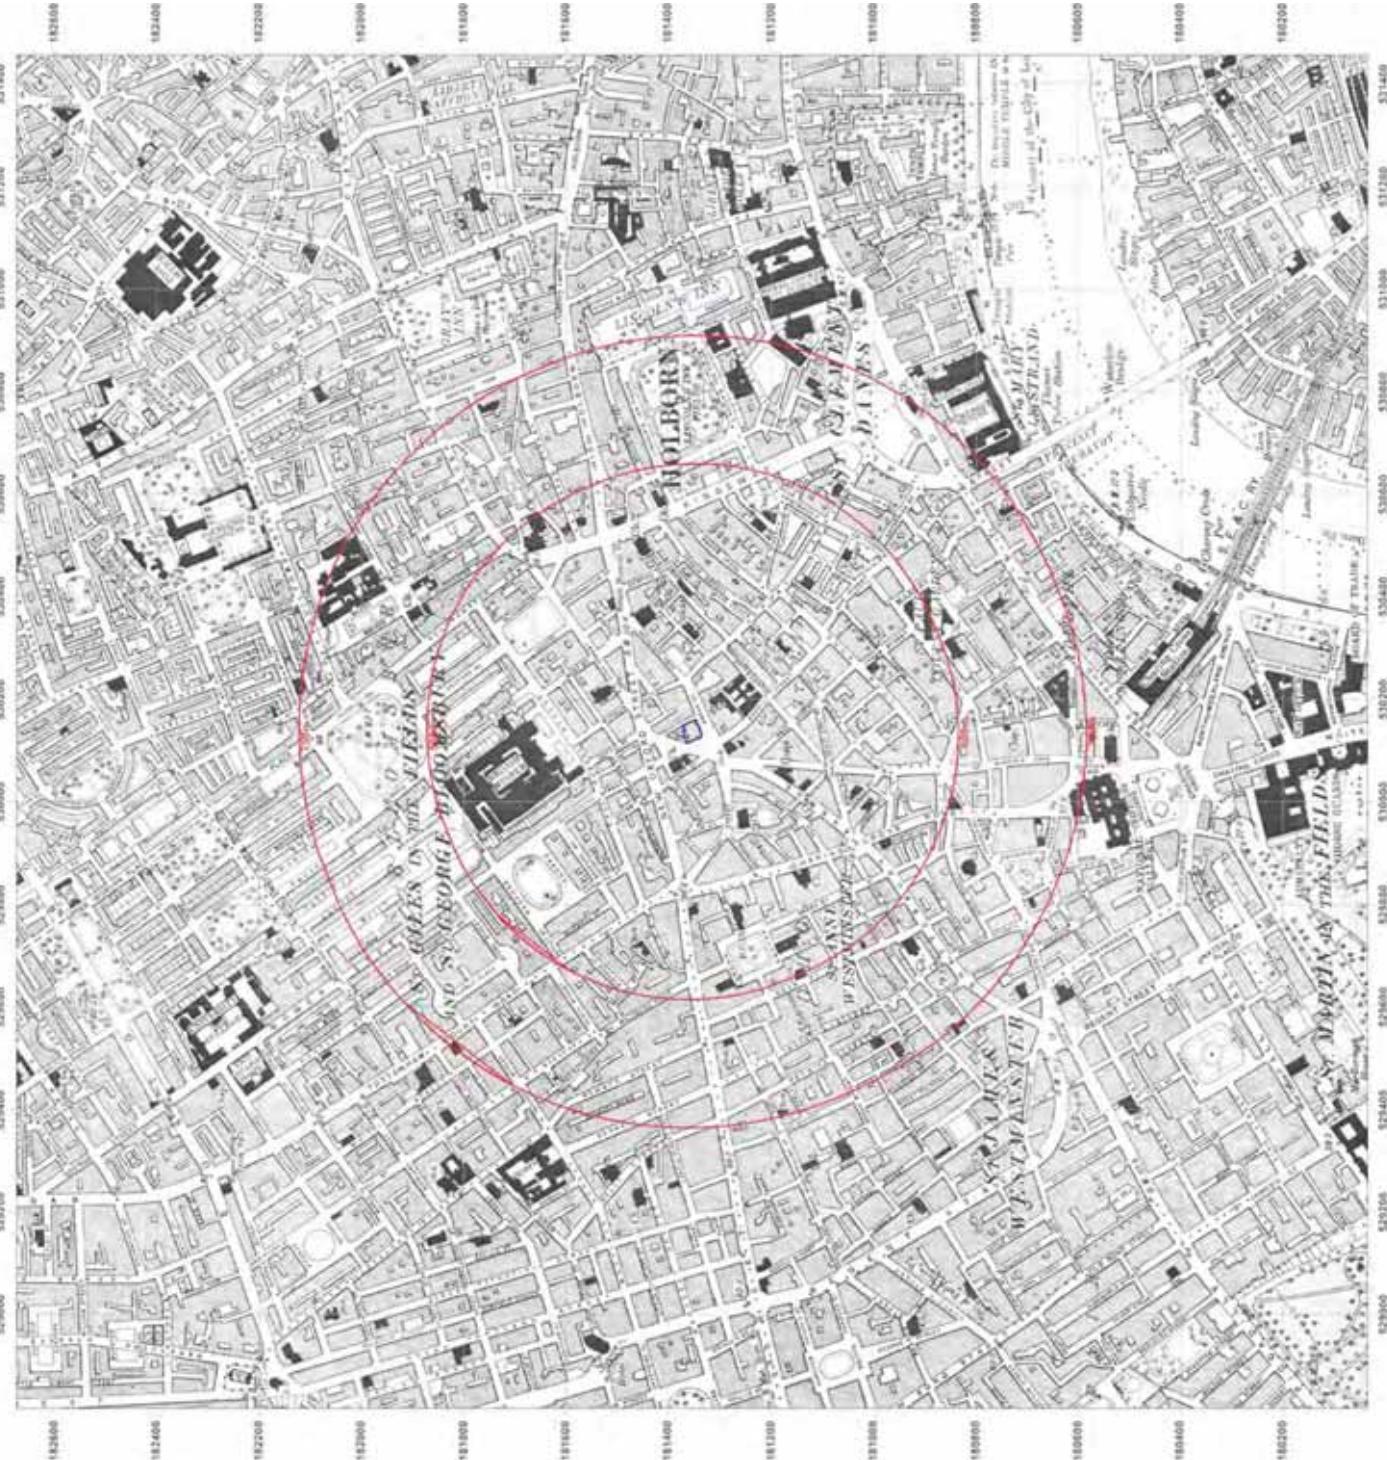
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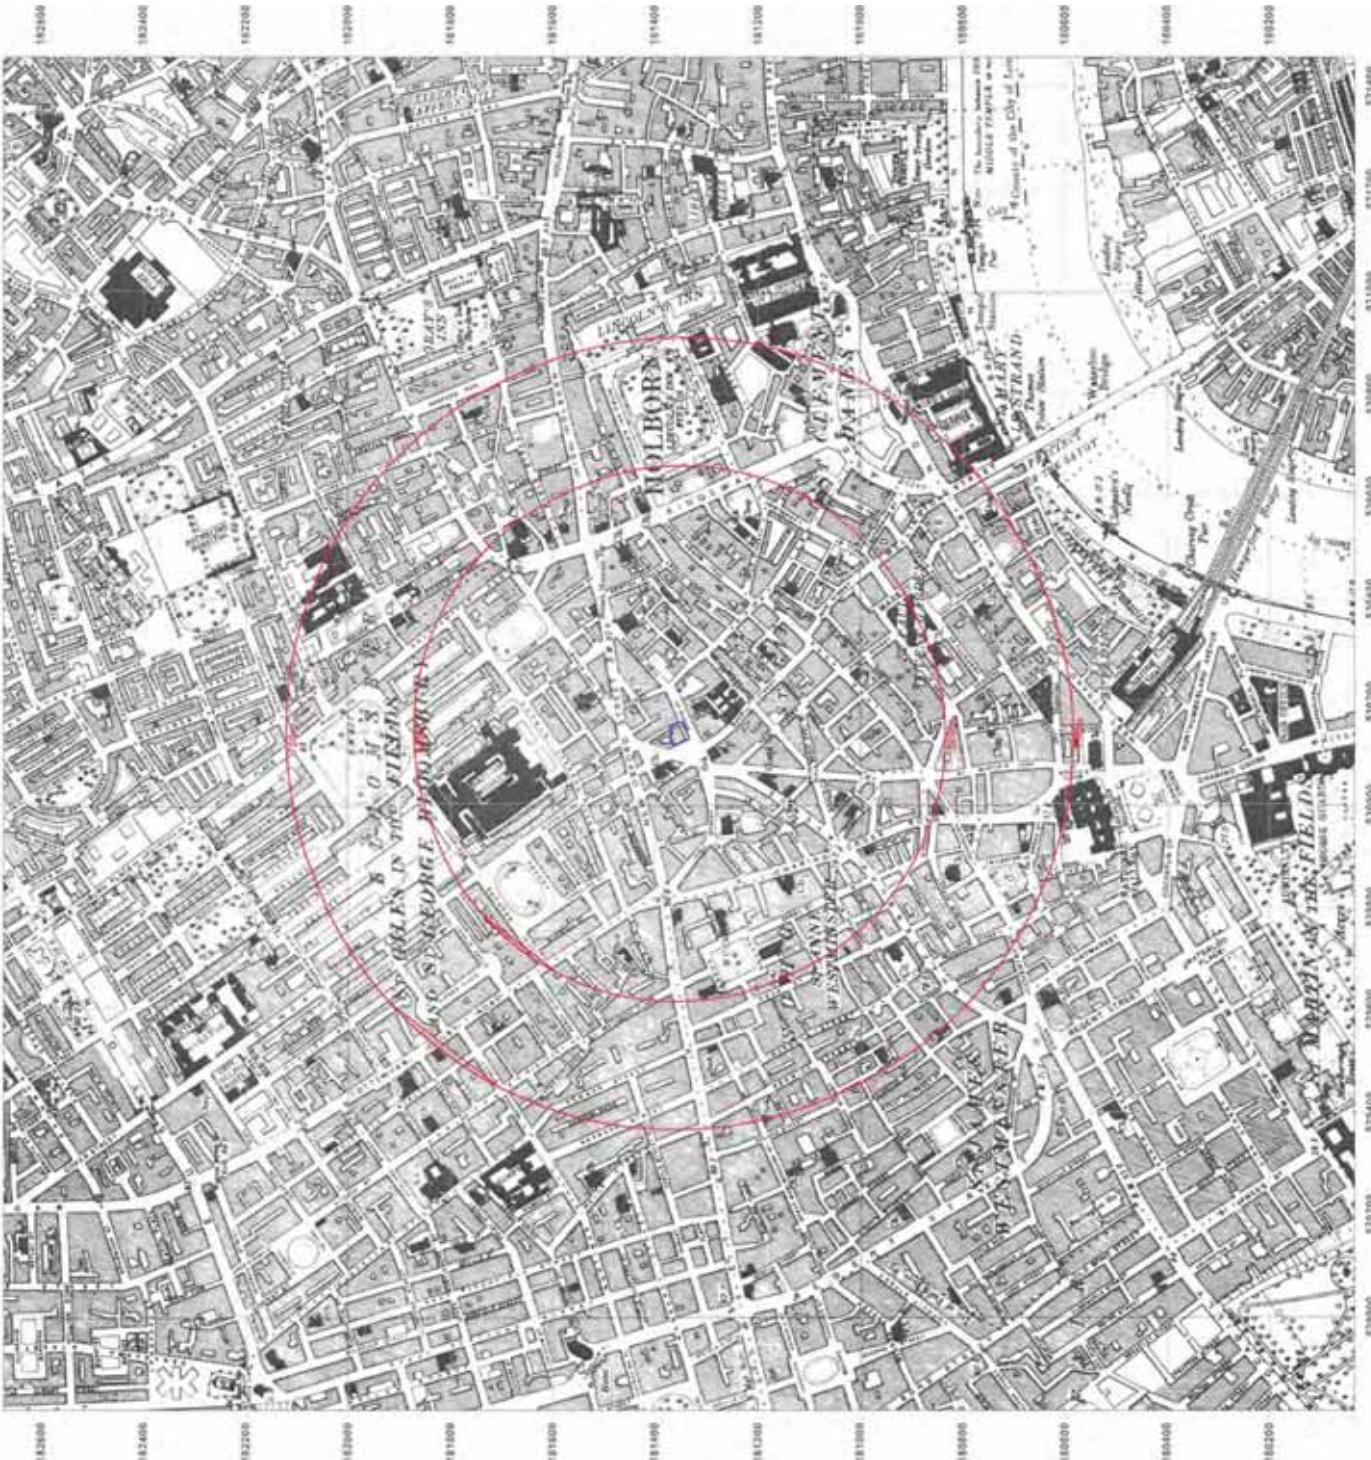
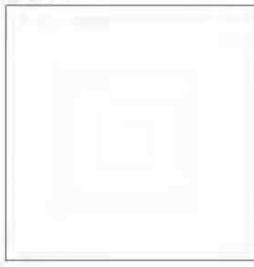
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Scale: 1:10,560

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Revised 1938  
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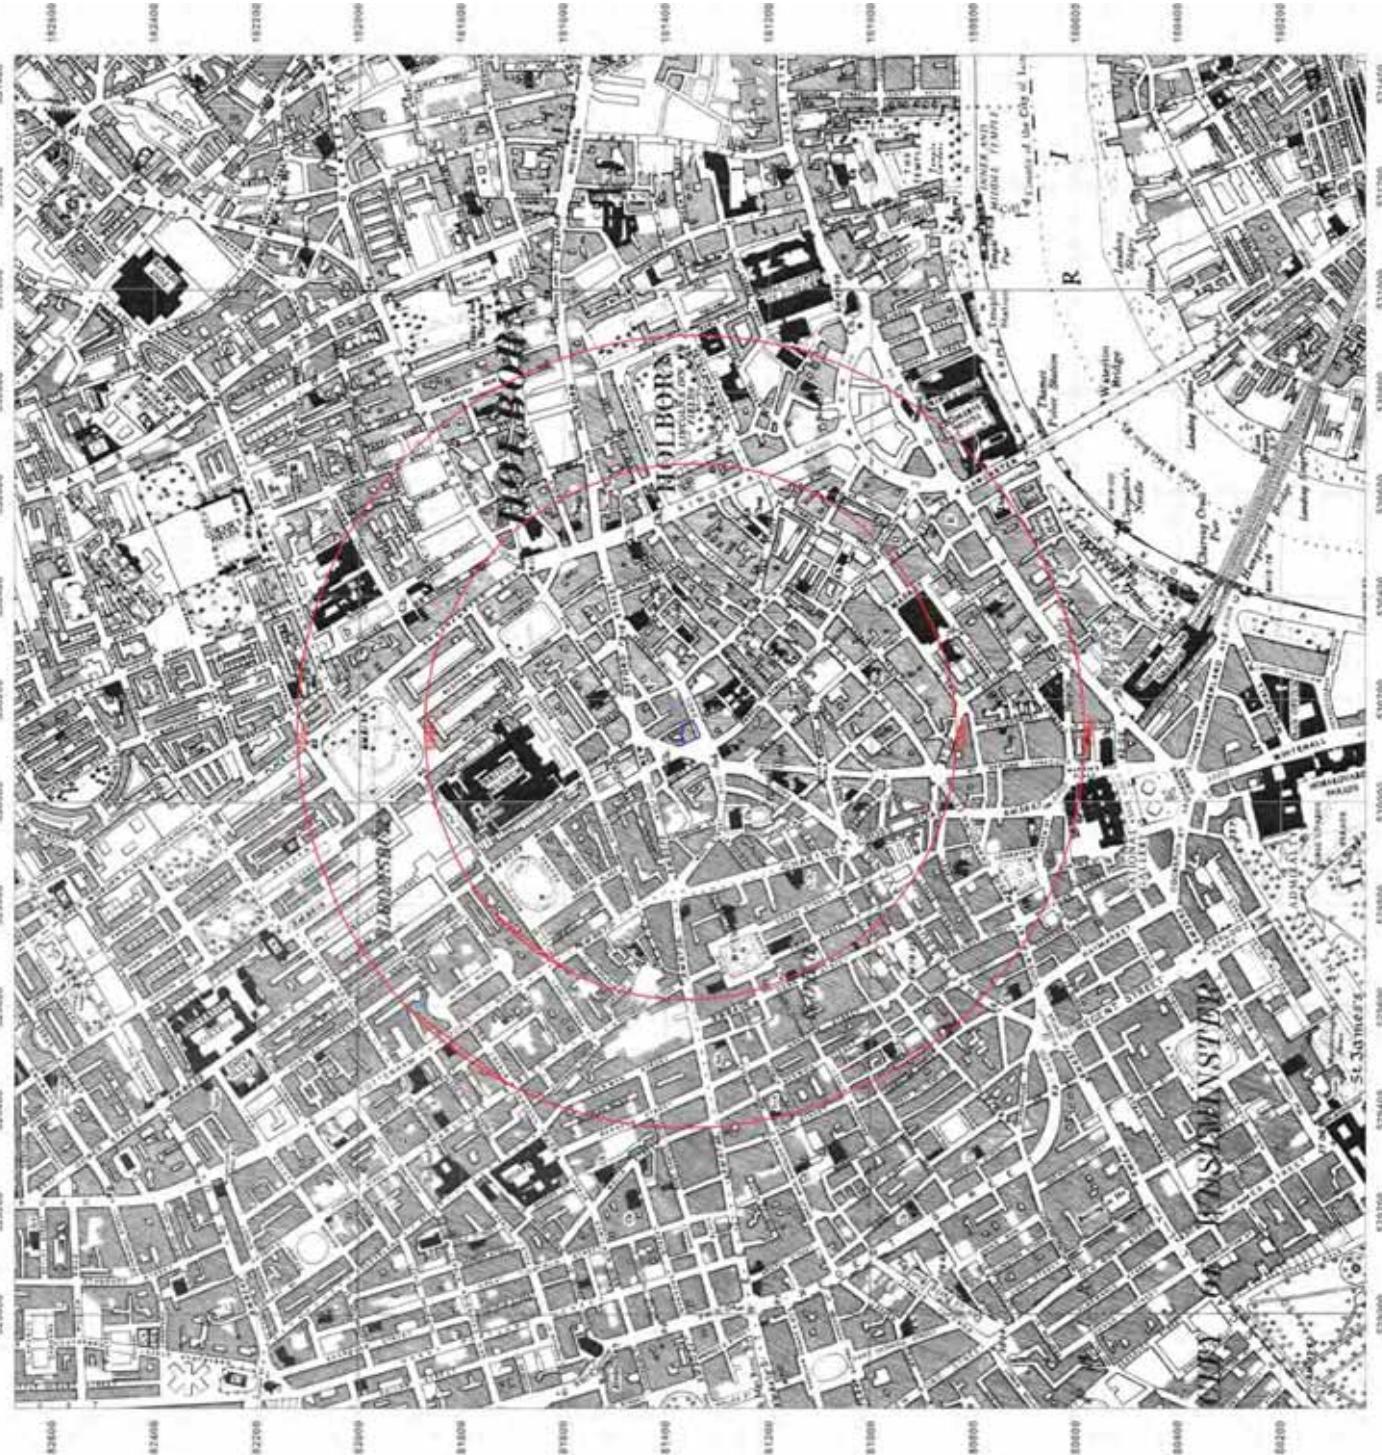
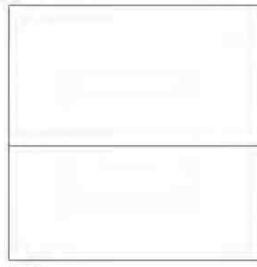
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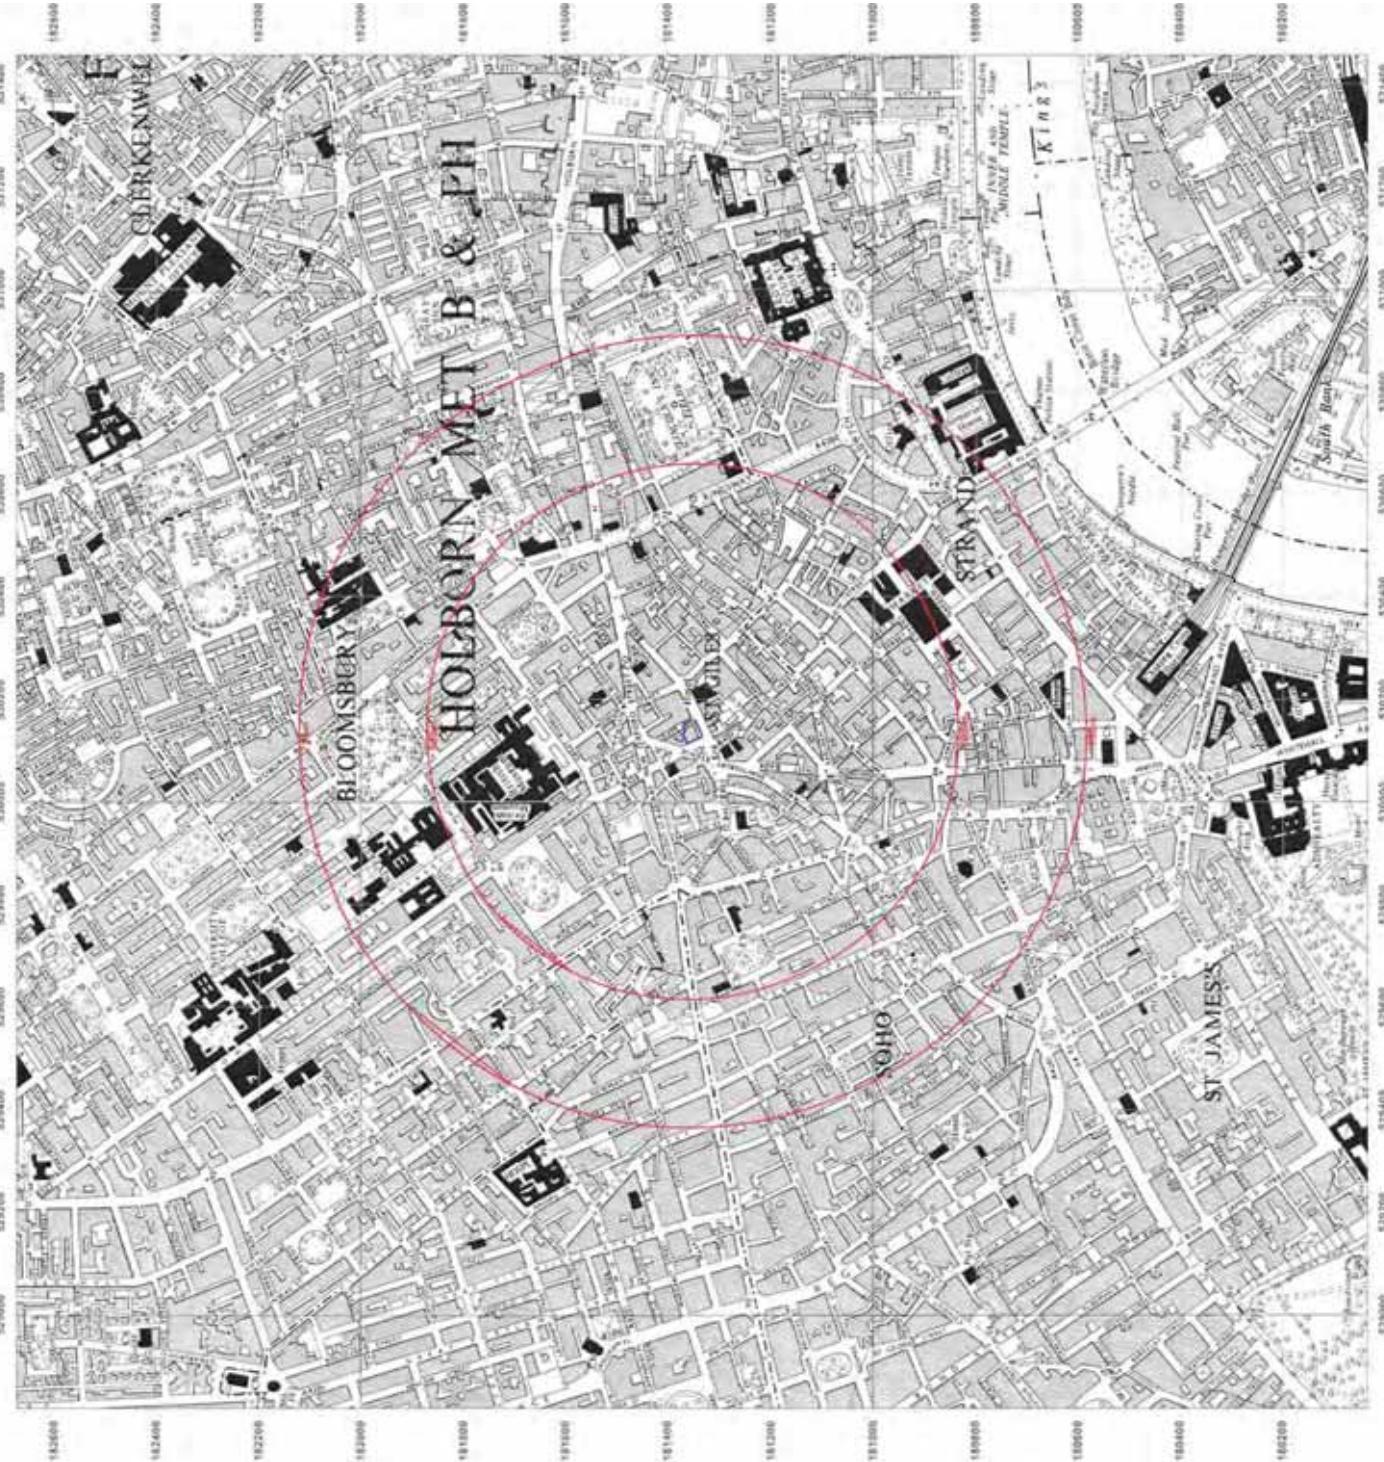
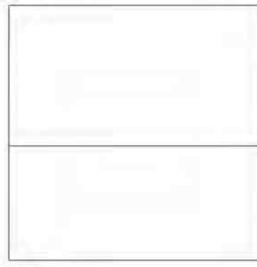
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Surveyed 1955  
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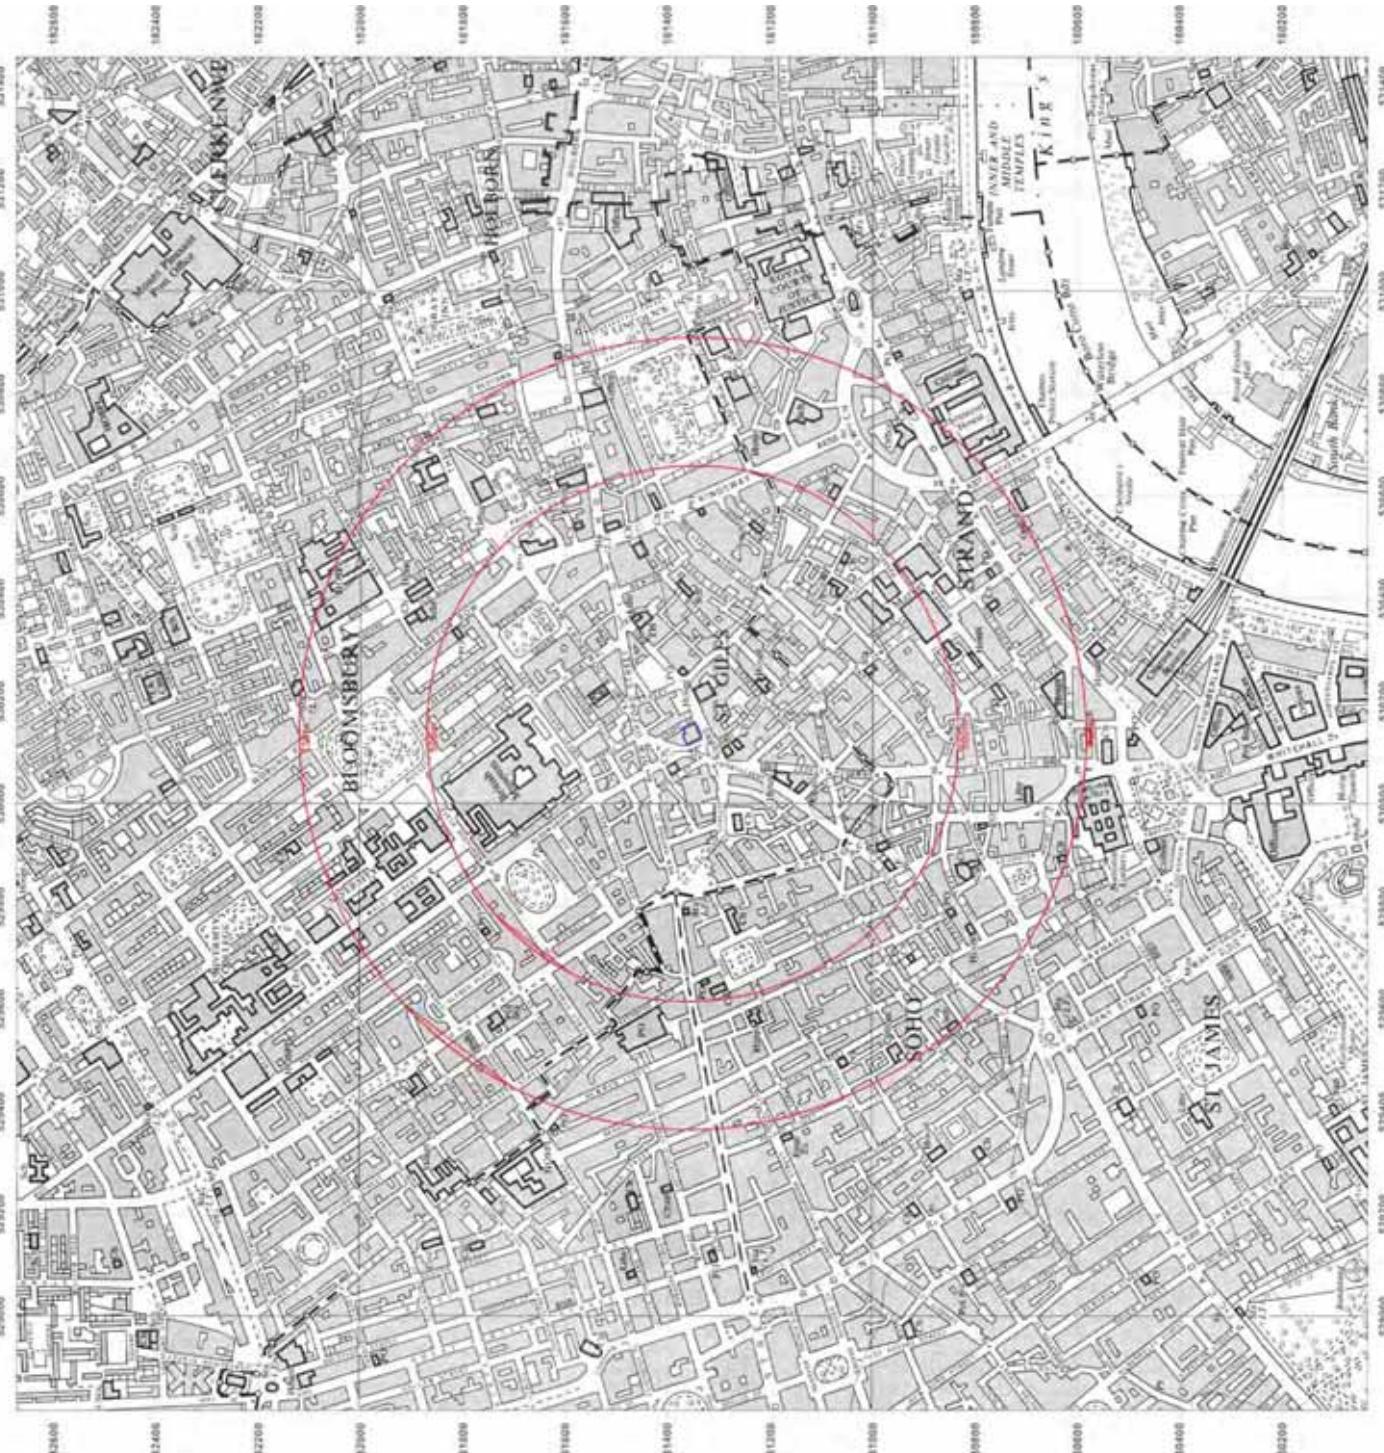
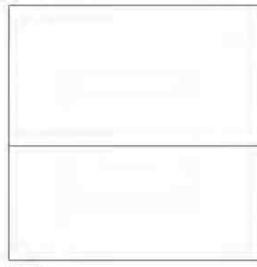
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Scale: 1:10,560

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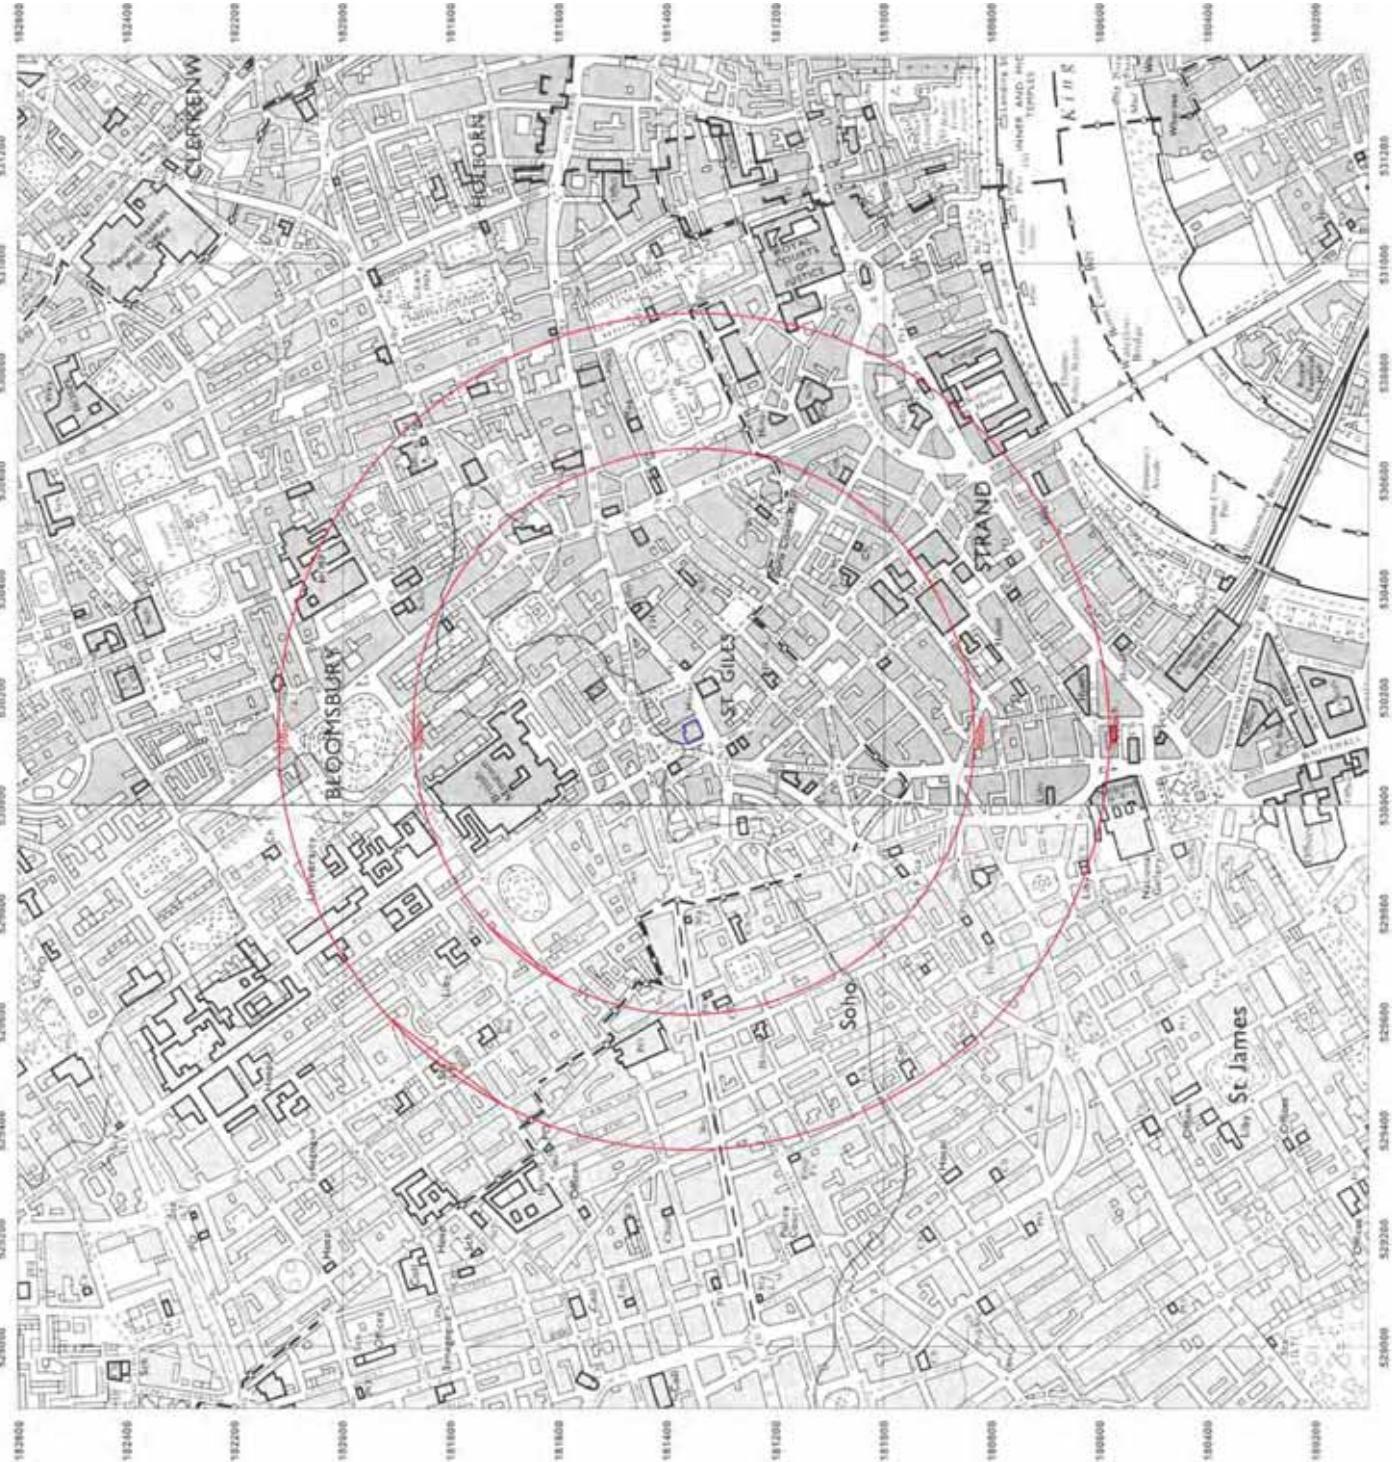
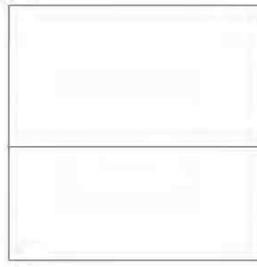
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Map date: 1971-1973

Scale: 1:10,000

Printed at: 1:10,000

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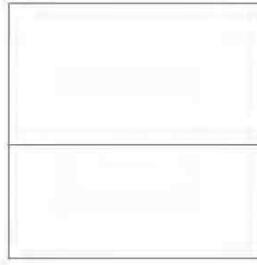


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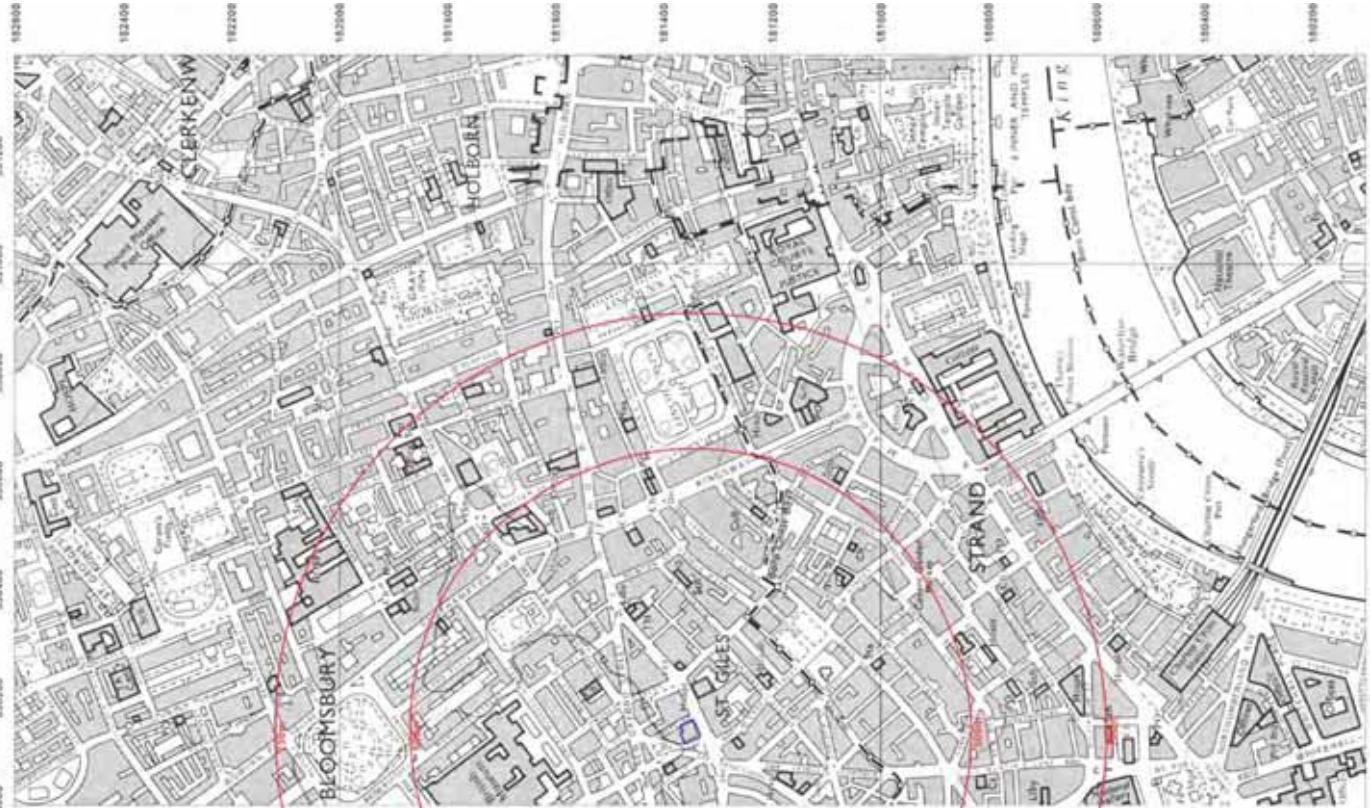
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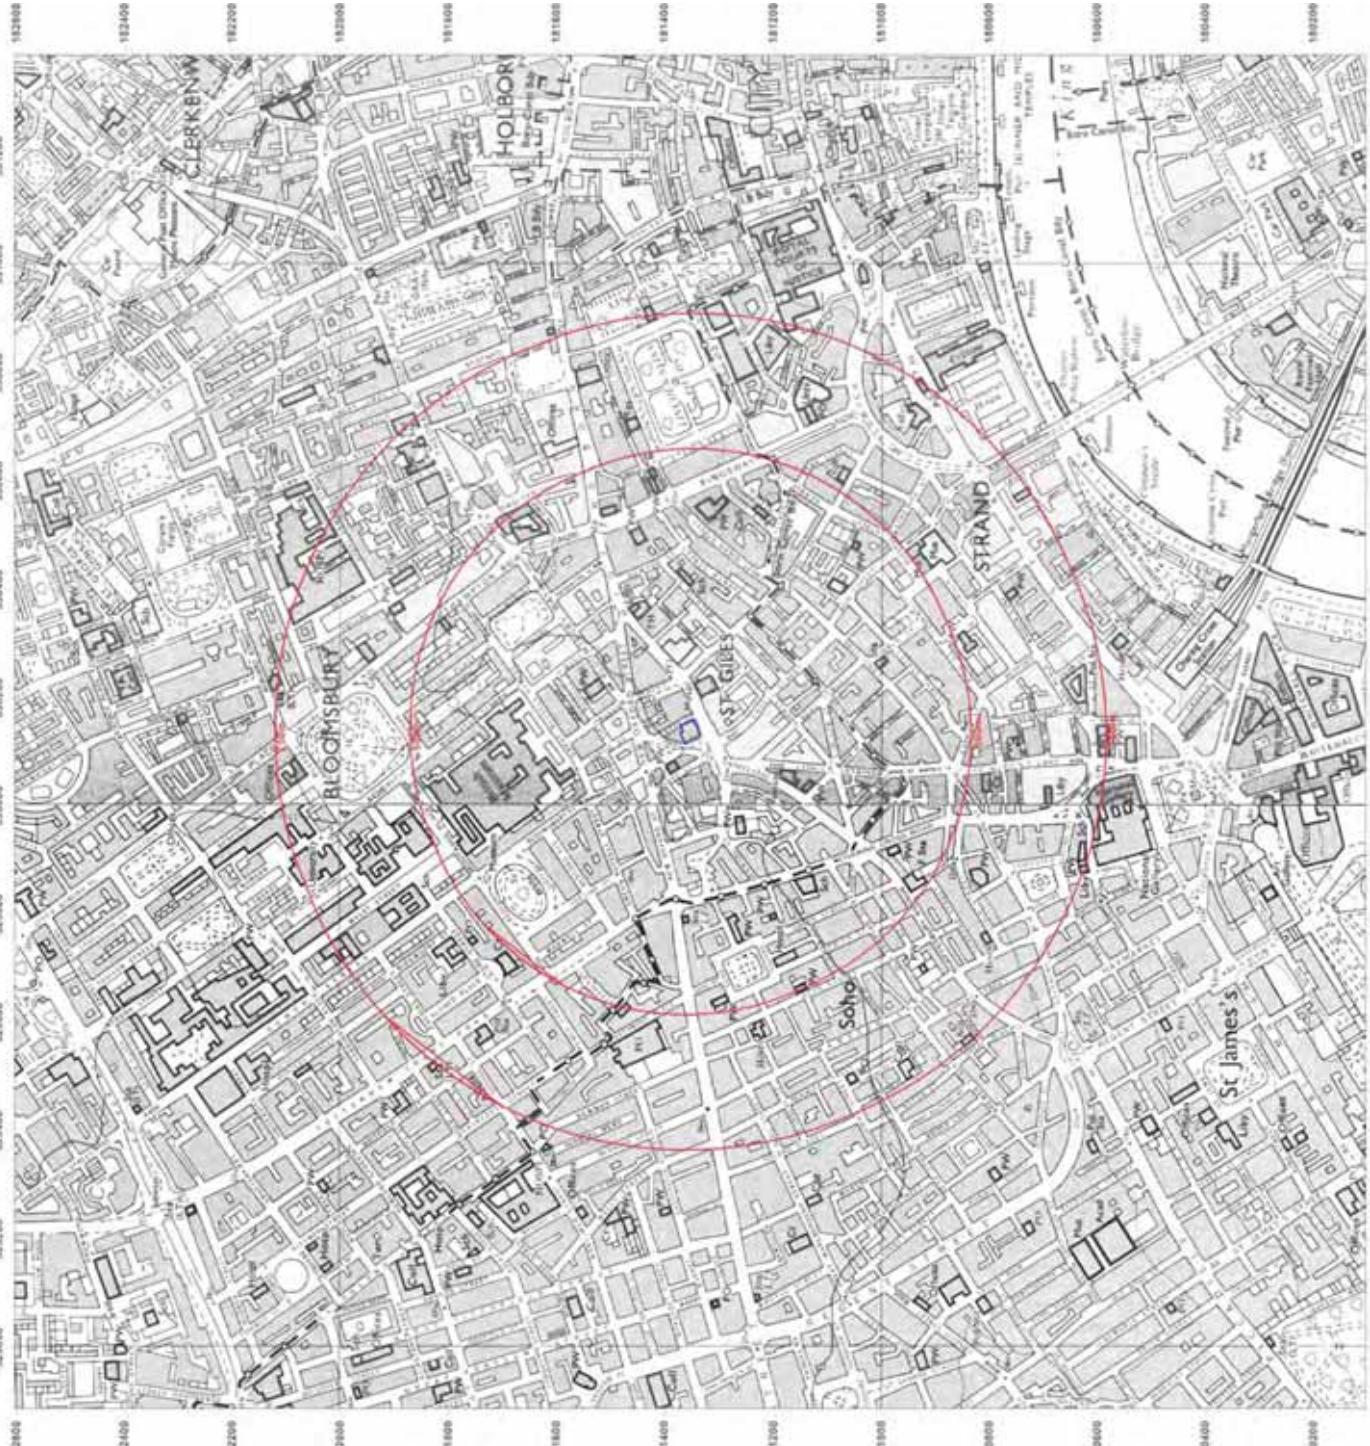
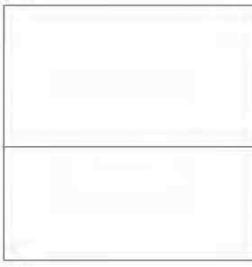
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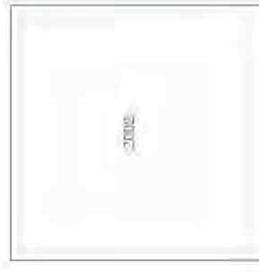
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Map date: 2002

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Printed at: 1:10,000



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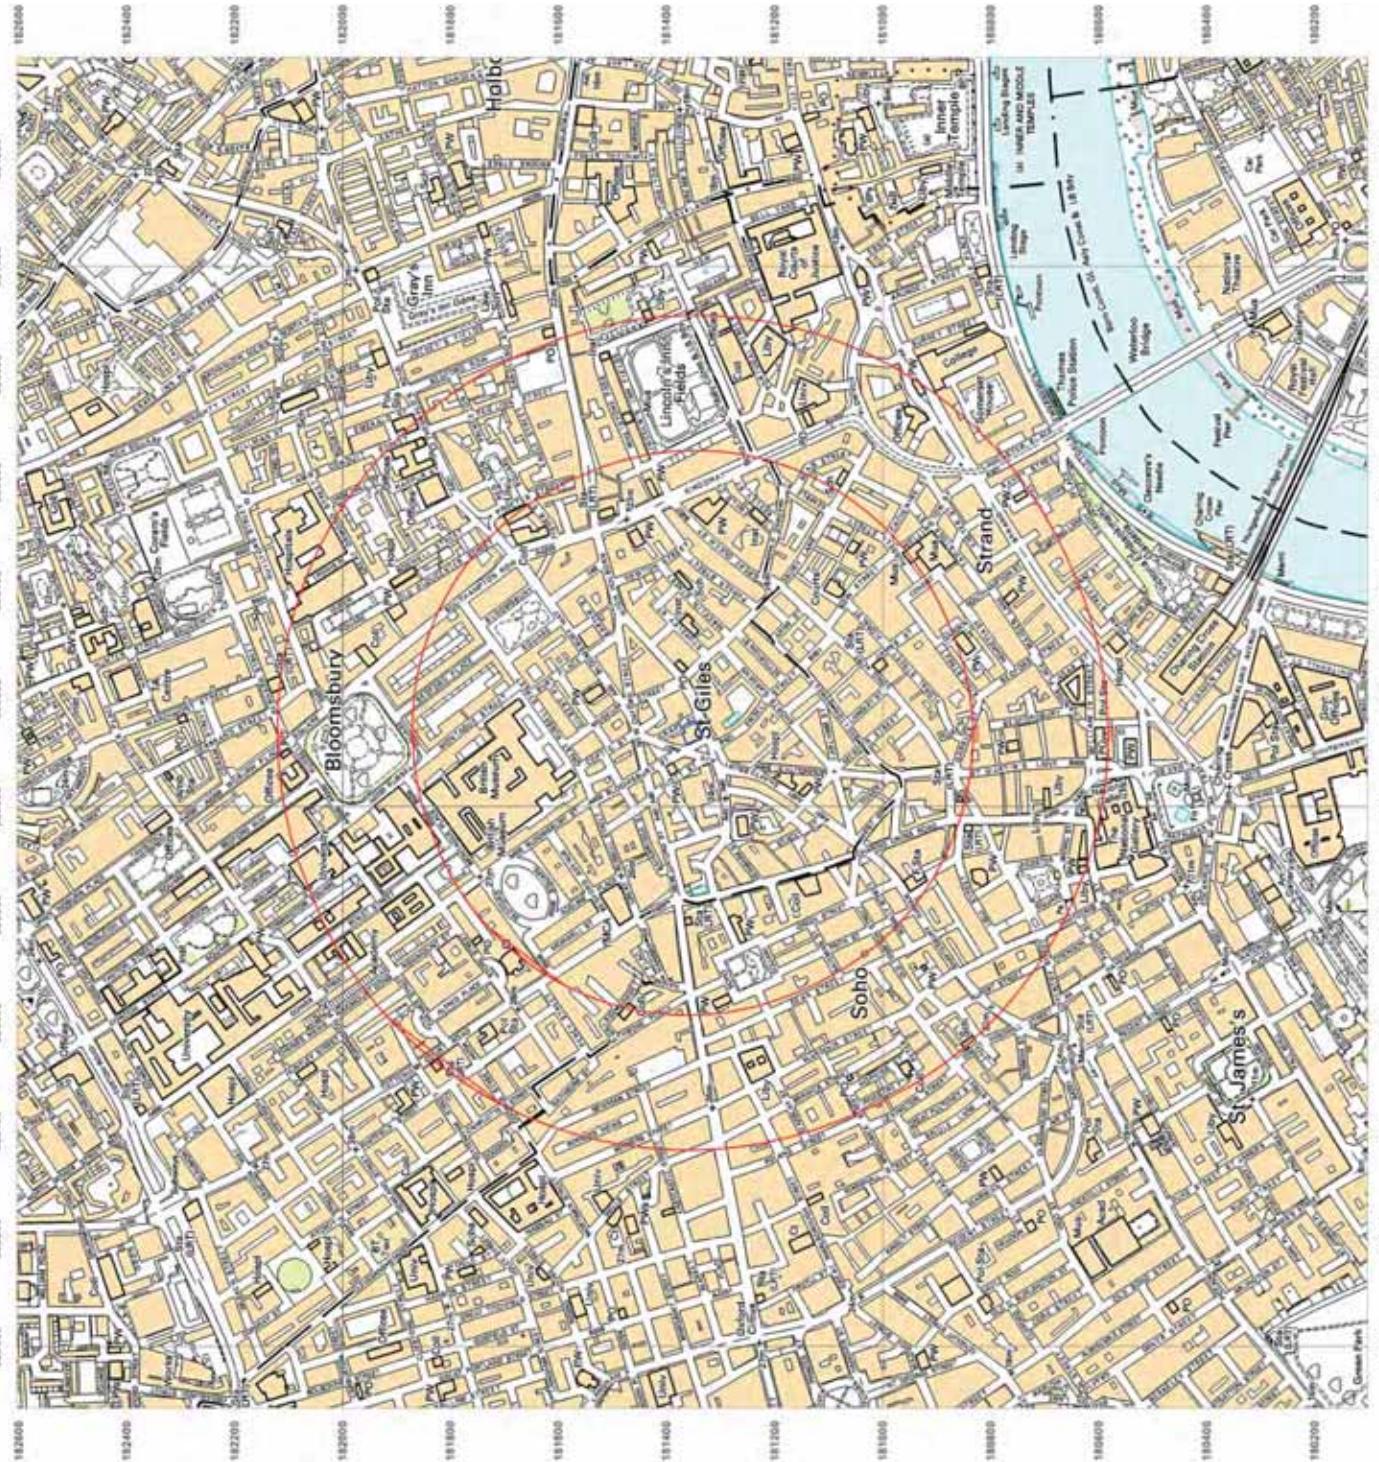
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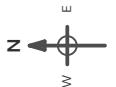
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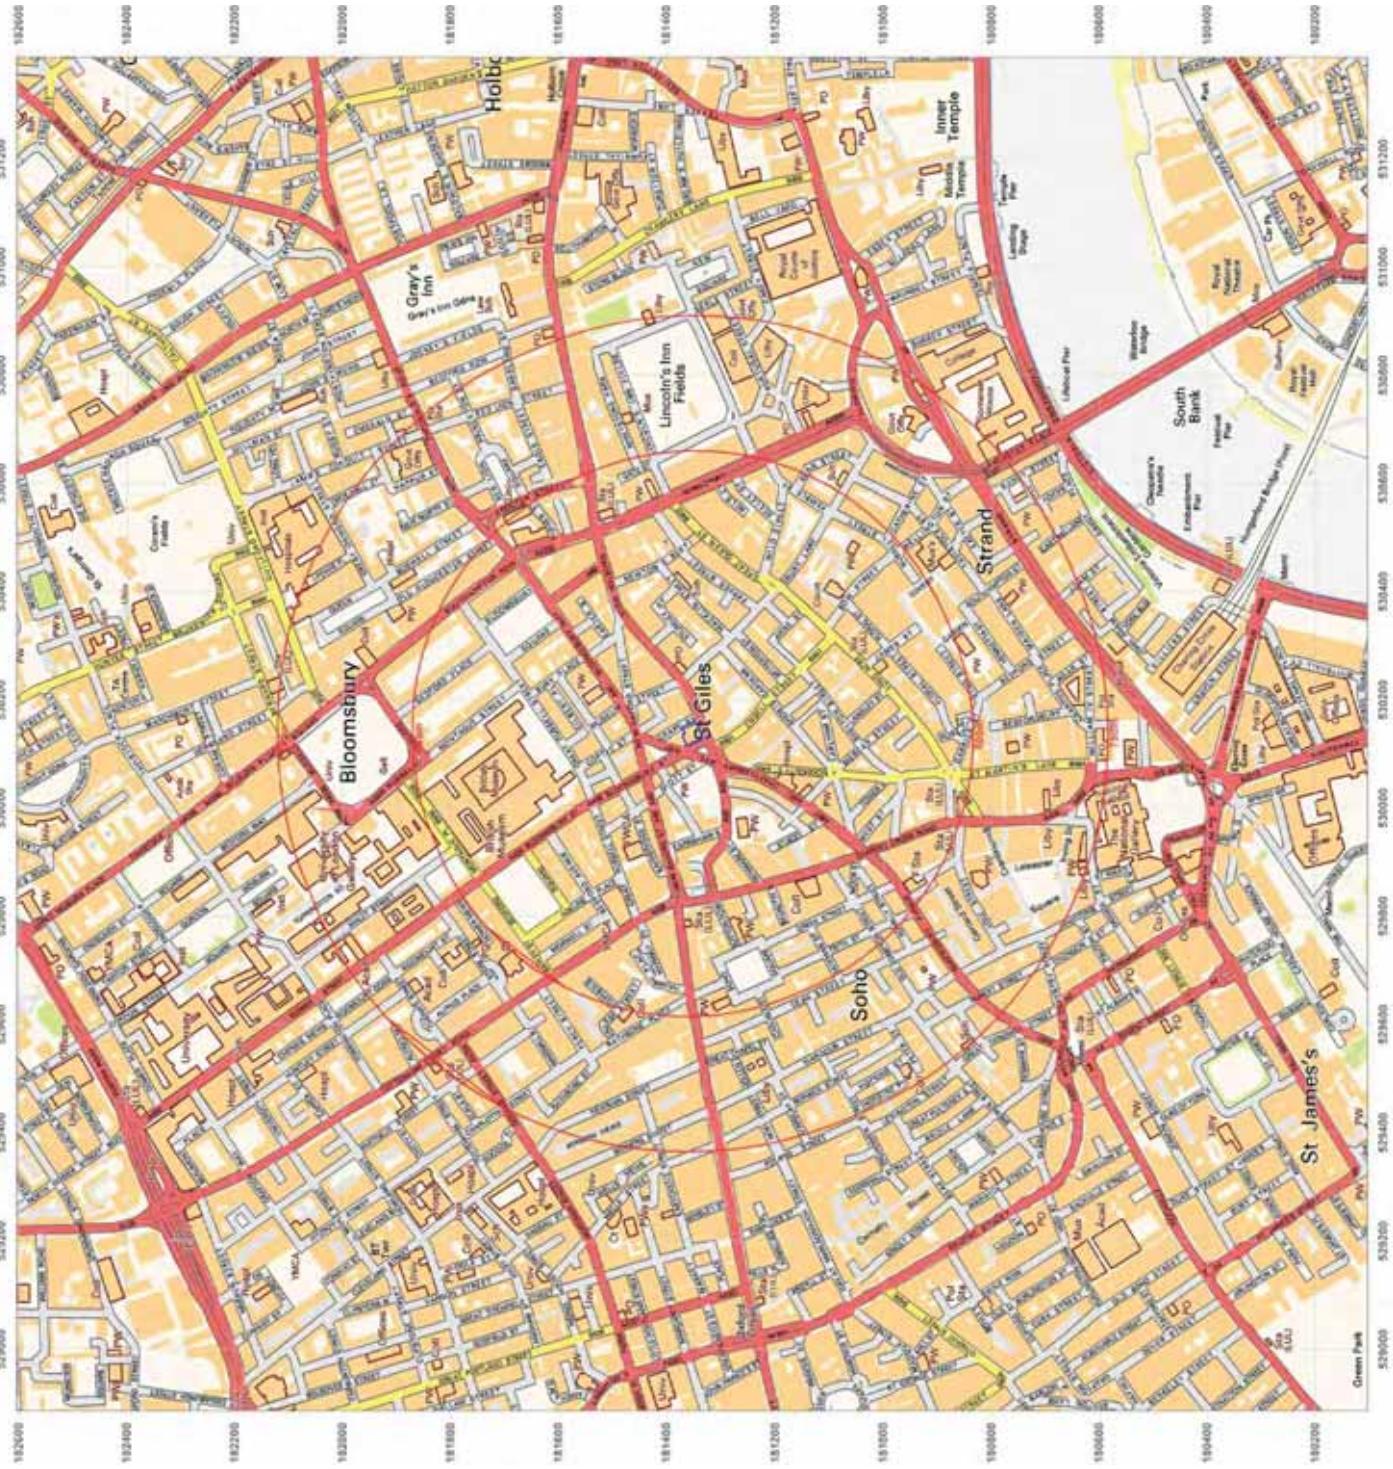
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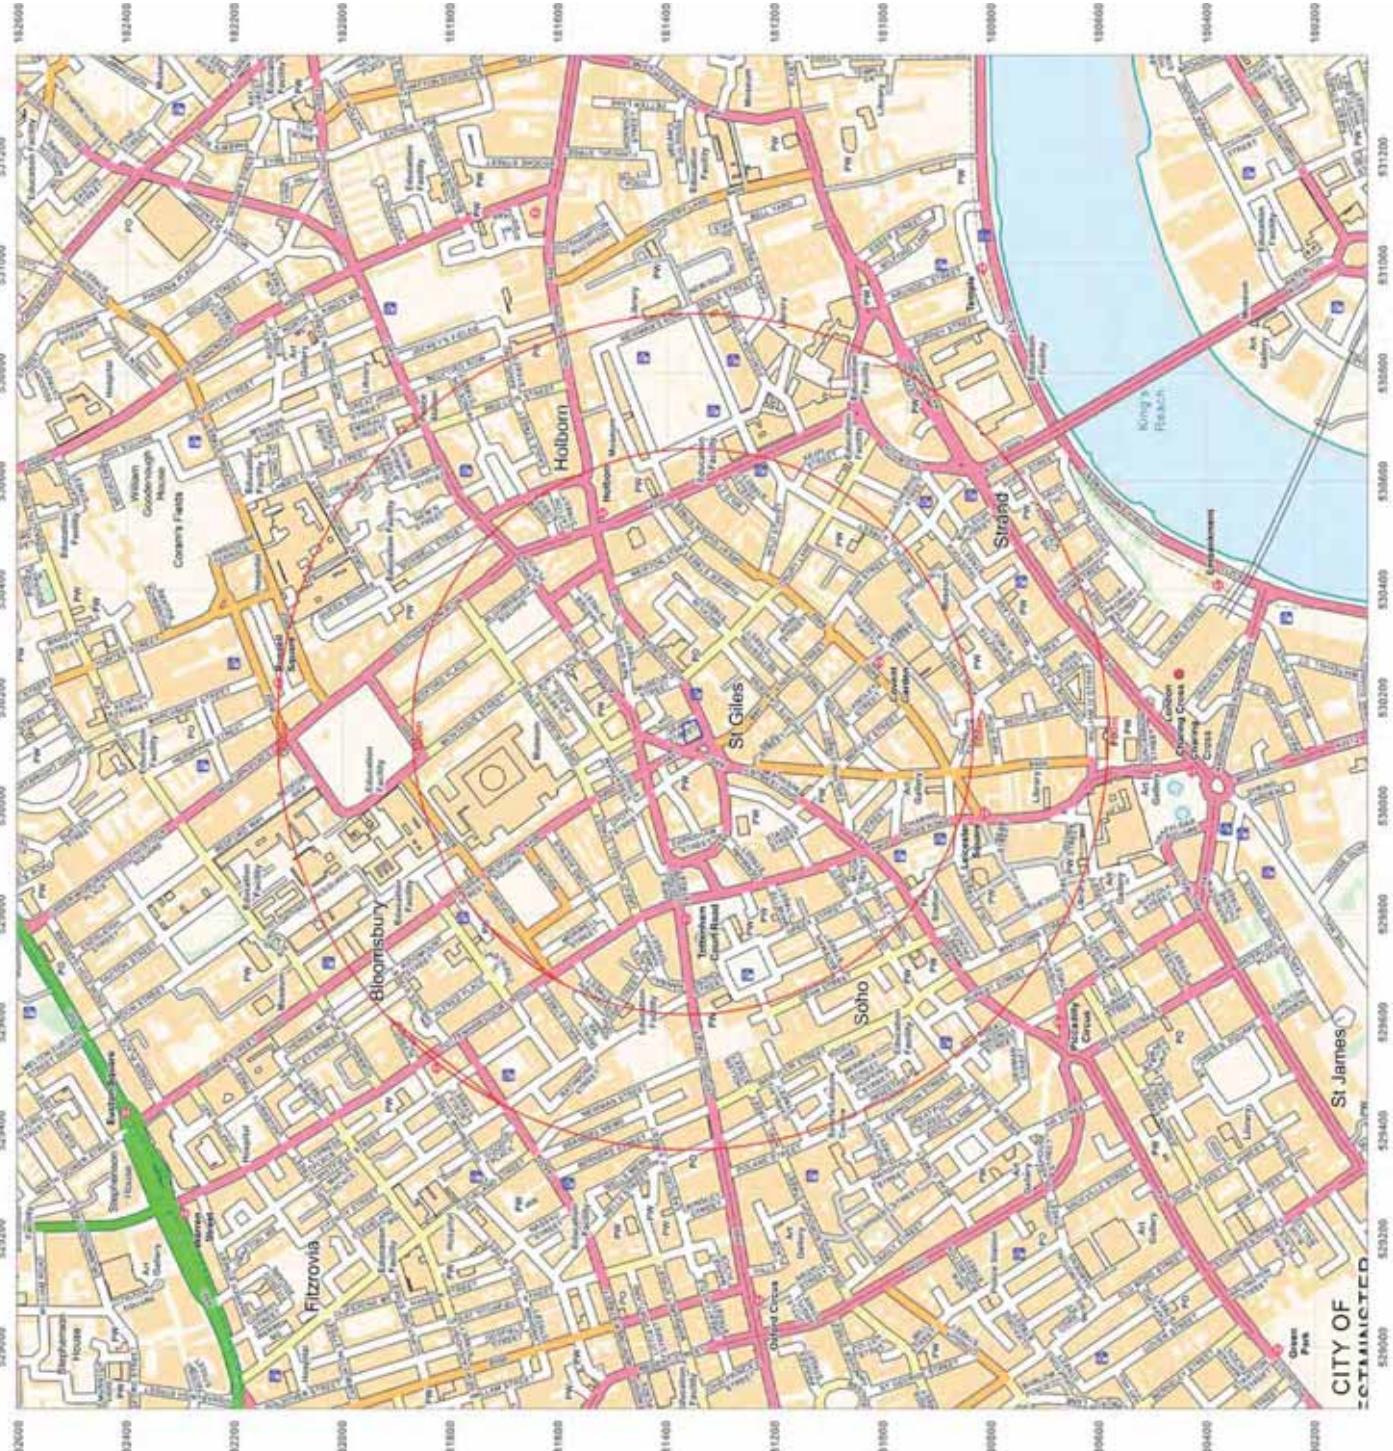
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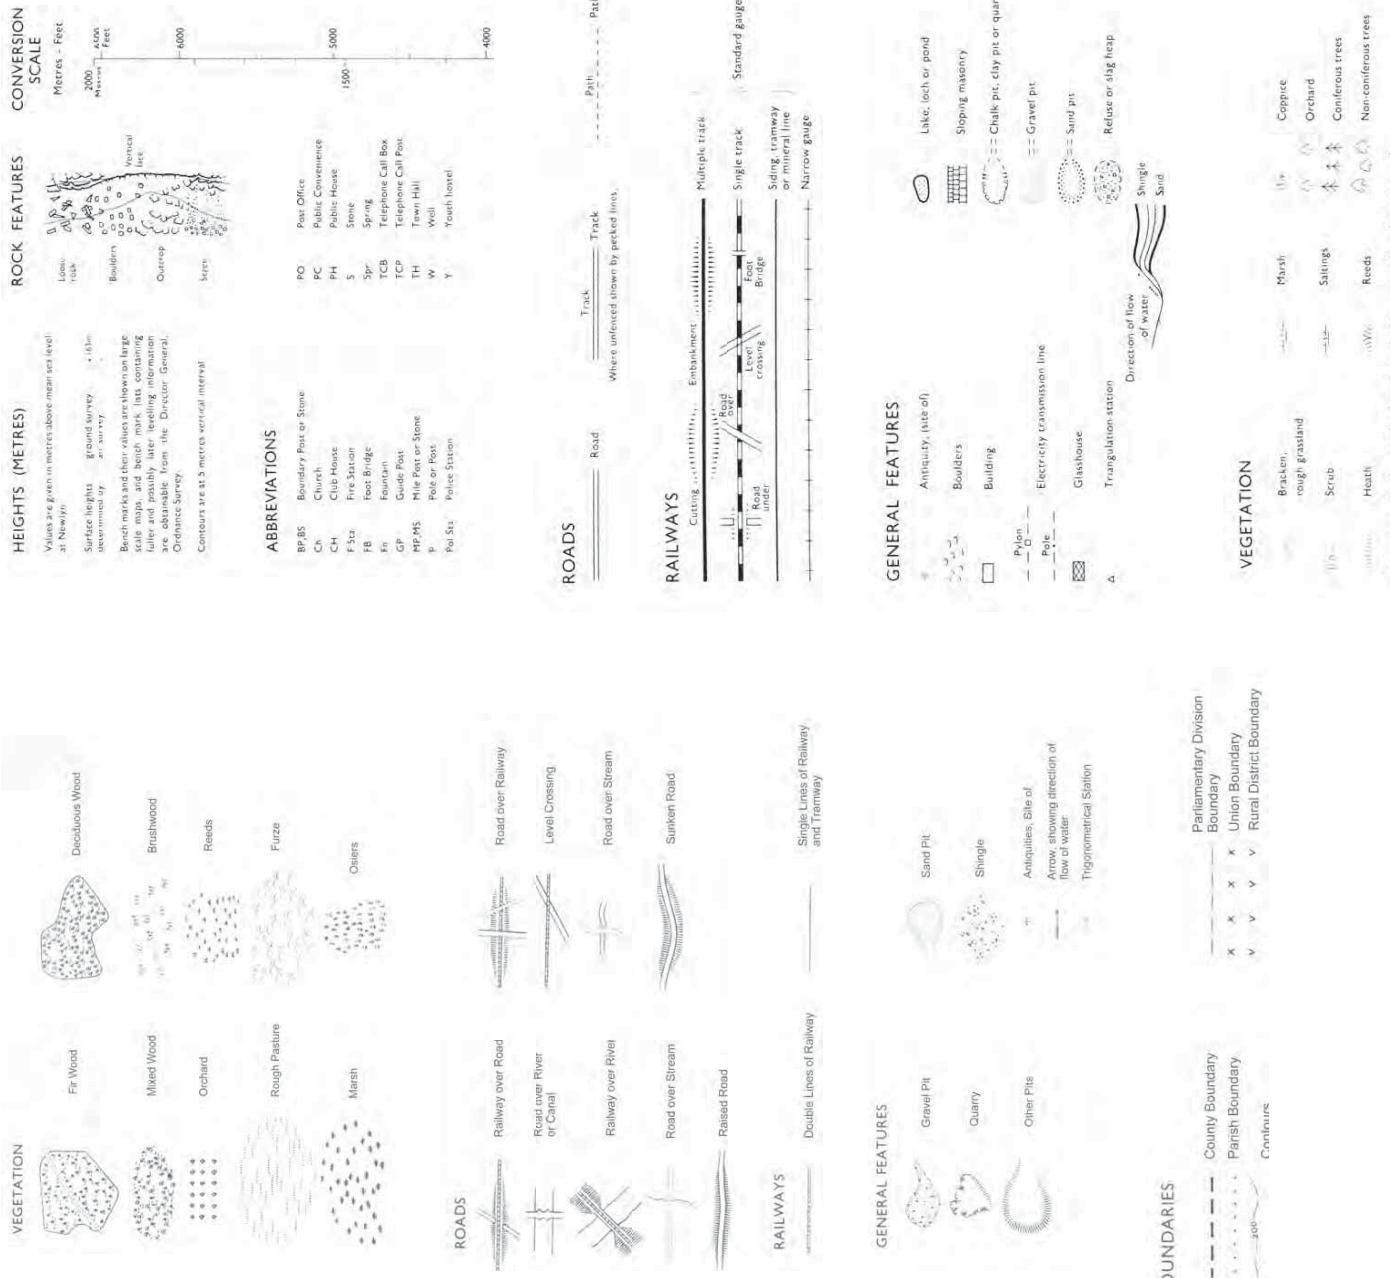


## County Series 1:10,560 scale

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## **APPENDIX B**

### **SITE INVESTIGATION**

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## Factual Site Investigation Report




Desk Studies | Risk Assessments | Site Investigations | Geotechnical | Contamination Investigations | Remediation Design and Validation

**Site: Shaftesbury Theatre, 210 Shaftesbury Ave, City of London,  
WC2H 8DP**

**Client: Theatre of Comedy Company Ltd**

**Report Date: 25<sup>th</sup> January 2013**

**Project Reference: J11265**

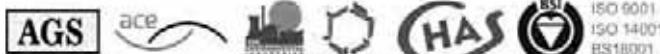

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## SUMMARY

The site comprises the stage area of the Shaftesbury Theatre, including rooms and space below the stage. It is proposed to install piling in order to increase the loading capacity of the stage.

Geological records indicate the site to be underlain by Terrace Gravels over London Clay.

A single borehole was drilled from stage level to 25.2 m below basement floor level.

The soils encountered comprised London Clay to a depth of approximately 25 m below the level of the stage, overlying mottled clays of the Lambeth Group.

Groundwater was not encountered in this investigation.

*The site investigation was conducted and this report has been prepared for the sole internal use and reliance of Theatre of Comedy Company Ltd and their appointed Engineers. This report shall not be relied upon or transferred to any other parties without the express written authorization of Southern Testing Laboratories Limited. If an unauthorised third party comes into possession of this report they rely on it at their peril and the authors owe them no duty of care and skill.*

*The findings and opinions conveyed via this Site Investigation Report are based on information obtained from a variety of sources as detailed within this report, and which Southern Testing Laboratories Ltd believes are reliable. Nevertheless, Southern Testing Laboratories Ltd cannot and does not guarantee the authenticity or reliability of the information it has obtained from others.*



D. Vooght MSc  
(Countersigned)



T. Lees MSc  
(Signed)

For and on behalf of Southern Testing Laboratories Limited

STL: J11265  
25 January 2013

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**APPENDIX A**

Site Plans and Exploratory Hole Logs

**APPENDIX B**

Field Sampling and in-situ Test Methods & Results

**APPENDIX C**

Geotechnical Laboratory Test Methods & Results

## **A INTRODUCTION**

### **1 Authority**

Our authority for carrying out this work is contained in a project order from Theatre of Comedy Company Ltd, dated 19<sup>th</sup> November 2012.

### **2 Location**

The site is located on Shaftesbury Avenue, approximately 0.6 km east of Tottenham Court Road underground station, London. The approximate National Grid Reference of the site is TQ 301 813.

### **3 Proposed Construction**

We understand that it is proposed to install a series of piles beneath the stage.

### **4 Object**

This is a Phase II geotechnical investigation (Tier 1).

The object of the investigation was to assess foundation bearing conditions and other soil parameters relevant to the proposed development and to aid pile design

### **5 Scope**

This factual report presents our exploratory hole logs and test results. As with any site there may be differences in soil conditions between exploratory hole positions.

This factual report is not an engineering design and the figures and calculations contained in the report should be used by the Engineer, taking note that variations will apply, according to variations in design loading, in techniques used, and in site conditions. Our figures therefore should not supersede the Engineer's design.

Contamination issues are not considered in this report.

The findings conveyed via this Factual Site Investigation Report are based on information obtained from a variety of sources as detailed within this report, and which Southern Testing Laboratories Limited believes are reliable. Nevertheless, Southern Testing Laboratories Limited cannot and does not guarantee the authenticity or reliability of the information it has obtained from others.

The site investigation was conducted and this report has been prepared for the sole internal use and reliance of Theatre of Comedy Company Ltd and their appointed Engineers. This report shall not be relied upon or transferred to any other parties without the express written authorization of Southern Testing Laboratories Limited. If an unauthorised third party comes into possession of this report they rely on it at their peril and the authors owe them no duty of care and skill.

## **6      Geology**

The indicated geology is London Clay over Lambeth Group.

### **London Clay**

London Clay is a well-known stiff (high strength) blue-grey, fissured clay, which weathers to a brown colour near the surface. It contains thin layers of nodular calcareous mudstone - "claystone" - from place to place, and crystals of water clear calcium sulphate (selenite) are common. Although slopes will stand in the clay at steep angles in the short term, the long-term stable slope angle is about 7° for grassed, or cleared slopes, and a few degrees more for wooded slopes.

### **Lambeth Group (Woolwich and Reading Beds)**

The Woolwich Beds, part of the Lambeth Formation, consist largely of grey to grey-brown interlaminated fine-grained sands silts and clays. Shelly beds have been identified in both the top and bottom of the formation, with the basal shelly beds being of greater thickness and more readily identifiable. Interlaminated sands and silts and pockets of striped loams may occur in southeastern areas of the London basin. Rock strength bands of weakly cemented shells and limestone can be encountered, particularly in the area between Lewisham and Bermondsey. (Ref: Engineering in the Lambeth Group, CIRIA C583, 2004)

## **B   SITE INVESTIGATION**

### **7   Method**

The strategy adopted for the intrusive investigation comprised the following:

- 1 No borehole was drilled to a depth of 25.2 m below the basement floor using a light percussion, 150mm diameter, shell and auger boring rig. Due to restrictions regarding access to the borehole location an electric breakdown cable percussive rig was utilised. In this investigation ground level is taken as the stage level. The floor of the basement from which intrusive drilling commenced is 2.8 m below this level. In total the basement level is approximately 6 m below street level.

The location of the exploratory hole is shown in Figure 1 in Appendix A.

The fieldwork was carried out between the 14<sup>th</sup> and 16<sup>th</sup> of January 2013.

### **8   Soils as Found**

The soils encountered are described in detail in the attached exploratory hole logs (Appendix A), but in general comprised a stiff to very stiff London Clay over the Lambeth Group (previously the Woolwich and Reading Beds). A summary is given below.

Depth	Thickness	Soil Type	Description
GL – 2.8 m	-	VOID	Open space between stage and basement floor.
2.8 – 2.9 m	0.1 m	CONCRETE	Concrete slab.
2.9 – 3.2 m	0.3 m	MADE GROUND	Sub base consisting of brick and concrete fragments in a clay matrix.
3.2 – 24.5 m	21.3 m	CLAY (LONDON CLAY)	Stiff to very stiff, high strength, dark grey brown clay. With possible selenite crystals.
24.5 m +	Base not reached	CLAY (LAMBETH GROUP)	Very stiff, very high strength blue grey mottled red brown clays.

## C FIELD TESTING AND SAMPLING

The following in-situ test and sampling methods were employed. Descriptions are given in Appendix B together with the test results.

- Standard Penetration Tests
- Disturbed samples
- U100 undisturbed samples


## D GEOTECHNICAL LABORATORY TESTS

The following tests were carried out on selected samples. Test method references and results are given in Appendix C.

- pH value;
- Natural moisture content;
- Atterberg limits;
- Water soluble sulphate content;
- Undrained 100 mm diameter Triaxial tests.

## **APPENDIX A**

**Site Plans and Exploratory Hole Logs**

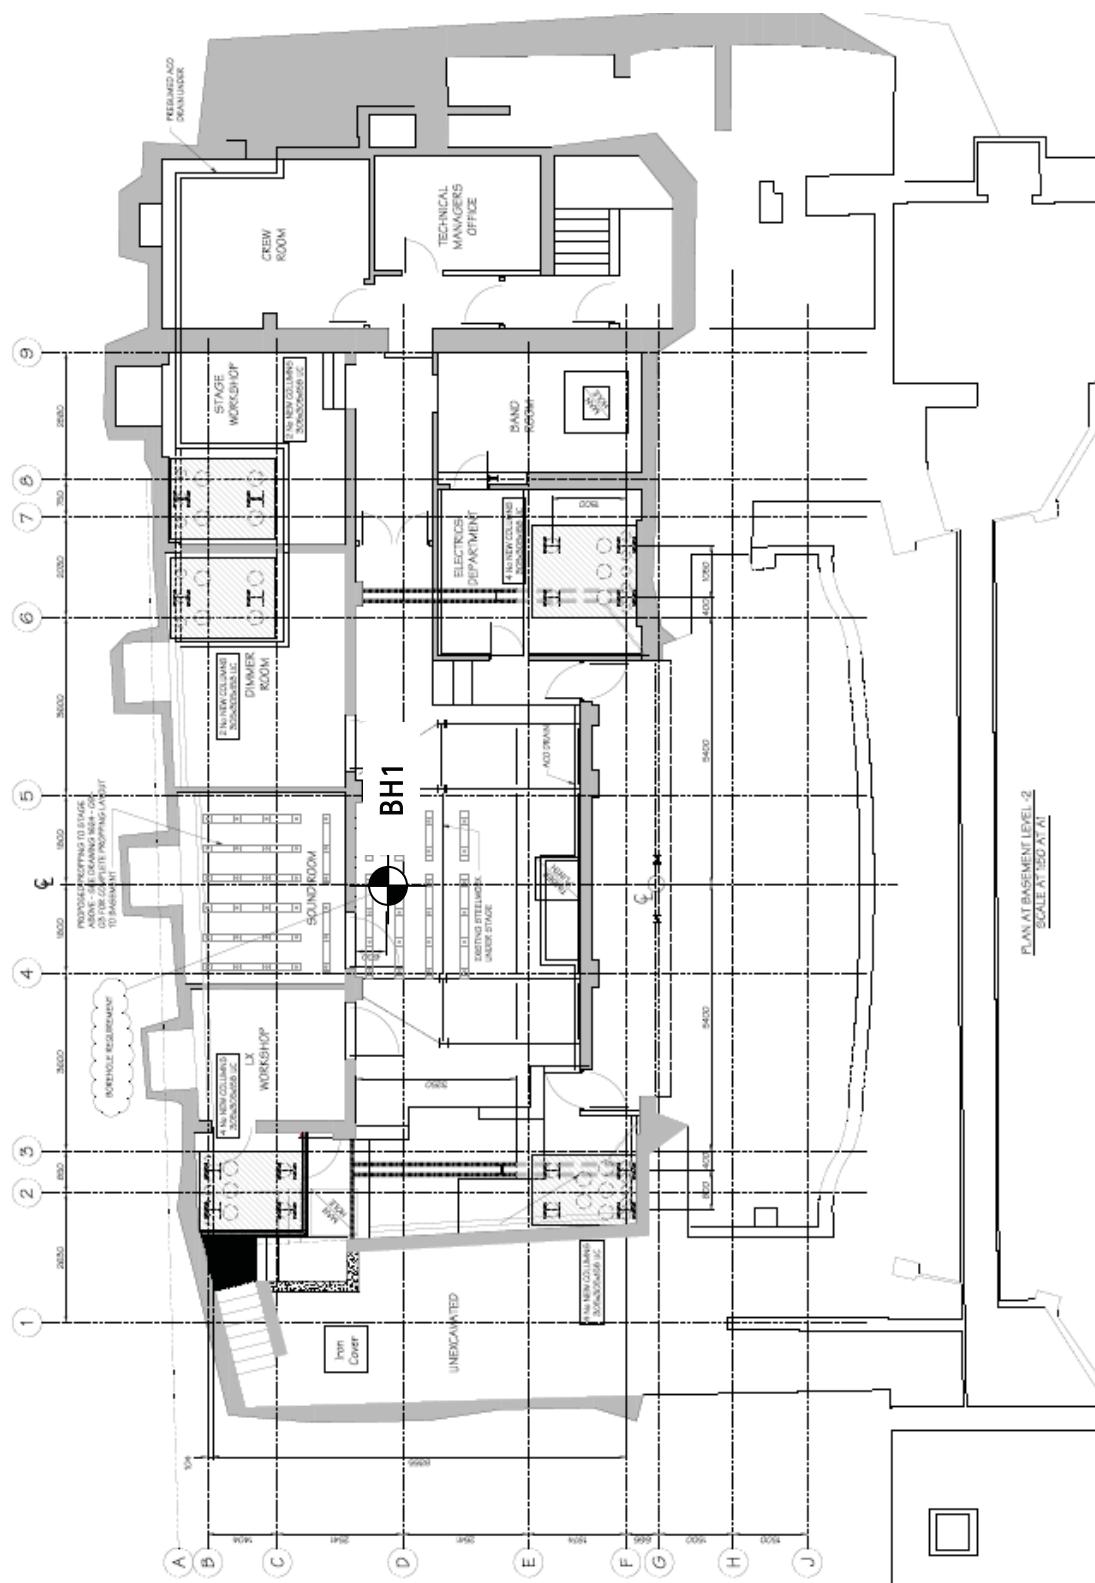

NB: Positions of Boreholes and/or Trial Pits are only indicative unless dimensioned

Site: Shaftesbury Theatre, London

Date: 25 January 2013

**Southern Testing**

Southern Testing: Keeble House, Stuart Way, East Grinstead, West Sussex RH19 4QA  
ST Consult: Twyford Barns, Brixworth Road, Creton, Northampton NN6 8NN




**ST Consult**

STL: J11265

Fig No: 1

Borehole location

PLAN AT BASEMENT LEVEL -2  
SCALE AT 1:50 AT A1

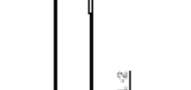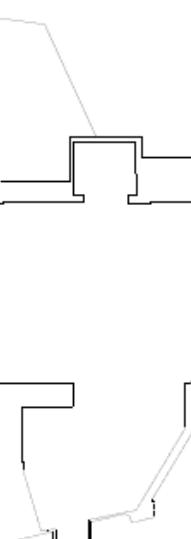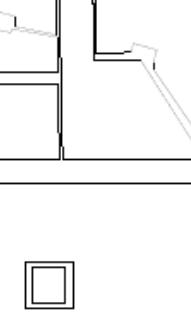




**Site : Shaftesbury Theatre**

**Client : MJ Consulting**

Drilling Method : Shell and Auger (150mm)

National Grid Reference		TQ 301 813	
Start date	14/01/2013	End date	15/01/2013
Ground level		Backfill date	16/01/2013
Logged by	TL	Engineer	DV
Final depth	28.00	Page	1 of 2

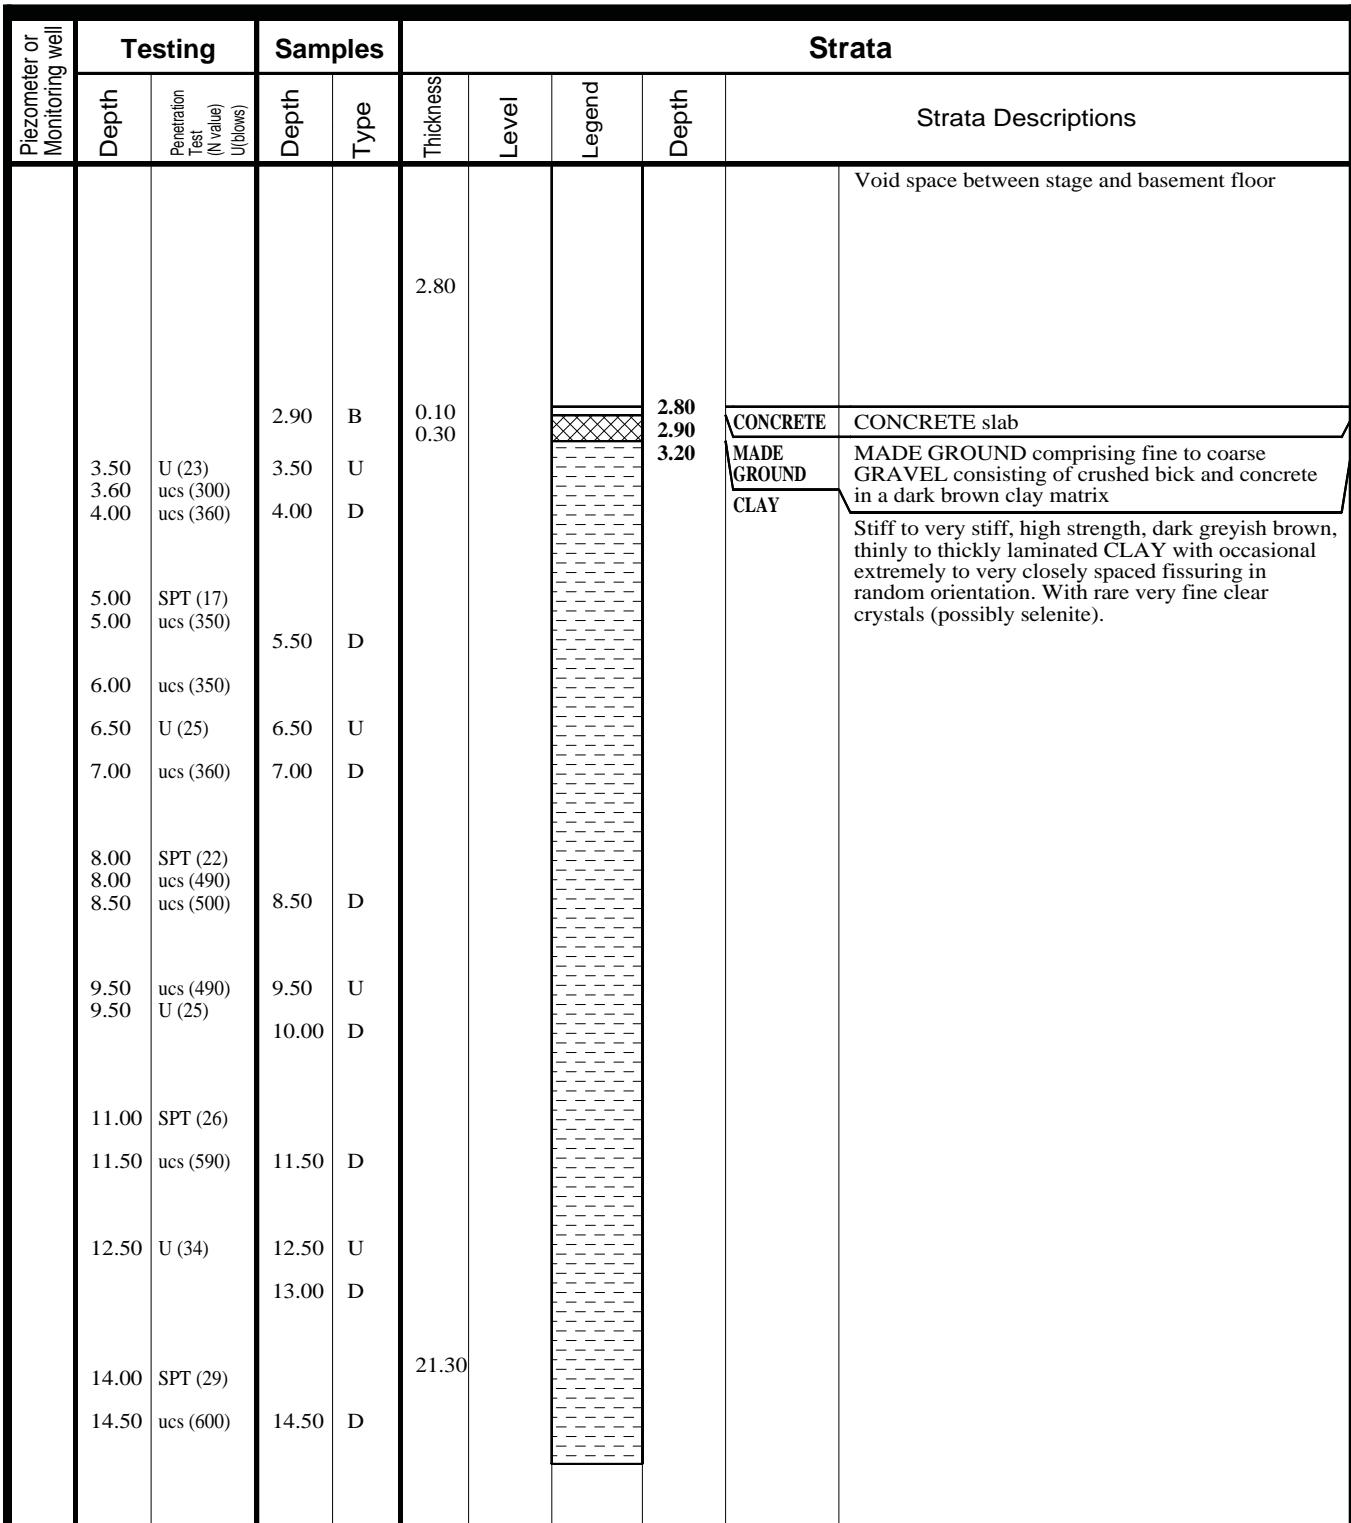

**Site : Shaftesbury Theatre**
**Client : MJ Consulting**

Drilling Method : Shell and Auger (150mm)

National Grid Reference		TQ 301 813	
Start date	14/01/2013	End date	15/01/2013
Ground level		Backfill date	16/01/2013
Logged by	TL	Engineer	DV
Final depth	28.00	Page	2 of 2

Piezometer or Monitoring well	Testing		Samples		Thickness	Level	Legend	Depth	Strata		
	Depth	Penetration Test (N value) U(bows)	Depth	Type					Strata Descriptions		
	15.50	U (35)	15.50	U							
			16.00	D							
	17.00	SPT (29)	17.50	D							
	18.95	U (35)	18.95	U							
			19.00	D							
	20.00	SPT (50 for 75mm)	20.50	D							
	21.50	U (38)	21.50	U							
			22.00	D							
	23.00	SPT (40)	23.50	D							
	24.95	U (50)	24.95	U							
			25.00	D							
	26.00	SPT (51)	26.50	D							
	26.00	ucs (600)									
	27.50	U (50)	27.50	U							
	28.00	ucs (600)	28.00	D							
					24.50						
					3.50						
					28.00						
									End of Borehole		
<b>Hole Diameters</b>			<b>Water Strikes</b>				<b>Chiselling Time</b>			<b>General Remarks</b>	
Depth (m)	Hole (mm)	Casing (mm)	Date	Water (m)	Casing (m)	Time (mins)	Rose to (m)	Sealed (m)	From (m)	To (m)	Time (hrs)
3.50	150	150									

**General Remarks**

Ground level taken as stage surface. Stage surface is 3 m below street level. Basement floor level is 2.8 m below stage level.

## **APPENDIX B**

**Field Sampling and in-situ Test Methods & Results**

## Field Sampling and in-situ Test Methods

### **Disturbed Samples**

Disturbed samples were taken from the trial holes intervals and stored in sealed glass jars and polythene bags, as appropriate.

### **Undisturbed U100 Samples**

Undisturbed U100 samples were taken in the clay soils at appropriate intervals. These samples are taken in a 100 mm diameter, 450 mm long, thin-walled steel tube, and are sealed with paraffin wax and tightly fitting end caps for transporting to the laboratory.

### **Standard Penetration Test**

The Standard Penetration (SPT) Test is specified in BS EN ISO 22476-3 : 2005. In this test, a 51mm diameter open-ended tube is driven into the ground by a 63.5 kg hammer falling freely through 760 mm. The tube is seated by driving to a penetration of 150mm, or by 25 standard blows, whichever occurs first. It is then driven for a maximum of a further 300mm and the number of blows is termed the penetration resistance (N). If 300mm penetration cannot be achieved in 50 blows (100 blows in soft rock), the test drive is terminated.

When testing in gravels, a conical end piece is attached to the tube. The test is then called an SPT(C).

This test provides an indirect method of assessing the properties of cohesionless soils, and the following table (after Terzaghi and Peck) gives the approximate condition:-

Number Blows (N)	Density
0 - 4	Very Loose
4 - 10	Loose
10 - 30	Medium Dense
30 - 50	Dense
Over 50	Very Dense

### **Clay**

An approximate value for the shear strength of clay may be obtained using Stroud (1974), which paper indicates that the cohesive strength is a function of plasticity and SPT 'N' value. The relation is:

$$C_u = f_i \times N \text{ kPa}$$

$$C_u = \text{undrained shear strength}$$

$$f_i = \text{factor related to plasticity index and ranging from 4 to more than 6}$$

The SPT test is not generally accepted as giving a reliable indication of the strength of cohesive soils but it does give a guide; often the following table:-

<b>Number Blows (N)</b>	<b>Soil Strength</b>
Less than 2	Very Soft (Very Low Strength)
2 – 5	Soft (Low Strength)
5 – 10	Firm (Medium Strength)
10 – 15	Stiff (High Strength)
15 – 30	Very Stiff (Very High Strength)

## **APPENDIX C**

**Geotechnical Laboratory Test Methods & Results**

### **Determination of pH value**

The pH value is a measure of acidity or alkalinity. It is measured using an electrometric meter, directly in the case of water, or in a soil suspension in distilled water.

### **Moisture Content**

A sample of soil is dried to constant dry weight at a temperature of 105 degrees centigrade and the moisture content determined.

### **Atterberg Limit Tests**

This is a valuable classification test, which is used to determine the moisture contents at which a soil changes from a liquid through a plastic to a solid state and gives an indication of the clay quantities present in the soil.

### **2 : 1 Water Extract Sulphate Test**


When the water soluble sulphate content, as described above, is classified as Class III or over a 2 : 1 water : soil extract is prepared and the sulphate content determined gravimetrically.

This ensures that only the more readily soluble sulphates - those most likely to attack concrete - are determined.

### **Triaxial Compression Test**

Shear characteristics of the soil are obtained by the undrained triaxial test. In this test, 38mm diameter or 100mm diameter samples were tested in compression under a series of varied lateral pressures, and the angle of shearing resistance and apparent cohesion obtained.

## Plasticity Chart for Atterberg Limit Test Results

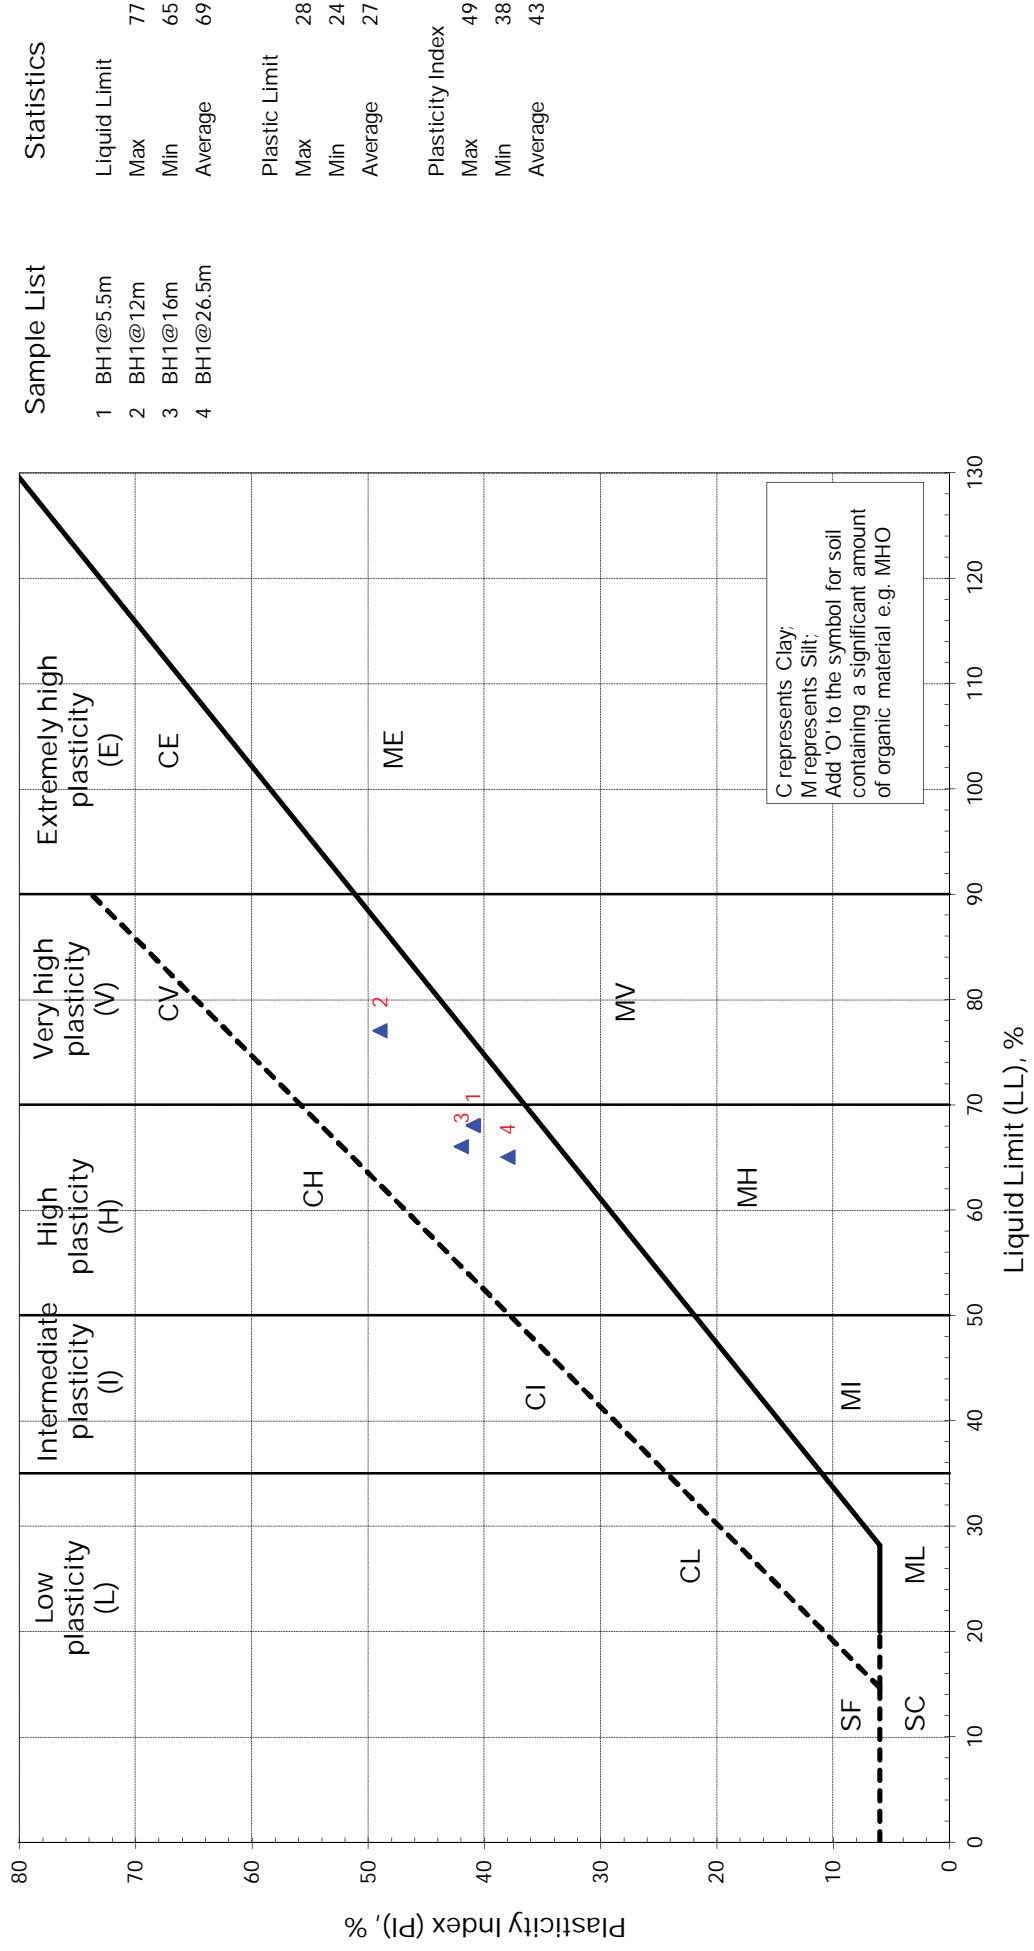

Project Name: Shaftesbury Theatre

Project No.: J11265


Project Engineer: DV

Client: MJ Consulting

Date: 23/01/2013

Figure No. 2

## Plot Relating Soil Plasticity to NH C Classification for Volume Change Potential

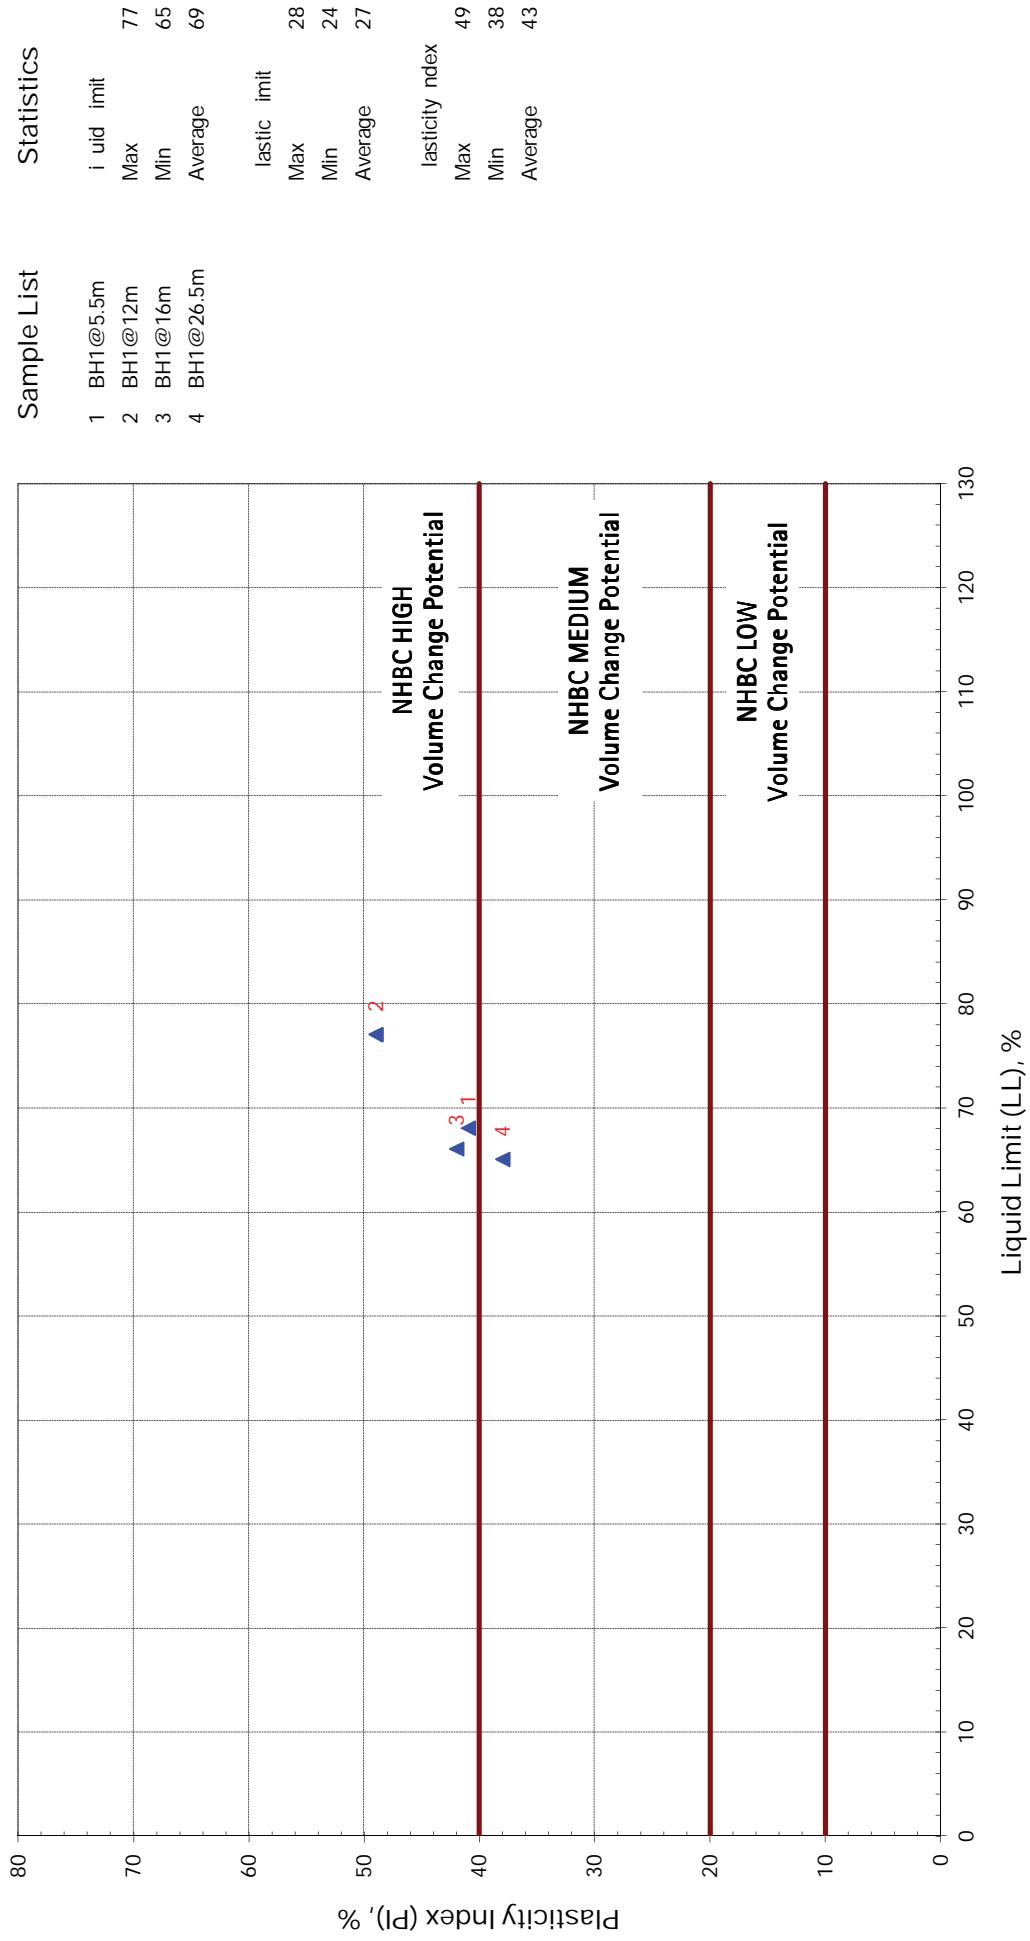

Project Name: Shaftesbury Theatre

Client: MJ Consulting

Project No: J11265

Date: 23/01/2013

Figure No. 3

Project Engineer: DV

### Atterberg Limits Test Result Summary Sheet

*Test arrie out in a or an e ith S 13 21 0 2003 I.3.2 .2 .3 5.3 5.*

Project No : J11265      Checked by : S      Date: 23 Jan 2013

Project Name : Shaftesbury Theatre

Client : MJ Consulting

Plot No	TH No	Depth m	Moisture Content	Liquid Limit	Plastic Limit	Plasticity Index	Classification	% Passing m	Visual Description
1	1	5.50	2 .5	6	2	1	C	100	Very stiff very high strength ar grey C .
2	1	12.00	2 .2		2		CV	100	ar e tre ely high strength ar grey C .
3	1	16.00	23.	66	2	2	C	100	Very stiff very high strength ar grey slightly san y C .
4	1	26.50	2 .	65	2	3	C	100	Very stiff very high strength re bro n ottle light grey C .

Soil roundwater Sulphate Content Test Results							
Test arrive out in a or an e ith S 13 3 1 0 2003 1. 5.3 5. 5.6 .5							
Project No : <b>J11265</b>		Project Name : <b>Shaftesbury Theatre</b>		Client : <b>MJ Consulting</b>			
Tested y :		Chec ed : <b>AS</b>		Date : <b>24-Jan-13</b>			
TH No	Depth	Sample Type	Soil Sulphate in Water Extract	roundwater Sulphate	Total Potential Sulphate	pH Value	Percentage Passing mm Sie e
H	m	g l SO <sub>3</sub>	B mg l SO <sub>4</sub>	g l SO <sub>3</sub>	B mg l SO <sub>4</sub>	SO <sub>3</sub>	SO <sub>4</sub>
H	Soil	<b>0.21</b>	<b>252</b>			<b>7.9</b>	<b>100.0</b>
H	Soil	<b>0.16</b>	<b>192</b>			<b>8.0</b>	<b>100.0</b>
H	Soil	<b>0.40</b>	<b>480</b>			<b>8.0</b>	<b>100.0</b>
H	Soil	<b>0.22</b>	<b>264</b>			<b>8.5</b>	<b>100.0</b>
H	Soil	<b>0.05</b>	<b>60</b>			<b>9.1</b>	<b>100.0</b>

## Summary Sheet Triaxial Compression Test Results BS1377 7 1990 1994

 Proj No: **J11265** Project Name: **Shaftesbury Theatre**

 Chec ed y: AS Date: **23/01/2013**

TH No	Depth m	Moisture Content	ul Density Mg m <sup>3</sup>	Dry Density Mg m <sup>3</sup>	Cell Pressure a	De iator Stress a	Apparent Cohesion C <sub>u</sub> a	Visual Description	Sample Type	CS by Hand Pen m <sup>2</sup>
H	26.1	1. 0	1.50	20	256.5	12 .2	Very stiff fissure slightly san y C .		100	60
H	2 .	1.	1.	5	2 .6	122.3	Very stiff fissure slightly san y C .		100	560
H	2 .1	1.	1. 6	135	2 0.2	1 0.1	Very stiff e tre ely high strength grey bro n slightly san y C .		100	600
H	2 .1	1.	1. 3	1 5	335.	16 .	Very stiff fissure e tre ely high strength grey bro n slightly san y C .		100	600
H	26.	1. 1	1.51	255	6 .	23 .2	Very stiff fissure e tre ely high strength grey bro n slightly san y C .		100	600
H	25.	1. 2	1.53	315	56 .	2 3.	Very stiff fissure e tre ely high strength grey bro n slightly san y C .		100	600
H	25.5	1.	1.50	3 5	.2	2 .1	Very stiff fissure e tre ely high strength grey bro n slightly san y C .		100	600
H	1 .	2.03	1.6	35	6 .5	3 3.	Very stiff fissure e tre ely high strength grey bro n slightly san y C .		100	600

**Summary Sheet Triaxial Compression Test Results BS1377 7 1990 1994**

Proj No:		J11265		Project Name: <b>Shaftesbury Theatre</b>		Chec ed		y: AS	Date:	23/01/2013
TH No	Depth m	Moisture Content	Dry Density Mg m <sup>3</sup>	Cell Pressure Mg m <sup>3</sup>	De iator Stress a	Apparent Cohesion C <sub>u</sub> a	Visual Description	Sample Type	CS by Hand Pen	m <sup>2</sup>
H	1 .0	2.0	1. 1	5	1 2.5	1.3	Very stiff e tr e ly high strength light grey otte orange bro n san y C .	100	600	



# Scientific Analysis Laboratories Ltd

## Certificate of Analysis

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3 Crittall Drive  
Springwood Industrial Estate  
Braintree Essex  
CM7 2RT  
Tel : 01376 560120  
Fax : 01376 552923

**Report Number:** 312763-1

**Date of Report:** 30-Jan-2013

**Customer:** Southern Testing Laboratories  
Keeble House  
Stuart Way  
East Grinstead  
West Sussex  
RH19 4QA

**Customer Contact:** Mr David Vooght

**Customer Job Reference:** J11265

**Customer Purchase Order:** STL8657C

**Customer Site Reference:** Shaftesbury Theatre, Shaftesbury

**Date Job Received at SAL:** 22-Jan-2013

**Date Analysis Started:** 23-Jan-2013

**Date Analysis Completed:** 30-Jan-2013

The results reported relate to samples received in the laboratory

Opinions and interpretations expressed herein are outside the scope of UKAS accreditation

This report should not be reproduced except in full without the written approval of the laboratory

Tests covered by this certificate were conducted in accordance with SAL SOPs

All results have been reviewed in accordance with QP22



Report checked  
and authorised by :

Issued by :  
Miss Sarah Brown  
Analyst

SAL Reference:	312763				
Project Site:	Shaftesbury Theatre, Shaftesbury				
Customer Reference:	J11265				
Soil	Analysed as Soil				
BRE SD1 (SE)					
	SAL Reference <b>312763 001</b>				
	Customer Sample Reference <b>BH1 @ 2.70m</b>				
	Date Sampled <b>16-JAN-2013</b>				
Determinand	Method	Test Sample	LOD	Units	
(Water soluble) Ammonia expressed as NH4	T306	AR	0.01	g/l	<0.01
(Water soluble) Cl-	T426	A40	0.01	g/l	<b>0.04</b>
Magnesium	T112	A40	1	mg/l	<b>11</b>
(Water soluble) NO3	T426	A40	0.01	g/l	<0.01
pH	T7	A40			<b>8.0</b>
SO4(Total)	T102	A40	0.01	%	<b>0.23</b>
(Water Soluble) SO4-- expressed as SO4	T242	A40	0.01	g/l	<b>0.29</b>
Sulphur (total)	T6	A40	0.01	%	<b>0.81</b>

## Index to symbols used in 312763-1

Value	Description
A40	Assisted dried < 40C
AR	As Received
U	Analysis is UKAS accredited
N	Analysis is not UKAS accredited

## Method Index

Value	Description
T6	ICP/OES
T7	Probe
T102	ICP/OES (HCl extract)
T242	2:1 Extraction/ICP/OES (TRL 447 T1)
T426	2:1 Extraction / IC
T112	ICP/OES (SIM)(Water Extract)
T306	2:1 Extraction / Colorimetry

## Accreditation Summary

Determinand	Method	Test Sample	LOD	Units	Symbol	SAL References
(Water soluble) Ammonia expressed as NH4	T306	AR	0.01	g/l	N	001
(Water soluble) Cl-	T426	A40	0.01	g/l	N	001
Magnesium	T112	A40	1	mg/l	N	001
(Water soluble) NO3	T426	A40	0.01	g/l	N	001
pH	T7	A40			U	001
SO4(Total)	T102	A40	0.01	%	U	001
(Water Soluble) SO4-- expressed as SO4	T242	A40	0.01	g/l	U	001
Sulphur (total)	T6	A40	0.01	%	U	001



<b>RSK</b>	<b>TRIAL PIT 3</b>	<b>Client: The Theatre of Comedy Company</b>	<b>Appendix B</b>
		<b>Site: Shaftesbury Theatre</b>	<b>Job No: 371647</b>
		<b>Scale: NTS</b>	<b>Source: Site Observations</b>



## **APPENDIX C**

# **PROPOSED DEVELOPMENT PLANS AND SECTIONS**

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For Bennett's Associates' electronic information security disclaimer -  
[www.bennettsassociates.com/InformationSecurityDisclaimer/](http://www.bennettsassociates.com/InformationSecurityDisclaimer/)

Project No. 1702  
**Shaftesbury Theatre**  
The Theatre of Comedy Company

Drawing Title  
Proposed Plan  
Basement  
Stamps

Drawing Number	1702_20_099	Scale @ A3	1 : 100
Revision/Suitability	A	Scale @ A1	
		Revolution Date	17/11/09 YY MM DD

Notes



### HIGH HOLBORN

GRAPE STREET

PRINCES CIRCUS

SHAFTESBURY AVENUE




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ASSOCIATES**

Project No. 1702  
**Shaftesbury Theatre**  
The Theatre of Comedy Company

Drawing File  
Proposed Plan  
Ground Floor  
Lower Royal Circle

Revision/Suitability  
A  
Drawing Number  
1702\_20\_100  
Scale @ A3  
1:100  
Revision Date  
17/11/09  
BY AM CO

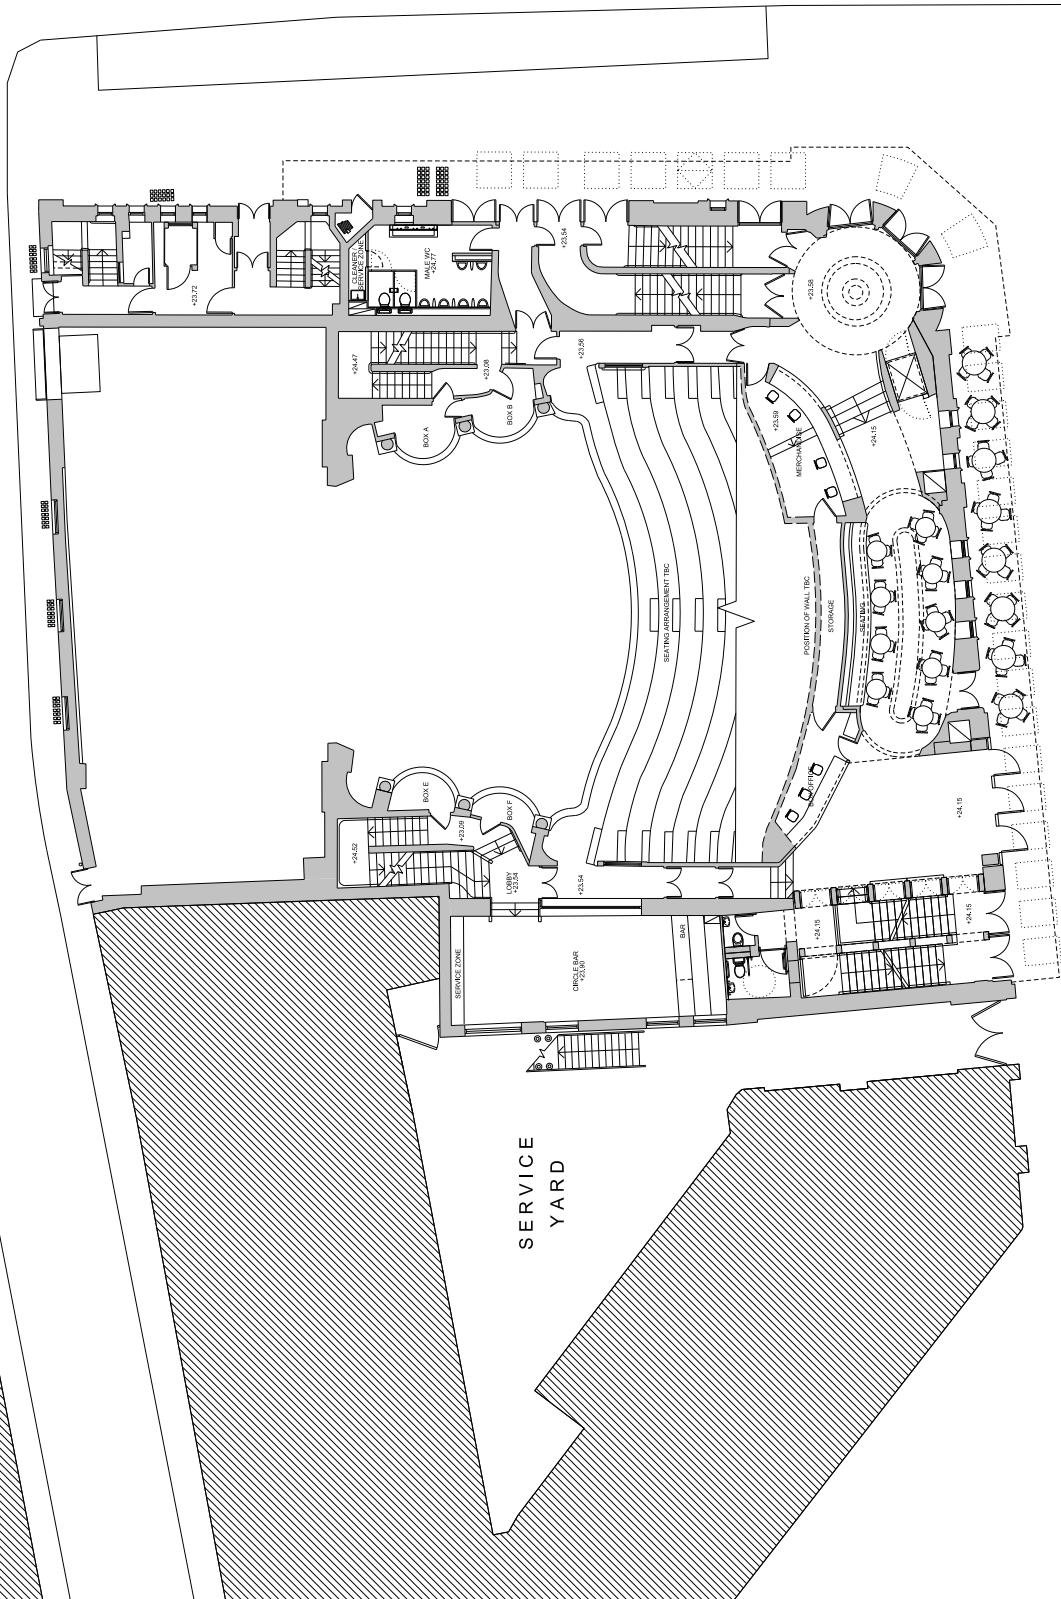



The Theatre of Comedy Company  
  
Shaftesbury Theatre


BENNETTS  
ASSOCIATES

Shaftesbury Theatre  
Project No. 1702  
Project  
[www.bethellsassociates.com/London/Design.html](http://www.bethellsassociates.com/London/Design.html)

Drawing Title

**Proposed Plan**  
**First Floor**  
**Upper Royal Circle**

Drawing Number	11702_20_101		
Scale @ A3	Scale @ A1	Scale @ A1	Revision Date
1 : 200	1 : 100	1 : 100	171109

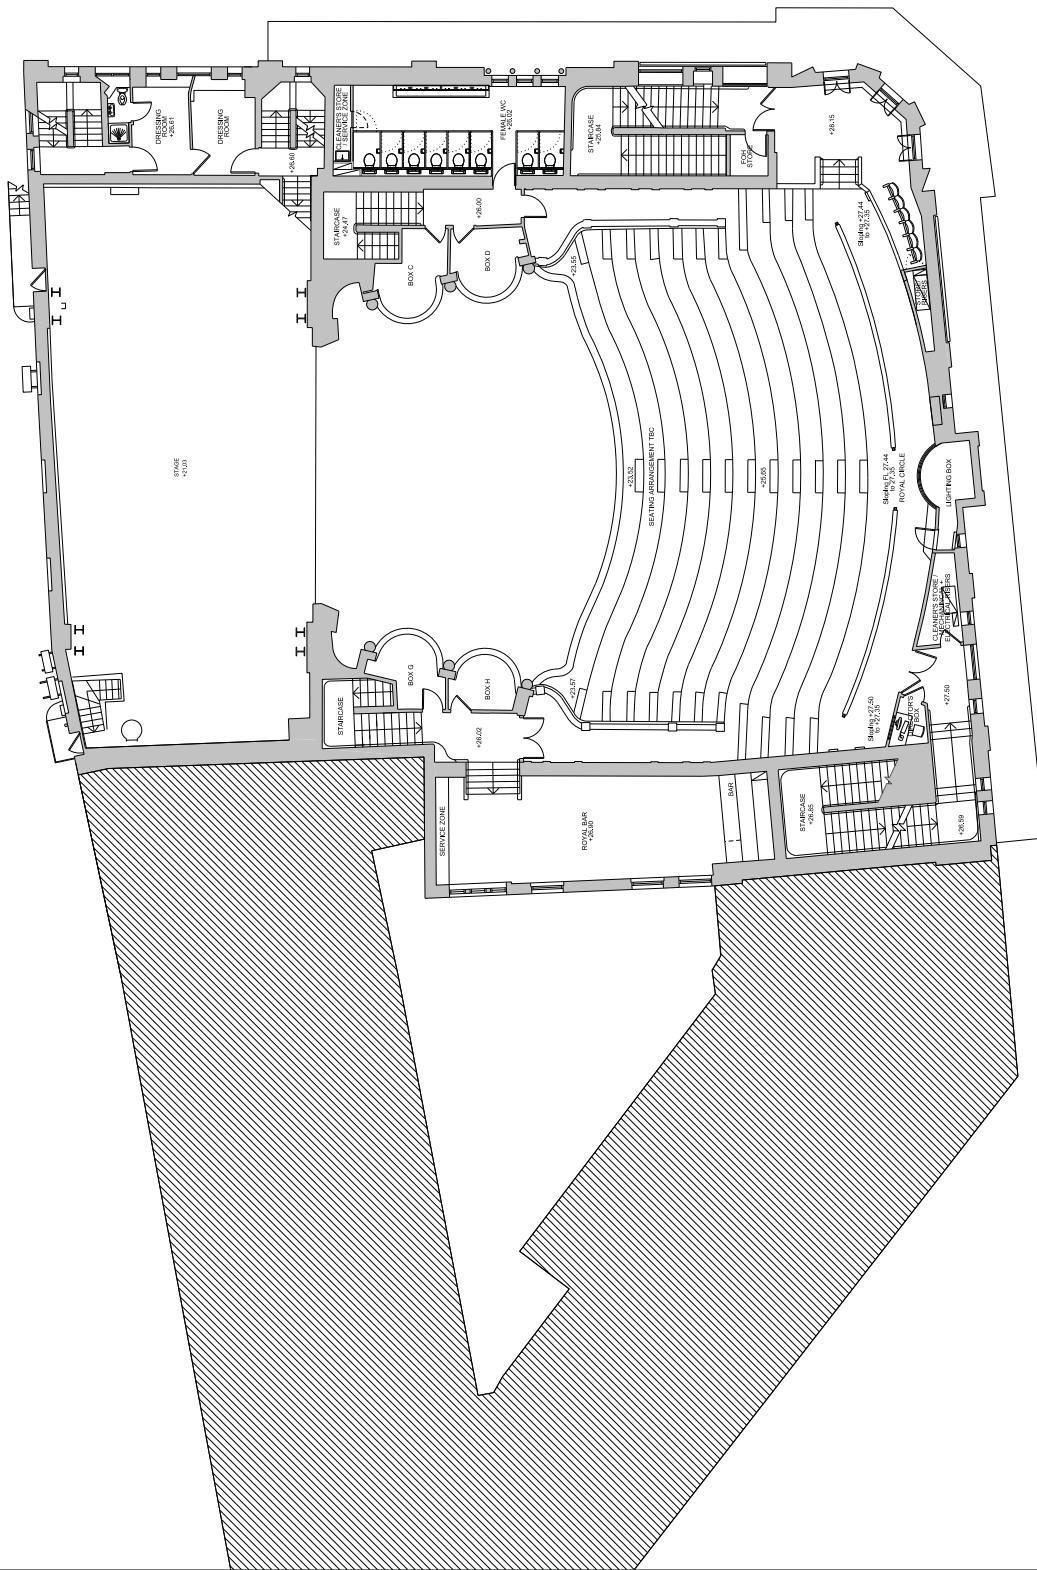

Notes



Shaftesbury Theatre

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Project No. 1702  
**Shaftesbury Theatre**  
The Theatre of Comedy Company

Drawing File

Proposed Plan

Second Floor

Lower Grand Circle

Revision/Suitability

Drawing Number  
1702\_20\_102

A


Proposed Plan

Scale @ A3

1 : 100

Revision Date  
171109

BY AM CO

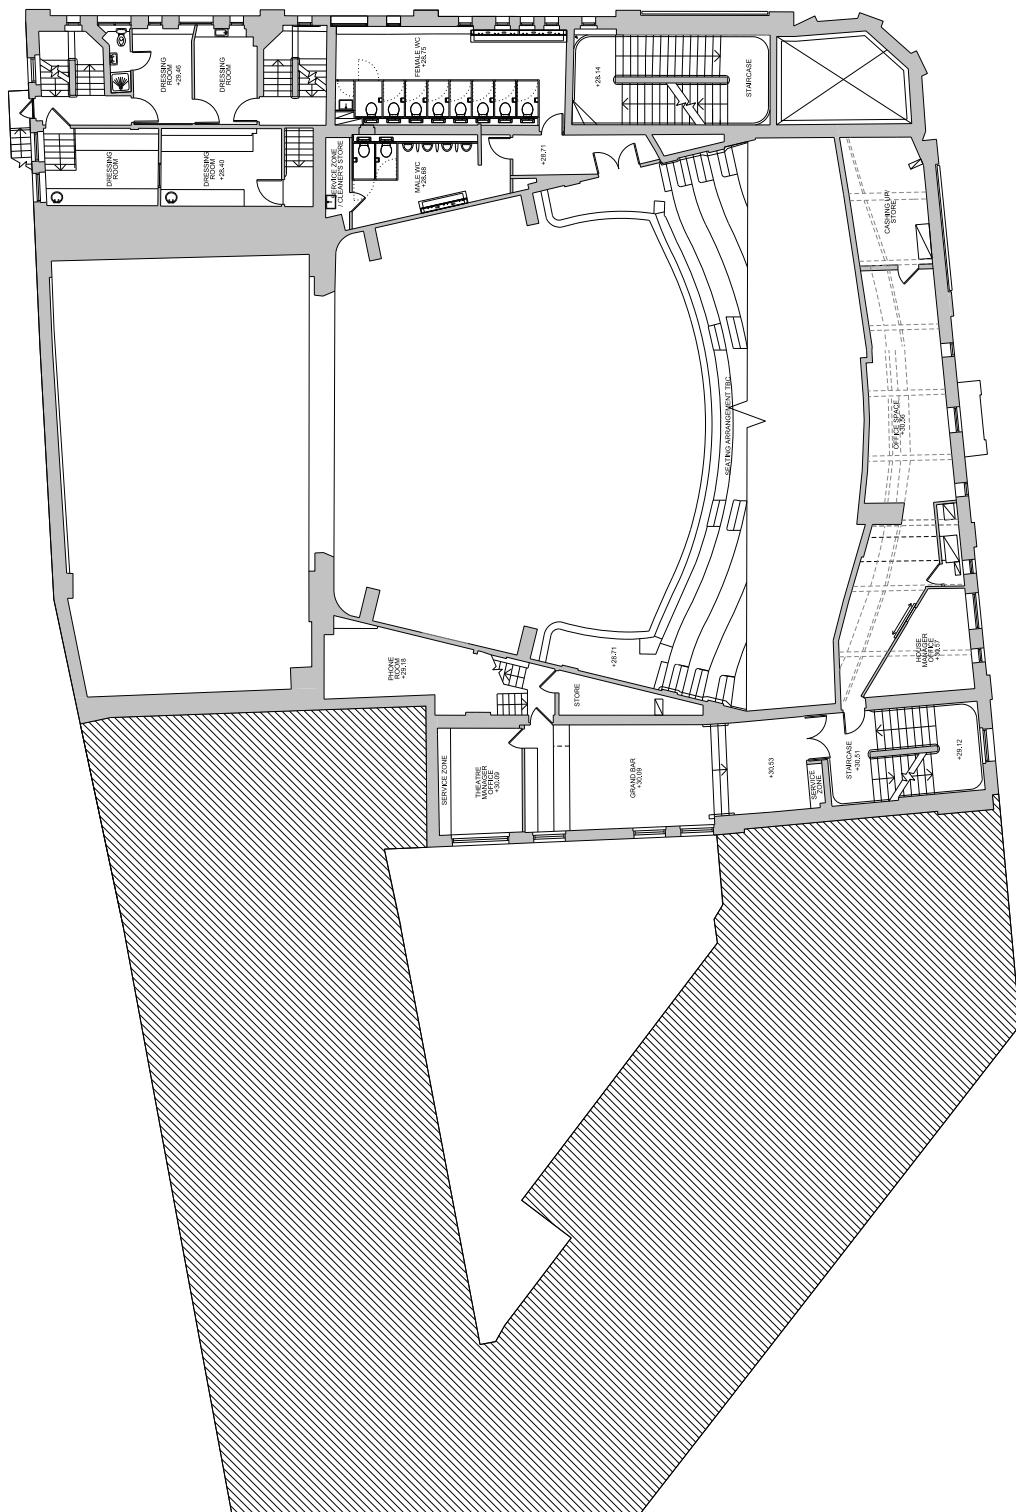



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Denavit-Hartenberg matrix:  
www.robomotionsoft.com/botframe/bdhmatrix

The Theatre of Comedy Company

Proposed Plan  
Third Floor

Scale @ A3  
1 : 200  
Scale @ A1  
1 : 100  
Revision Date  
171109