



Proposed Main House Flank Elevation

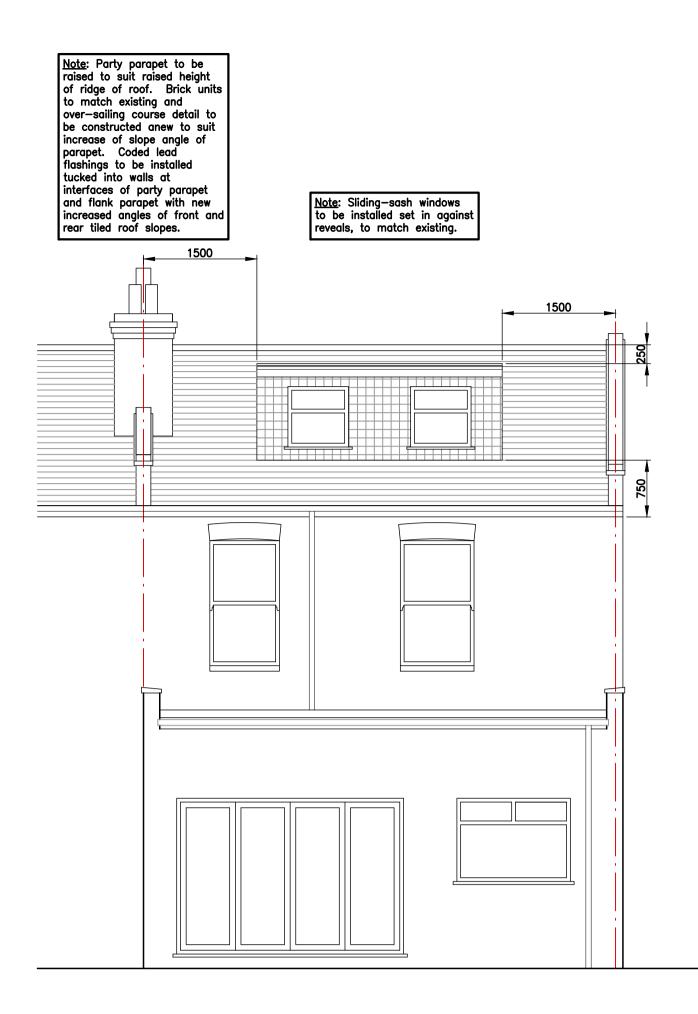

Proposed Rear Elevation

Note: Main flank wall: Existing gable height of wall is bowed outwards, and shall be carefully demolished and reconstructed vertically, plumb and square. The existing brick units shall be salvaged where possible to reinstate the uniformity of the brickwork that remains in place. Any shortfall of brick units and the additionally required brick units to construct the raised gable wall and party wall shall be of colour and appearance to match existing.

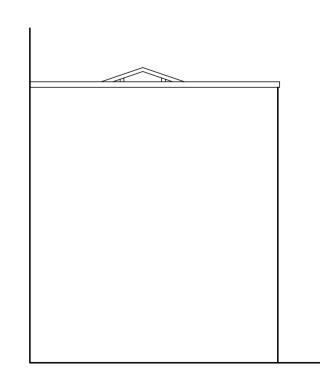

Proposed Rear Extension Flank Elevation

	Notes:	
	1. All fenestration, materials and colours of tiles are	
	to match existing. 2. This drawing should be	read in conjunction with
	drawings 1635/02 to 0	-
	D Front—to—back dimension single—story rear extensio	
	confirmed to accord with rear garden area.	50% of
	C Proposed main roof detai dormer revised in accord with Planning Department	ance
	requirements. B Raised ridge shown on fro	ont 23.12.17 TC. TH.
	elevation. Further note ad front and rear elevations.	ded to
	A Arrangement of rear wind dormer rear elevation wal amended. Flat roof added	I
	floor plan. Roof lantern a client's requirements.	
	 First Issue For Information Rev Description 	n. 26.11.17 TC. TH. Date By Chkd.
		RMATION
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	Client : MR. M. WHITFIELD	
	Project : 38 CONSTANTINE ROAD,	
	GOSPEL OAK, LONDON,	
	NW3 2NG Title :	
	PROPOSED	ELEVATIONS ECTIONS
10m	Drawn : T. Crosby	Designed : T. Harriette
	Date : 26.11.2017 Scale : 1:50	Drg. No. : Rev 1635/05 D
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