

Copyright: All rights reserved. This drawing must not be reproduced without permission.

Only the original drawing should be relied upon. Contractors, subcontractors and suppliers must verify all dimensions on site before commencing any work or making any shop drawings. All shop drawings to be submitted to the architect for comment prior to fabrication.

This drawing is to be read in conjunction with the Architect's specification, bills of quantities / schedules, structural, mechanical & electrical drawings and all discrepancies are to be reported to the architect.

Do not scale from this drawing. Dimensions are in millimetres unless otherwise stated.

revision / date / amendments - / --/--/-- /

### LEGEND 90000000


	Proposed Works
	Existing Building Fabric KOKO née Camden Palace Theatre (1900)
	Existing Building Fabric Hope & Anchor (approx. 1850)
	Existing Building Fabric Bayham Place (from 1875)
	Existing Modern Building Fabric Bayham Place (from 2006)
	Building Fabric to be demolished
	Demolition of Flooring / Elevation / Wall
	Proposed Excavation
	Remove and retain in alternate location
	Retain and protect existing
	Retain, make good, ease and adjusted
	Means of escape Route
>	Private Members Route
	Koko Customer Route
>	Public Route
	Artist Route
	Proposed Riser
	Proposed Risers Above
RM.4-06	Room Number
D4-02	Door Number
W4-05	Window Number
	Hope & Anchor Demise
	Koko Demise
	1 Bayham Street & 65 Bayham Place Demise
	Blue Roof
1 -	7 10 17

### 17.10.17 DRAFT 0 1 2 3 4 5 8m

### PLANNING

Archer Humphryes Architects


project title KOKO + Hope & Anchor + Bay Camden, London	ham I	Place
drawing title	scale 1:100@A1	date 13.04.17
Proposed Third Floor Plan	drawn FR/PC	checked DA
drawing number AHA/ KKC /GA/103	revision -	

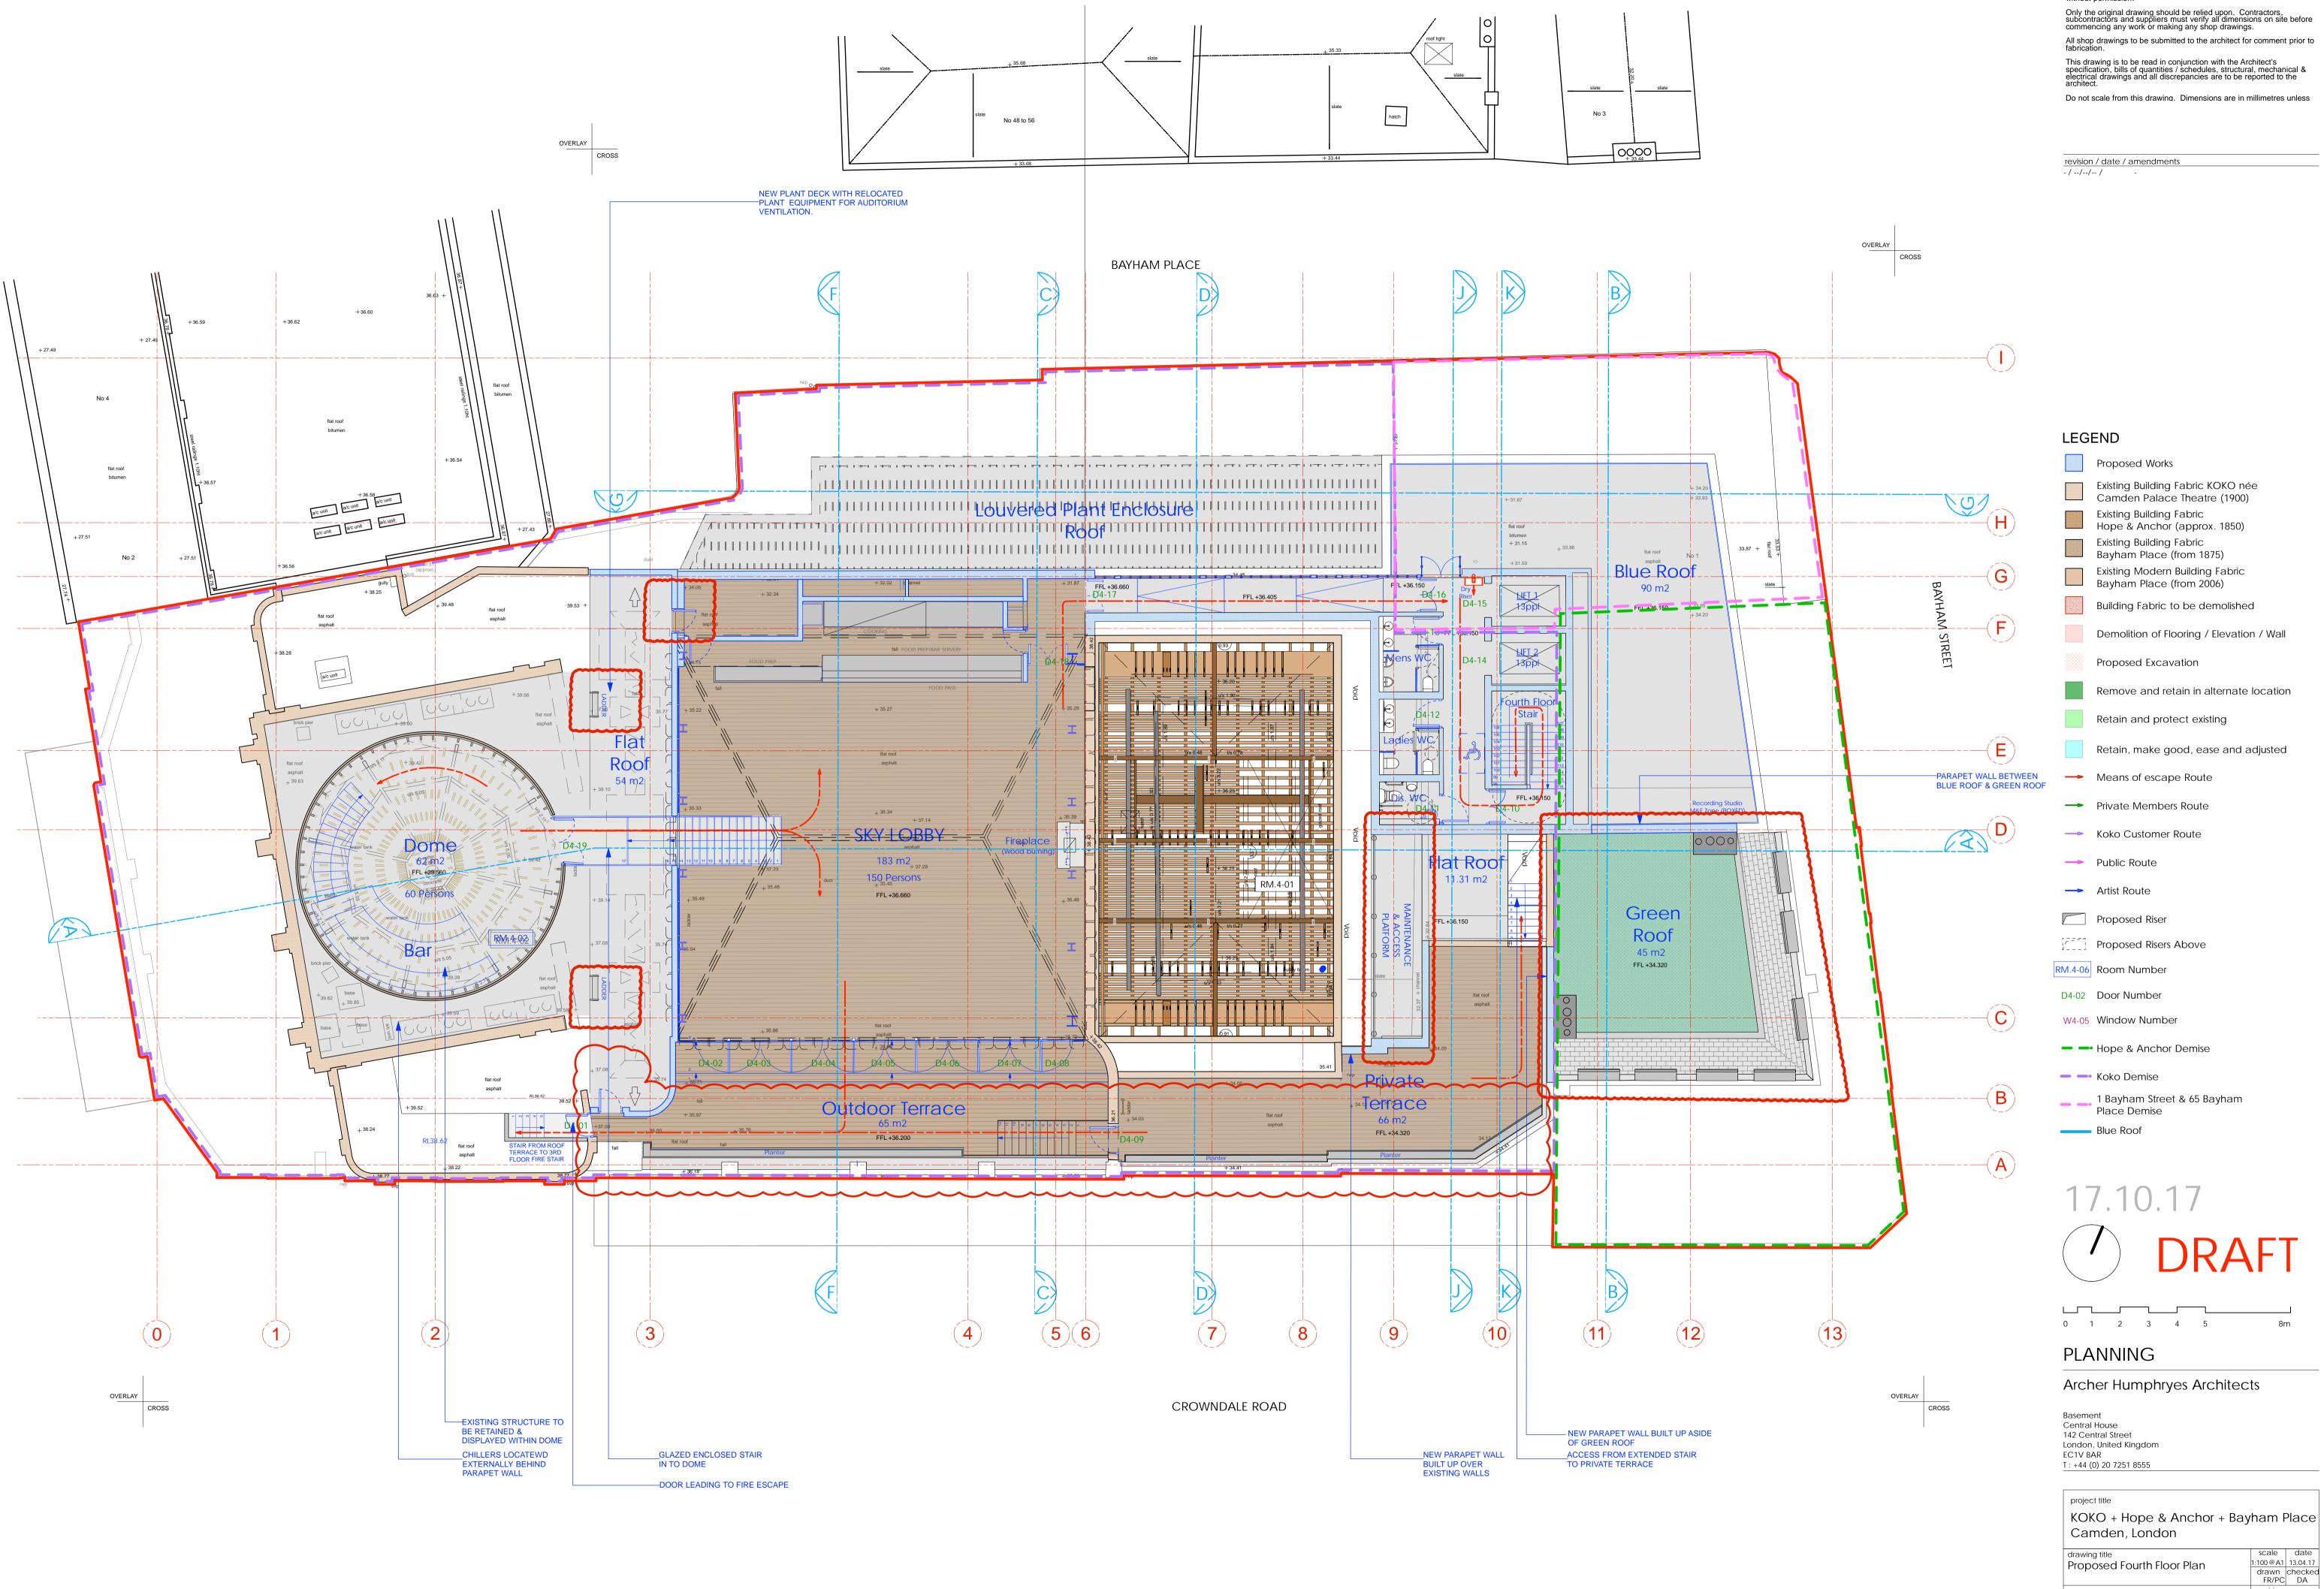


Copyright: All rights reserved. This drawing must not be reproduced without permission.

drawing number AHA/ KKC /GA/104

revision

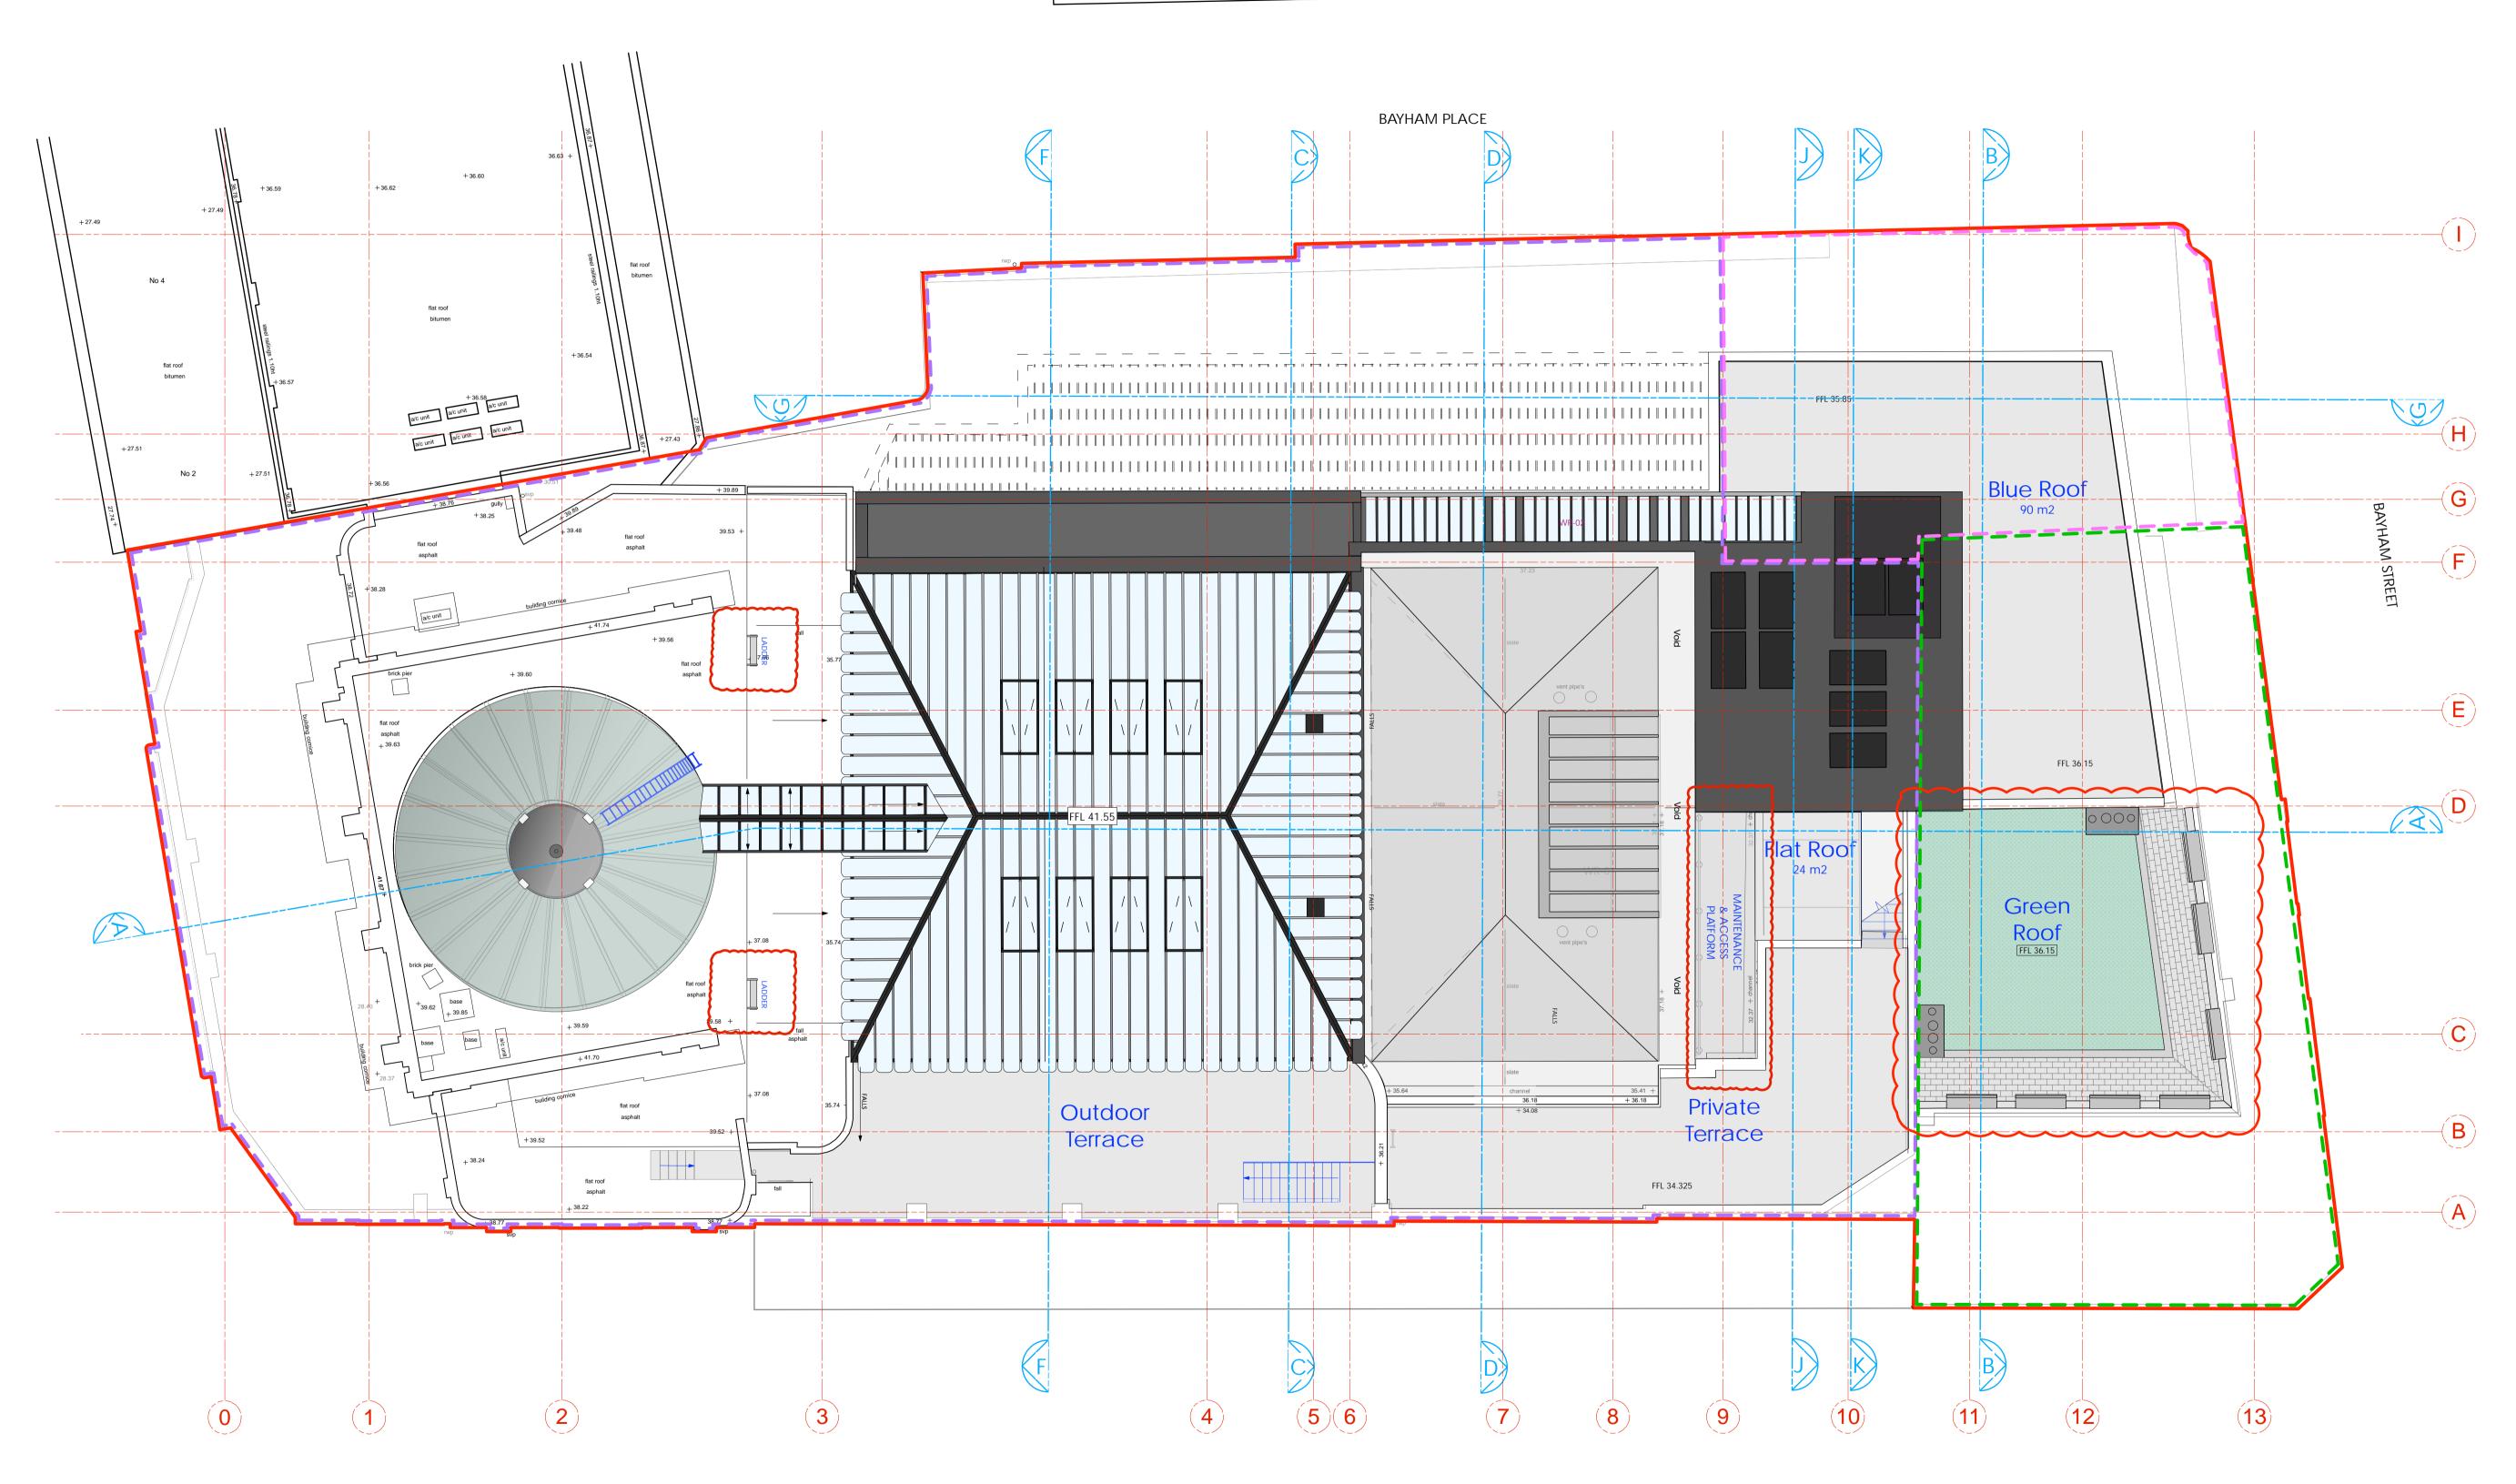

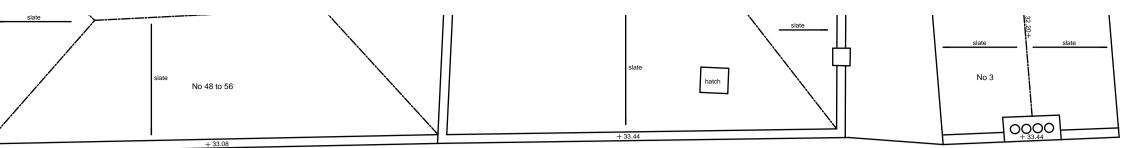

CROWNDALE ROAD

Copyright: All rights reserved. This drawing must not be reproduced without permission.


Only the original drawing should be relied upon. Contractors, subcontractors and suppliers must verify all dimensions on site before commencing any work or making any shop drawings. All shop drawings to be submitted to the architect for comment prior to fabrication.

This drawing is to be read in conjunction with the Architect's specification, bills of quantities / schedules, structural, mechanical & electrical drawings and all discrepancies are to be reported to the architect.

```
revision / date / amendments
```




	Proposed Works
	Existing Building Fabric KOKO née Camden Palace Theatre (1900)
	Existing Building Fabric Hope & Anchor (approx. 1850)
	Existing Building Fabric
	Bayham Place (from 1875) Existing Modern Building Fabric
	Bayham Place (from 2006)
	Building Fabric to be demolished
	Demolition of Flooring / Elevation / Wall
	Proposed Excavation
	Remove and retain in alternate location
	Retain and protect existing
	Retain, make good, ease and adjusted
	Means of escape Route
>	Private Members Route
	Koko Customer Route
	Public Route
Å	Public Route Artist Route
	Artist Route
	Artist Route Proposed Riser Proposed Risers Above
RM.4-06	Artist Route Proposed Riser Proposed Risers Above
RM.4-06	Artist Route Proposed Riser Proposed Risers Above Room Number
RM.4-06	Artist Route Proposed Riser Proposed Risers Above Room Number Door Number
RM.4-06	Artist Route Proposed Riser Proposed Risers Above Room Number Door Number Window Number
RM.4-06	Artist Route Proposed Riser Proposed Risers Above Room Number Door Number Window Number Hope & Anchor Demise
RM.4-06	Artist Route Proposed Riser Proposed Risers Above Room Number Door Number Window Number Hope & Anchor Demise Koko Demise 1 Bayham Street & 65 Bayham
RM.4-06	Artist Route Proposed Riser Proposed Risers Above Room Number Door Number Window Number Hope & Anchor Demise Koko Demise 1 Bayham Street & 65 Bayham Place Demise
RM.4-06 D4-02 W4-05	Artist Route Proposed Riser Proposed Risers Above Room Number Door Number Window Number Hope & Anchor Demise Koko Demise 1 Bayham Street & 65 Bayham Place Demise

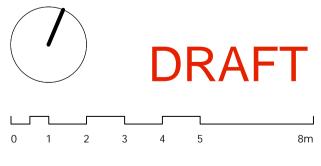

## PLANNING

### Archer Humphryes Architects

project title KOKO + Hope & Anchor + Bay Camden, London	ham I	Place
drawing title	scale 1:100@A1	date 26.05.17
Proposed Roof Plan	drawn FR/PC	checked DA
drawing number AHA/ KKC /GA/105	revision -	

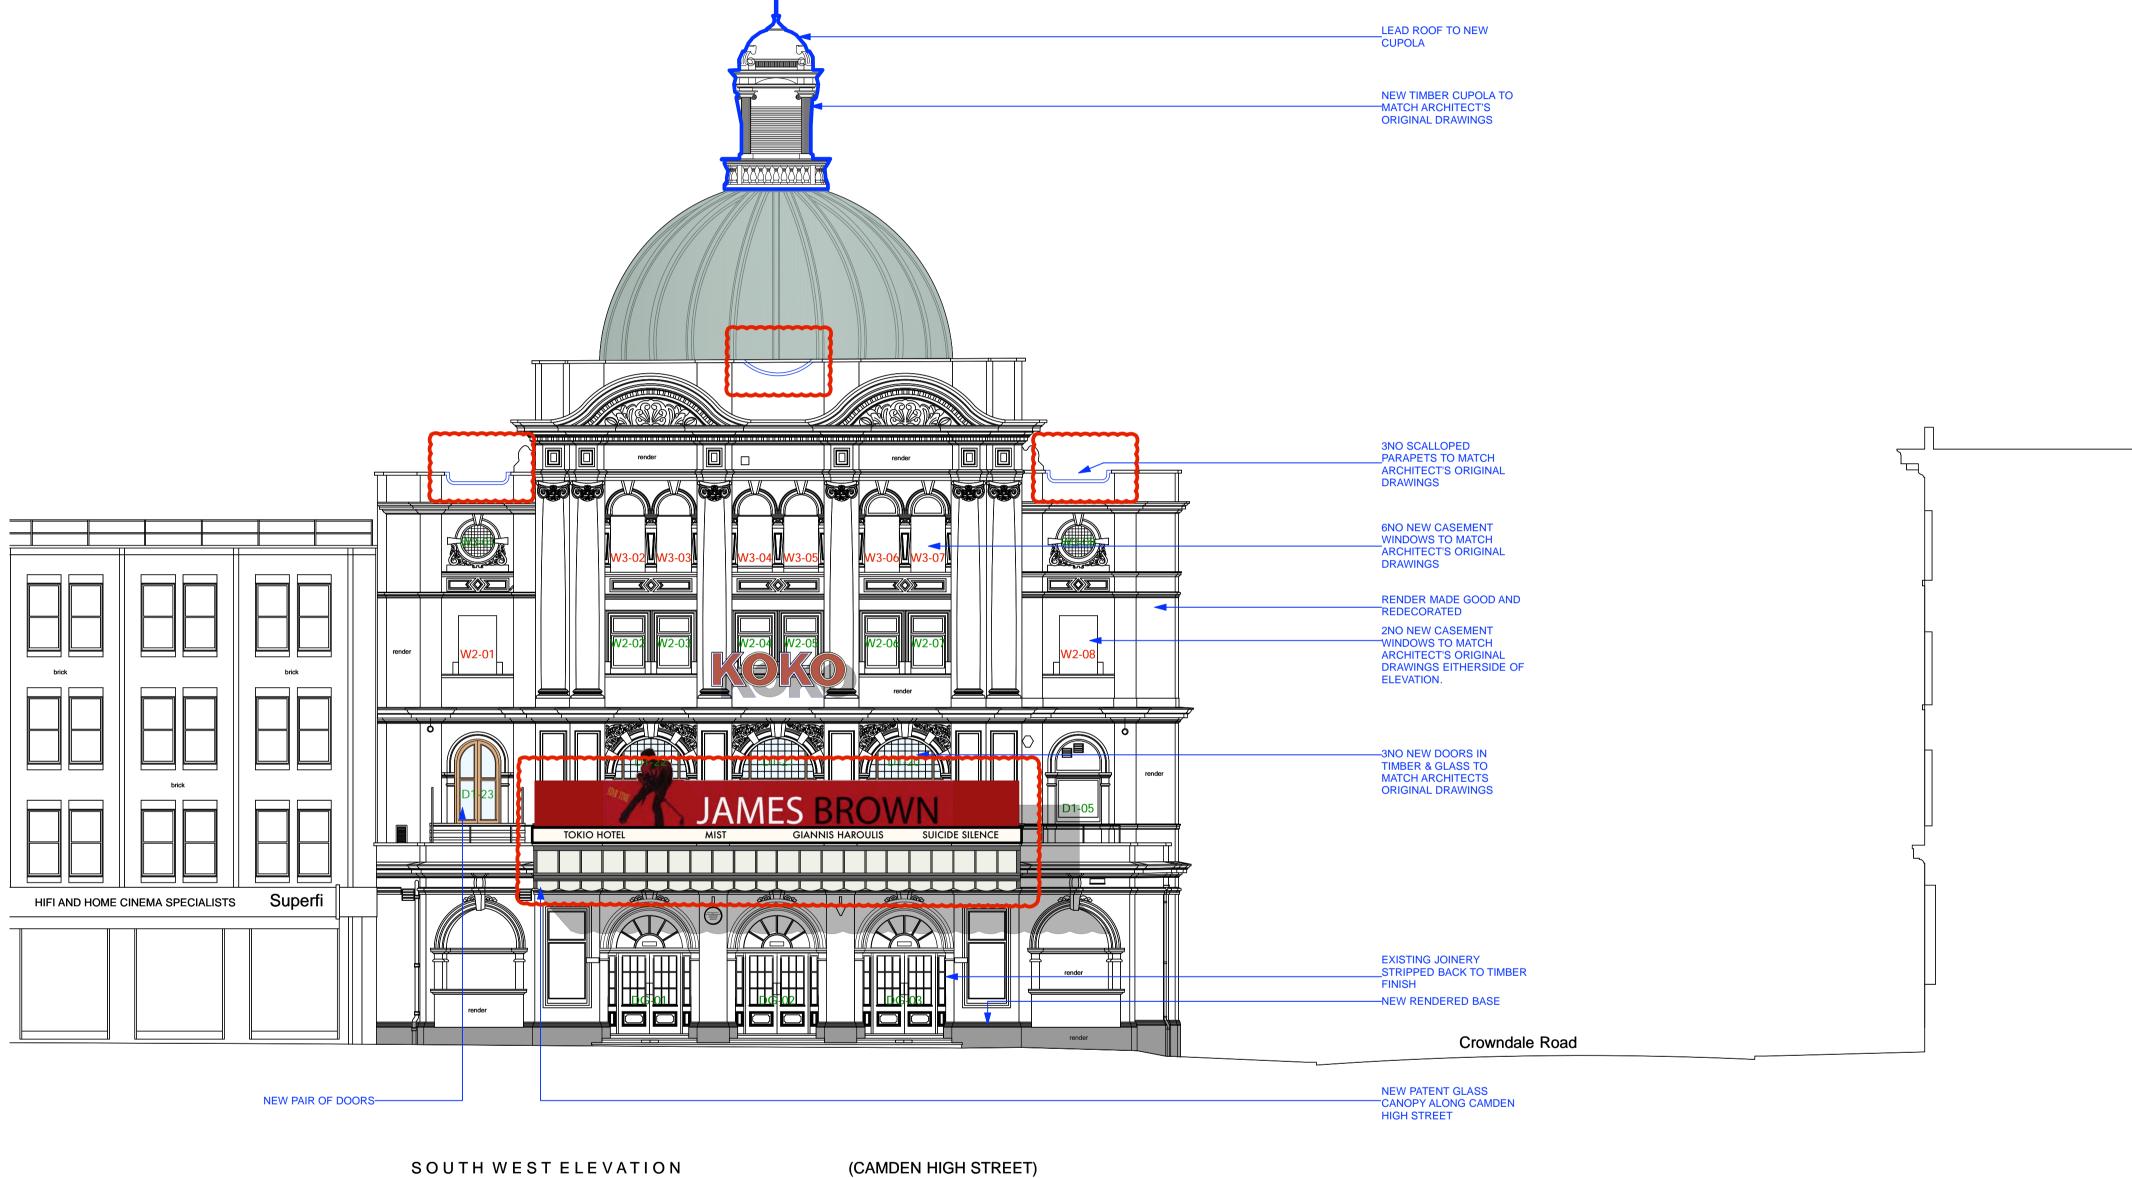

(CAMDEN HIGH STREET)

△ 20.00m A.O.D

Copyright: All rights reserved. This drawing must not be reproduced without permission.

Only the original drawing should be relied upon. Contractors, subcontractors and suppliers must verify all dimensions on site before commencing any work or making any shop drawings. All shop drawings to be submitted to the architect for comment prior to fabrication.

This drawing is to be read in conjunction with the Architect's specification, bills of quantities / schedules, structural, mechanical & electrical drawings and all discrepancies are to be reported to the architect.


Do not scale from this drawing. Dimensions are in millimetres unless otherwise stated.

revision / date / amendments - / --/-- / -



Archer Humphryes Architects

project title KOKO + Hope & Anchor + Bay Camden, London	ham I	Place
drawing title Proposed Koko Front Elevation	scale 1:100@A1	date 13.04.17
	drawn FR/PC	checked DA
drawing number	revision	
AHA/KKC/ PR /200	-	

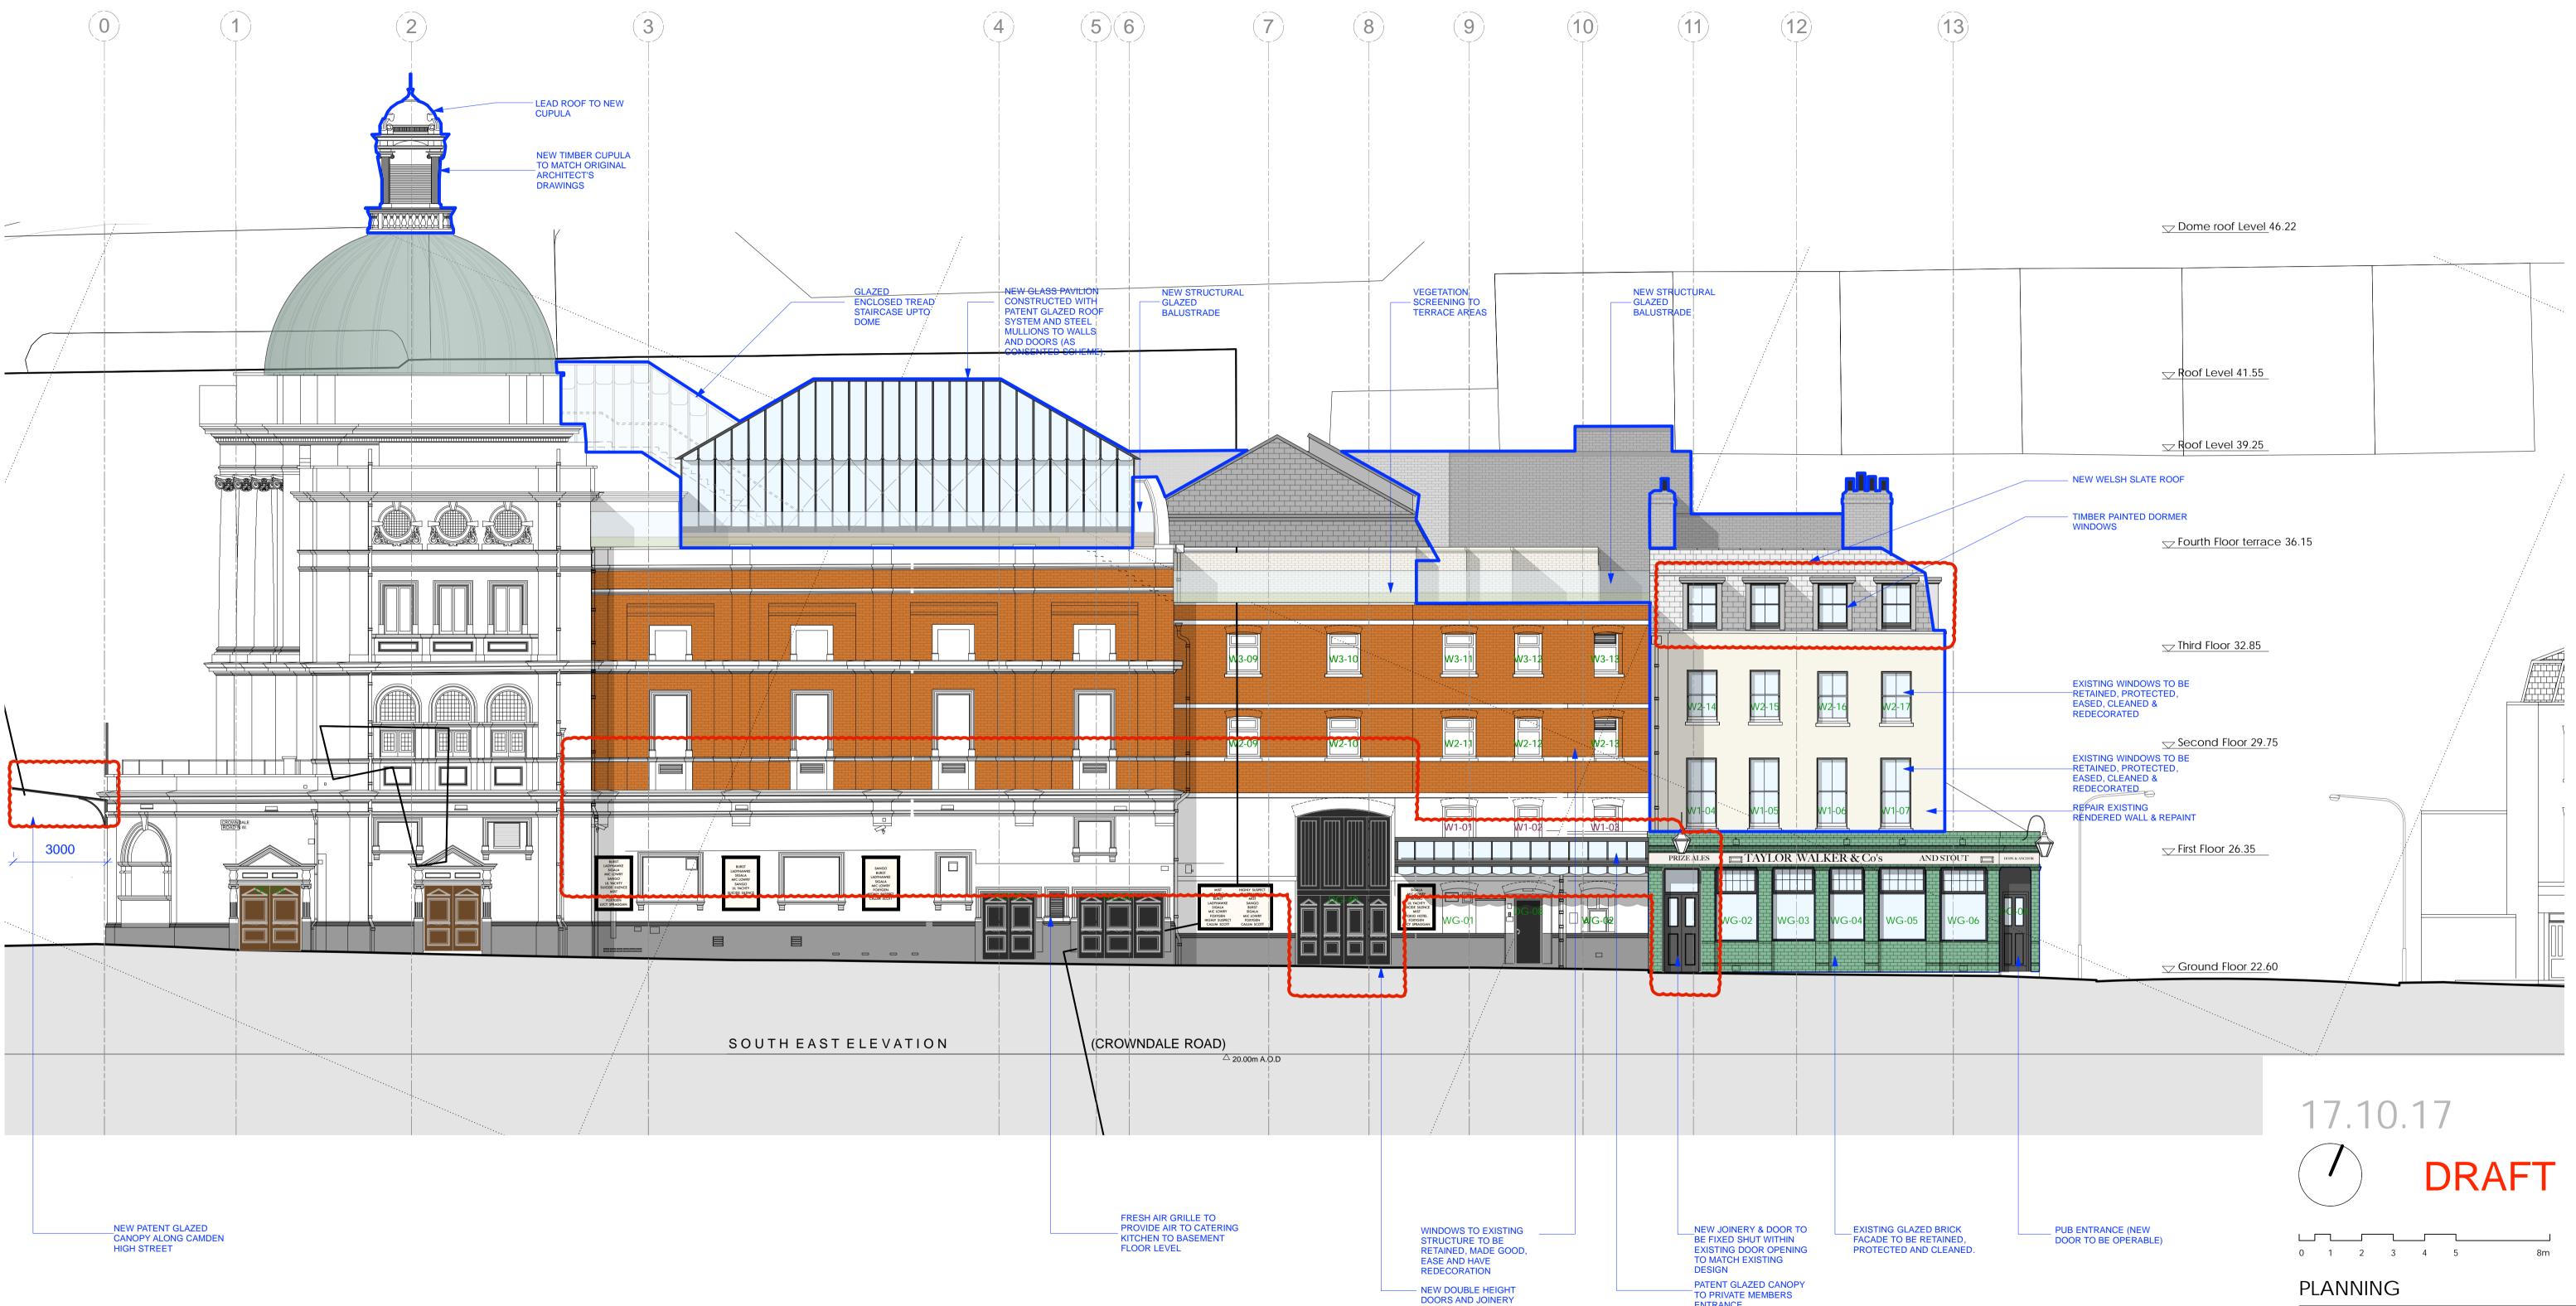

PATENT GLAZED CANOPY TO PRIVATE MEMBERS ENTRANCE

Copyright: All rights reserved. This drawing must not be reproduced without permission.

Only the original drawing should be relied upon. Contractors, subcontractors and suppliers must verify all dimensions on site before commencing any work or making any shop drawings. All shop drawings to be submitted to the architect for comment prior to fabrication.

This drawing is to be read in conjunction with the Architect's specification, bills of quantities / schedules, structural, mechanical & electrical drawings and all discrepancies are to be reported to the architect. Do not scale from this drawing. Dimensions are in millimetres unless otherwise stated.

revision / date / amendments - / --/-- / -

Archer Humphryes Architects


Basement Central House 142 Central Street London, United Kingdom

EC1V 8AR	5
Г: +44 (0) 20	7251 8555

K	oject title OKO + Hope & Anchor + Bay camden, London	ham I	Place
	wing title	scale	date
Pr	oposed Crowndale Road	1:100@A1	13.04.17
	evation		checked
Ele	evalion	EH/FR	DA
dra	wing number	revision	
A	IA/KKC/GA/201	-	

✓ Dome roof Level 46.22	
GLAZED STAIRCASE ENCLOSURE	
→ Roof Level 39.25	
✓ Fourth Floor 36.15 NEW WELSH SLATE ROOF & TIMBER PAINTED DORMER WINDOWS ORIGINAL SIGNAGE RETAINED, PROTECTED, MADE GOOD Third Floor 32.85	
REPAIR EXISTING HOPE AND ANCHOR FACADE RENDER & REPAINTED	
Ground Floor 22.60	08
<u>→ Basement Floor 19.55</u>	
	SROOT Level 41.35  Roof Level 41.35  Roof Level 39.25  Fourth Floor 36.15  Fourth Floor 36.15  Third Floor 32.85  REPARE EXISTING HOPE REVAULS PROTECTED, MADE GOOD  Third Floor 22.85  First Floor 26.35  First Floor 26.35  First Floor 26.35  First Floor 26.35  First Floor 22.60  First Floor 20.75  First Floor 20.75

PUB ENTRANCE

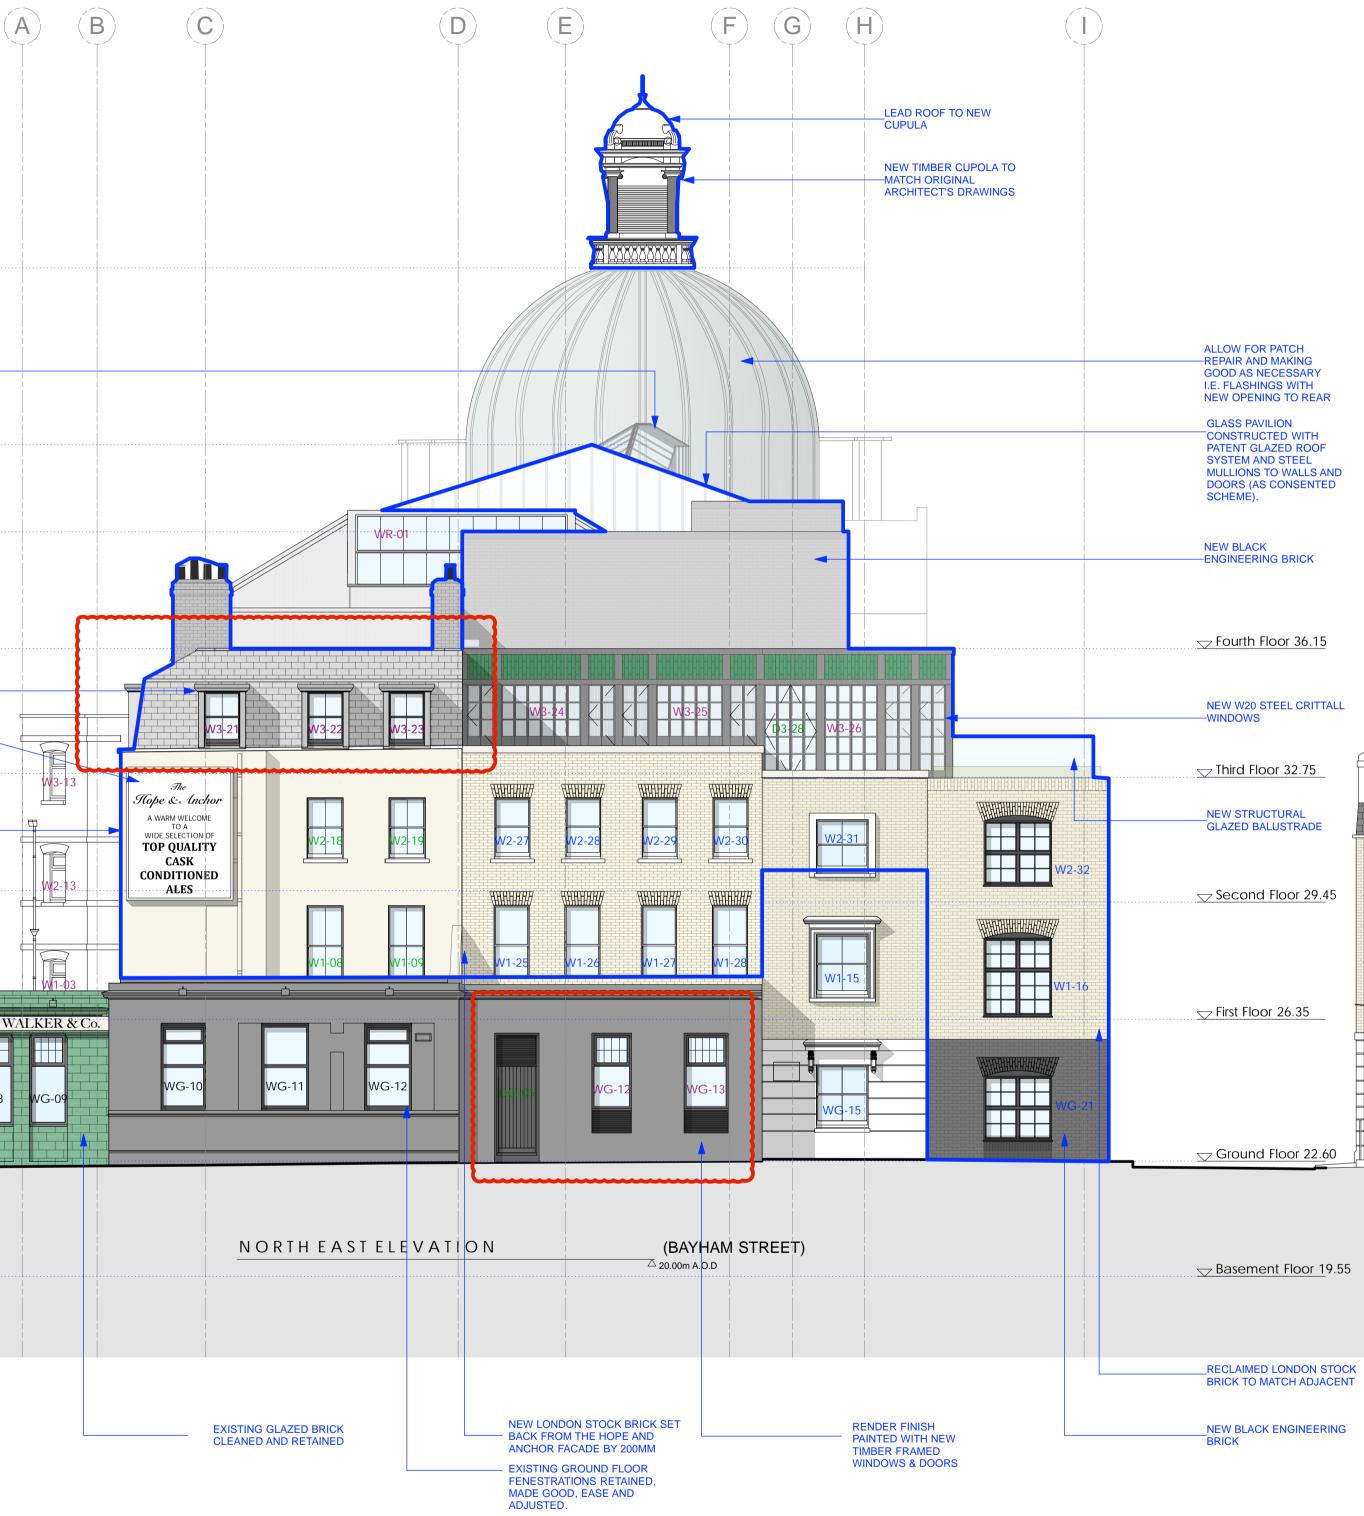

Copyright: All rights reserved. This drawing must not be reproduced without permission.

Only the original drawing should be relied upon. Contractors, subcontractors and suppliers must verify all dimensions on site before commencing any work or making any shop drawings. All shop drawings to be submitted to the architect for comment prior to fabrication.

This drawing is to be read in conjunction with the Architect's specification, bills of quantities / schedules, structural, mechanical & electrical drawings and all discrepancies are to be reported to the architect.

Do not scale from this drawing. Dimensions are in millimetres unless otherwise stated.

revision / date / amendments - / --/-- / -

urth Floor 36.15	
W20 STEEL CRITTALL OWS	
rd Floor 32.75	
STRUCTURAL ED BALUSTRADE	
<u>cond Floor 29.4</u> 5	
t Floor 26.35	
ound Floor 22.60	
	<u> </u>




### PLANNING

Archer Humphryes Architects

project title KOKO + Hope & Anchor + Bay Camden, London	ham I	Place
drawing title	scale	date
Proposed Bayham Street Elevation	1:100@A1	13.04.17
rioposod baynam otroot Elovation	drawn	checked
	FR/PC	DA
drawing number	revision	
AHA/KKC/GA/202	-	

			2	10	9	8
¬ Roof Level 41.55		NEW BLACK ENGINEERING BRICK				
─ Fourth Floor Terrace 36.15						
$\sim$ Third Floor Terrace 32.75	NEW W20 STEEL CRITTALL WINDOWS NEW STRUCTURAL GLAZED BALUSTRADE					
<sup>△</sup> Third Floor 32.55						
Second Floor 29.45						
─ First Floor 26.35						
					Dry Riser Intet	
∽ Ground Floor 22.60						
→ Basement Floor 19.55						
	RECLAIMED LONDON STOCK BRICK TO MATCH ADJACENT NEW BLACK ENGINEERING BRICK					

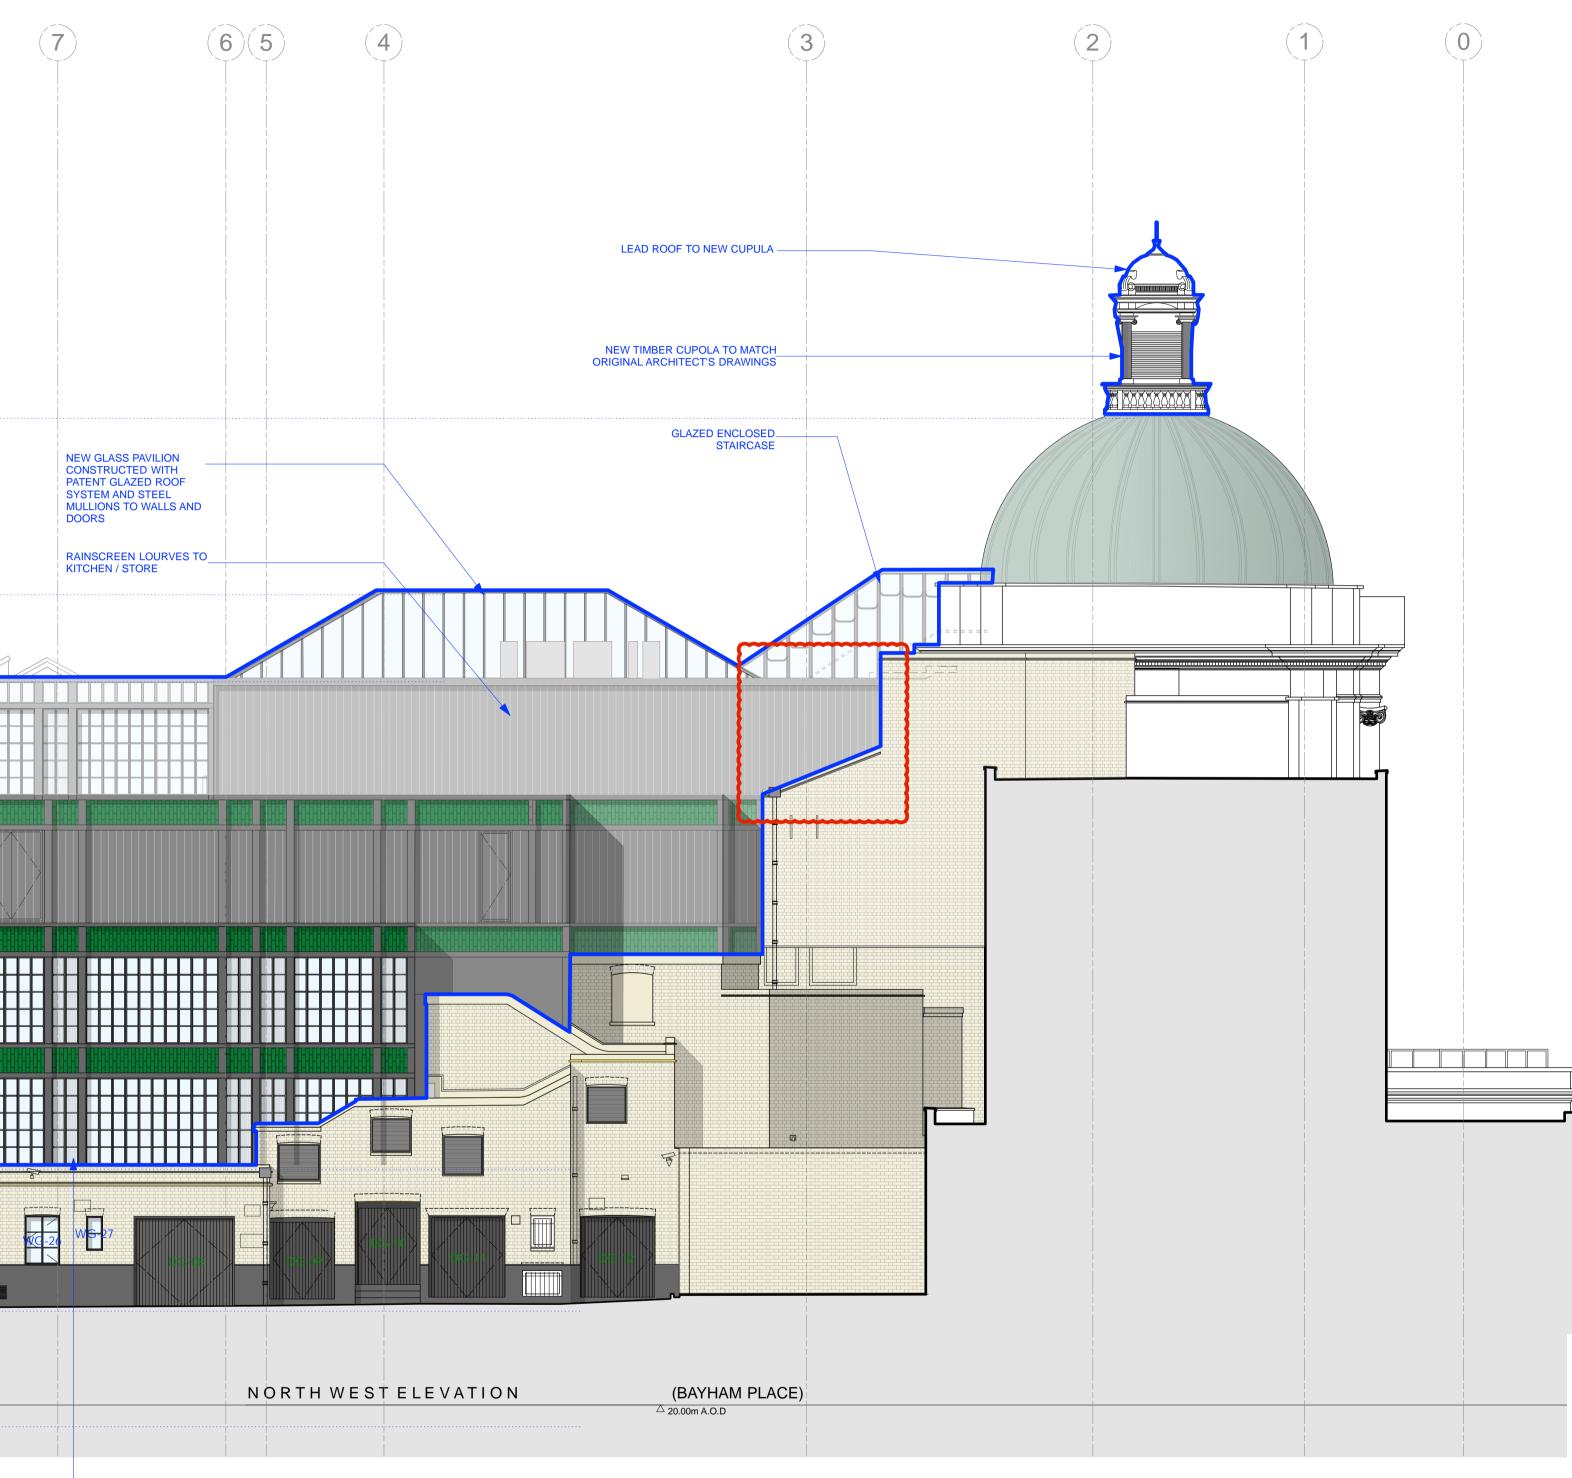

- RIBBED GLASS EXISTING WALL RENDERED AND —PAINTED TO UNDERSIDE OF EXISTING SILLS

DRY RISER INLET

Copyright: All rights reserved. This drawing must not be reproduced without permission.

Only the original drawing should be relied upon. Contractors, subcontractors and suppliers must verify all dimensions on site before commencing any work or making any shop drawings. All shop drawings to be submitted to the architect for comment prior to fabrication.

This drawing is to be read in conjunction with the Architect's specification, bills of quantities / schedules, structural, mechanical & electrical drawings and all discrepancies are to be reported to the architect.

Do not scale from this drawing. Dimensions are in millimetres unless otherwise stated.


revision / date / amendments - / --/-- / -

# 17.10.17 7 DRAFT

0 1 2 3 4 5 8m PLANNING

Archer Humphryes Architects

<sup>project title</sup> KOKO + Hope & Anchor + Bay Camden, London	ham I	Place
drawing title Proposed Bayham Place Elevation	scale 1:100@A1 drawn	date 13.04.17 checked
	FR/PC	DA
drawing number	revision	
AHA/KKC/GA/203	-	

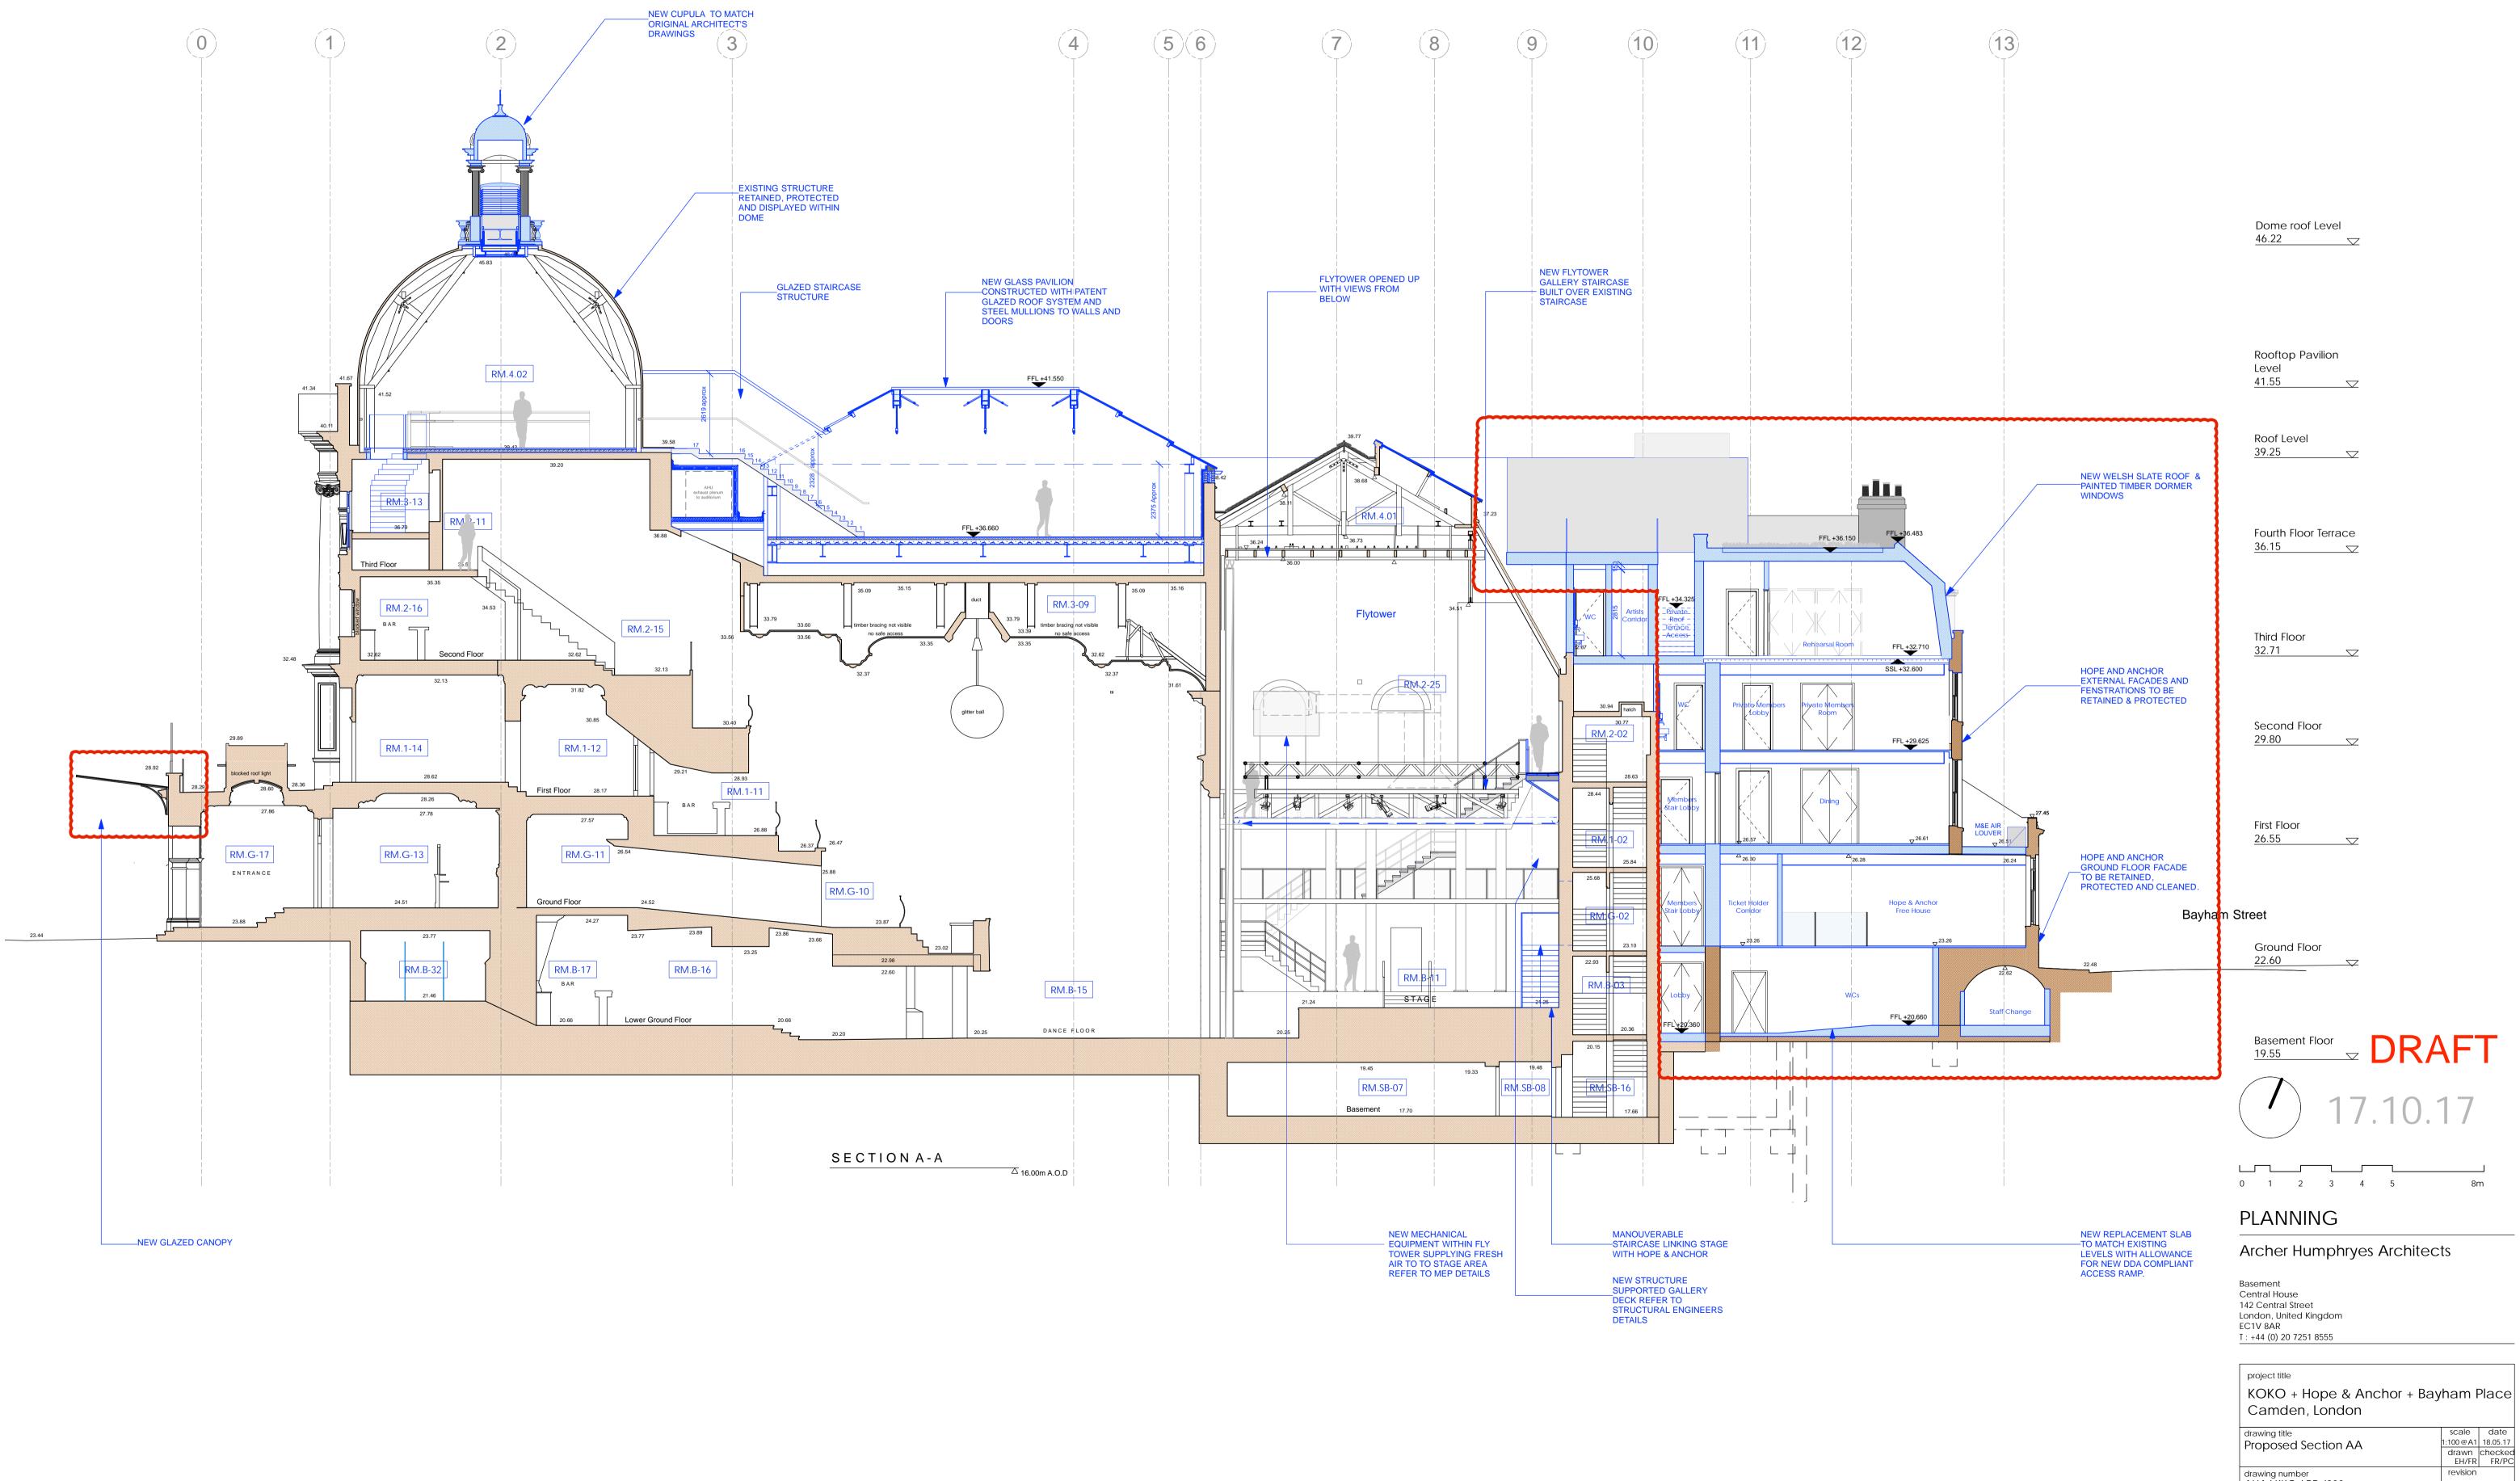

Copyright: All rights reserved. This drawing must not be reproduced without permission.

Only the original drawing should be relied upon. Contractors, subcontractors and suppliers must verify all dimensions on site before commencing any work or making any shop drawings. All shop drawings to be submitted to the architect for comment prior to fabrication.

This drawing is to be read in conjunction with the Architect's specification, bills of quantities / schedules, structural, mechanical & electrical drawings and all discrepancies are to be reported to the architect. Do not scale from this drawing. Dimensions are in millimetres unless otherwise stated.

revision / date / amendments - / --/-- / -

drawing number AHA/ KKC / PR /300