

THIS IS AN A1 DRAWING. IF REPRODUCED IN ANY OTHER FORMAT THE SCALE SHOWN WILL BE INCORRECT. DO NOT SCALE OFF THIS DRAWING. ANY AMBIGUITIES, OMISSIONS AND ERRORS, OR INCONSISTENCIES WITH OTHER DOCUMENTS, ON THIS DRAWING SHOULD BE NOTIFIED IMMEDIATELY TO THE ARCHITECT BEFORE THE COMMENCEMENT OF WORKS

ALL DIMENSIONS ARE IN MILLIMETRES

UNLESS OTHERWISE STATED. ALL DIMENSIONS, UNLESS OTHERWISE STATED, ARE TO THE FACE OF UNFINISHED MASONRY WALLS OR TO THE FINISHED

PLASTER FACE OF STUD PARTITIONS. ALL DIMENSIONS ARE TO BE CHECKED ON SITE. ANY DISCREPANCIES ARE TO BE NOTIFIED IMMEDIATELY TO THE ARCHITECT


BEFORE THE COMMENCEMENT OF WORKS

ALL LEVELS ARE IN METRES UNLESS

OTHERWISE STATED. THIS DRAWING IS TO BE READ IN CONJUNCTION WITH ALL OTHER RELEVANT DRAWINGS AND SPECIFICATIONS FOR THIS PROJECT AND APPARENT INCONSISTENCIES BROUGHT TO THE ATTENTION OF THE

ARCHITECT.

- Treads generally varied heights and require regularizing
- Replacement and reinforcement of all treads heights required
- New feature handrail to installed at wall location 1100mm at landings 900mm from pitch. Sample required to be submitted and signed off by the conservation officer prior to installation.
- Existing Dado handrail to be carefully removed.

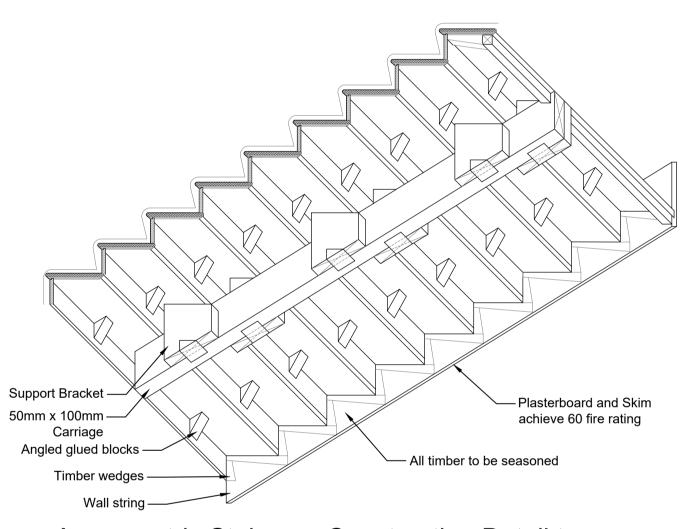


Ref: DRW022 Ver: 1 ISD: 01/10/15

and repairs to timber staircase

Scale 1:10 @ A1

Axonometric Staircase Construction Detail to Underside of Stairs - Where Located over Stores Scale 1:20 @ A1

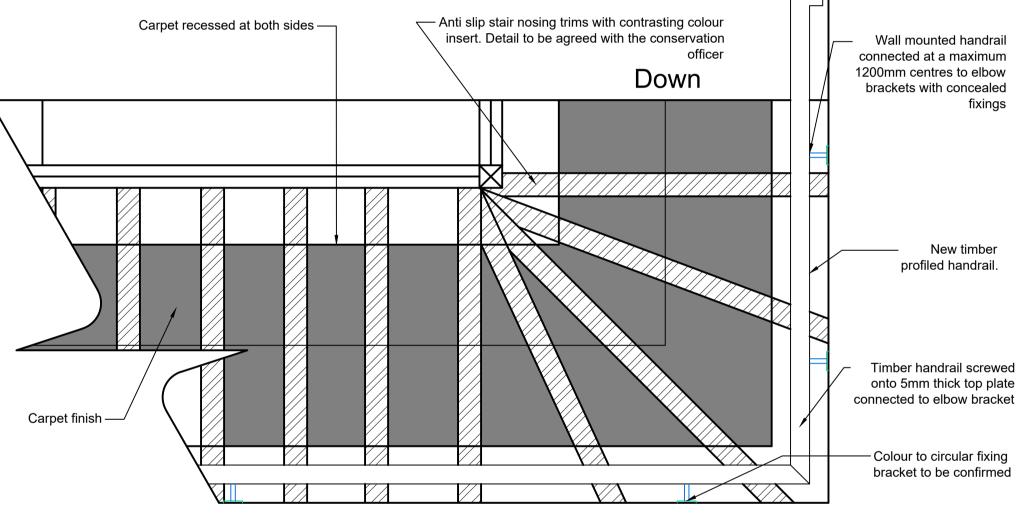

stall new timber glue blocks.

Positioned in each corner and

screwed into place. All screw

fixings to be countersunk

Plasterboard and skim

to achieve 60 minute

Install new timber glued

50mm x 100mm Timber

carriage located to stairs

tread & riser blocks

with stores under

Proposed Typical Timber Stair


Reinforcement

Scale 1:10 @ A1


- Anti slip stair nosing trims with contrasting colour insert installed to treads. Detail
- to be agreed by conservation officer - Install combination of timber blocks, tread & riser wedges to provide additional
- support to loose treads New timber profiled handrail installed




Site Plan Scale 1:500 @ A1

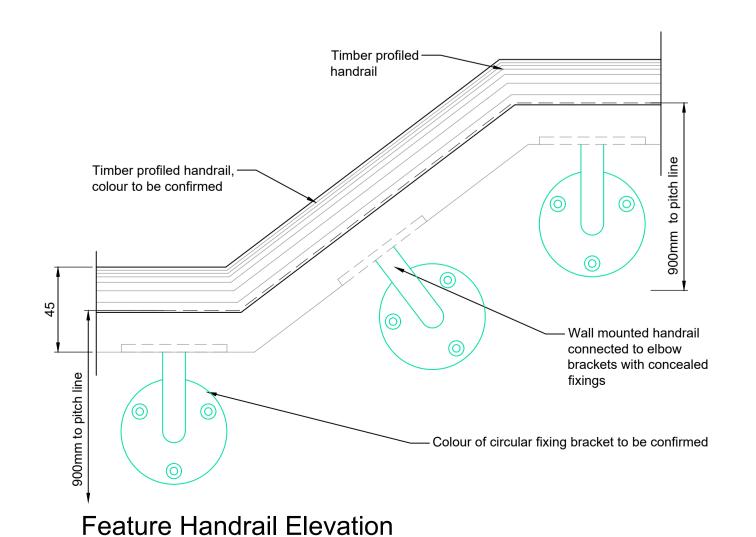

@ Basement to Ground Floor Stairs Scale 1:2 @ A1

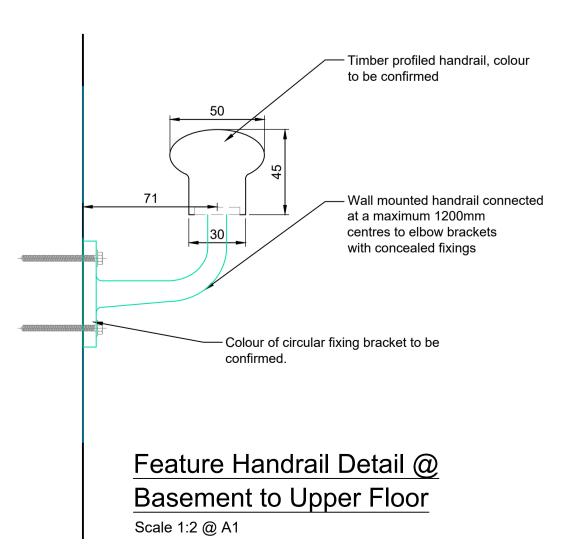

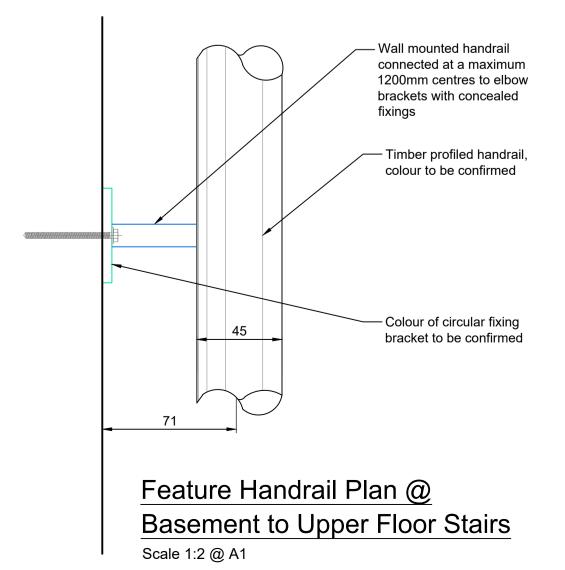

P01 05.09.17 PLANNING ISSUE By Ckd 44 The Ropewalk Nottingham NG1 5DW t: 0115 9481144 f: 0115 9580976 w: cbp-arch.co.uk **Project** GOODENOUGH CLUB STAIRS **Drawing Title**

05.09.17 Scale As indicated Date PB Checked Drawing number Revision

HOUSE 23 - PROPOSED WORKS

16010-A-0008 P01

Reproduction subject to copyright Original sheet size A1