45-46 RED LION STREET

Document containing information for the approval of details reserved by a condition





2017/1783/P Planning condition 3

"Detailed drawings, or samples of materials as appropriate, in respect of the following, shall be submitted to and approved in writing by the local planning authority before the relevant part of the work is begun:


Manufacturer's specification details of facing materials to the proposed 3rd floor rear extension (to be submitted to the Local Planning Authority) and samples of those materials (to be provided on site)."

2017/1941/L Listed Building Consent conditions 4(a)

"a) Manufacturer's specification details of facing materials to the proposed 3rd floor rear extension (to be submitted to the Local Planning Authority) and samples of those materials (to be provided on site)"

2017/1941/L Listed Building Consent conditions 4(b)

"b) Details of service runs for all new bathrooms/ kitchens, demonstrating the relationship of new pipework with the structure of the building. Specification Manufacturer's specification details of facing materials to the proposed 3rd floor rear extension: VMZINC Traditional ventilated standing seam cladding Finish: Natural light-grey Quartz-Zinc Photo of material sample **QUARTZ-ZINC VMZINC** Reference project De Vere Gardens by David Chipperfield Architects

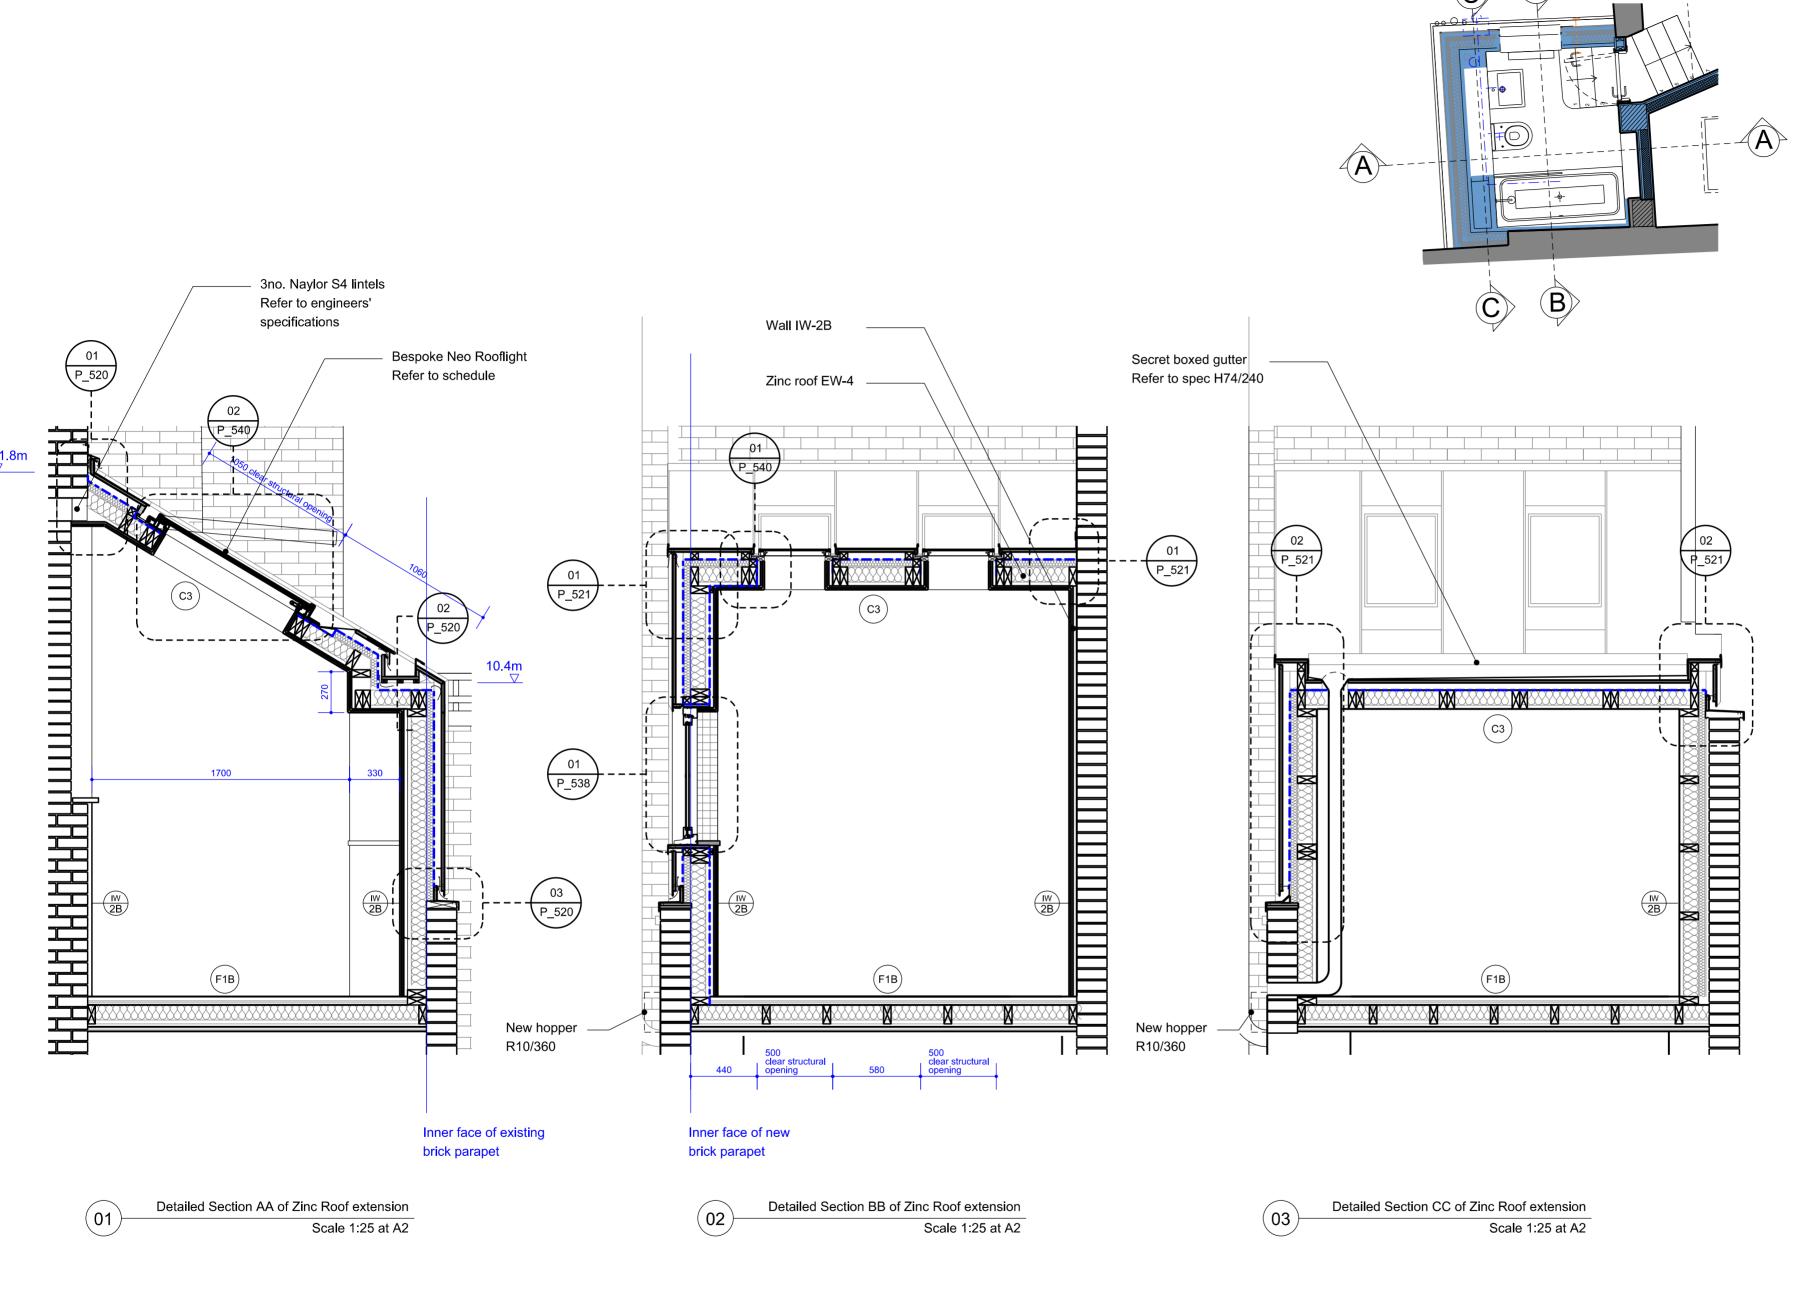

General notes: Do not scale from drawings. Errors to be reported immediately to the Architect. To be read in conjuntion with all relevant Architects', Services and Structural Engineers' drawings. All existing site, tree and building information has been compiled from different sources. All dimensions to be checked on site. FFL and FCL refers to finished floor and ceiling levels. Within apartments these are indicative only and based on a nominal increased build up of floors Existing building fabric: Where assumptions have been made as to the existing building fabric to be retained, these to be confirmed by the contractor on site in order to ascertain if these will alter the anticipated acoustic and fire separation Refer to spec P12/130 for all firestopping to service and building penetrations Refer to Anderson Acoustic report for acoustic separation requirements T01 18/08/17 Tender Rev. Date Description Drawn Check

EMIL EVE ARCHITECTS

60a Windus Road London N16 6UP T 07805662839 E info@emileve.co.uk www.emileve.co.uk

Project

Project number 030

45-46 Red Lion Street

Client

Glasshouse Limited

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Drawing name

Roof Extension to n.46
Proposed - Section details

CAD Reference

030_P_475

 Date
 June 2017

 Scale / Format
 1:25@A2/1:50@A4


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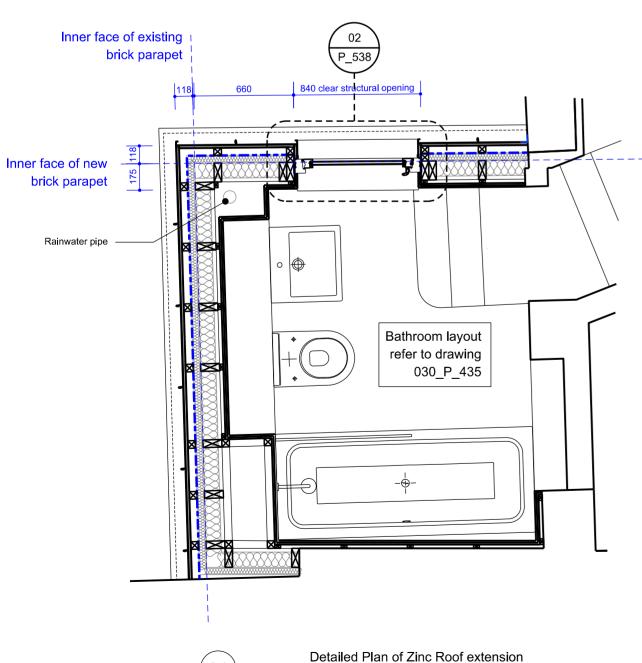
 Approved
 EEA

T01 Tender

Issue


Drawing number




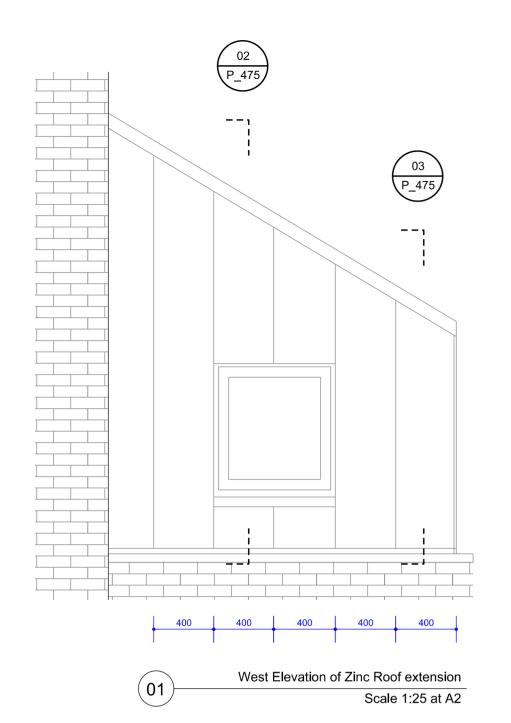


Scale 1:25 at A2

(04)

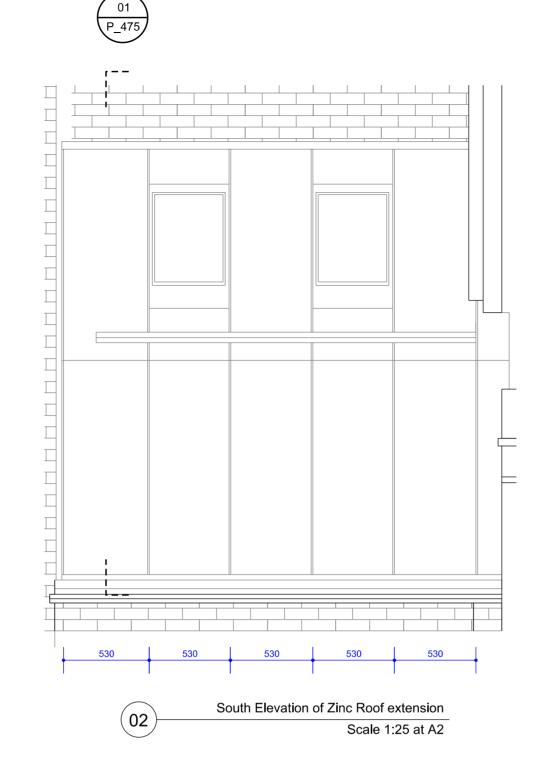

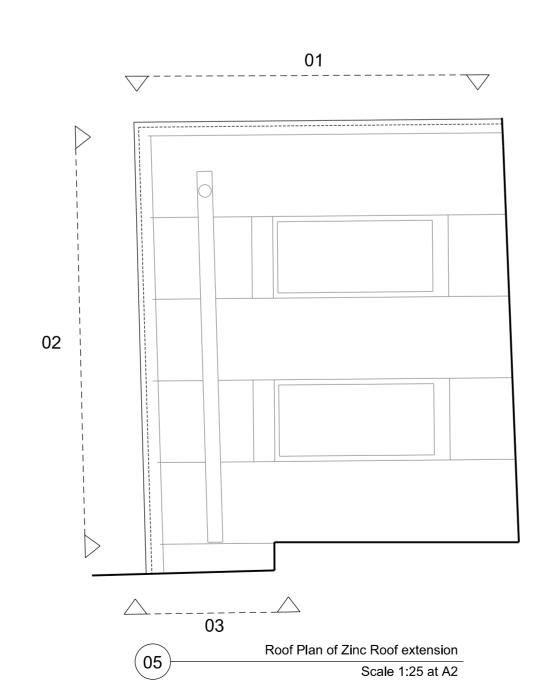

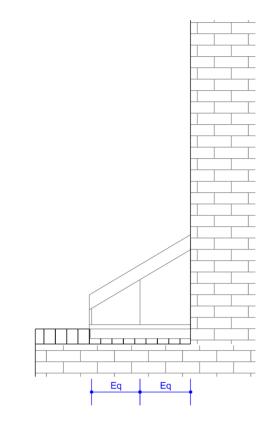

East Elevation of Zinc Roof extension (03) Scale 1:25 at A2


General notes: Do not scale from drawings. Errors to be reported immediately to the Architect. To be read in conjuntion with all relevant Architects', Services and Structural Engineers' drawings. All existing site, tree and building information has been compiled from different sources. All dimensions to be checked on site. FFL and FCL refers to finished floor and ceiling levels. Within apartments building fabric to be retained, these to be confirmed by the contractor on site in

these are indicative only and based on a nominal increased build up of floors Existing building fabric: Where assumptions have been made as to the existing

order to ascertain if these will alter the anticipated acoustic and fire separation Refer to spec P12/130 for all firestopping to service and building penetrations

Refer to Anderson Acoustic report for acoustic separation requirements

T01 18/08/17 Tender Rev. Date Description Drawn Check

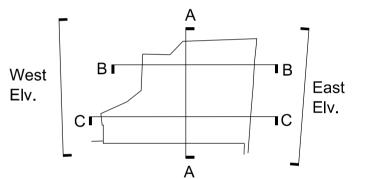



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45-46 Red Lion Street

030

Project number

Client

CAD Reference

Glasshouse Limited

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Drawing number Drawing name

Roof Extension to n.46 030_P_476 Proposed - Plan detail

June 2017 Issue 1:25@A2/1:50@A4 T01 Scale / Format Drawn / Checked EEA Tender EEA

EXTERNAL WALLS AND ROOFS


Ref: EW-1


Decription: Sand-blast and re-point Typical location: Rear facades Nominal thickness N/A U-Value required:


(Left to right)

- Existing masonry

- Remove existing render with hammer and chisel (do not use power tools which could damge the bricks) (C41/126)
- Cut out pointing and re-point walls flush with hydraulic lime
- (Note: Architect to assess the state of walls during/following removal of render and advise how to proceed)

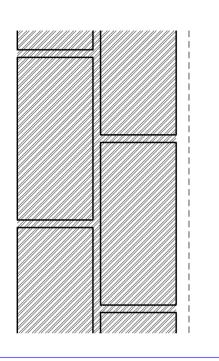

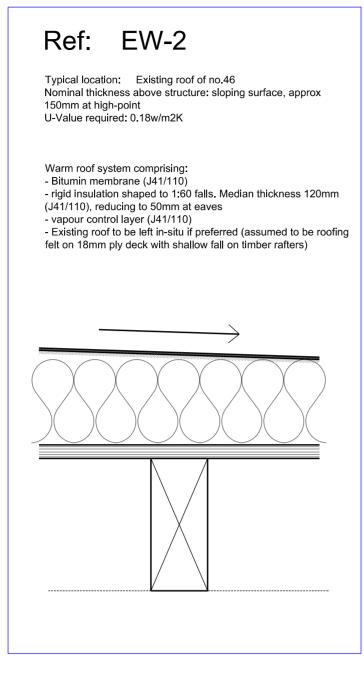

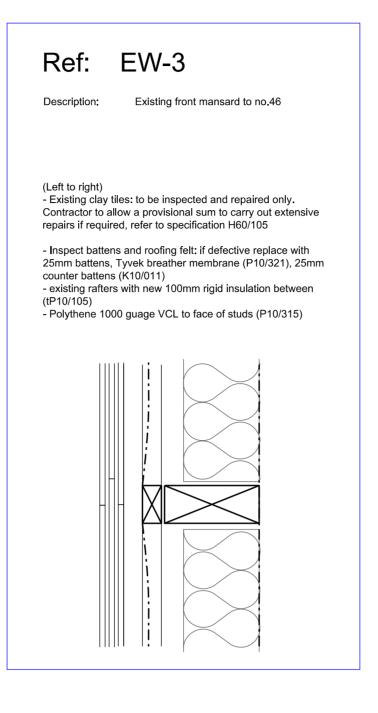

Ref: EW-4


Zinc clad timber wall/roof Description: Typical location: New top floor Nominal build-up: 245mm


U-Value required:

(Left to right) - Standing seam zinc on proprietary fixing clips (H74/130)

0.18w/m2K

- 18mm WBP plywood (K10/101)
- 50mm battened out ventilated cavity (K10/011)
- Breather membrane (P10/320)
- 50mm rigid insulation outside studs (P10/103)
- 125mm studs with 75mm rigid insulation between (P10/102)
- Polythene 1000 guage VCL to face of studs (P10/315)

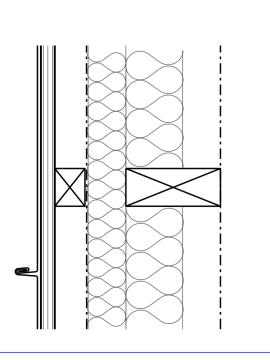

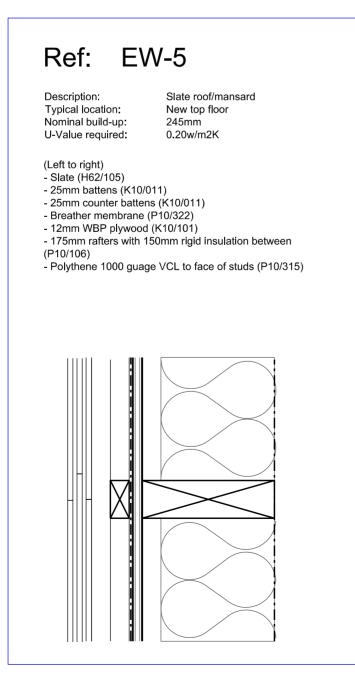

EW-6 Ref: Lead clad timber dormer Description: Typical location: New top floor Nominal build-up: 195mm U-Value required: 0.27w/m2K (Left to right) - Lead sheet (H71/150) - 18mm WBP plywood (K10/101) - 50mm battened out ventilated cavity (K10/011) - Breather membrane (P10/320) - 125mm rafters with 100mm rigid insulation between - Polythene 1000 guage VCL to face of studs (P10/315)

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45-46 Red Lion Street

030

Drawing name

CAD Reference


Glasshouse Limited

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Drawing number

Typical external walls and roofs 030_P_502 Proposed

June 2017 Issue 1:5@A2/1:10@A4 T01 Scale / Format EEA Tender EEA

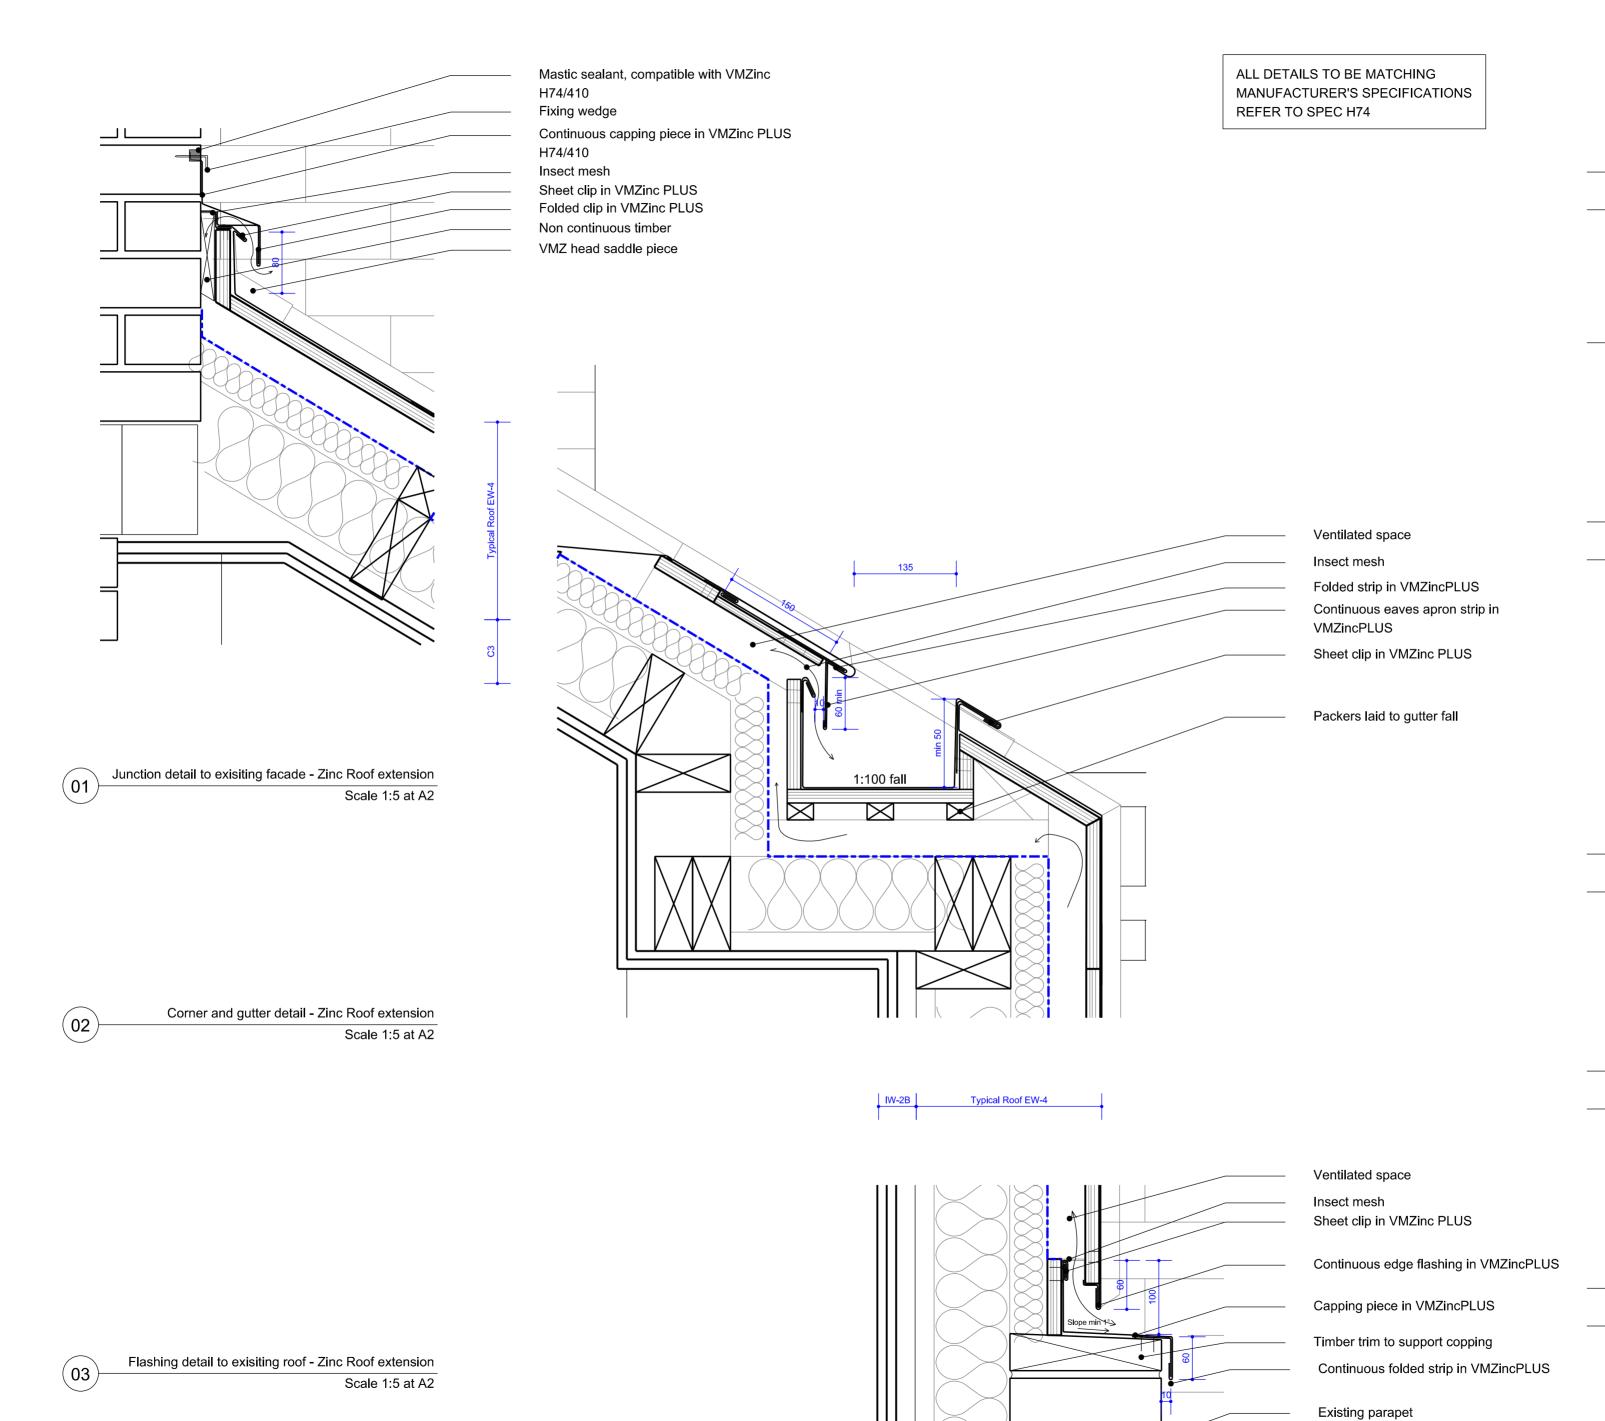

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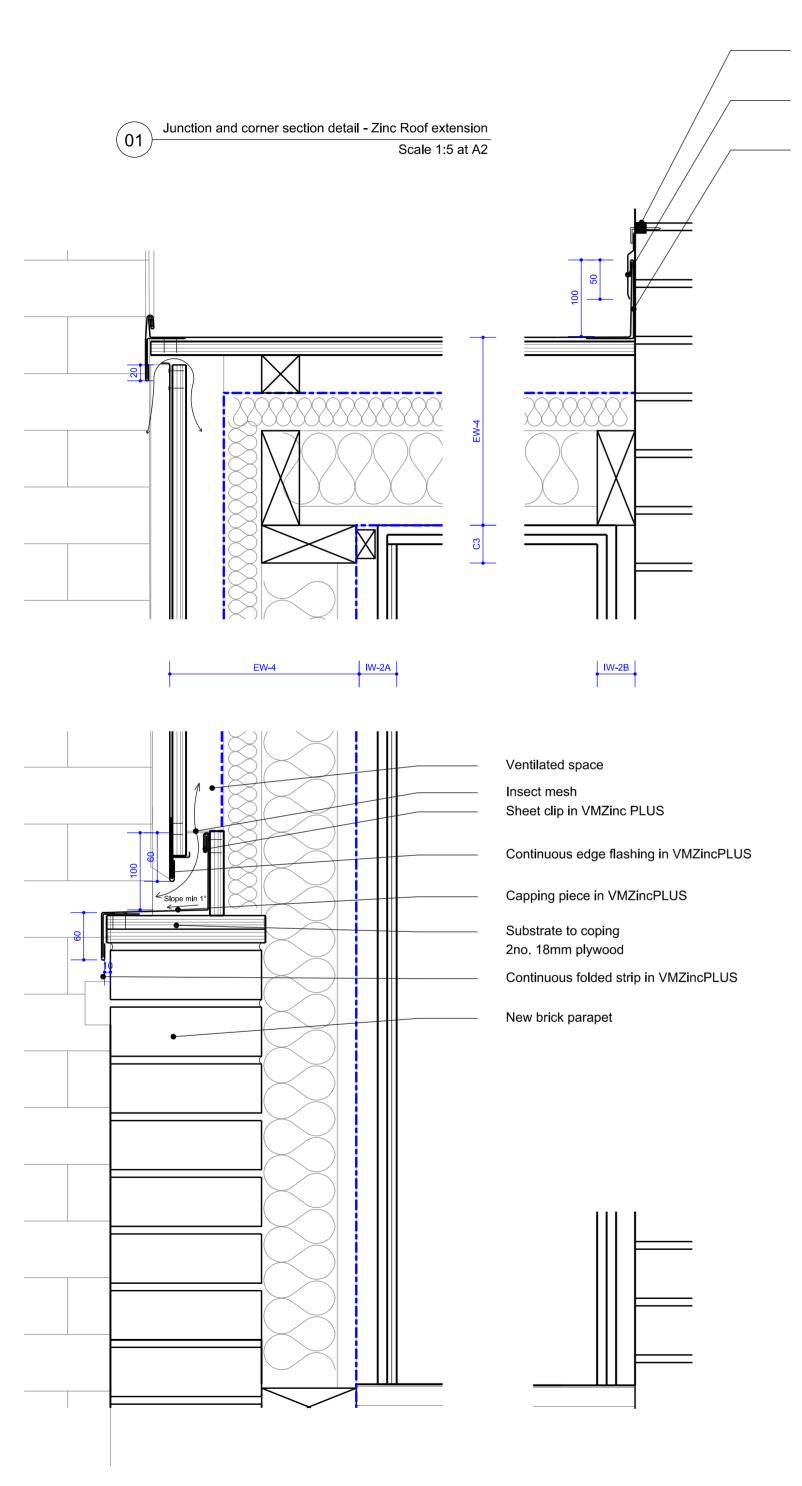
EEA

EEA

Drawn / Checked

CAD Reference

Tender



Mastic sealant compatible with VMZincPLUS VMZincPLUS stepped flashings chased into the wall Sheet clip in VMZinc PLUS Flashing in VMZinc PLUS Folded strip in VMZinc PLUS Packers laid to gutter fall min. 1 to 100 Outlet in VMZinc PLUS Leaf guard Capping piece in VMZincPLUS Continuous folded strip in VMZincPLUS Gutter section detail - Zinc Roof extension (02) Scale 1:5 at A2

General notes: Do not scale from drawings. Errors to be reported immediately to the Architect. To be read in conjuntion with all relevant Architects', Services and Structural Engineers' drawings. All existing site, tree and building information has been compiled from different sources. All dimensions to be checked on site. FFL and FCL refers to finished floor and ceiling levels. Within apartments these are indicative only and based on a nominal increased build up of floors Existing building fabric: Where assumptions have been made as to the existing building fabric to be retained, these to be confirmed by the contractor on site in order to ascertain if these will alter the anticipated acoustic and fire separation Refer to spec P12/130 for all firestopping to service and building penetrations Refer to Anderson Acoustic report for acoustic separation requirements T01 18/08/17 Tender Rev. Date Description Drawn Check

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45-46 Red Lion Street

030

Project number

Client

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Drawing name

Roof Extension n.46 Section Details

CAD Reference

030_P_521

Drawing number

Issue

T01

June 2017

1:5@A2/1:10@A4 Scale / Format Drawn / Checked EEA Tender EEA

ALL DETAILS TO BE MATCHING MANUFACTURER'S SPECIFICATIONS REFER TO SPEC H74

EMIL EVE ARCHITECTS RED LION STREET H74 REV T01 18/08/17

H74 ZINC STRIP/ SHEET COVERINGS/ FLASHINGS

To be read with Preliminaries/ General conditions.

TYPES OF ZINC WORK

130 STANDING SEAM ZINC CLADDING – to walls and roof of rear outrigger extension –

Wall/roof type, refer to: 030_P_502 EW-4

Details, refer to: 030_P_475/030_P_476/030_P_520/030_P_521

Warrenty: Required

- Cladding system: VMZINC Single lock standing seam cladding (horizontal or vertical) for vertical walls and soffits.
- Substrate: Exterior grade 18mm plywood (EN314-3 & EN636-2). The plywood deck must be even and flush with all joints being less than 2mm in height. Nails should be driven into the plywood so as to avoid abrasive contact with the underside of the zinc cladding sheets. Ensure that any treatment which the plywood may have received (fungicides or insecticides) is compatible with the zinc cladding sheets. A continuous airspace of at least 50mm must be allowed for between the plywood and insulation (which can be protected by the VMZINC membrane). refer to: 030_P_502 EW-4
- Underlay: No underlay is required but a VMZINC membrane can be installed over the plywood.
- Vapour control layer as per requirements, refer to: 030_P_502 EW-4
- Insulation as per requirements protected with VMZINC membrane, refer to: 030_P_502 EW-
- Zinc: As clause 520.
 - Finish: QUARTZ ZINC
- Thickness: 0.8mm.
- Longitudinal joints: 25mm high single lock standing seam.
 - Spacing: REFER TO DRAWINGS. Not more than 530mm in accordance with design and wind loadings.
- Cross joints: Single welts, in accordance with manufacturer's recommendations.
 - Spacing, panels to be no longer than 4m.
- Vented apron detail: As clause 345.
- Vented ridge detail: As clause 470.

Overall Cladding system to have a BRE Green Guide rating of at least A with no more than
 0.64 BRE ecopoints (measured over 60 years for 1m2).

240 RECESSED VALLEY GUTTER LINING – refer to drawings 030_P_520/030_P_521

- Zinc: Boxed gutter in VMZinc PLUS

Width: REFER TO DRAWINGS (<600mm). Minimum fall of 1 in 100 with overflows.

- Substrate: 18mm Plywood

- Underlay: Sheet clip in VMZinc PLUS th=0.7mm min, w=80mm, 2 per m

- Finish: VMZINC PLUS in QUARTZ ZINC

- Thickness: 0.8mm

- Joints: Soldered joints with neoprene at 6m intervals.

- Joint with roof covering:

folded strip in VMZincPLUS 0.7mm, continuous

Continuous eaves apron strip in VMZincPLUS

- Continuous drip 10mm linear vent opening including insect mesh.

340 VENTED BASE DETAIL

- Eaves zinc: As clause 520.

- Finish: QUARTZ ZINC

- Thickness: 0.8mm.

Joints: Spacing: 2m.

- Continuous drip 10mm linear vent opening

345 VENTED STANDING SEAM EAVES

- Minimum 10mm air inlet

- Eaves zinc: As clause 520.

- Finish: VMZINC PLUS in QUARTZ-ZINC

- Thickness: 0.7mm or 0.8mm.

- Joints: Spacing: 2m

- Eaves Strip:

- T plate in zinc or galvanized steel.

- Continuous G3 eaves strip with hem in zinc available in QUARTZ ZINC PLUS

370 STANDING SEAM VERGE

- Ridge: As clause 520.

- Finish: VMZINC PLUS in QUARTZ ZINC

- Thickness: 0.7mm or 0.8mm

- Joints: Spacing: 2m.
- Top edge:
 - Standing seam longitudinal joint: Position flush with verge.
 - Forming: Secure top of verge into double welt and clips of standing seam.
- Bottom edge:
 - Continuous clip: Fix at 200mm centres.
- 410 ABUTMENT FLASHING / hip detail with minimum 10mm air inlet
- Ridge: As clause 520.
 - Finish: VMZINC PLUS QUARTZ
 - Thickness: 0.8mm.
- Joints: Spacing: 2m.
- Ridge Cap:
 - Held in place with stainless steel clips attached to the zinc standing seam.
 - Continuous G3 ridges strip zinc in QUARTZ ZINC fixed with stainless steel clip and decompression strip G3.

GENERAL REQUIREMENTS/ PREPARATORY WORK

510 WORKMANSHIP GENERALLY

- Standard: Generally to CP 143-5.
- Fabrication and fixing: To provide a secure, free draining and completely weather tight installation.
- Operatives: Trained in the application of zinc coverings/flashings by participation in a Pro-Zinc training course. Submit records of experience on request. VMZINC at Work installers offer evidence of successfully completed projects, records of VMZINC training and extended material warranties.
- · Measuring, marking, cutting and forming: Prior to assembly wherever possible.
- Metal temperature: Do not form zinc when the metal temperature is below 7°C
- Marking out: With pencil, chalk or crayon. Do not use scribers or other sharp instruments without approval.
- Folding: With mechanical or manual presses to give straight, regular and tight bends, leaving panels free from ripples, kinks, buckling and cracks. Use hand tools only for folding details that cannot be pressed. The minimum bending radius is thickness x 2 (x 3 for Pigmento).

- · Sharp metal edges: Fold under or remove as work proceeds.
- · Sealants: Do not use in joints to attain waterproofing.
- · Solder: Use only where specified.
- Finished zinc work: Fully supported, adequately fixed to resist wind uplift and able to accommodate thermal movement without distortion or stress.
- Protection: Prevent staining, discolouration and damage by subsequent works. All
 instructions and recommendations contained in the guidelines for design and
 specification and VMZ General Technical Recommendation of VMZINC standing seam
 facades to be applied. Plastic film must be removed within 2 months of installation and
 in such a way so as not to trap water between the partially removed film and the zinc.

520 ZINC STRIP/SHEET

- Zinc-titanium-copper alloy:
 - To BS EN 501 and BS EN 988.
 - Zinc manufactured following ISO 14001 (environmental management), ISO 9001 (quality management) and ISO 18001 safety management.
 - Stamped or labelled with type, finish and thickness.
 - Zinc to be coated on underside with a protective 60 micron lacquer.
 - Manufacturer:
 - VMZINC Collier House Mead Lane Hertford Herts SG13 7AX

Tel: 01992 822 288 Fax: 01992 584 460 Email: vmzinc.uk@vmzinc.com Web:

www.vmzinc.co.uk

- Product reference: QUARTZ-ZINC

535 INTEGRITY OF ZINC

- Requirement: Design coverings/flashings and methods of attachment to prevent loss of weather tightness and permanent deformation due to wind pressure or suction.
- Wind loads: Calculate to BS 6399-2.

555 LAYOUT

Setting out of longitudinal and cross joints: refer to drawings. No cross joints acceptable.

610 SUITABILITY OF SUBSTRATES

- Condition: Dry and free of dust, debris, grease and other deleterious matter.

620 PREPARATION OF EXISTING TIMBER SUBSTRATES

- Remedial work: Adjust boards to level and securely fix. Punch in any protruding fasteners and plane or sand to achieve an even surface.

- Defective boards: Give notice.
- Moisture content: Not more than 22% at time of covering.

640 TIMBER FOR USE WITH ZINC WORK

- Quality: Planed, free from wane, splits, pitch pockets, decay and insect attack (ambrosia beetle excepted).
- Moisture content: Not more than 22% at time of fixing and covering.
- Preservative treatment: Organic solvent as section Z12, and Wood Protection Association
 Commodity Specification C8.

650 LAYING UNDERLAY

- Handling: Prevent tears and punctures.
- Laying: Butt jointed onto a dry substrate.
 - Fixing edges: With galvanized, sherardized or stainless steel staples or 20 x 3 mm extra large head clout nails.
 - Do not lay over eaves and drip/ step zinc underlaps.
- Protection: Keep dry and cover with zinc at the earliest opportunity.

655 LAYING UNDERLAY

- Handling: Prevent tears, punctures and removal of sanded finish.
- Laying: Overlap jointed, parallel to eaves, onto a dry substrate.
 - Fixing edges: With galvanized, sherardized or stainless steel clout nails at close centres.
- Protection: Keep dry and cover with zinc at the earliest opportunity.

FIXING ZINC

720 STANDING SEAM FIXED CLIPS

Fixing: Secure each clip (minimum of 5) to substrate with two fixings (205709000).
 Each clip to withstand a pulling force of 50 daN

725 STANDING SEAM SLIDING CLIPS

- Stainless steel.
 - Two piece clips with 70mm sliding movement (205710000)
- Fixing: Secure each clip to substrate with three fixings.

Each clip to withstand a pulling force of 50 daN

Typical clip spacing:

Middle zone every 330mm

Edge zone 200mm

Corner zone 150mm

750 CLIPS FOR FLASHINGS/ CROSS JOINTS

- Material: Zinc of same thickness as that being secured.
- Dimensions:
- Width: Not less than 50 mm.
- Length: To suit detail.
- Fixing: Secure each clip to substrate with two fixings not more than 50 mm from edge of strip/ sheet being fixed.

760 CONTINUOUS CLIPS

- Material: Zinc of same thickness as that being secured.
- Dimensions:
- Width: To suit detail.
- Length: Not more than 1.8m.
- Fixing: To substrate at 200 mm centres. Welt edge of strip/ sheet being fixed to continuous clip and dress down.

810 FORMING DETAILS

- Folds and welts: Form without thinning, or splitting the strip/sheet.
- Thermal movement: Form details with appropriate allowance for movement, without impairment of security at full expansion or contraction.

825 SOLDERING

- All zinc must be cleaned back to its natural state.
- The protective coat on the underside of the upper panel must be removed over a width of 20mm either chemically, using DECALAQ, or mechanically, using a 3 MTM RolocTM Bristle Disc brush mounted on a small disc sander.
- The pre-weathering must be removed from the parts to be soldered. ZINN7 (flux) to be applied to allow spot soldering with solder (40% tin 60% lead) ZINN7 applied over whole length of joint and then soldered. Wipe clean. Please see VMZINC soldering document.


ACCESSORIES

900 INSECT MESH

- Continuous insect mesh at all openings to ventilated cavity and in accordance with drawings.
- Black Woven Aluminium Fly & Insect screen (Aperture 1.36 x 1.36mm) by Mesh Direct or similar approved

901 MASTIC

- Generally as Z22
- Applied to seal gaps around windows and where required
- Mastic used must be compatible with zinc in accordance with suppliers instructions (Polyurethanes/ Non-acetic silicones/ MS Polymers)
- Colour to match zinc as closely as possible

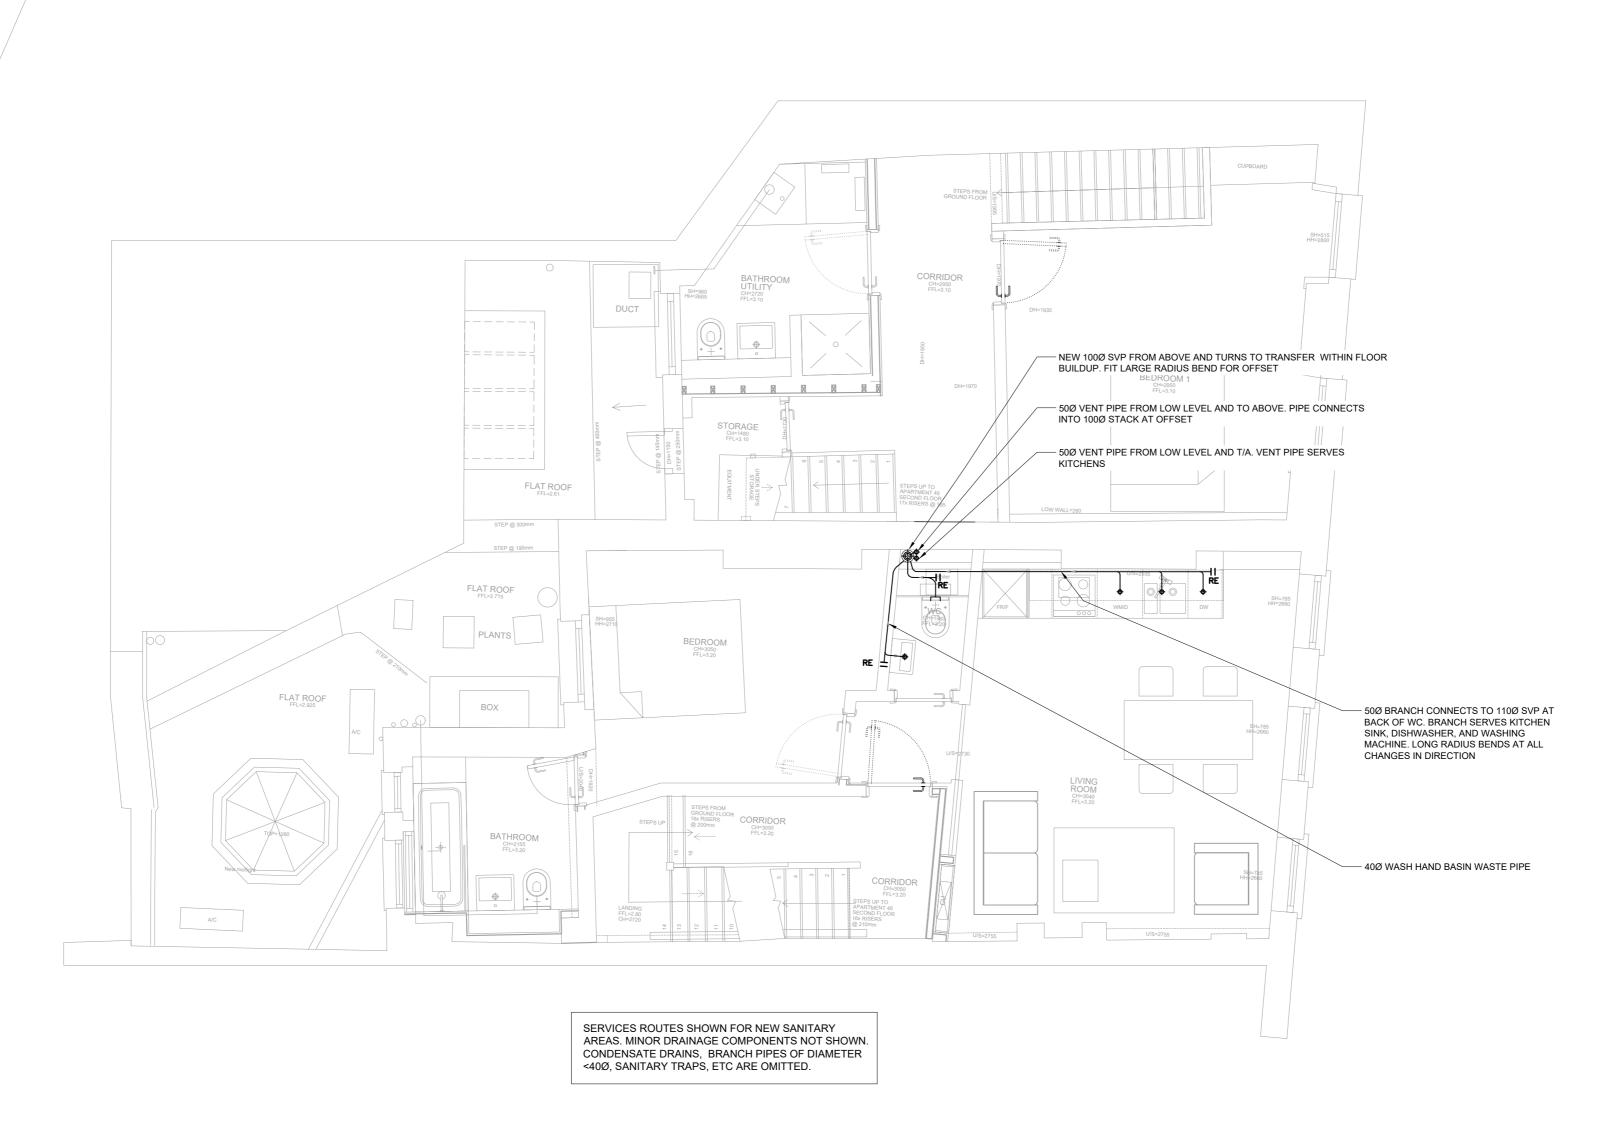

FIRST FLOOR

Notes:

- DO NOT SCALE FROM DRAWING
- ALL SETTING OUT TO BE AGREED WITH ARCHITECT
 INFORMATION MUST BE READ WITH ALL
- SPECIFICATIONS, SCHEDULES AND DRAWINGS

 THE EXISTING RAINWATER DRAINAGE SYSTEM ON THE FRONT ELEVATION WILL BE RETAINED ON THE REAR ELEVATION DRAINAGE ROUTES THAT SERVE GF AND BASEMENT RESTAURANT DEMISE
- MUST BE RETAINED. ANY REDUNDANT DRAINAGE GOODS ARE TO BE REMOVED

 THE MAIN CONTRACTOR SHALL ENSURE THAT ALL EXISTING DRAINAGE SYSTEMS (FOUL AND SURFACE WATER) WHICH ARE TO BE RETAINED ARE
- ADEQUATELY PROTECTED THROUGHOUT THE WORKS. PROTECT AGAINST DEBRIS ENTERING, OR ANYTHING ELSE THAT MIGHT CAUSE A BLOCKAGE. ANY I HING ELSE I HAI MIGH I CAUSE A BLOCKAGE.
 SHOULD A BLOCKAGE OCCUR, THIS MUST BE
 RECTIFIED IMMEDIATELY.

 • ALLOW FOR A BRANCH DISCHARGE PIPE MANIFOLD
 ON STACKS WHERE MULTIPLE BRANCHES
 CONNECT TO THE STACK WITHIN 150MM OF EACH
- CONNECT TO THE STACK WITHIN 150MM OF EACH
 OTHER (MEASURED VERTICALLY)

 FOR ALL NEW EXTERNAL DRAINAGE FIXTURES AND
 COMPONENTS REFER TO ARCHITECT'S
 SPECIFICATION

 RAINWATER RUNOFF LOADINGS OF PROPOSED
 WORKS REMAIN UNCHANGED COMPARED TO
 FXISTING

- WORKS REMAIN UNCHANGED COMPARED TO EXISTING

 WHERE AN EXISTING SERVICE PIPE IS SHOWN AS REDUNDANT AND TO BE REMOVED, CONTRACTOR TO FIRST ENSURE IT IS NOT LIVE PRIOR TO UNDERTAKING STRIP OUT. REPORT BACK TO
- UNDERTIAKING STRIP OUT. REPORT BACK TO DESIGN TEAM IF FOUND TO BE LIVE

 EXISTING SVPS ON REAR ELEVATION TO BE RETAINED, SUBJECT TO CONDITION SURVEY, TO BE UNDERTAKEN BY THE MECHANICAL CONTRACTOR. CONTRACTOR TO MAKE ALLOWANCE FOR REPLACING THE SVPS SHOULD THE CONDITION BE DEEMED NON RECTIFIABLE
- ALSO REFER TO ACOUSTIC CONSULTANT'S SPECIFICATION ON ALL NEW 100MM INTERNAL DRAINAGE ROUTES

LINETYPES/KEY DRAINAGE BELOW FLOOR DRAINAGE WALLS, VOIDS & HABITABLE ZONE

DRAINAGE ABOVE CEILING RODDING EYE

DRAINAGE AT HIGH

DENOTES REDUNDANT

Date

LEVEL

WC CONNECTION FROM ABOVE T/B TO BELOW

Planning Condition 01/09/2017

MRC CONSULT

No.

ABOVE GROUND DRAINAGE LAYOUT


Revision/Issue

45-46 RED LION STREET

EMIL EVE ARCHITECTS

GLASSHOUSE PROPERTY LTD

SEPTEMBER 2017 1:50 @ A2 Drawing Series Revision RLS-MRC-R11 PL1

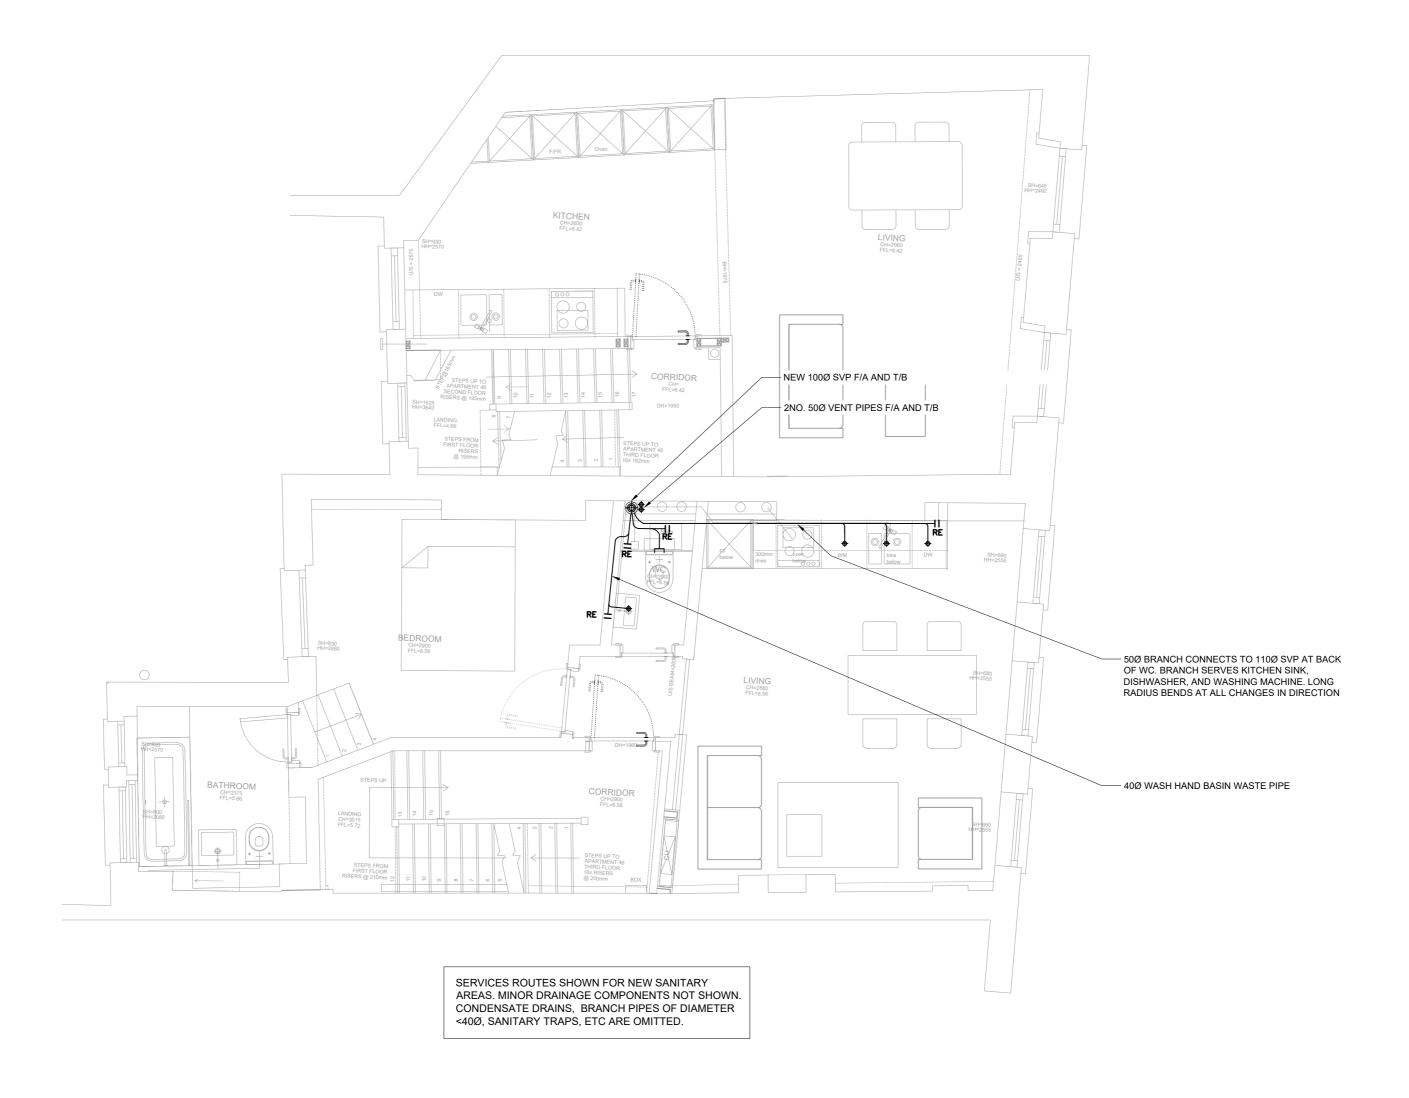

SECOND FLOOR

Notes:

- DO NOT SCALE FROM DRAWING
- DO NOT SCALE FROM DRAWING
 ALL SETTING OUT TO BE AGREED WITH ARCHITECT
 INFORMATION MUST BE READ WITH ALL
 SPECIFICATIONS, SCHEDULES AND DRAWINGS
 THE EXISTING RAINWATER DRAINAGE SYSTEM ON
 THE FRONT ELEVATION WILL BE RETAINED ON THE REAR ELEVATION DRAINAGE ROUTES THAT SERVE GF AND BASEMENT RESTAURANT DEMISE
- SERVE GF AND BASEMENT RESTAURANT DEMISE MUST BE RETAINED. ANY REDUNDANT DRAINAGE GOODS ARE TO BE REMOVED

 THE MAIN CONTRACTOR SHALL ENSURE THAT ALL EXISTING DRAINAGE SYSTEMS (FOUL AND SURFACE WATER) WHICH ARE TO BE RETAINED ARE ADEQUATELY PROTECTED THROUGHOUT THE WORKS. PROTECT AGAINST DEBRIS ENTERING, OR ANYTHING ELSE THAT MIGHT CAUSE A BLOCKAGE. SHOULD A BLOCKAGE OCCUR, THIS MUST BE RECTIFIED IMMEDIATELY.

 ALLOW FOR A BRANCH DISCHARGE PIPE MANIFOLD ON STACKS WHERE MULTIPLE BRANCHES CONNECT TO THE STACK WITHIN 150MM OF EACH OTHER (MEASURED VERTICALLY)
- OTHER (MEASURED VERTICALLY)
 FOR ALL NEW EXTERNAL DRAINAGE FIXTURES AND COMPONENTS REFER TO ARCHITECT'S
 SPECIFICATION
- SPECIFICATION

 RAINWATER RUNOFF LOADINGS OF PROPOSED WORKS REMAIN UNCHANGED COMPARED TO
- WORKS REMAIN UNCHANGED COMPARED TO EXISTING

 WHERE AN EXISTING SERVICE PIPE IS SHOWN AS REDUNDANT AND TO BE REMOVED, CONTRACTOR TO FIRST ENSURE IT IS NOT LIVE PRIOR TO UNDERTAKING STRIP OUT. REPORT BACK TO DESIGN TEAM IF FOUND TO BE LIVE

 EXISTING SVPS ON REAR ELEVATION TO BE RETAINED, SUBJECT TO CONDITION SURVEY, TO BE UNDERTAKEN BY THE MECHANICAL CONTRACTOR. CONTRACTOR TO MAKE ALLOWANCE FOR REPLACING THE SVPS SHOULD THE CONDITION BE DEEMED NON RECTIFIABLE

 ALSO REFER TO ACOUSTIC CONSULTANT'S
- ALSO REFER TO ACOUSTIC CONSULTANT'S SPECIFICATION ON ALL NEW 100MM INTERNAL DRAINAGE ROUTES

LINETYPES/KEY	
	DRAINAGE BELOW FLOOR
	DRAINAGE WALLS, VOIDS & HABITABLE ZONE
	DRAINAGE AT HIGH LEVEL
	DRAINAGE ABOVE CEILING
RE II	RODDING EYE
	WC CONNECTION
F/A	FROM ABOVE
T/B	TO BELOW
	DENOTES REDUNDANT SERVICE

PL1	Planning Condition	01/09/2017
No.	Revision/Issue	Date

MRC CONSULT

ABOVE GROUND DRAINAGE LAYOUT


45-46 RED LION STREET

EMIL EVE ARCHITECTS

GLASSHOUSE PROPERTY LTD

SEPTEMBER 2017 1:50 @ A2 Drawing Series Revision PL1 RLS-MRC-R11



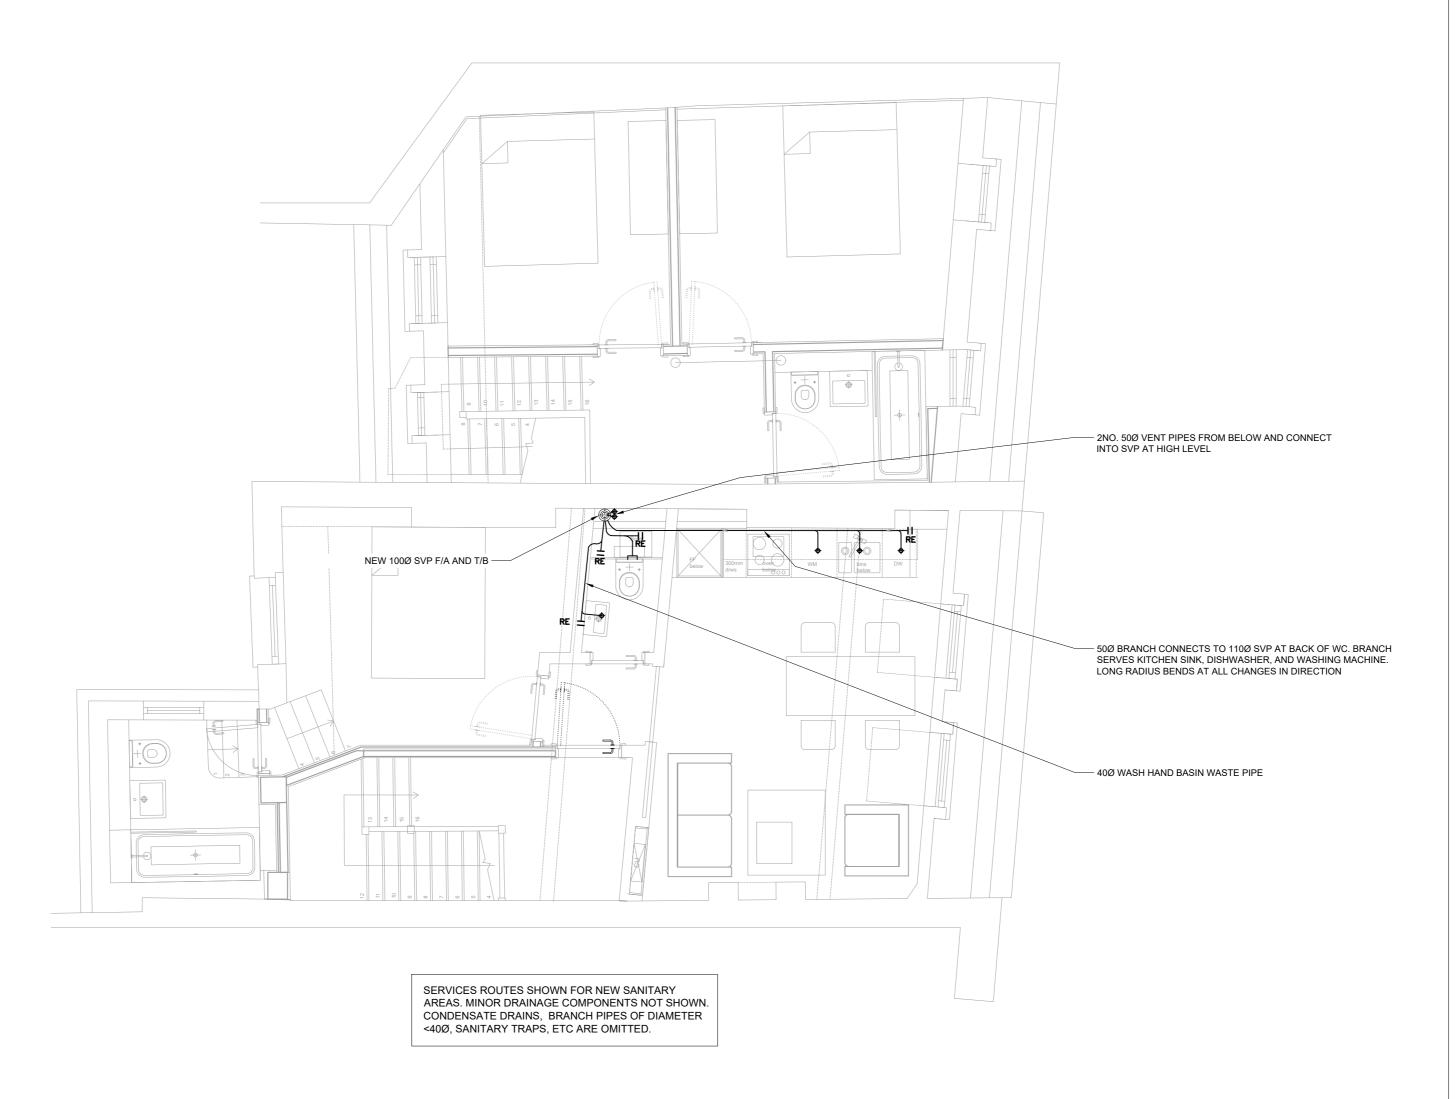

THIRD FLOOR

Notes:

- DO NOT SCALE FROM DRAWING

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 ALL SETTING OUT TO BE AGREED WITH ARCHITECT
 INFORMATION MUST BE READ WITH ALL
 SPECIFICATIONS, SCHEDULES AND DRAWINGS
 THE EXISTING RAINWATER DRAINAGE SYSTEM ON
 THE FRONT ELEVATION WILL BE RETAINED
 ON THE REAR ELEVATION DRAINAGE ROUTES THAT
 SERVE GF AND BASEMENT RESTAURANT DEMISE
 MIST BE PETAINED. ANY PEDI MIDANT DRAINAGE.
- SERVE GF AND BASEMENT RESTAURANT DEMISE MUST BE RETAINED. ANY REDUNDANT DRAINAGE GOODS ARE TO BE REMOVED

 THE MAIN CONTRACTOR SHALL ENSURE THAT ALL EXISTING DRAINAGE SYSTEMS (FOUL AND SURFACE WATER) WHICH ARE TO BE RETAINED ARE ADEQUATELY PROTECTED THROUGHOUT THE WORKS. PROTECT AGAINST DEBRIS ENTERING, OR ANYTHING ELSE THAT MIGHT CAUSE A BLOCKAGE. SHOULD A BLOCKAGE OCCUR, THIS MUST BE RECTIFIED IMMEDIATELY.

 ALLOW FOR A BRANCH DISCHARGE PIPE MANIFOLD ON STACKS WHERE MULTIPLE BRANCHES CONNECT TO THE STACK WITHIN 150MM OF EACH OTHER (MEASURED VERTICALLY)
- OTHER (MEASURED VERTICALLY)
 FOR ALL NEW EXTERNAL DRAINAGE FIXTURES AND COMPONENTS REFER TO ARCHITECT'S SPECIFICATION
 RAINWATER RUNOFF LOADINGS OF PROPOSED
- WORKS REMAIN UNCHANGED COMPARED TO
- WORKS REMAIN UNCHANGED COMPARED TO EXISTING

 WHERE AN EXISTING SERVICE PIPE IS SHOWN AS REDUNDANT AND TO BE REMOVED, CONTRACTOR TO FIRST ENSURE IT IS NOT LIVE PRIOR TO UNDERTAKING STRIP OUT. REPORT BACK TO DESIGN TEAM IF FOUND TO BE LIVE

 EXISTING SVPS ON REAR ELEVATION TO BE RETAINED, SUBJECT TO CONDITION SURVEY, TO BE UNDERTAKEN BY THE MECHANICAL CONTRACTOR. CONTRACTOR TO MAKE ALLOWANCE FOR REPLACING THE SVPS SHOULD THE CONDITION BE DEEMED NON RECTIFIABLE

 ALSO REFER TO ACOUSTIC CONSULTANT'S
- ALSO REFER TO ACOUSTIC CONSULTANT'S SPECIFICATION ON ALL NEW 100MM INTERNAL DRAINAGE ROUTES

LINETYPES/KEY	
	DRAINAGE BELOW FLOOR
	DRAINAGE WALLS, VOIDS & HABITABLE ZONE
	DRAINAGE AT HIGH LEVEL
	DRAINAGE ABOVE CEILING
RE II-	RODDING EYE
	WC CONNECTION
F/A	FROM ABOVE
T/B	TO BELOW
	DENOTES REDUNDANT SERVICE

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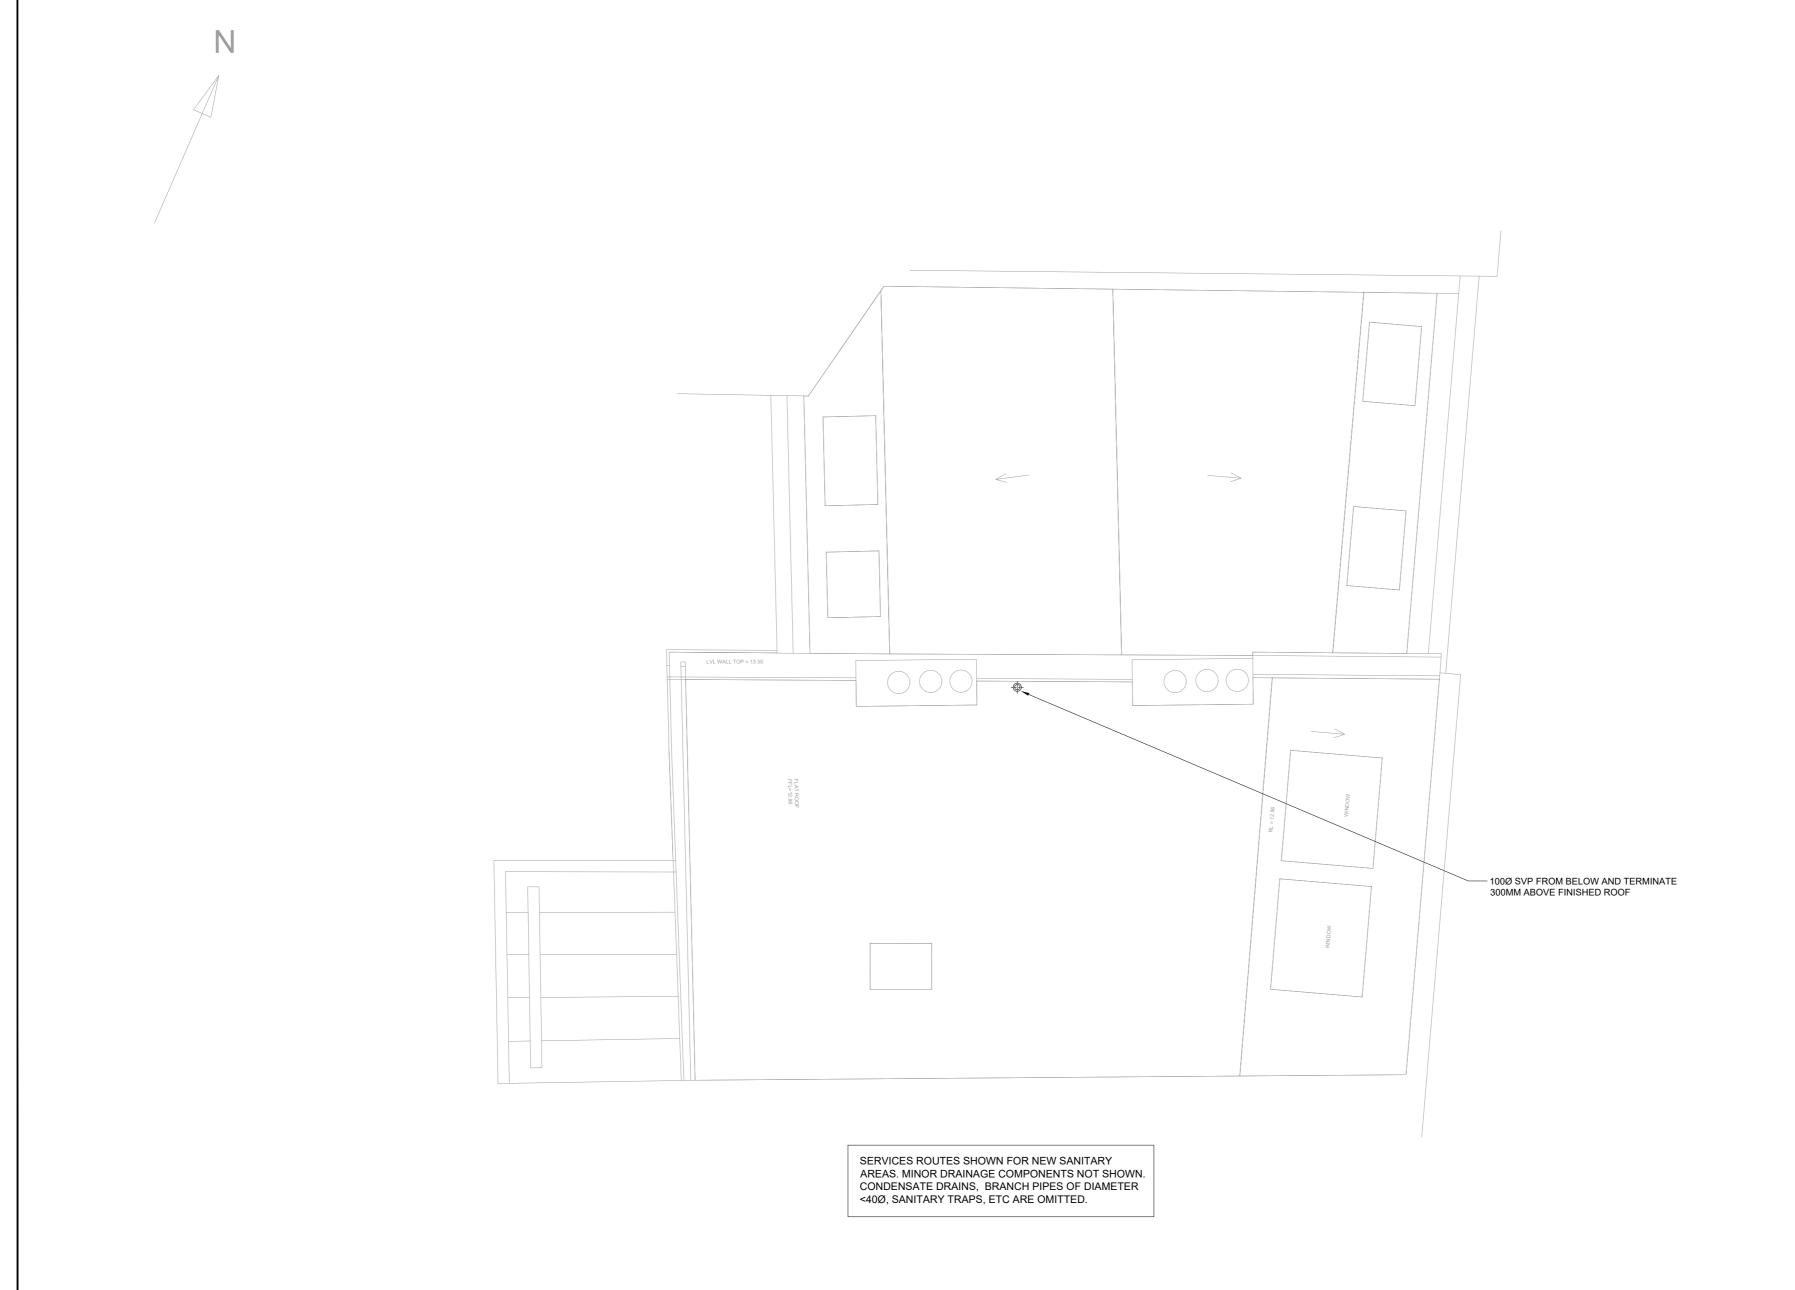
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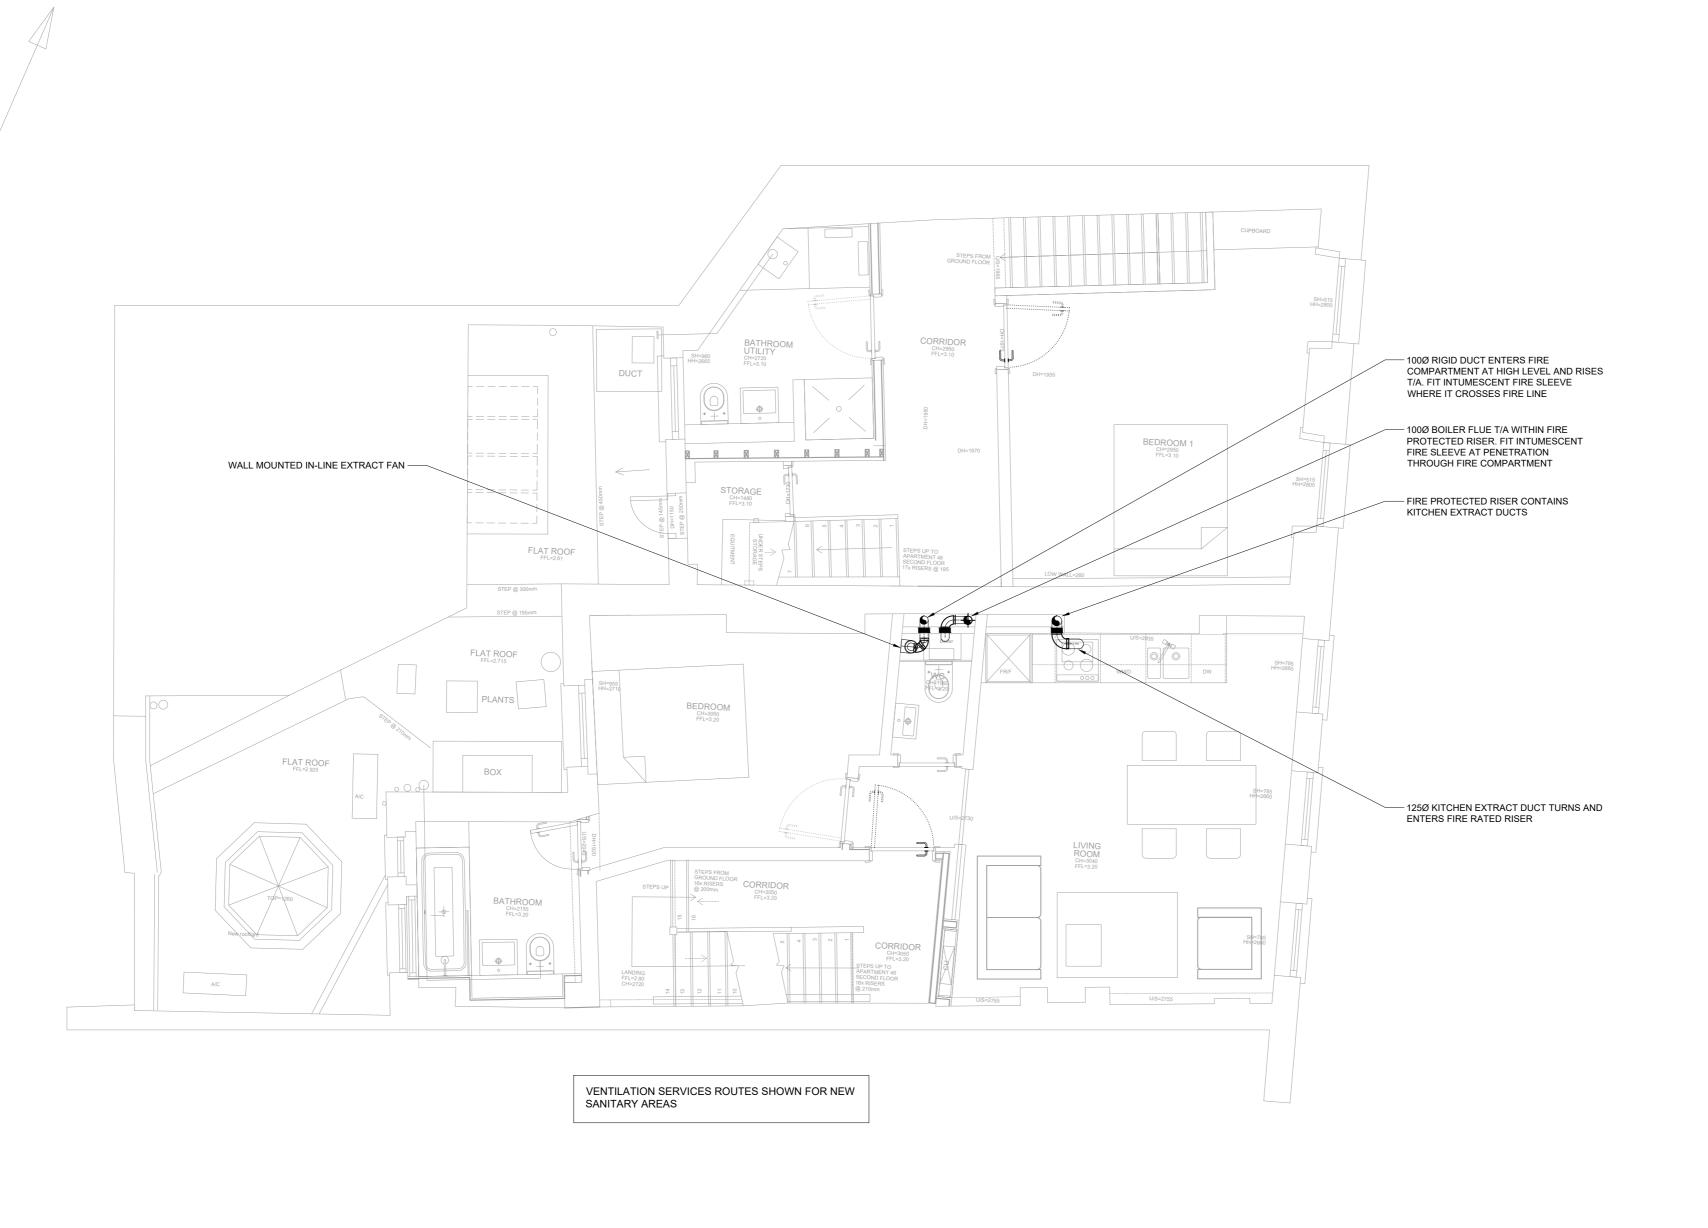
1:50 @ A2

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Drawing Series Revision PL1

RLS-MRC-R11



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 MAKEUP AIR TO FLATS 2,3,4. SURVEY AND
 SWEEP STACKS. SUPPLY AND FIT CHIMNEY
 LINER TO EACH STACK
 APPLY INTUMESCENT FIRE SLEEVE WRAP
 AROUND DUCTS THAT TRANSFER THROUGH A
 EIDE COMPARTMENT. COOPDINATE WITH FIRE COMPARTMENT. COORDINATE WITH ARCHITECTS INFORMATION FOR FIRE
- STRATEGY AND FIRE RATED WALLS EXTRACT VALVES ARE STEEL FIRE RATED C/W
 ADJUSTABLE CORE FOR BALANCING - GILBERTS



100Ø STEEL FIRE RATED EXTRACT VALVE



10MM DOOR UNDERCUT

20MM DOOR UNDERCUT



AIR TRANSFER OPENING - ROUTED

01/09/2017

MRC CONSULT

PL1 Planning Condition No. Revision/Issue

VENTILATION LAYOUT

45-46 RED LION STREET


Architect

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FIRST FLOOR



SECOND FLOOR

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VENTILATION LAYOUT
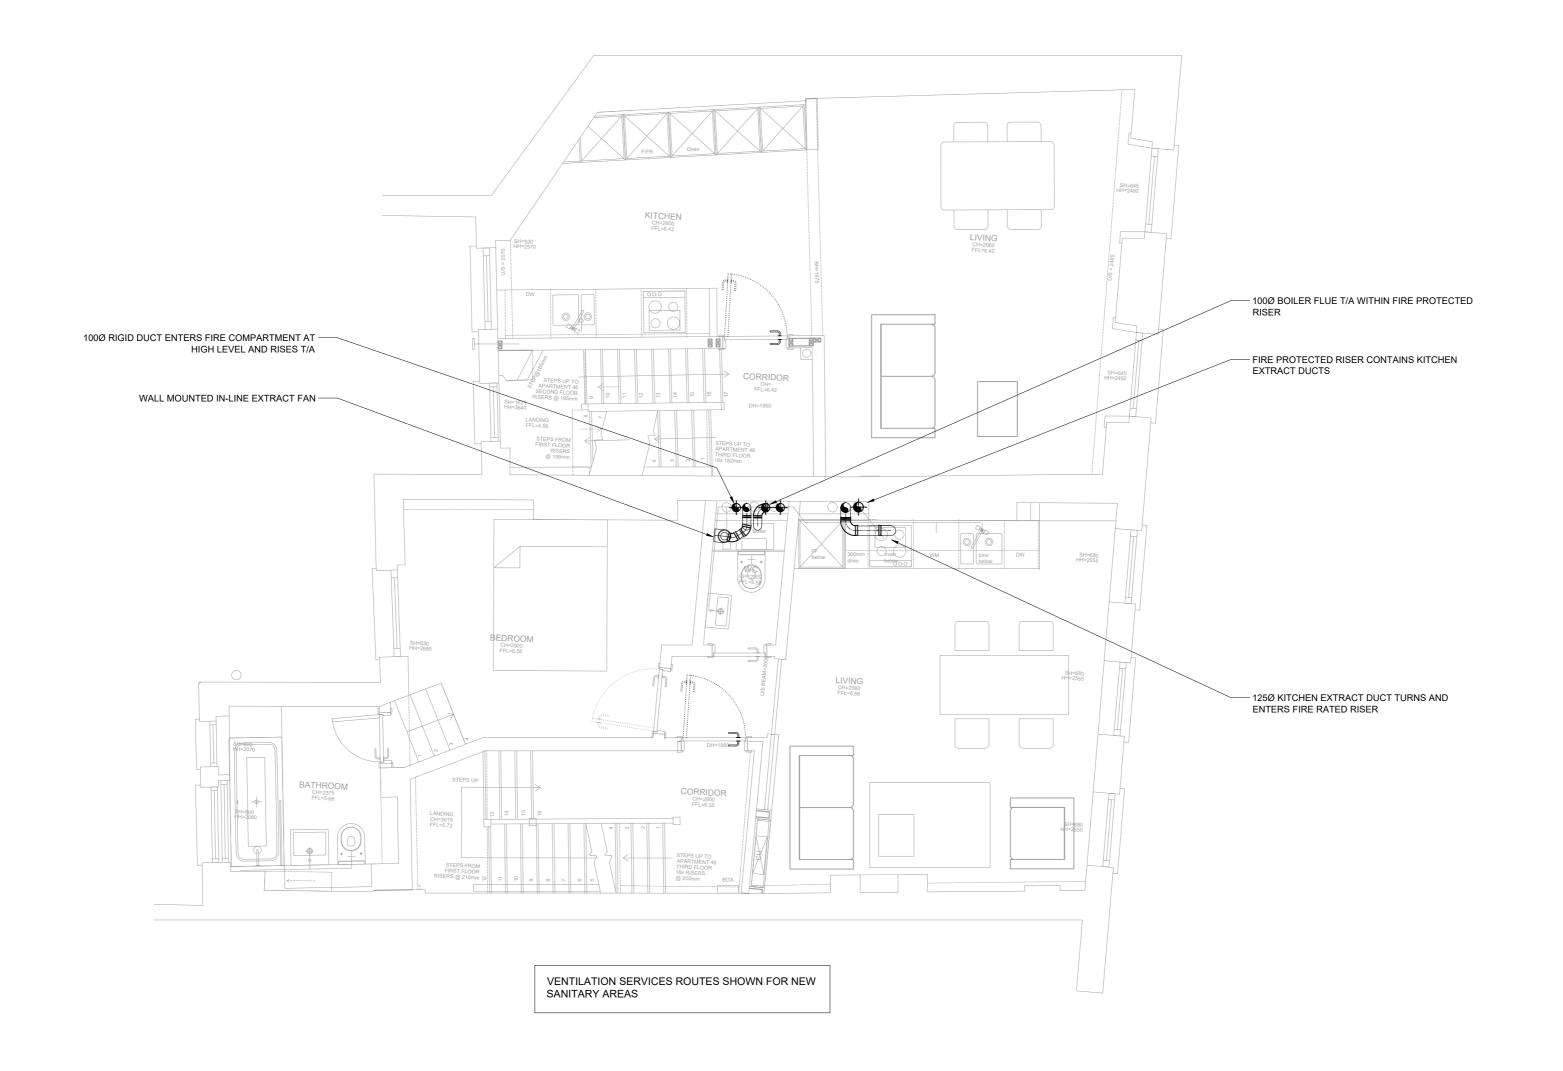
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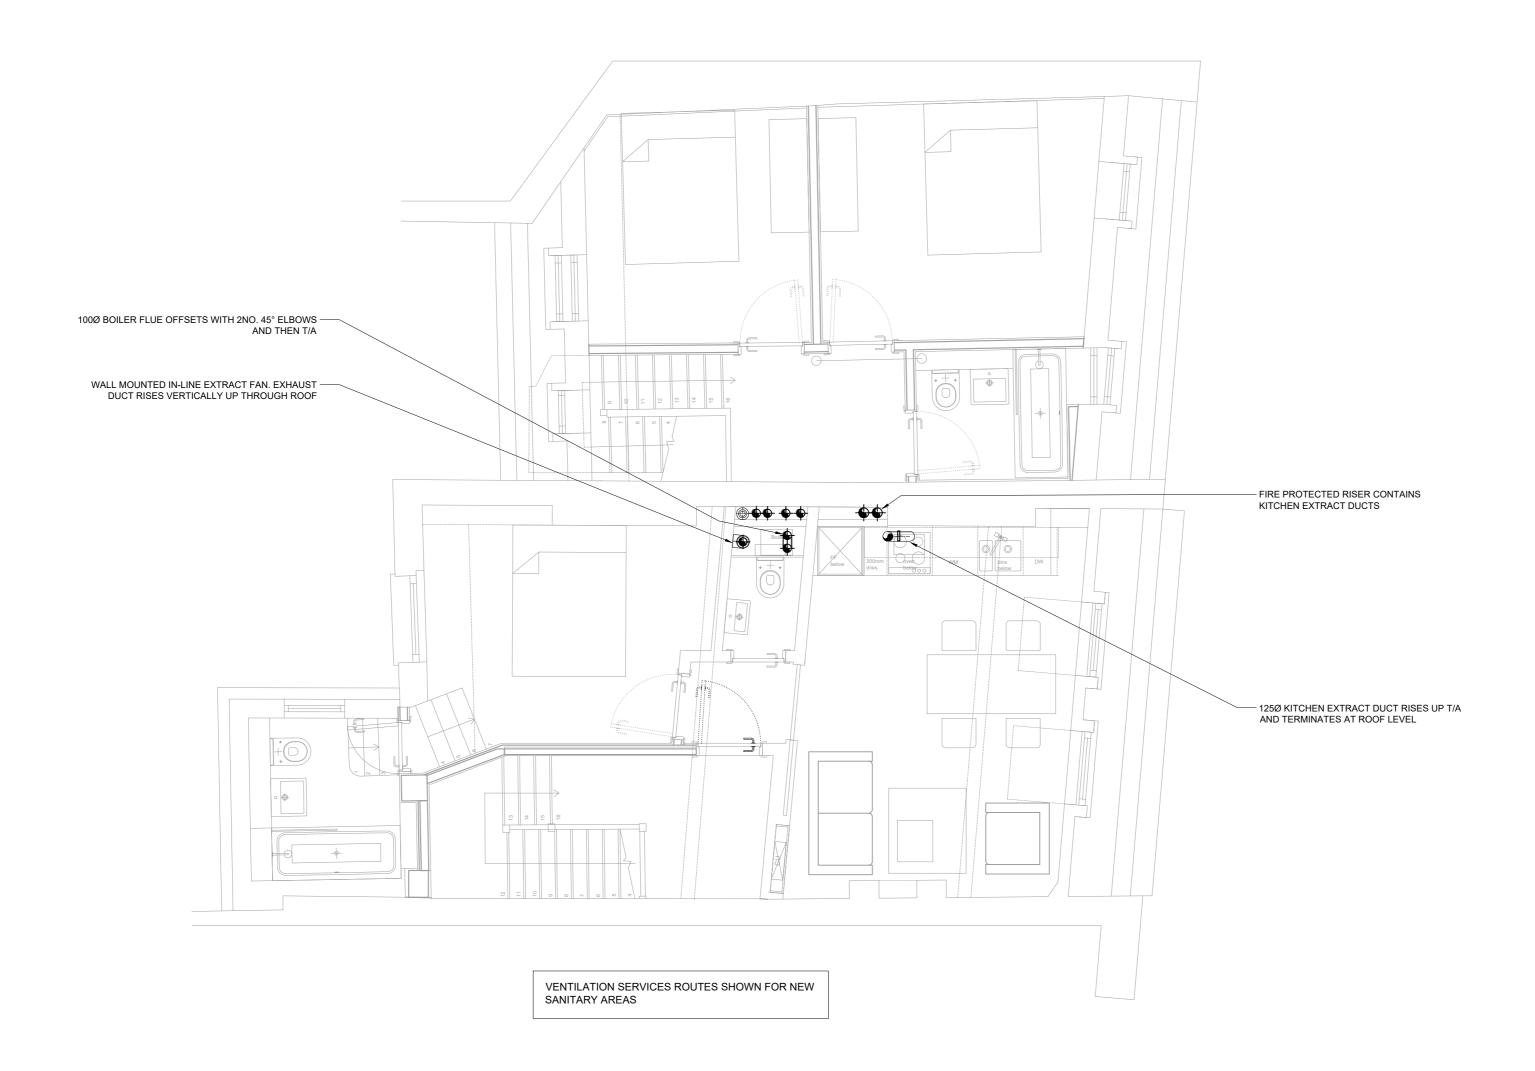
Architect

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THIRD FLOOR

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