


1. THE CONTRACTOR MUST CHECK ALL DIMENSIONS ON SITE BEFORE COMMENCING WORK
2. ALL WORK MUST CONFORM TO CURRENT BUILDING REGULATIONS, BRITISH STANDARDS & CODES OF PRACTICE AND NHBC STANDARDS
3. THESE DRAWINGS ARE TO BE READ IN CONJUNCTION WITH ALL RELEVANT DESIGNER, ENGINEER OR SPECIALIST DRAWINGS AND SPECIFICATIONS
4. ALL DIMENSIONS ARE IN MILLIMETERS UNLESS STATED OTHERWISE
5. THE CONTRACTOR IS RESPONSIBLE FOR PROVIDING ALL NECESSARY TEMPORARY SUPPORT TO THE BUILDING AND ANY ADJACENT STRUCTURES


NOTE:

100x50mm CLS STUDS AT DIFFERING HEIGHTS DEPENDING ON SLOPE OF ROOF. CUT TO SIZE ON SIZE. FIXED TO SOLE PLATE AT BOTTOM WHICH IS RAKED TO ANGLE OF ROOF.

100x50mm CLS SOLE PLATE FIXED TO TOP OF MASONRY WALL. USE MASONRY NAILS AT 500cc STAGGERED.

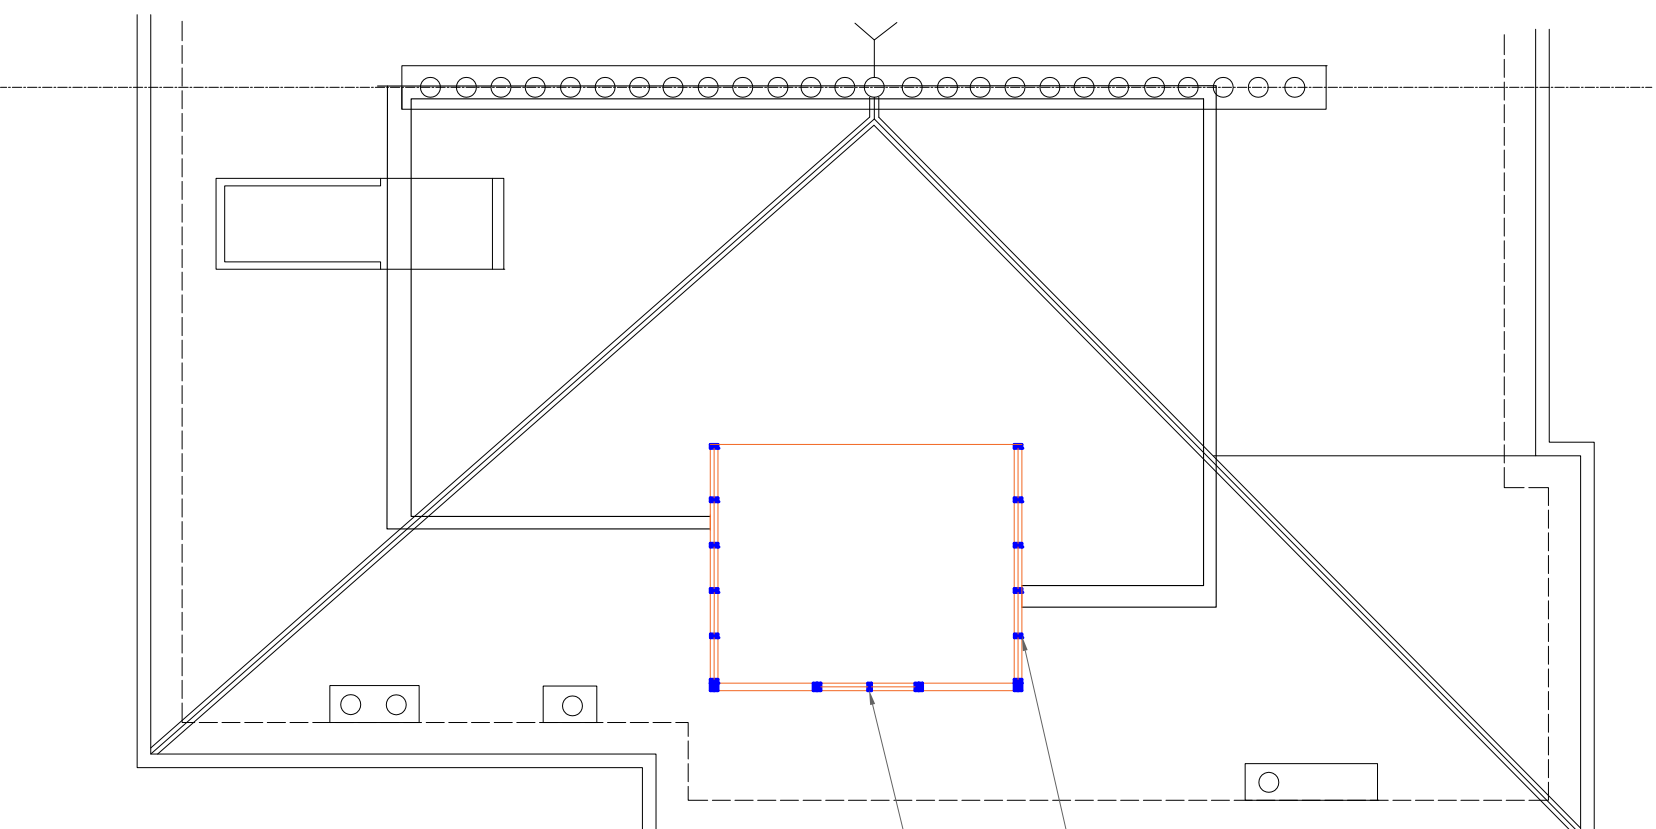

DORMER WALL PLAN

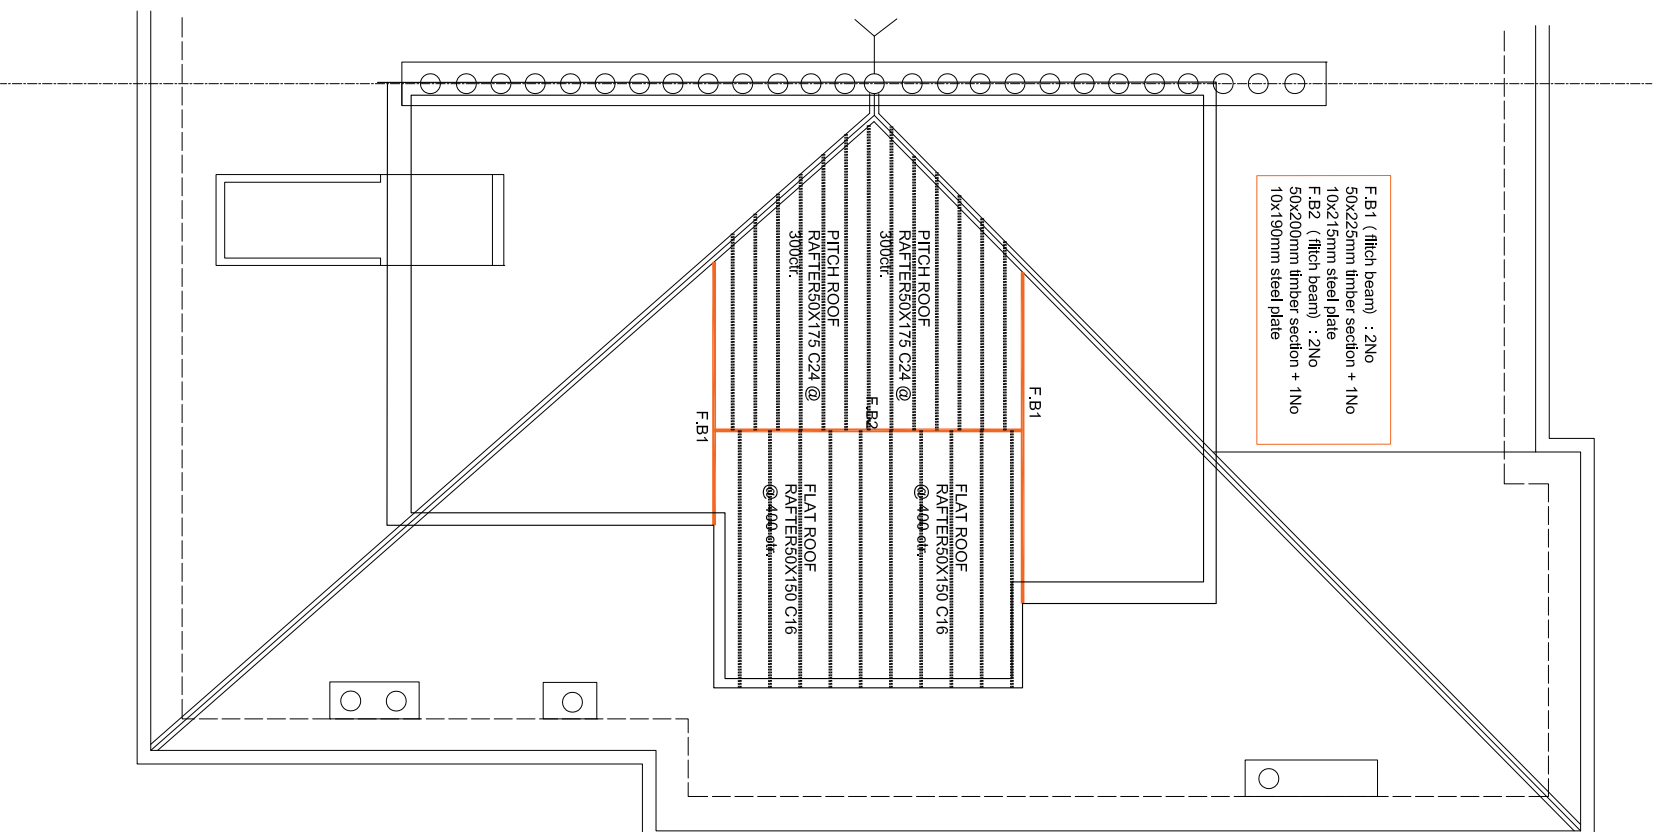

ROOF FRAMING PLAN

PROJECT TITLE: LOFT CONVERSION
CLIENT: STEWART BRANNAN
ADDRESS: 18 BELSIZE PARK, LONDON
TITLE: ROOF FRAMING PLAN & DORMER WALL PLAN
DRAWING NO: 09
REV:
DRAWN BY: H.D.
Date: JUNE 2017
SCALE: 1:100@ A3