



VEW FROM DRUMMOND CRESCENT



04 VIEW FROM EVERSHOLT STREET

DO NOT SCALE FROM THS DRAWING
The contractor shall check and verify all dimensions on site and report any descrepancies in writing to the architect before proceeding with work.

FOR ELECTRONIC DATA USE
Electronic data/drawings are issued as "read only" and should not be interrogated for measurement. All dimensions and levels should be read only from those values stated in text, on the drawing.

AREA MEASUREMENT

The areas are approximate and can only be verified by a detailed dimensional survey of the completed building. Any decisions to be made on the basis of these predictions whether as to project viability, pre-letting, lease agreements or the like should include due allowance for the increases and decreases inherent in the design development and building processes. Figures relate to the likely areas of the building at the current state of the design and using Gross External Area (GEA), Gross Internal Area (GIA) and Net Internal Area (NIA) method of measurement from the Code of Measuring Practice, 5th edition (RICS code of practice). All areas are subject to Town Planning and Conservation Area Consent, and detailed Rights to Light analysis.

NOTES:

REVISION DATE COMMENT

72 - 26 EVERSHOT STREET CAMDEN

NEKTON INVESTMENTS


SITE PLAN, BLOCK PLAN AND PHOTOS

SCALE BAR:

SCALE: DRAWN | CHECK VARIES 24.05.17 REASON FOR ISSUE: DRAWING NO: 72ES\_PL\_000




The D\*Haus Company Limited 48 Rawstorne Street London EC1V 7ND www.thedhaus.com

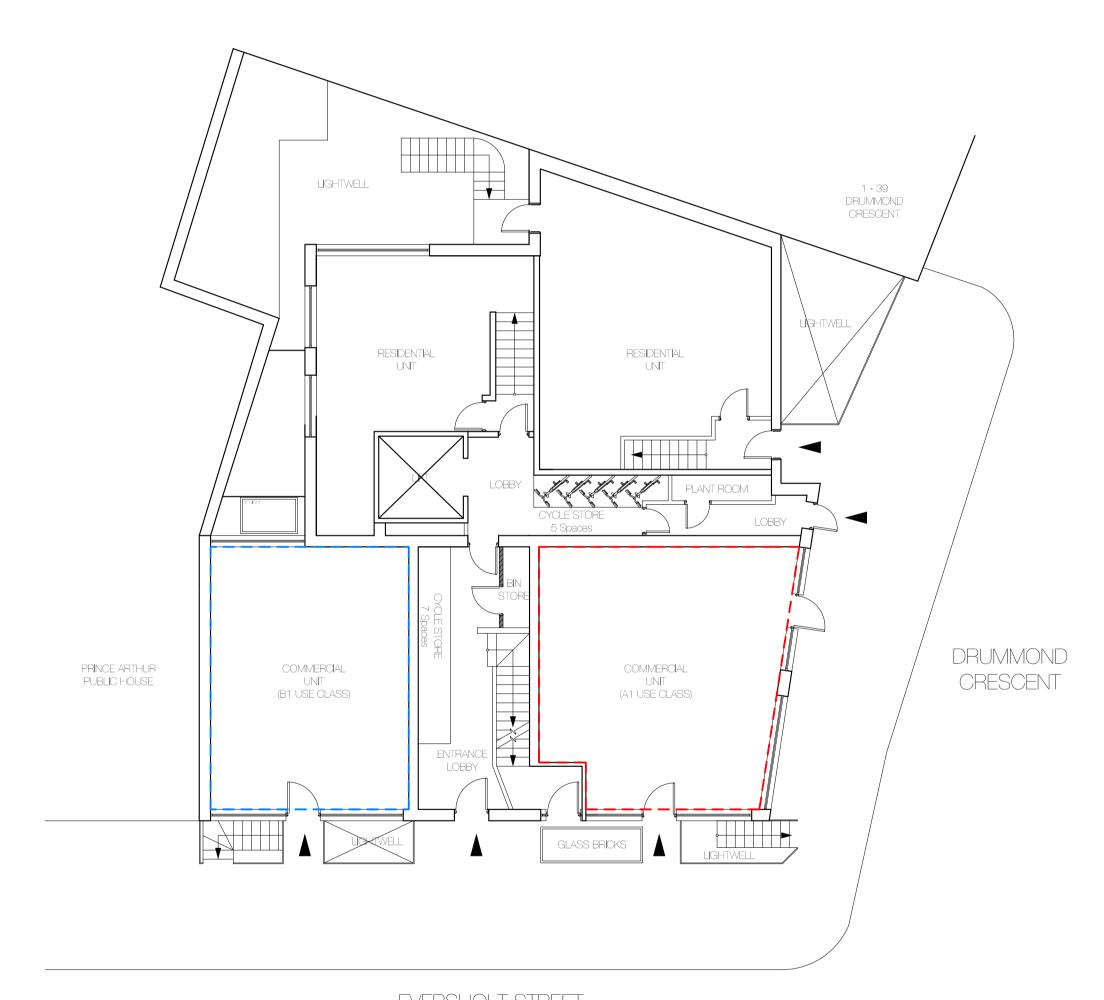

EVERSHOLT STREET

01 EXISTING GROUND FLOOR PLAN

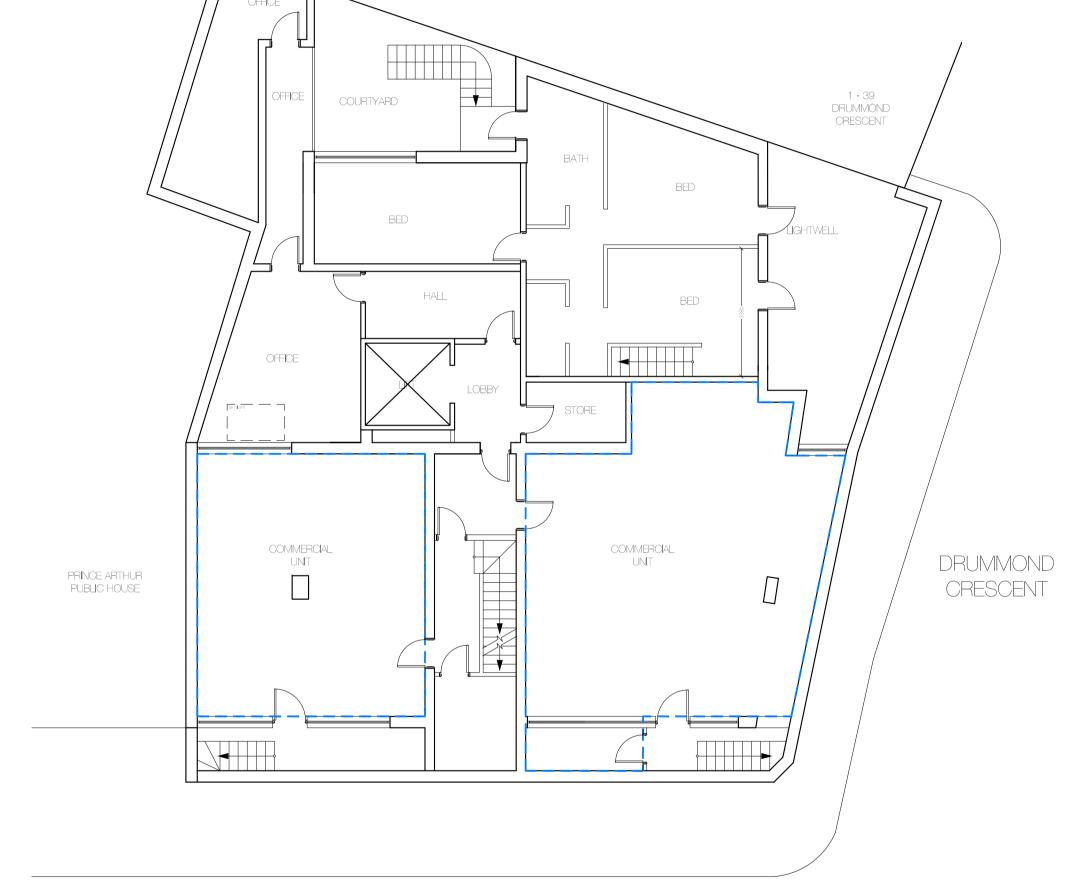

EVERSHOLT STREET

02 EXISTING BASEMENT PLAN

DO NOT SCALE FROM THIS DRAWING
The contractor shall check and verify all dimensions on site and report any descrepancies in writing to the architect before proceeding with work.

FOR ELECTRONIC DATA USE Electronic data/drawings are issued as "read only" and should not be interrogated for measurement, All dimensions and levels should be read only from those values stated in

text, on the drawing. AREA MEASUREMENT

The areas are approximate and can only be verified by a detailed dimensional survey of the completed building. Any decisions to be made on the basis of these predictions whether as to project viability, pre-letting, lease agreements or the like should include due allowance for the increases and decreases inherent in the design development and building processes. Figures relate to the likely areas of the building at the current state of the design and using Gross External Area (GEA), Gross Internal Area (GIA) and Net Internal Area (NIA) method of measurement from the Code of Measuring Practice, 5th edition (RICS code of practice). All areas are subject to Town Planning and Conservation Area Consent, and detailed Rights to Light analysis.

NOTES:

B1 USE CLASS

A2 USE CLASS

C3 USE CLASS 

REVISION DATE COMMENT

PROJECT:

72 - 26 EVERSHOT STREET CAMDEN

NEKTON INVESTMENTS


DRAWING: EXISTING PLANS

SCALE BAR:

SCALE:	DRAWN: CHECK
1:100 @ A3	DW DG
; 7	NORTH:
	REV:
	<u> </u>




The D\*Haus Company Limited 48 Rawstorne Street London EC1V 7ND www.thedhaus.com

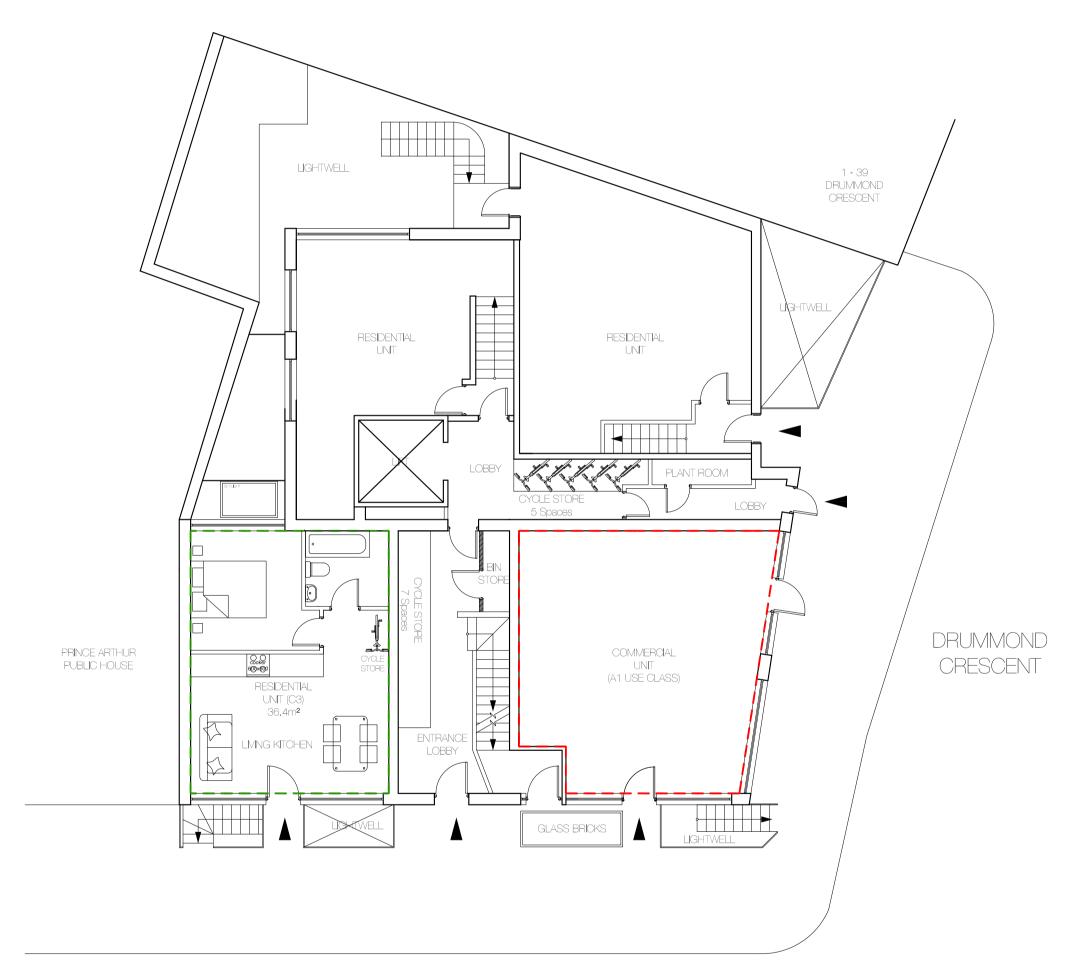

EVERSHOLT STREET

01
EXISTING GROUND FLOOR PLAN

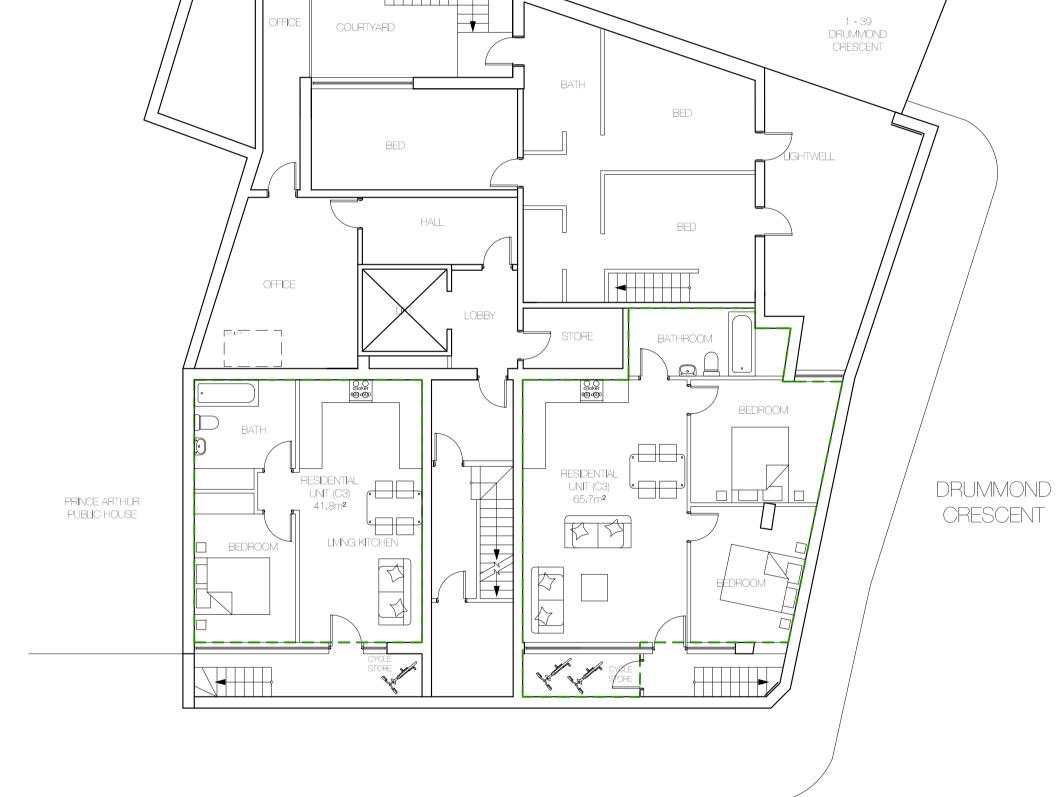

EVERSHOLT STREET

02 EXISTING BASEMENT PLAN

DO NOT SCALE FROM THIS DRAWING

The contractor shall check and verify all dimensions on site and report any descrepancies in writing to the architect before proceeding with work.

FOR ELECTRONIC DATA USE Electronic data/drawings are issued as "read only" and should not be interrogated for measurement. All dimensions and levels should be read only from those values stated in

text, on the drawing, AREA MEASUREMENT

The areas are approximate and can only be verified by a detailed dimensional survey of the completed building. Any decisions to be made on the basis of these predictions whether as to project viability, pre-letting, lease agreements or the like should include due allowance for the increases and decreases inherent in the design development and building processes. Figures relate to the likely areas of the building at the current state of the design and using Gross External Area (GEA), Gross Internal Area (GIA) and Net Internal Area (NIA) method of measurement from the Code of Measuring Practice, 5th edition (RICS code of practice). All areas are subject to Town Planning and Conservation Area Consent, and detailed Rights to Light analysis.

NOTES:

B1 USE CLASS

\_\_\_\_

A2 USE CLASS

C3 USE CLASS 

COMMENT

PROJECT:

REVISION

72 - 26 EVERSHOT STREET CAMDEN

DATE

NEKTON INVESTMENTS

DRAWING: PROPOSED PLANS

SCALE BAR:

SCALE: 1:100 @ A3 DW DG 24,05,17 REASON FOR ISSUE: DRAWING NO: 72ES\_PL\_001



The D\*Haus Company Limited 48 Rawstorne Street London EC1V 7ND www.thedhaus.com