


GENERAL NOTES:

- DO NOT SCALE FROM THE DRAWINGS
- ALL DIMENSIONS ARE IN MILLIMETER.
- VERIFY ALL DIMENSIONS AND CONDITIONS BEFORE BUILDING OR STARTING CONSTRUCTION. NOTIFY THE DESIGNER IMMEDIATELY OF ANY DISCREPANCY OR VARIATION.
- ALL WORK TO COMPLY WITH CURRENT BUILDING REGULATIONS AND CODES OF PRACTICE


Title:

Existing Part Ground Floor Plan, Front Elevation and Sectional Side Elevations

Site Address	Scale: 1:50 @A3	Revision Date:	Faluck Patel
16 Percy Street London W1T 1DT	Date: 09 2012		
	Drawing No.: 2012/32 -01		
	Drawn By: FP	e.mail - faluckpatel@yahoo.com (M) +44 (0) 7871 466 254	

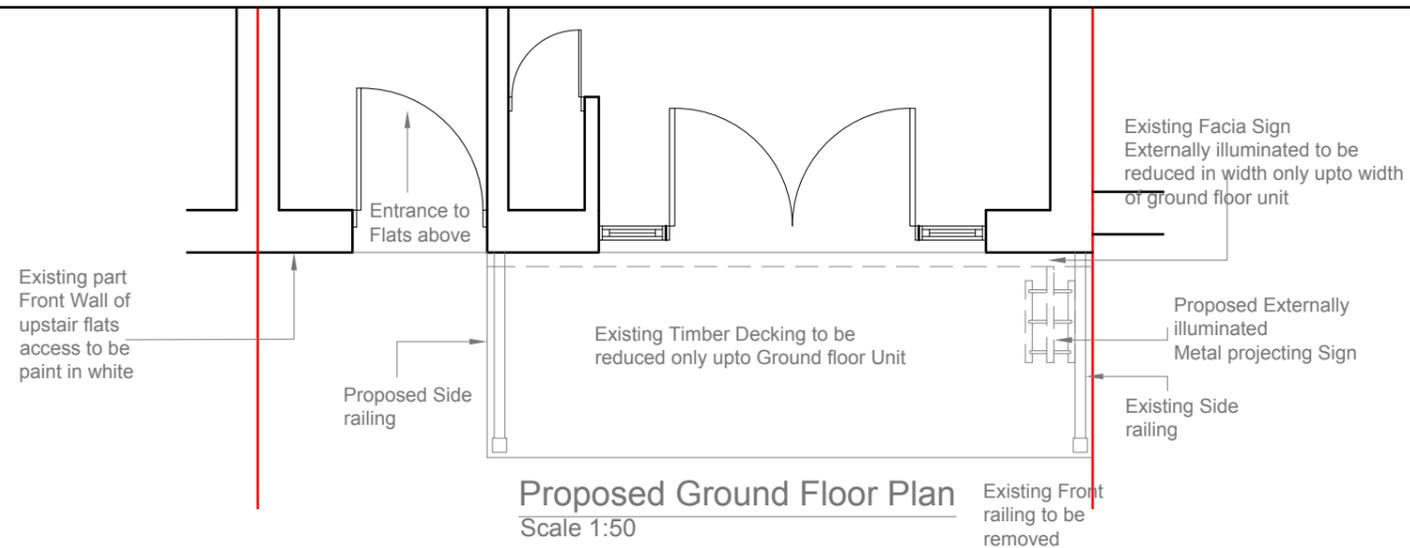


Proposed Ground Floor Plan
Scale 1:50

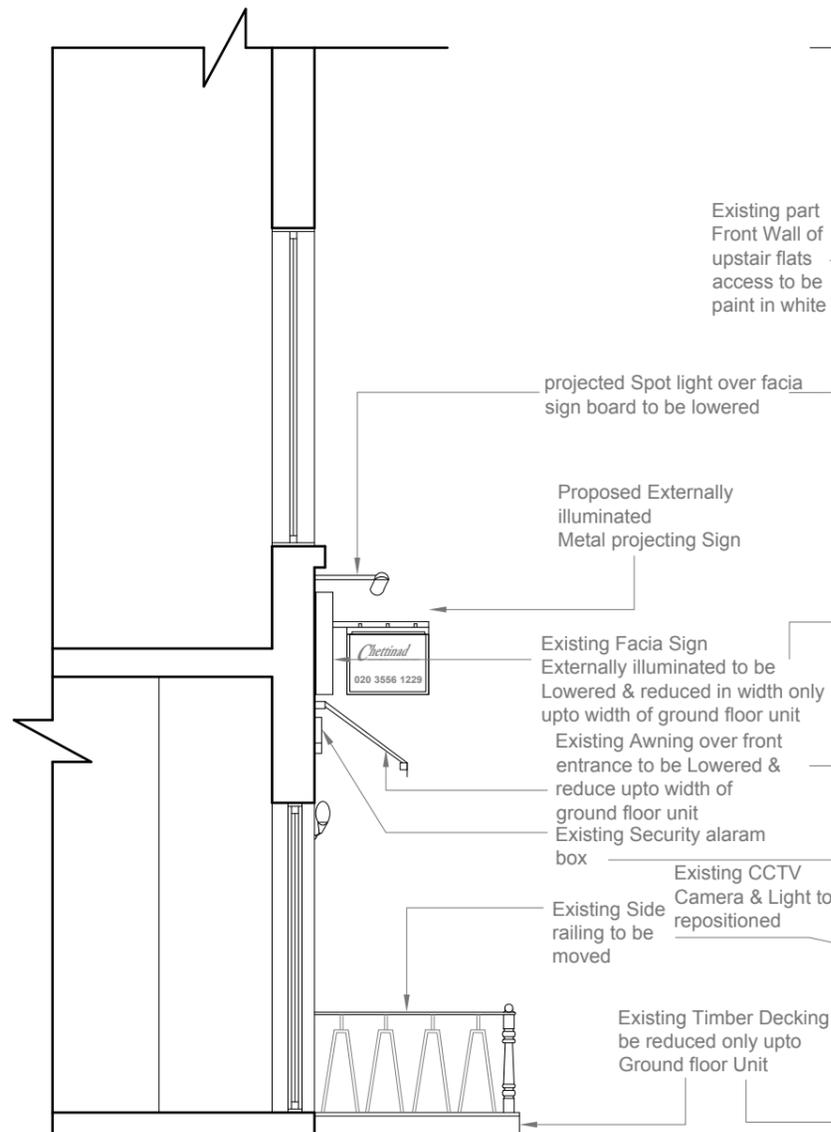

Proposed Side Elevation
Scale 1:50



Proposed Front Elevation
Scale 1:50

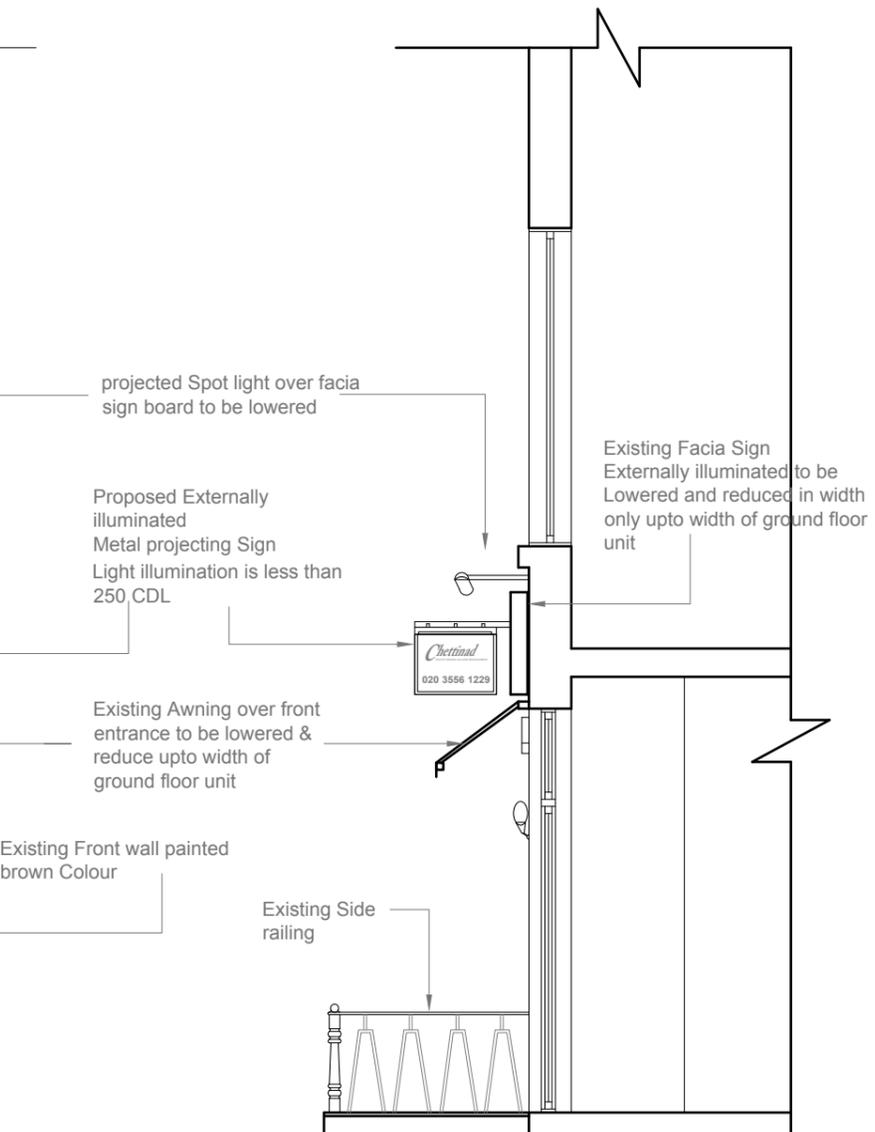

Proposed Side Elevation
Scale 1:50

GENERAL NOTES:
 1. DO NOT SCALE FROM THE DRAWINGS
 2. ALL DIMENSIONS ARE IN MILLIMETER.
 3. VERIFY ALL DIMENSIONS AND CONDITIONS BEFORE BUILDING OR STARTING CONSTRUCTION. NOTIFY THE DESIGNER IMMEDIATELY OF ANY DISCREPANCY OR VARIATION.
 4. ALL WORK TO COMPLY WITH CURRENT BUILDING REGULATIONS AND CODES OF PRACTICE

Title:
Proposed Part Ground Floor Plan, Front Elevation and Sectional Side Elevations

Site Address
 16 Percy Street
 London
 W1T 1DT

Scale: 1:50 @A3
 Date: 09 2012
 Drawing No.:
 2012/32 -01
 Drawn By:
 FP

Revision Date:
 A | 28/09/2012
 B | 28/09/2012
 e.mail -
 faluckpatel@yahoo.com
 (M) +44 (0) 7871 466 254





Location Plan
Scale 1:1250



Block Plan
Scale 1:500

GENERAL NOTES:

1. DO NOT SCALE FROM THE DRAWINGS
2. ALL DIMENSIONS ARE IN MILLIMETER.
3. VERIFY ALL DIMENSIONS AND CONDITIONS BEFORE BUILDING OR STARTING CONSTRUCTION. NOTIFY THE DESIGNER IMMEDIATELY OF ANY DISCREPANCY OR VARIATION.
4. ALL WORK TO COMPLY WITH CURRENT BUILDING REGULATIONS AND CODES OF PRACTICE

Title:

**Location &
Block Plans**



Site Address

16 Percy Street
London
W1T 1DT

Scale: 1:1250/500 @A4

Date: 09 2012

Drawing No.:
2012/32 -03

Drawn By:
FP

Revision Date:

e.mail -
faluckpatel@yahoo.com
(M) +44 (0) 7871 466 254

