tatehindle

33 Alfred Place
Design & Access Statement
G-Research 24th March 2017





Rev	Description	Date	Checked
00	Issued for Planning	24/03/17	JP

Contents

1.1	This Document	4
2.1	Site Location	5
2.2	Existing Roof Plan	6
2.3	Proposed Roof Plan	7
2.4	Proposed Roof Plant	8
3.1	Data Sheet - Air Handling Unit	9
3.2	Data Sheet - Air Conditioning unit	10
3.3	Data Sheet - Big Foot	11


1.1 This Document

Tatehindle have been invited by G-Research to submit a planning application to the London Borough of Camden in relation to the proposed expansion of plant area on the 5th Floor Roof of 33 Alfred Place, London, WC1E 7DP.

The proposed plant is necessary due to the Fit out works to the second and third floors of the property. G-Research, a tech company, intend to lease of these floors following completion of the fit out works.

This document should be read in conjunction with the proposed drawings:

- > PL(02)001 Location Plan
- > PL(02)005 Existing 5th Floor/Roof Plan
- > PL(02)015 Proposed 5th Floor/Roof Plan

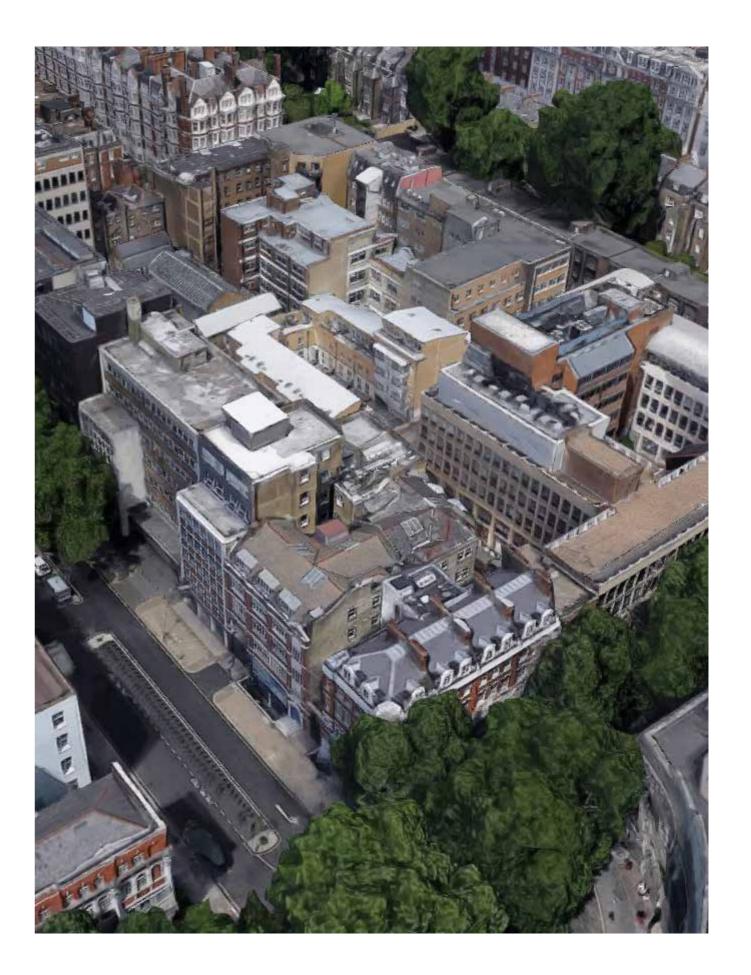


2.1 Site Location

Alfred Place runs roughly north-south parallel to Tottenham Court Road and one block to the east, between Chenies Street at the north end to Store Street at the south end.


The properties facing the street are predominantly offices. The application premises are at the South end of the street on the east side.

The application relates only to the fifth floor roof of the premises. This is accessed from Alfred Place. Alfred Place is in the Bloomsbury conservation area and is designated part of the Central London area on the local planning authority proposals map.

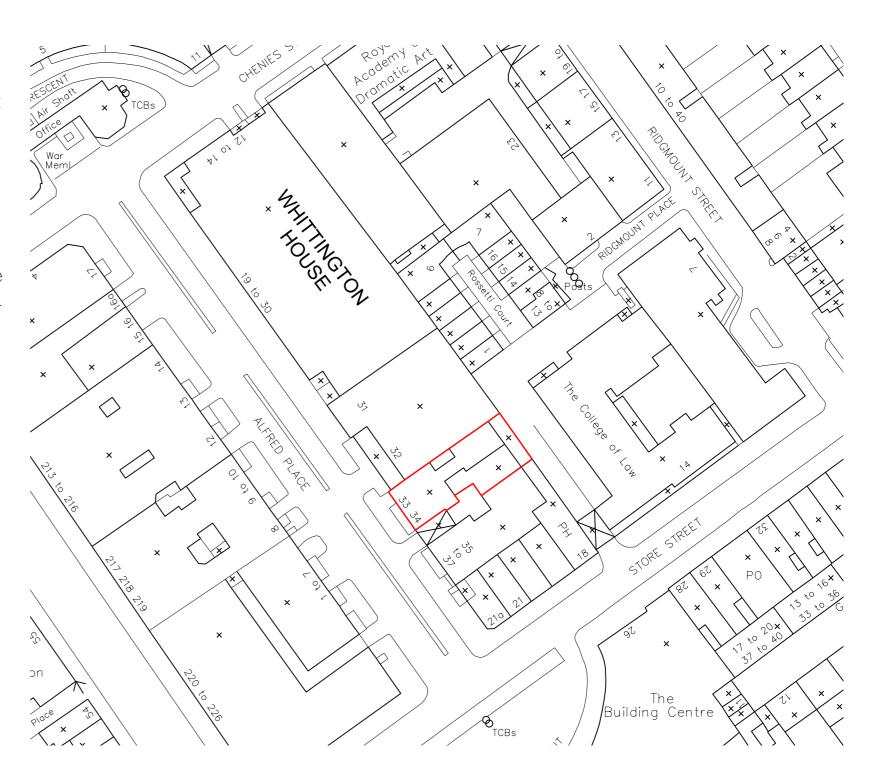




2.2 Existing Roof Plan

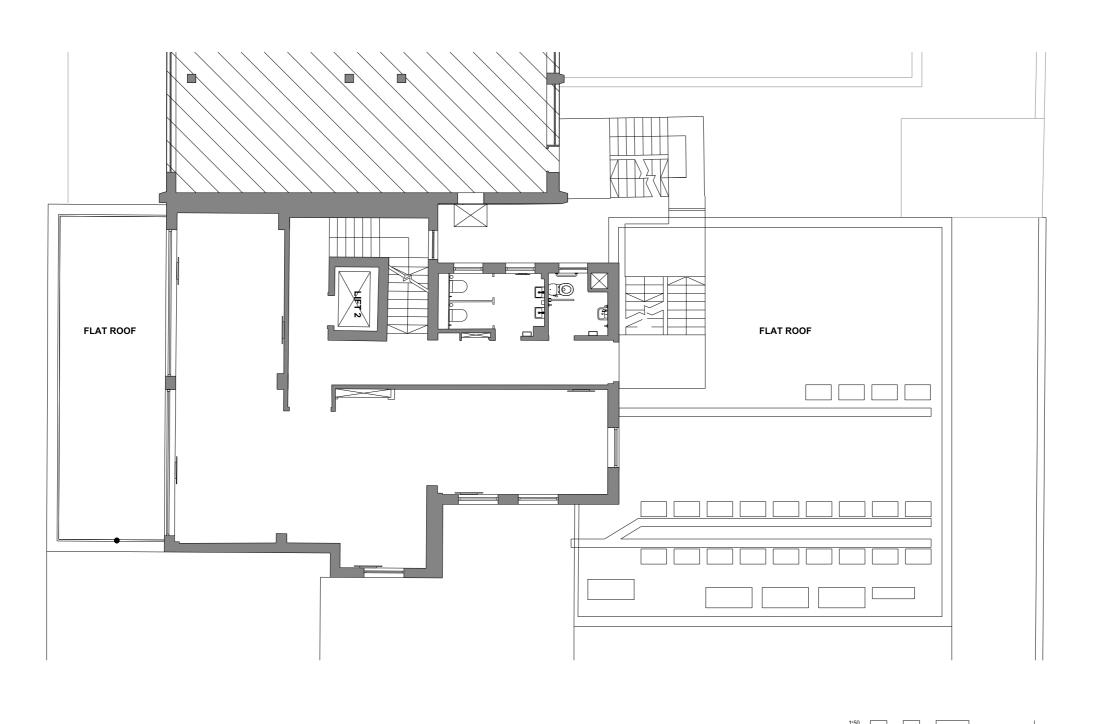





2.3 Proposed Roof Plan

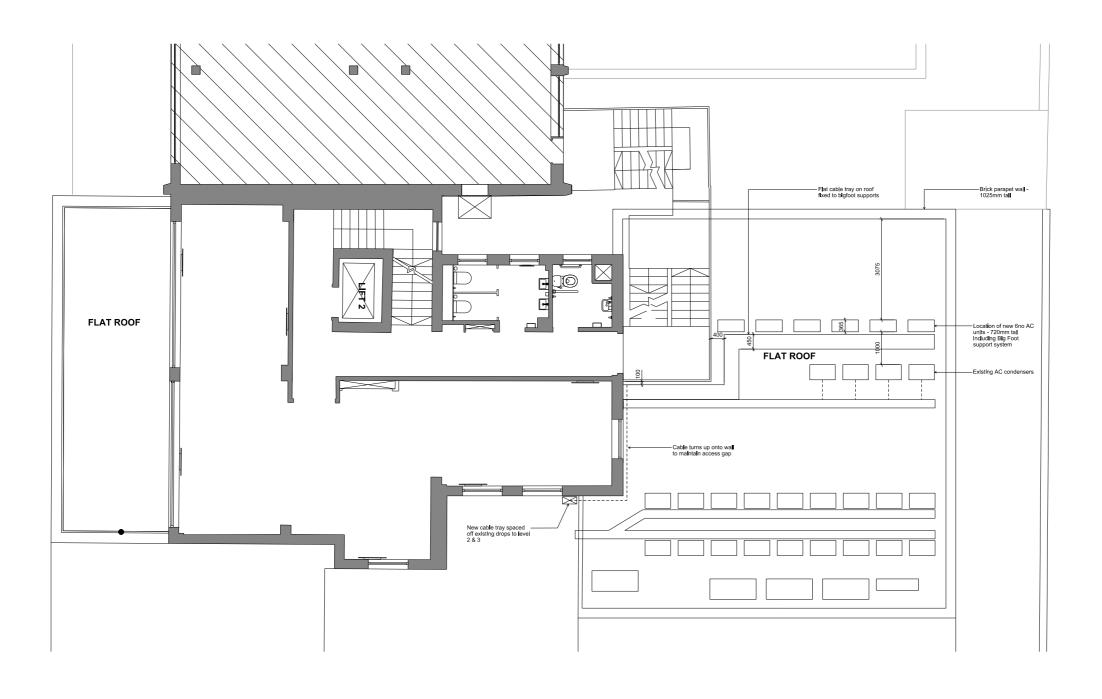




00 Rev	Planning issu	ue	24-03-17 Date	FF Checked
FOF	R INFORM	MATION		
Client PLA	ATINE HC	LDINGS		
Project	ALFRED I	PLACE		
	TH FLOO OPOSED			
Scale 1:50(@A1	Drawn FF	Date 24-03-17	Checked JP
Project 150		PL(03)015		Revision 00

tatehindle

2.4 Proposed Roof Plant

The proposal entails the siting of six new air conditioning units which will service the second and third floors of the property. As the existing builing currently holds air conditioning units on the fifth floor roof in a designated plant area, it has been proposed to site the units here.


As can be seen in the existing and proposed aerial view mock-up, the units will have a limited visual impact on the roofscape. The sketch section below also indicated the height of the proposed units as 720mm, including the 'big-foot' mounting, therefore below the height of the parapet wall by 305mm. This indicates that the air conditioning units will be completely obscured from view at street level.

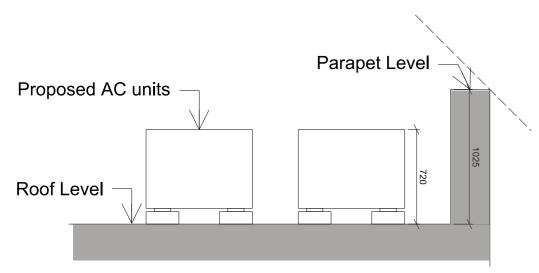








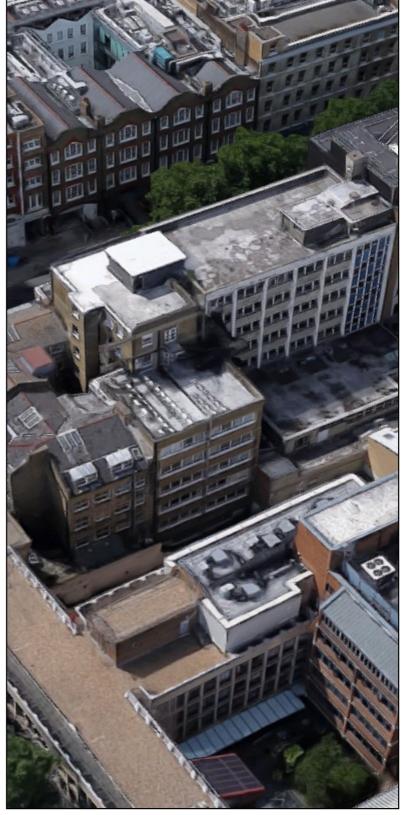

Proposed

3.1 Data Sheet - Proposed External AC Unit

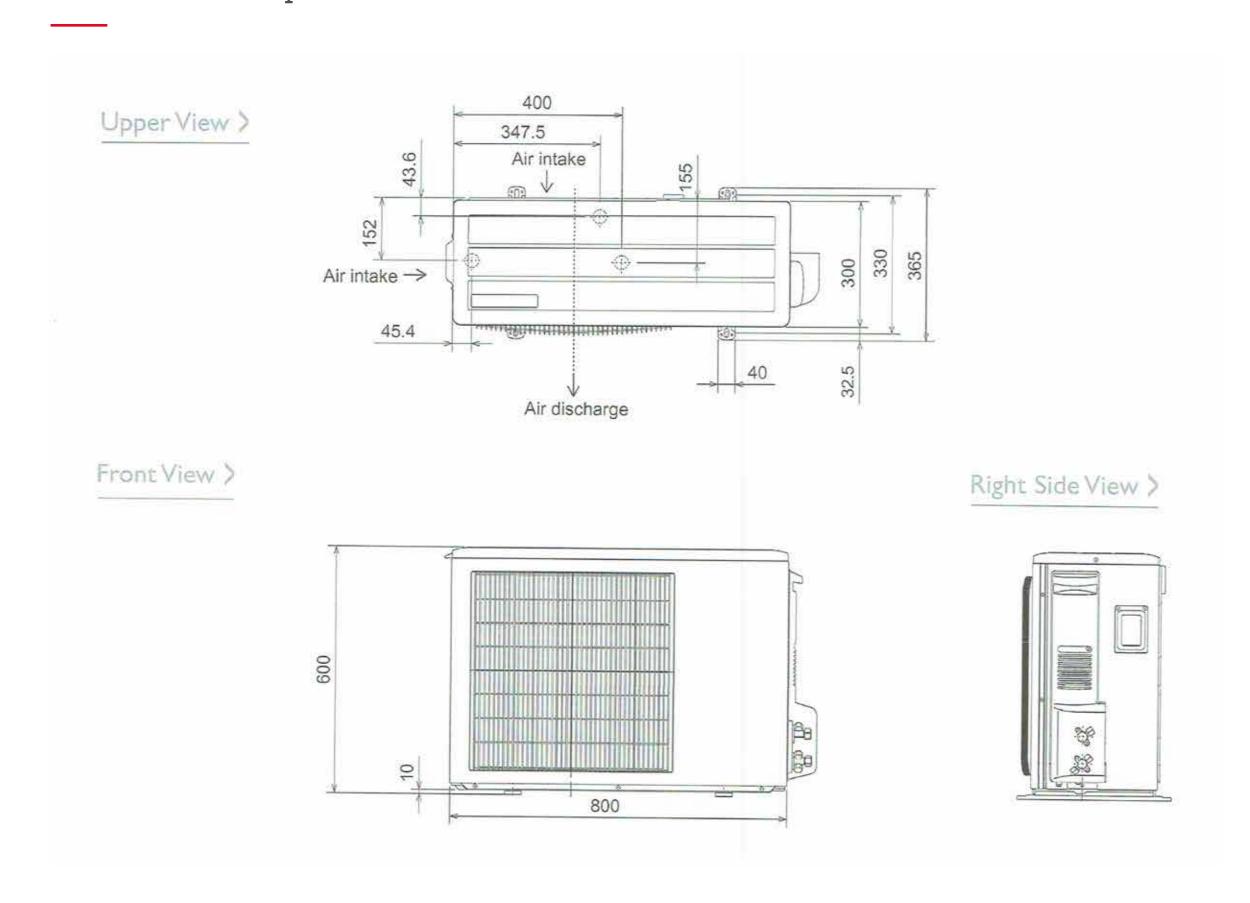

Air Conditioning

3.2 Data Sheet - Air Conditioning unit

Product Information

PKA-RP35HAL (Single Phase) **Power Inverter Heat Pump** Wall Mounted System

Making a World of Difference

Mr.SLIM.

Our wide range of Power Inverters offer customers high seasonal efficiency, advanced control options and quiet operation, whilst providing greater flexibility and ease of installation.

Key Features

- Flat panel, compact indoor unit design
- Adjustable louvres for uniform air distribution
- Internal pipe connection to wall mounted unit for easy and neat installation





Ventilation | Controls



Air Conditioning


Product Information


PKA-RP35HAL (Single phase) Power Inverter Heat Pump Wall Mounted System

Making a World of Difference

PKA-RP - IND	OOR UNITS	PKA-RP35HAL
APACITY (kW)	Heating (nominal)	4.1 (1.6-5.2)
	Cooling (nominal)	3.6 (1.6-4.5)
	Heating (UK)	3.5 (1.35-4.4)
	Cooling (UK)	3.3 (1.45-4.15)
HF (nominal & UK)		0.81
OP / EER (nominal)		3.83 / 3.83
COP / SEER (BS EN	V14825)	3.9 / 5.7
rP ENERGY EFFICIENC	CY CLASS Heating/Cooling	A / A+
IRFLOW (I/s)	Lo-Mi-Hi	150-175-200
IPE SIZE mm (in)	Gas	12.7 (1/2")
	Liquid	6.35 (1/4")
OUND PRESSURE LEVE	L (dBA)	36-40-43
OUND POWER LEVEL (d	BA)	60
IMENSIONS (mm)	Width x Depth x Height	898 x 249 x 295
VEIGHT (kg)		13
LECTRICAL SUPPL	Y	Fed by Outdoor Unit
USE RATING (BS88) -	· HRC (A)	6
NTERCONNECTING	CABLE No. Cores	4

PUHZ-ZRP -	OUTDOOR UNITS	PUHZ-ZRP35VKA
SOUND PRESSURE L	EVEL (dBA) Heating/Cooling	46 / 44
SOUND POWER LE	VEL (dBA) Cooling	65
WEIGHT (kg)		43
DIMENSIONS (mm)	Width x Depth x Height	809 x 300 x 630
ELECTRICAL SUPPL	Υ	220-240v, 50Hz
PHASE		Single
SYSTEM POWER	Heating/Cooling (nominal)	1.07 / 0.94
INPUT (kW)	Heating/Cooling (UK)	0.84 / 0.91
STARTING CURREN	T (A)	4.0
SYSTEM RUNNING CU	IRRENT (A) Heating/Cooling [MAX]	4.22 / 3.94 [13.4]
FUSE RATING (BS88) - HRC (A)		16
MAINS CABLE No. Cores		3
MAX PIPE LENGTH (m)		50
MAX HEIGHT DIFFERENCE (m)		30
CHARGE R410A (kg) - 30m	2.2

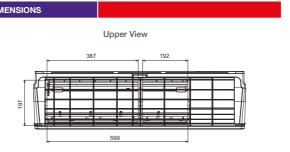

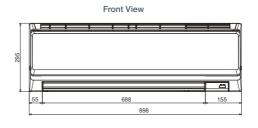







Changes for the Better Telephone: 01707 282880


 $email: air.conditioning@meuk.mee.com \ web: www.airconditioning.mitsubishielectric.co.uk$

UNITED KINGDOM Mitsubishi Electric Europe Living Environmental Systems Division
Travellers Lane, Hatfield, Hertfordshire, AL10 8XB, England General Enquiries Telephone: 01707 282880 Fax: 01707 278881
IRELAND Mitsubishi Electric Europe Westgate Business Park, Ballymount, Dublin 24, Ireland
Telephone: Dublin (01) 419 8800 Fax: Dublin (01) 419 8890 International code: (003631)




Follow us @meuk_les Follow us @green_gateway

3.3 Data Sheet - Big Foot

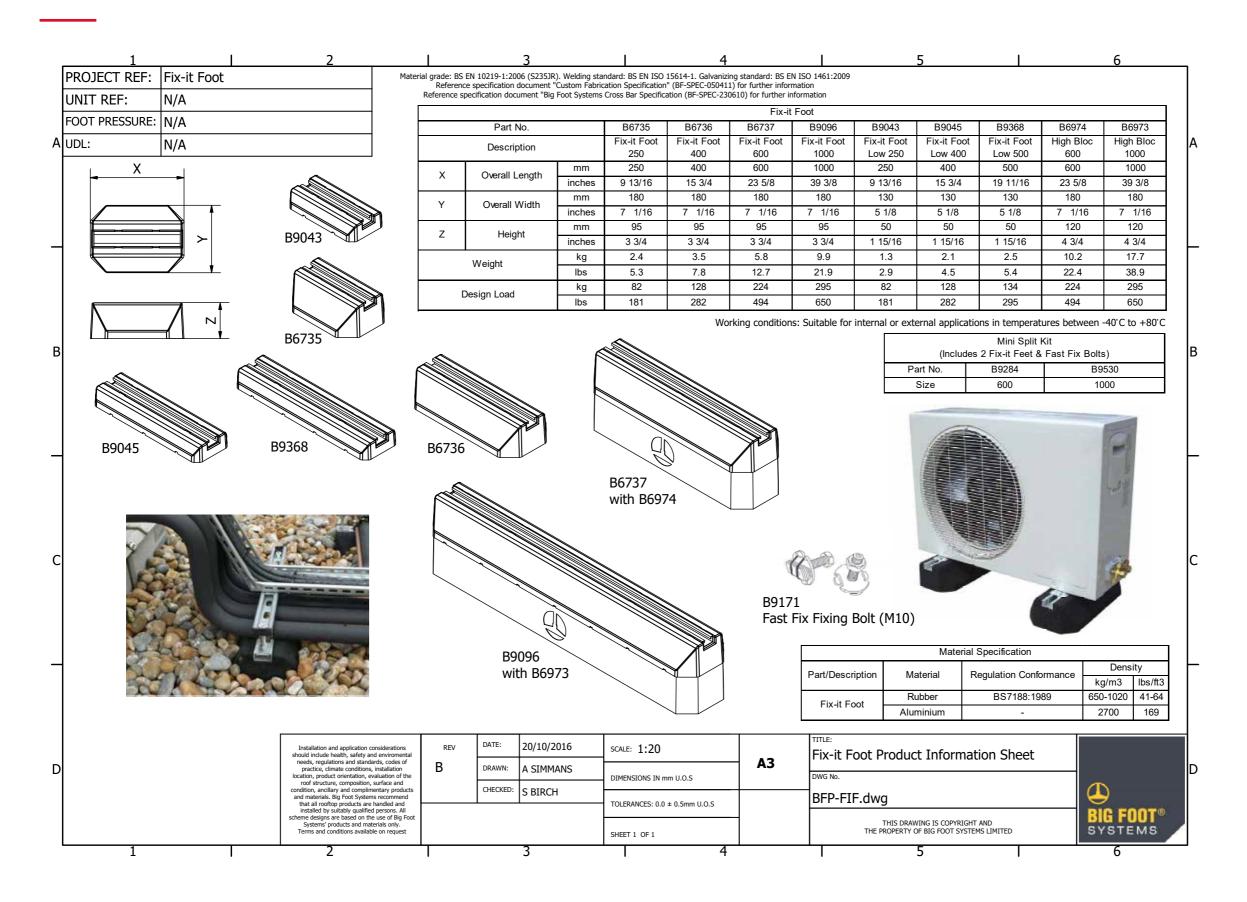



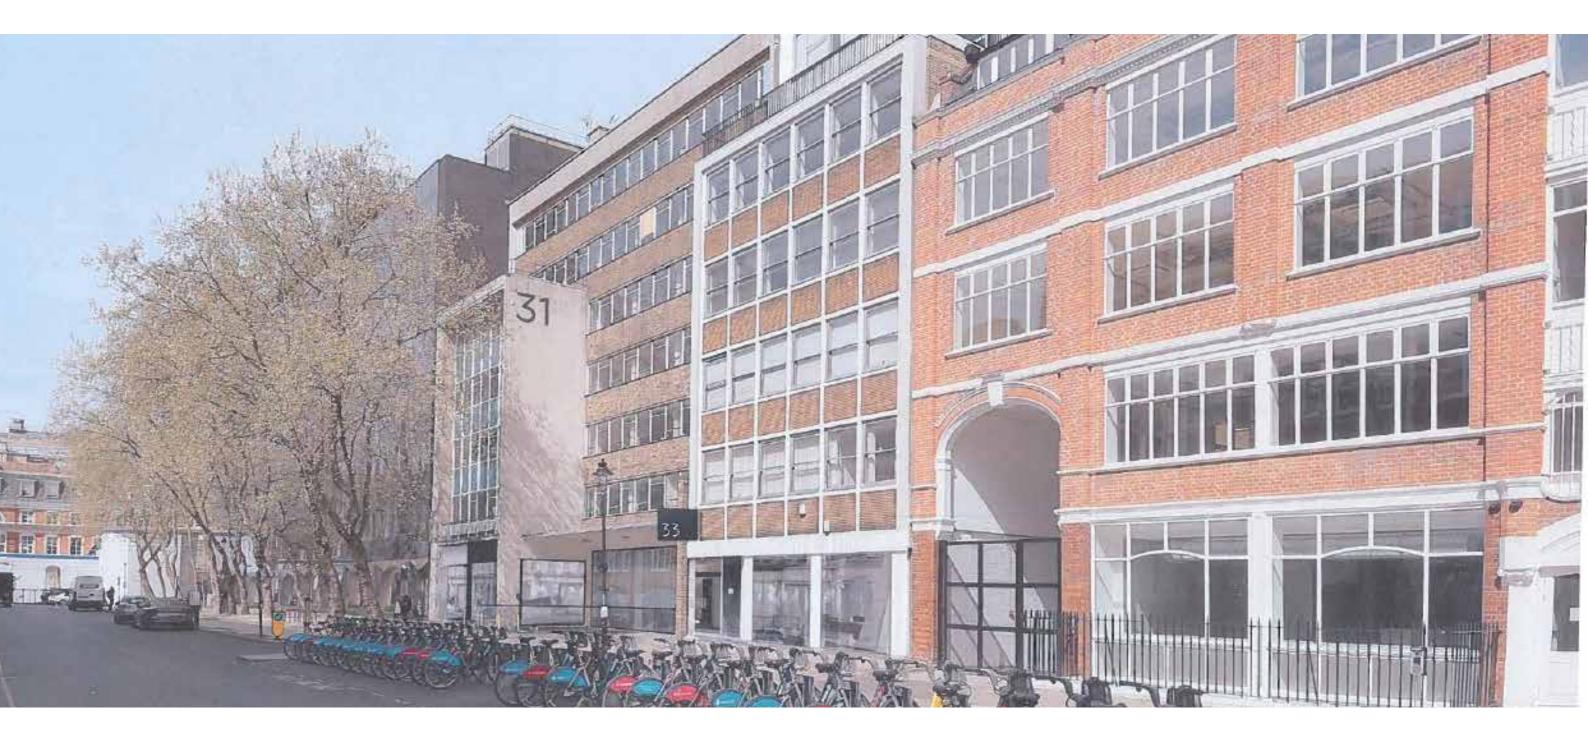

TateHindle Limited
1 Lindsey Street
Smithfield
London
EC1A 9HP