	· · · · · · · · · · · · · · · · · · ·)	(· · · · · · · · · · · · · · · · · · ·												
DB External	Windows And D	oors Schedu	le (- -		3											
Location		3		DB_EXT BASE	EMENT (CONC)												
Window Ref	N DB-ED-BO-01B	BB-ED-BO-02	DB-ED-BO-03	DB-W-BO-01A	DB-W-BO-01C	OB-ED-GF-14	DB-ED-GF-18	DB-ED-GF-20	DB-ED-GF-22	DB-ED-GF-27	DB-W-GF-01	DB-W-GF-02	DB-W-GF-03	DB-W-GF-04	DB-W-GF-05	DB-W-GF-06	DB-W-GF-07
H+R Reference	Y N/A	N/A	N/A	N/A	N/A	DB-0-W20	DB-0-W16	DB-0-W14	DB-0-W12	N/A	DB-0-W32	DB-0-W31	DB-0-W30	DB-0-W29	DB-0-W28	DB-0-W27	DB-0-W26
Approx W x H Size	1,716x2,250	,404x2,460	1,404x2,460			905x2,479	1,156x2,549	1,300x2,380	870x2,324	1,068x2,264	1,100x1,915	1,100x1,915	800x1,915	1,100x1,915	800x1,915	1,100x1,915	1,100x1,915
Elevation				Please refer to plans and elevations for more detail.	Please refer to plans and elevations for more detail.												
Status	New Double Door	New Double Door	New Double Do	or Structural Screen	Structural Screen	New Door	New Door	New Door	New Door	Existing Door	Existing Window	Existing Window	Existing Window	Existing Window	Existing Window	Existing Window	Existing Window
Glazing	Structural Glazing	Single Glazing	Single Glazing	Structural Glazing	Structural Glazing	Single Glazed	Single Glazed	N/A	Single Glazed	N/A	Single Glazed Opaque	Single Glazed	Single Glazed	Single Glazed	Single Glazed	Single Glazed	Single Glazed Opaque
External Frame Colour	N/A	White	White	N/A	N/A	White	White	Royal Blue	White	Royal Blue	White	White	White	White	White	White	White
Description	Structural glass double door opening out	Timber double door with 12 no panes each. Opening out	Timber double door with 12 no panes each. Opening out	conciege with set	three sides of conciege with set of double door ref	15 panes timber door opening out		4 paneled timber door opening in	12 pane door with fixed 3 no panes over, 8 panes fixed panels with 2 panes over to each side.	4 paneled timber door opening in	Timber sash window with 6 over 6 window pane arrangement.	Timber sash window with 6 over 6 window pane arrangement.	Timber sash window with 4 over 4 window pane arrangement.	Timber sash window with 6 over 6 window pane arrangement.	Timber sash window with 4 over 4 window pane arrangement.	Timber sash window with 6 over 6 window pane arrangement.	Timber sash window with 6 over 6 window pane arrangement.
Proposed Approach	To manufacturer recomendations	N/A	N/A	To manufacturer recomendations		N/A	N/A	New door to match existing ref: DB-ED- GF-27	N/A	Completely refurbish and repair existing door, including incorporating draught stripping. Door to be eased.	Completely refurbish and repair existing window, including incorporating draught stripping. Window to be eased. Glazing to be replaced with opaque.	Completely refurbish and repair existing window, including incorporating draught stripping.	incorporating	incorporating	incorporating	incorporating	Completely refurbish and repair existing window, including incorporating draught stripping. Glazing to be replaced with opaque.
Ironmongery		New ironmongery match existing in style through out the building. Additional latches to be installed.	0	n It N/A	N/A	New ironmongery match existing in style through out the building. Additional latches to be installed.	style through out the building.		match existing in style through out the	New ironmongery match existing in style through out the building. Additional latches to be installed.	new to match existing in style	Existing ironmongery to be replaced with new to match existing in style through out the building. Additional latches to be installed.	new to match existing in style through out the building.	be replaced with new to match existing in style through out the building.	Existing ironmongery to be replaced with new to match existing in style through out the building. Additional latches to be installed.	Existing ironmongery to be replaced with new to match existing in style through out the building. Additional latches to be installed.	Existing ironmongery to be replaced with new to match existing in style through out the building. Additional latches to be installed.

Europe (

To be developed further ———

To be developed further ———

DIMENSION AT ORIGINAL SHEET SIZE
Contractors must check all dimensions on site. Only figured dimensions are to be worked from.
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KEY PLAN

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CONSTRUCTION

	REVISION	DR'N	CH'KD	DATE
C1	Issue for Construction	KrC	TW	02/12/201



CLIENT MOUNT ANVIL LTD



PROJECT
KIDDERPORE AVENUE

DRAWING
Dudin Brown
External Window And Door

External Window And Door Schedule Sheet 1 of 5

 SCALE
 1:1 @ A1
 DATE

 December 2016
 December 2016


 DRAWING No.
 DRAWN BY

 4 To 230
 KrC


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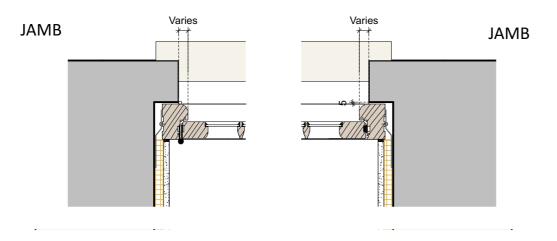
 9000-DRG-DB-001
 C1

A&Q PARTNERSHIP (LONDON) LTD
THE LUX BUILDING, 2-4 HOXTON SQUARE, LONDON N 1 6 NU
Tel: 020 7613 2244 Fax: 020 7613 2642 Email:london@aqp.co.uk
ARCHITECTURE DESIGN MASTERPLANNING INTERIORS

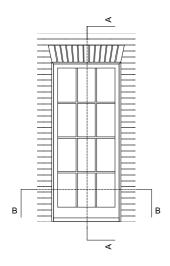



Typical Door Elevation 1:50



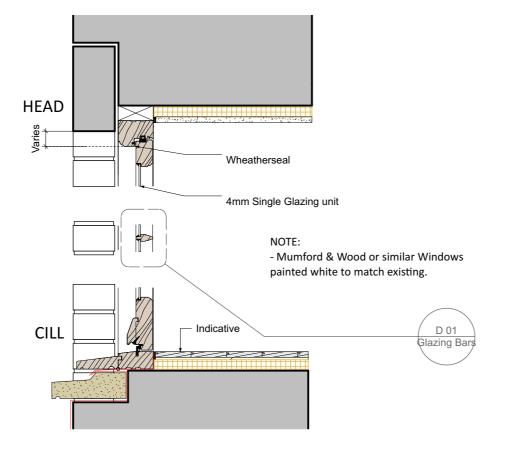


TYPICAL CONSERVATION DOORSET. HEAD, CILL & JAMB DETAIL

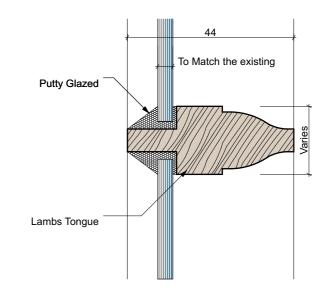

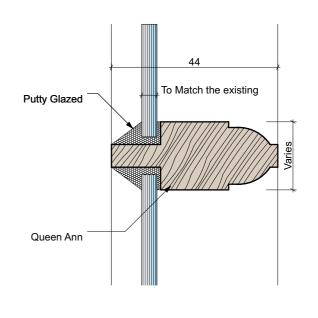


D01 - Glazing Bars - Type to suit existing Heritage Building

1:10

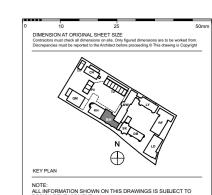

FOR TENDER

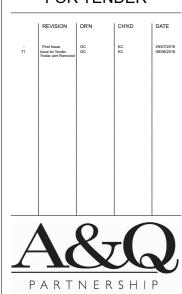

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PROJECT KIDDERPORE AVENUE

Generally Applicable
Typical New Timber Door Detail


DATE August 2016

DRAWING No. DRAWN BY GC 9000-DRG-00GN- DE020

T1

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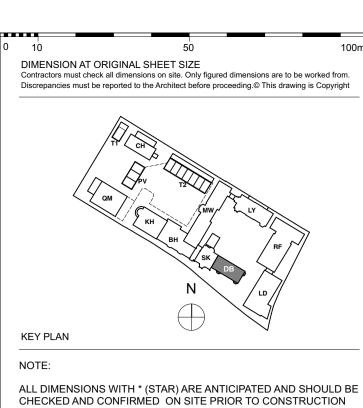


No. Material Name
Structural glass balustrade by Handrail Design or similar. Top rail colour - black.
Metal railing finished in black gloss paint.
Existing roof repairs as drawing 9000-DRG-00GN-DE016.

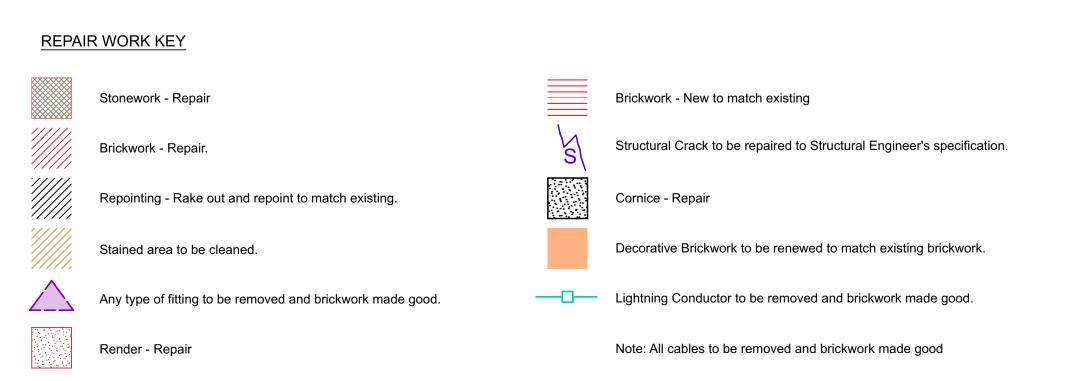
9x6" black painted cast iron vent
 Heritage range cast aluminium RWP finished in gloss black paint
 Structural glazing

New timber window by Mummford and Wood or similar, colour to match existing New timber door by Mummford and Wood or similar, colour to match existing Metal facia to new balcony colour white New stone coping to match existing Metal facia to new terrace colour white

Metal facia to new terrace colour white Existing brickwork New Lead covered canopy to match existing New Brick to match existing



CONSTRUCTION

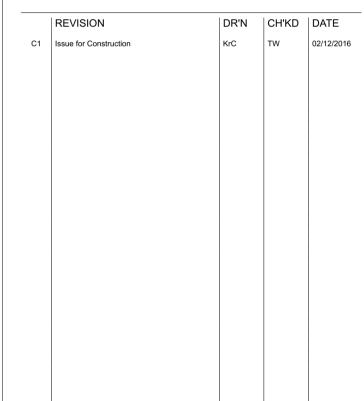



MOUNT ANVIL LTD



PROJECT
KIDDERPORE AVENUE

DRAWING
Dudin Brown
South Elevation As Proposed

SCALE 1:50 @ A1 DATE

December 2016


DRAWING No. DRAWN BY

GC

REV

9000-DRG-02DB-EL001 C1

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ARCHITECTURE DESIGN MASTERPLANNING INTERIORS

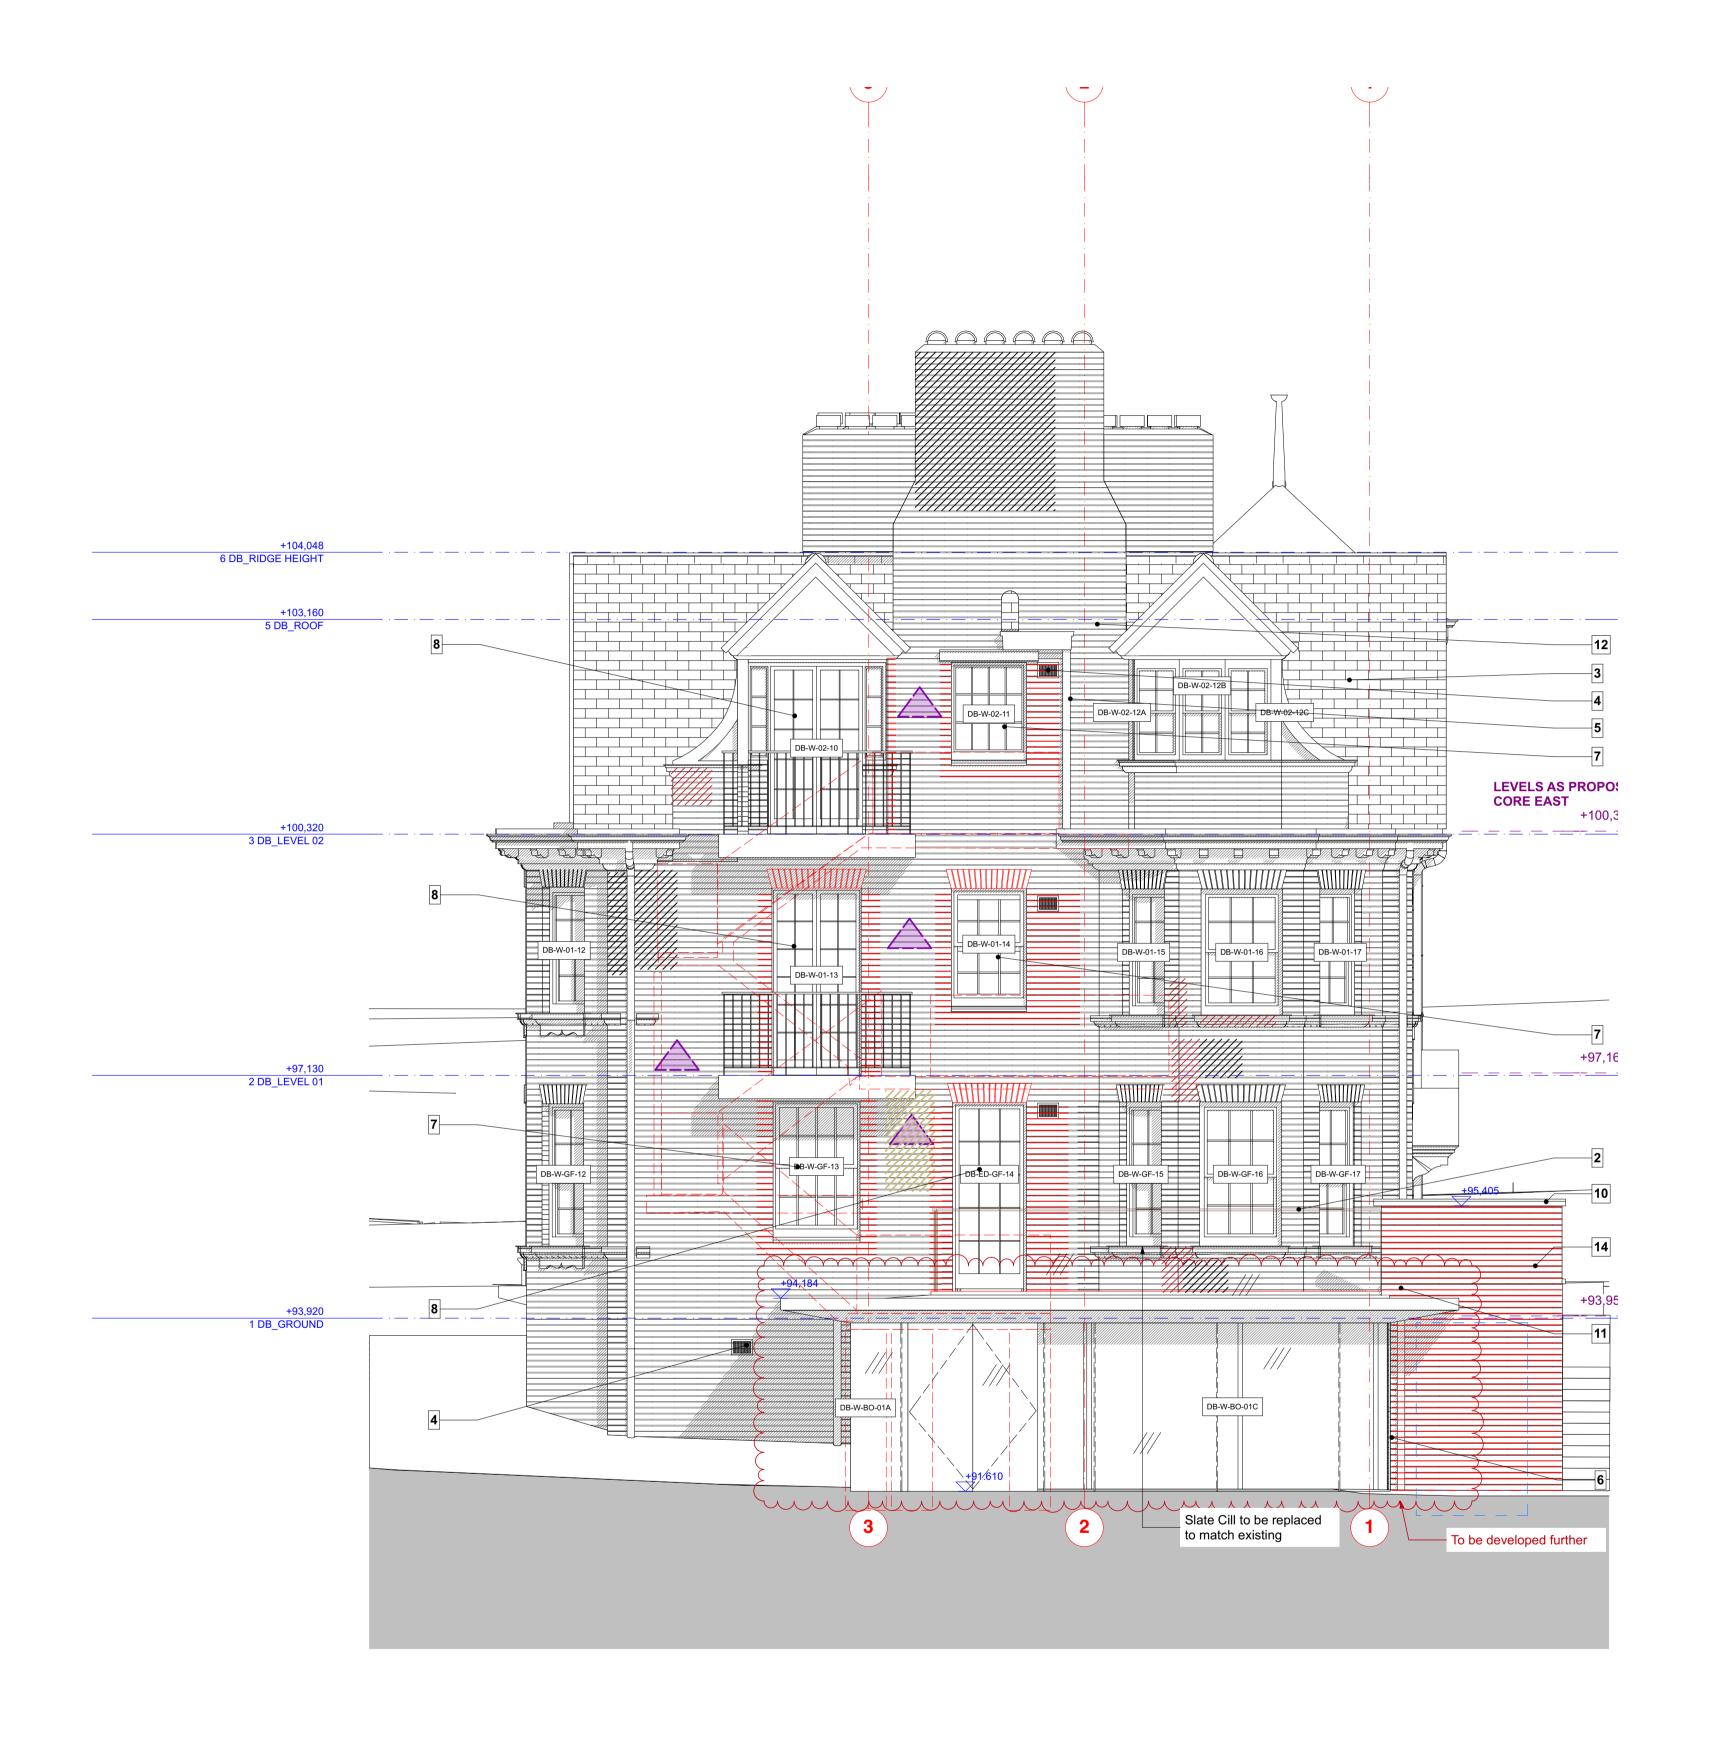



Render - Repair

Stonework - Repair Brickwork - New to match existing Structural Crack to be repaired to Structural Engineer's specification. Brickwork - Repair. Repointing - Rake out and repoint to match existing. Cornice - Repair Decorative Brickwork to be renewed to match existing brickwork. Stained area to be cleaned. Any type of fitting to be removed and brickwork made good. Lightning Conductor to be removed and brickwork made good.

Note: All cables to be removed and brickwork made good

Material Name

Structural glass balustrade by Handrail Design or similar. Top rail colour - black.

Metal railing finished in black gloss paint.

Existence from the property of the property 9x6" black painted cast iron vent Heritage range cast aluminium RWP finished in gloss black paint

Structural glazing New timber window by Mummford and Wood or similar, colour to match existing New timber door by Mummford and Wood or similar, colour to match existing

Metal facia to new balcony colour white New stone coping to match existing Metal facia to new terrace colour white

Existing brickwork New Lead covered canopy to match existing New Brick to match existing


DIMENSION AT ORIGINAL SHEET SIZE

Contractors must check all dimensions on site. Only figured dimensions are to be worked from.

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CONSTRUCTION



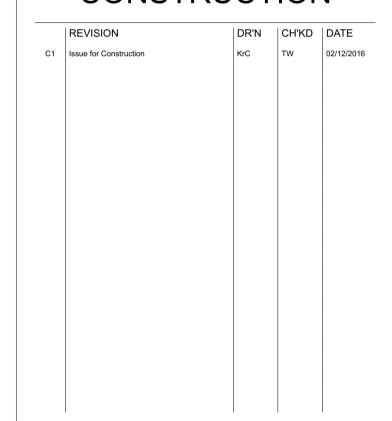

MOUNT ANVIL LTD



KIDDERPORE AVENUE

Dudin Brown East Elevation As Proposed

SCALE DATE 1:50 @ A1 December 2016 DRAWING No. DRAWN BY 15 230 9000-DRG-02DB-EL002

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Lightning Conductor to be removed and brickwork made good.

Note: All cables to be removed and brickwork made good

Any type of fitting to be removed and brickwork made good.

Render - Repair

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ARCHITECTURE DESIGN MASTERPLANNING INTERIORS

Metal facia to new balcony colour white

New Lead covered canopy to match existing

New stone coping to match existing Metal facia to new terrace colour white

Existing brickwork

New Brick to match existing

Location																	DB_GROUND	
Window Ref	DB-W-GF-08	DB-W-GF-09	DB-W-GF-10	DB-W-GF-11	DB-W-GF-12	DB-W-GF-13	DB-W-GF-15	DB-W-GF-16	DB-W-GF-17	DB-W-GF-19	DB-W-GF-21	DB-W-GF-23	DB-W-GF-24	DB-W-GF-25	DB-W-GF-26	DB-W-GF-28	DB-W-GF-29	DB-W-01-01
H+R Reference	DB-0-W25	DB-0-W24	DB-0-W23	DB-0-W22	DB-0-W21	N/A	DB-0-W19	DB-0-W18	DB-0-W17	DB-0-W15	DB-0-W13	DB-0-W11	DB-0-W10	DB-0-W9	DB-0-W8	DB-0-W7	DB-0-W6	DB-1-W28
Approx W x H Size	1,100x1,915	1,100x1,915	800x1,915	1,100x1,915	800x1,915	1,300x1,875	800x1,915	1,100x1,915	800x1,915	1,100x1,915	1,100x1,915	1,100x1,915	800x1,915	800x1,915	800x1,915	1,175x1,950	1,175x1,800	1,100x1,675
Elevation																		
Status	Existing Window	Existing Window	Existing Window	Existing Window	Existing Window	New Window	Existing Window	Existing Window	Existing Window	Existing Window	Existing Window	Existing Window	Existing Window	Existing Window	Existing Window	Existing Window	Existing Window	Existing Window
Glazing	Single Glazed	Single Glazed	Single Glazed	Single Glazed	Single Glazed	Single Glazed	Single Glazed	Single Glazed	Single Glazed	Single Glazed	Single Glazed	Single Glazed Opaque	Single Glazed	Single Glazed	Single Glazed	Single Glazed	Single Glazed	Single Glazed Opaque
External Frame Colour	White	White	White	White	White	White	White	White	White	White	White	White	White	White	White	White	White	White
Description	Timber sash window with 6 over 6 window pane arrangement.	Timber sash window with 6 over 6 window pane arrangement.	Timber sash window with 4 over 4 window pane arrangement.	Timber sash window with 6 over 6 window pane arrangement.	Timber sash window with 4 over 4 window pane arrangement.	Timber sash window with 8 over 8 window pane arrangement.	Timber sash window with 4 over 4 window pane arrangement.	Timber sash window with 6 over 6 window pane arrangement.	Timber sash window with 4 over 4 window pane arrangement.	Timber sash window with 6 over 6 window pane arrangement.	Timber sash window with 6 over 6 window pane arrangement.	Timber sash window with 6 over 6 window pane arrangement.	Timber sash window with 4 over 4 window pane arrangement.	Timber sash window with 4 over 4 window pane arrangement.	Timber sash window with 4 over 4 window pane arrangement.	Timber sash window with 6 over 6 window pane arrangement.	Timber sash window with 6 over 6 window pane arrangement.	Timber sash window with 6 over 6 window pane arrangement.
Proposed Approach	Completely refurbish and repair existing window, including incorporating draught stripping.	Completely refurbish and repair existing window, including incorporating draught stripping.	Completely refurbish and repair existing window, including incorporating draught stripping. Window to be eased. External timber cill to be replaced to match existing.	Completely refurbish and repair existing window, including incorporating draught stripping. Window to be eased. External timber cill to be raised.	Completely refurbish and repair existing window, including incorporating draught stripping. Window to be eased. External timber cill to be replaced to match existing.	N/A	incorporating	Completely refurbish and repair existing window, including incorporating draught stripping.	Completely refurbish and repair existing window, including incorporating draught stripping.	Completely refurbish and repair existing window, including incorporating draught stripping.	incorporating	Completely refurbish and repair existing window, including incorporating draught stripping. Top louvers to be replaced for 3 no planes. Glazing to be replaced with opaque.	Completely refurbish and repair existing window, including incorporating draught stripping. Top louvers to be replaced for 2 no planes. Opaque glass replaces with clear.	Completely refurbish and repair existing window, including incorporating draught stripping. Top louvers to be replaced for 2 no planes. Opaque glass replaces with clear.	Completely refurbish and repair existing window, including incorporating draught stripping. Top louvers to be replaced for 2 no planes. Opaque glass replaces with clear.	Completely refurbish and repair existing window, including incorporating draught stripping.	Completely refurbish and repair existing window, including incorporating draught stripping.	Completely refurbish and repair existing window, including incorporating draught stripping Timber fixed to pulley lining to be removed. Glazing to be replaced with opaque.
Ironmongery	Existing ironmongery to be replaced with new to match existing in style through out the building. Additional latches to be installed.	new to match existing in style	Existing ironmongery to be replaced with new to match existing in style through out the building. Additional latches to be installed.	Existing ironmongery to be replaced with new to match existing in style through out the building. Additional latches to be installed.	Existing ironmongery to be replaced with new to match existing in style through out the building. Additional latches to be installed.	New ironmongery match existing in style through out the building. Additional latches to be installed.	bullaling.	Existing ironmongery to be replaced with new to match existing in style through out the building. Additional latches to be installed.	Existing ironmongery to be replaced with new to match existing in style through out the building. Additional latches to be installed.	Existing ironmongery to be replaced with new to match existing in style through out the building. Additional latches to be installed.	Existing ironmongery to be replaced with new to match existing in style through out the building. Additional latches to be installed.	Existing ironmongery to be replaced with new to match existing in style through out the building. Additional latches to be installed.	Existing ironmongery to be replaced with new to match existing in style through out the building. Additional latches to be installed.	Existing ironmongery to be replaced with new to match existing in style through out the building. Additional latches to be installed.	Existing ironmongery to be replaced with new to match existing in style through out the building. Additional latches to be installed.	Existing ironmongery to be replaced with new to match existing in style through out the building. Additional latches to be installed.	Existing ironmongery to be replaced with new to match existing in style through out the building. Additional latches to be installed.	Existing ironmongery to be replaced with new to match existing in style through out the building. Additional latched to be installed.

DIMENSION AT ORIGINAL SHEET SIZE
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CONSTRUCTION

	REVISION	DR'N	N CH'KD	DATE
C1	Issue for Construction	KrC	TW	02/12/201



CLIENT MOUNT ANVIL LTD



December 2016

DRAWN BY

KrC REV

PROJECT
KIDDERPORE AVENUE

DRAWING
Dudin Brown
External Window And Door Schedule Sheet 2 of

5 SCALE 1:1 @ A1 DATE

15 230 9000-DRG-DB-002

DRAWING No.

A & Q PARTNERSHIP (LONDON) LTD
THE LUX BUILDING, 2-4 HOXTON SQUARE, LONDON N 1 6 NU
Tel: 020 7613 2244 Fax: 020 7613 2642 Email:london@aqp.co.uk
ARCHITECTURE DESIGN MASTERPLANNING INTERIORS

Location																		
Window Ref	DB-W-01-02	DB-W-01-03	DB-W-01-04	DB-W-01-05	DB-W-01-06	DB-W-01-07	DB-W-01-08	DB-W-01-09	DB-W-01-10	DB-W-01-11	DB-W-01-12	DB-W-01-13	DB-W-01-14	DB-W-01-15	DB-W-01-16	DB-W-01-17	DB-W-01-18	DB-W-01-19
H+R Reference	DB-1-W27	DB-1-W26	DB-1-W25	DB-1-W24	DB-1-W23	DB-1-W22	DB-1-W21	DB-1-W20	DB-1-W19	DB-1-W18	DB-1-W17	N/A	DB-1-W16	DB-1-W15	DB-1-W14	DB-1-W13	DB-1-W12	DB-1-W11
Approx W x H Size	1,100x1,675	800x1,675	1,100x1,675	800x1,675	1,100x1,675	1,100x1,675	1,100x1,675	1,100x1,675	800x1,675	1,100x1,675	800x1,675	1,300x2,532	1,144x1,633	800x1,675	1,100x1,675	800x1,675	1,100x1,675	1,100x1,675
Elevation																		
Status	Existing Window	Existing Window	Existing Window	Existing Window	Existing Window	Existing Window	Existing Window	Existing Window	Existing Window	Existing Window	Existing Window	New Door	Existing Window	Existing Window	Existing Window	Existing Window	Existing Window	Existing Window
Glazing	Single Glazed	Single Glazed	Single Glazed	Single Glazed	Single Glazed	Single Glazed	Single Glazed Opaque	Single Glazed	Single Glazed	Single Glazed	Single Glazed	Single Glazed	Single Glazed	Single Glazed	Single Glazed	Single Glazed	Single Glazed	Single Glazed
External Frame Colour	White	White	White	White	White	White	White	White	White	White	White	White	White	White	White	White	White	White
Description	Timber sash window with 6 over 6 window pane arrangement.	Timber sash window with 4 over 4 window pane arrangement.	Timber sash window with 6 over 6 window pane arrangement.	Timber sash window with 4 over 4 window pane arrangement.	Timber sash window with 6 over 6 window pane arrangement.	Timber sash window with 6 over 6 window pane arrangement.	Timber sash window with 6 over 6 window pane arrangement.	Timber sash window with 6 over 6 window pane arrangement.	Timber sash window with 4 over 4 window pane arrangement.	Timber sash window with 6 over 6 window pane arrangement.	Timber sash window with 4 over 4 window pane arrangement.	A pair of side hung doors 12no panes each.	Timber sash window with 6 over 6 window pane arrangement.	Timber sash window with 4 over 4 window pane arrangement.	Timber sash window with 6 over 6 window pane arrangement.	Timber sash window with 4 over 4 window pane arrangement.	Timber sash window with 6 over 6 window pane arrangement.	Timber sash window with 6 over 6 window pane arrangement.
Proposed Approach	Completely refurbish and repair existing window, including incorporating draught stripping. Timber fixed to pulley lining to be removed. All decaying timber to be replaced to match existing.	window, including	draught stripping. Timber fixed to pulley lining to be	Completely refurbish and repair existing window, including incorporating draught stripping. Timber fixed to pulley lining to be removed.	Completely refurbish and repair existing window, including incorporating draught stripping. Timber fixed to pulley lining to be removed. External timber cill to be raised.	window, including incorporating draught stripping.	draught stripping. Timber fixed to pulley lining to be	Completely refurbish and repair existing window, including incorporating draught stripping. Timber fixed to pulley lining to be removed.	Completely refurbish and repair existing window, including incorporating draught stripping. Timber fixed to pulley lining to be removed.	Completely refurbish and repair existing window, including incorporating draught stripping. Timber fixed to pulley lining to be removed.	Completely refurbish and repair existing window, including incorporating draught stripping. Timber fixed to pulley lining to be removed.	N/A	Completely refurbish and repair existing window, including incorporating draught stripping.	Timber fixed to	Completely refurbish and repair existing window, including incorporating draught stripping. Timber fixed to pulley lining to be removed.	Completely refurbish and repair existing window, including incorporating draught stripping.	Completely refurbish and repair existing window, including incorporating draught stripping. Timber fixed to pulley lining to be removed.	incorporating draught stripping. Timber fixed to
Ironmongery	Existing ironmongery to be replaced with new to match existing in style through out the building. Additional latches to be installed.	Existing ironmongery to be replaced with new to match existing in style through out the building. Additional latches to be installed.	Existing ironmongery to be replaced with new to match existing in style through out the building. Additional latches	Existing ironmongery to be replaced with new to match existing in style through out the building. Additional latches	Existing ironmongery to be replaced with new to match existing in style through out the building. Additional latches	new to match existing in style through out the building.	Existing ironmongery to be replaced with new to match existing in style through out the building. Additional latches	Existing ironmongery to be replaced with new to match existing in style through out the building. Additional latches	Existing ironmongery to be replaced with new to match existing in style through out the building. Additional latches	Existing ironmongery to be replaced with new to match existing in style through out the building.	Existing ironmongery to be replaced with new to match existing in style through out the building. Additional latches	New ironmongery match existing in style through out the building. Additional latches to be installed.	building.	Existing ironmongery to be replaced with new to match existing in style through out the building.	Existing ironmongery to be replaced with new to match existing in style through out the building. Additional latches	Existing ironmongery to be replaced with new to match existing in style through out the building. Additional latches	Existing ironmongery to be replaced with new to match existing in style through out the building. Additional latches	Existing ironmongery to be replaced with new to match existing in style through out the building. Additional latches

DIMENSION AT ORIGINAL SHEET SIZE

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CONSTRUCTION

	REVISION	1	DR'N	CH'KD	DATE
C1	Issue for Construction	1	KrC	TW	02/12/201



CLIENT MOUNT ANVIL LTD



DATE

December 2016

DRAWN BY

PROJECT
KIDDERPORE AVENUE

DRAWING

Dudin Brown

External Window And Door Schedule Sheet 3 of

1:1 @ A1

DRAWING No. 15 230

SCALE

KrC REV 9000-DRG-DB-003

A&Q PARTNERSHIP (LONDON) LTD THE LUX BUILDING, 2-4 HOXTON SQUARE, LONDON N 1 6 NU Tel: 020 7613 2244 Fax: 020 7613 2642 Email:london@aqp.co.uk ARCHITECTURE DESIGN MASTERPLANNING INTERIORS

													T					
Location												DB_LEVEL 01						
Window Ref	DB-W-01-20	DB-W-01-21	DB-W-01-22A	DB-W-01-22B	DB-W-01-22C	DB-W-01-23	DB-W-01-24	DB-W-01-25	DB-W-01-26	DB-W-01-27	DB-W-01-28	DB-W-01-29	DB-W-02-01	DB-W-02-02	DB-W-02-03	DB-W-02-04	DB-W-02-05	DB-W-02-06
H+R Reference	DB-1-W10	DB-1-W9	DB-1-W8	DB-1-W8	DB-1-W8	DB-1-W7	DB-1-W6	DB-1-W5	DB-1-W4	DB-1-W3	DB-1-W2	DB-1-W1	DB-2-W21	DB-2-W20	DB-2-W19	DB-2-W18	DB-2-W17	DB-2-W16
Approx W x H Size	1,100x1,675	1,100x1,675	650x1,675	875x1,675	650x1,675	1,100x1,675	800x1,675	800x1,675	800x1,675	1,175x1,810	1,175x1,340	1,175x1,340	820x1,360	820x1,360	820x1,360	1,175x1,360	820x1,360	820x1,360
Elevation																		
Status	Existing Window	Existing Window	Existing Window	Existing Window	Existing Window	Existing Window	Existing Window	Existing Window	Existing Window	Existing Window	Existing Window	Existing Window	Existing Window	Existing Window	Existing Window	Existing Window	Existing Window	Existing Window
Glazing	Single Glazed	Single Glazed	Single Glazed	Single Glazed	Single Glazed	Single Glazed Opaque	Single Glazed	Single Glazed	Single Glazed	Single Glazed	Single Glazed	Single Glazed	Single Glazed Opaque	Single Glazed	Single Glazed	Single Glazed	Single Glazed	Single Glazed
External Frame Colour	White	White	White	White	White	White	White	White	White	White	White	White	White	White	White	White	White	White
Description	Timber sash window with 6 over 6 window pane arrangement.	Timber sash window with 6 over 6 window pane arrangement.	Part of 3no sash Window. Timber sash window with 4 over 4 window pane arrangement.	Part of 3no sash Window. Timber sash window with 6 over 6 window pane arrangement.	Window. Timber	Timber sash window with 6 over 6 window pane arrangement.	Timber sash window with 4 over 4 window pane arrangement.	Timber sash window with 4 over 4 window pane arrangement.	Timber sash window with 4 over 4 window pane arrangement.	Timber sash window with 6 over 6 window pane arrangement.	Timber sash window with 6 over 6 window pane arrangement.	Timber sash window with 6 over 6 window pane arrangement.	Timber sash window with 6 over 6 window pane arrangement.	Timber sash window with 6 over 6 window pane arrangement.	Timber sash window with 6 over 6 window panearrangement	1 no. timber sash window with a 6 over 6 window panearrangement. The upper sash was arch headed. 2 no. sidehung timber casement windows either side of the timber sash.	Timber sash window with 6 over 6 window pane arrangement.	Timber sash window with 6 over 6 window pane arrangement.
Proposed Approach	Completely refurbish and repair existing window, including incorporating draught stripping. Timber fixed to pulley lining to be removed.	Completely refurbish and repair existing window, including incorporating draught stripping. Timber fixed to pulley lining to be removed.	Completely refurbish and repair existing window, including incorporating draught stripping. Window to be eased.	Completely refurbish and repair existing window, including incorporating draught stripping. Window to be eased.	Completely refurbish and repair existing window, including incorporating draught stripping. Window to be eased.	Completely refurbish and repair existing window, including incorporating draught stripping. Top louvers to be replaced for 3 no planes.	Completely refurbish and repair existing window, including incorporating draught stripping. Top louvers to be replaced for 2 no planes. Opaque glass replaces with clear.	draught stripping. Window to be eased. Top	Completely refurbish and repair existing window, including incorporating draught stripping. Top louvers to be replaced for 2 no planes. Opaque glass replaces with clear.	Completely refurbish and repair existing window, including incorporating draught stripping. Timber fixed to pulley lining to be removed.	Completely refurbish and repair existing window, including incorporating draught stripping. Timber fixed to pulley lining to be removed.	Completely refurbish and repair existing window, including incorporating draught stripping. Missing bead to be added to match existing.	Completely refurbish and repair existing window, including incorporating draught stripping. Timber fixed to pulley lining to be removed. External timber cill to be replaced. Glazing to be replaced with opaque.	window, including incorporating draught stripping. Timber fixed to pulley lining to be removed. Glazing	Completely refurbish and repair existing window, including incorporating draught stripping. Timber fixed to pulley lining to be removed. Missing bead to be added. Glazing to be replaced with opaque.	Completely refurbish and repair existing window, including incorporating draught stripping.	Completely refurbish and repair existing window, including incorporating draught stripping. Timber fixed to pulley lining to be removed.	Timber fixed to pulley lining to be
Ironmongery	building.	building.	building.	building. Additional latches	building.	building.	building.	new to match existing in style through out the building.	building.	building.	building.	Existing ironmongery to be replaced with new to match existing in style through out the building. Additional latches to be installed.	building.	building.	Existing ironmongery to be replaced with new to match existing in style through out the building. Additional latches to be installed.	latches to be installed	building.	Existing ironmongery to be replaced with new to match existing in style through out the building. Additional latches to be installed.

DIMENSION AT ORIGINAL SHEET SIZE
Contractors must check all dimensions on site. Only figured dimensions are to be worked from.
Discrepancies must be reported to the Architect before proceeding.® This drawing is Copyright

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	CONST	RU	СТ	101	1
	REVISION		DR'N	CH'KD	DATE
C1	Issue for Construction		KrC	TW	02/12/2016



CLIENT MOUNT ANVIL LTD



PROJECT
KIDDERPORE AVENUE

DRAWING
Dudin Brown
External Window And Do

External Window And Door Schedule Sheet 4 of 5

 SCALE
 1:1 @ A1
 DATE

 December 2016
 DRAWING No.
 DRAWN BY

 KrC
 REV

9000-DRG-DB-004 C1

A & Q PARTNERSHIP (LONDON) LTD

THE LUX BUILDING, 2-4 HOXTON SQUARE, LONDON N 1 6 NU
Tel: 020 7613 2244 Fax: 020 7613 2642 Email:london@aqp.co.uk

ARCHITECTURE DESIGN MASTERPLANNING INTERIORS

Location																	DB_LEVEL 02	DB [3D REF ONLY]
Window Ref	DB-W-02-07	DB-W-02-08	DB-W-02-09	DB-W-02-11	DB-W-02-12A	DB-W-02-12B	DB-W-02-12C	DB-W-02-13	DB-W-02-14	DB-W-02-15	DB-W-02-16	DB-W-02-17	DB-W-02-18	DB-W-02-19	DB-W-02-20	DB-W-02-21	DB-W-02-22	DB-W-02-10
H+R Reference	DB-2-W15	DB-2-W14	DB-2-W13	N/A	DB-2-W11	DB-2-W11	DB-2-W11	DB-2-W10	DB-2-W9	DB-2-W8	DB-2-W7	DB-2-W6	DB-2-W5	DB-2-W4	DB-2-W3	DB-2-W2	DB-2-W1	DB-2-W12
Approx W x H Size	820x1,360	820x1,360	1,175x1,360	1,144x1,365		1,820x1,360		1,175x1,360	820x1,360	820x1,360	820x1,360	1,175x1,360	820x1,360	820x1,360	820x1,360	1,175x1,175	1,175x1,175	1,220x2,215
Elevation																		
Status	Existing Window	Existing Window	Existing Window	New Window	Existing Window	Existing Window	Existing Window	Existing Window	Existing Window	Existing Window	Existing Window	Existing Window	Existing Window	Existing Window	Existing Window	Existing Window	Existing Window	New Door
Glazing	Single Glazed	Single Glazed	Single Glazed	Single Glazed	Single Glazed	Single Glazed	Single Glazed	Single Glazed	Single Glazed Opaque	Single Glazed	Single Glazed	Single Glazed	Single Glazed	Single Glazed	Single Glazed	Single Glazed	Single Glazed	Single Glazed
External Frame Colour	White	White	White	White	White	White	White	White	White	White	White	White	White	White	White	White	White	White
Description	Timber sash window with 6 over 6 window pane arrangement.	Timber sash window with 6 over 6 window pane arrangement.	1 no. timber sash window with a 6 over 6 window panearrangement. The upper sash was arch headed. 2 no. sidehung timber casement windows either side of the timbersash.	Timber sash window 4 over 8 window pane arrangement.	Part of 3 no timber sash windows each with 4 over 4 window pane arrangements.	Part of 3 no timber sash windows each with 4 over 4 window pane arrangements.	Part of 3 no timber sash windows each with 4 over 4 window pane arrangements.	1 no. timber sash window with a 6 over 6 window panearrangement. The upper sash was arch headed. 2 no. sidehung timber casement windows either side of the timbersash.	Timber sash window with 6 over 6 window pane arrangement.	Timber sash window with 6 over 6 window pane arrangement.	Timber sash window with 6 over 6 window pane arrangement.	1 no. timber sash window with a 6 over 6 window panearrangement. The upper sash was arch headed. 2 no. sidehung timber casement windows either side of the timbersash.	Timber sash window with 6 over 6 window pane arrangement.	Timber sash window with 6 over 6 window pane arrangement.	Timber sash window with 6 over 6 window pane arrangement.	Timber sash window with 3 over 6 window pane arrangement.	Timber sash window with 3 over 6 window pane arrangement.	Timber double door opening out with 12 panes each. 3no panes of fixed glass to each side.
Proposed Approach	Completely refurbish and repair existing window, including incorporating draught stripping. Timber fixed to pulley lining to be removed. Window to be eased.	incorporating draught stripping. Timber fixed to	Completely refurbish and repair existing window, including incorporating draught stripping. Sash to be eased. All decayed timber to be replaced to match exsiting.	N/A	Completely refurbish and repair existing window, including incorporating draught stripping. Sash to be eased. All decayed timber to be replaced to match exsiting.	Completely refurbish and repair existing window, including incorporating draught stripping. Sash to be eased. All decayed timber to be replaced to match exsiting.	Completely refurbish and repair existing window, including incorporating draught stripping. Sash to be eased. All decayed timber to be replaced to match exsiting.	Completely refurbish and repair existing window, including incorporating draught stripping. Window to be eased.	Completely refurbish and repair existing window, including incorporating draught stripping. Window to be eased. Glazing to be replaced with opaque.	Completely refurbish and repair existing window, including incorporating draught stripping. Window to be eased.	Completely refurbish and repair existing window, including incorporating draught stripping. Window to be eased.	Completely refurbish and repair existing window, including incorporating draught stripping. Window to be eased. Arched partying bead to be replaced to match existing.	Completely refurbish and repair existing window, including incorporating draught stripping. Window to be eased. Missing bead to be replaced to match existing.	Completely refurbish and repair existing window, including incorporating draught stripping. Timber fixed to pulley lining to be removed. Window to be eased.	incorporating draught stripping. Timber fixed to	Completely refurbish and repair existing window, including incorporating draught stripping. Partying slip to be replaced.	Completely refurbish and repair existing window, including incorporating draught stripping. Window to be eased.	N/A
Ironmongery	through out the building.	Existing ironmongery to be replaced with new to match existing in style through out the building. Additional latches to be installed.	new to match existing in style through out the building. Additional	match existing in style through out the building. Additional latches	Dananig.	Existing ironmongery to be replaced with new to match existing in style through out the building. Additional latches to be installed.	through out the building.	Existing ironmongery to be replaced with new to match existing in style through out the building. Additional latches to be installed.	Existing ironmongery to be replaced with new to match existing in style through out the building. Additional latches to be installed.	building.	through out the building.	Existing ironmongery to be replaced with new to match existing in style through out the building. Additional latches to be installed.	through out the building.	building.	through out the building.	through out the building.	building.	New ironmongery match existing in style through out the building. Additional latches to be installed.

DIMENSION AT ORIGINAL SHEET SIZE

Contractors must check all dimensions on site. Only figured dimensions are to be worked from.

Discrepancies must be reported to the Architect before proceeding.® This drawing is Copyright KEY PLAN

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CONSTRUCTION

	REVISION	DR'N	CH'KD	DATE
C1	Issue for Construction	KrC	TW	02/12/201





DRAWN BY

KrC REV

PROJECT
KIDDERPORE AVENUE

DRAWING
Dudin Brown
External Window And Door Schedule Sheet 5 of


SCALE 1:1, 1:50 @ A1 DATE December 2016


15 230 9000-DRG-DB-005

DRAWING No.

A&Q PARTNERSHIP (LONDON) LTD THE LUX BUILDING, 2-4 HOXTON SQUARE, LONDON N 1 6 NU Tel: 020 7613 2244 Fax: 020 7613 2642 Email:london@aqp.co.uk

ARCHITECTURE DESIGN MASTERPLANNING INTERIORS

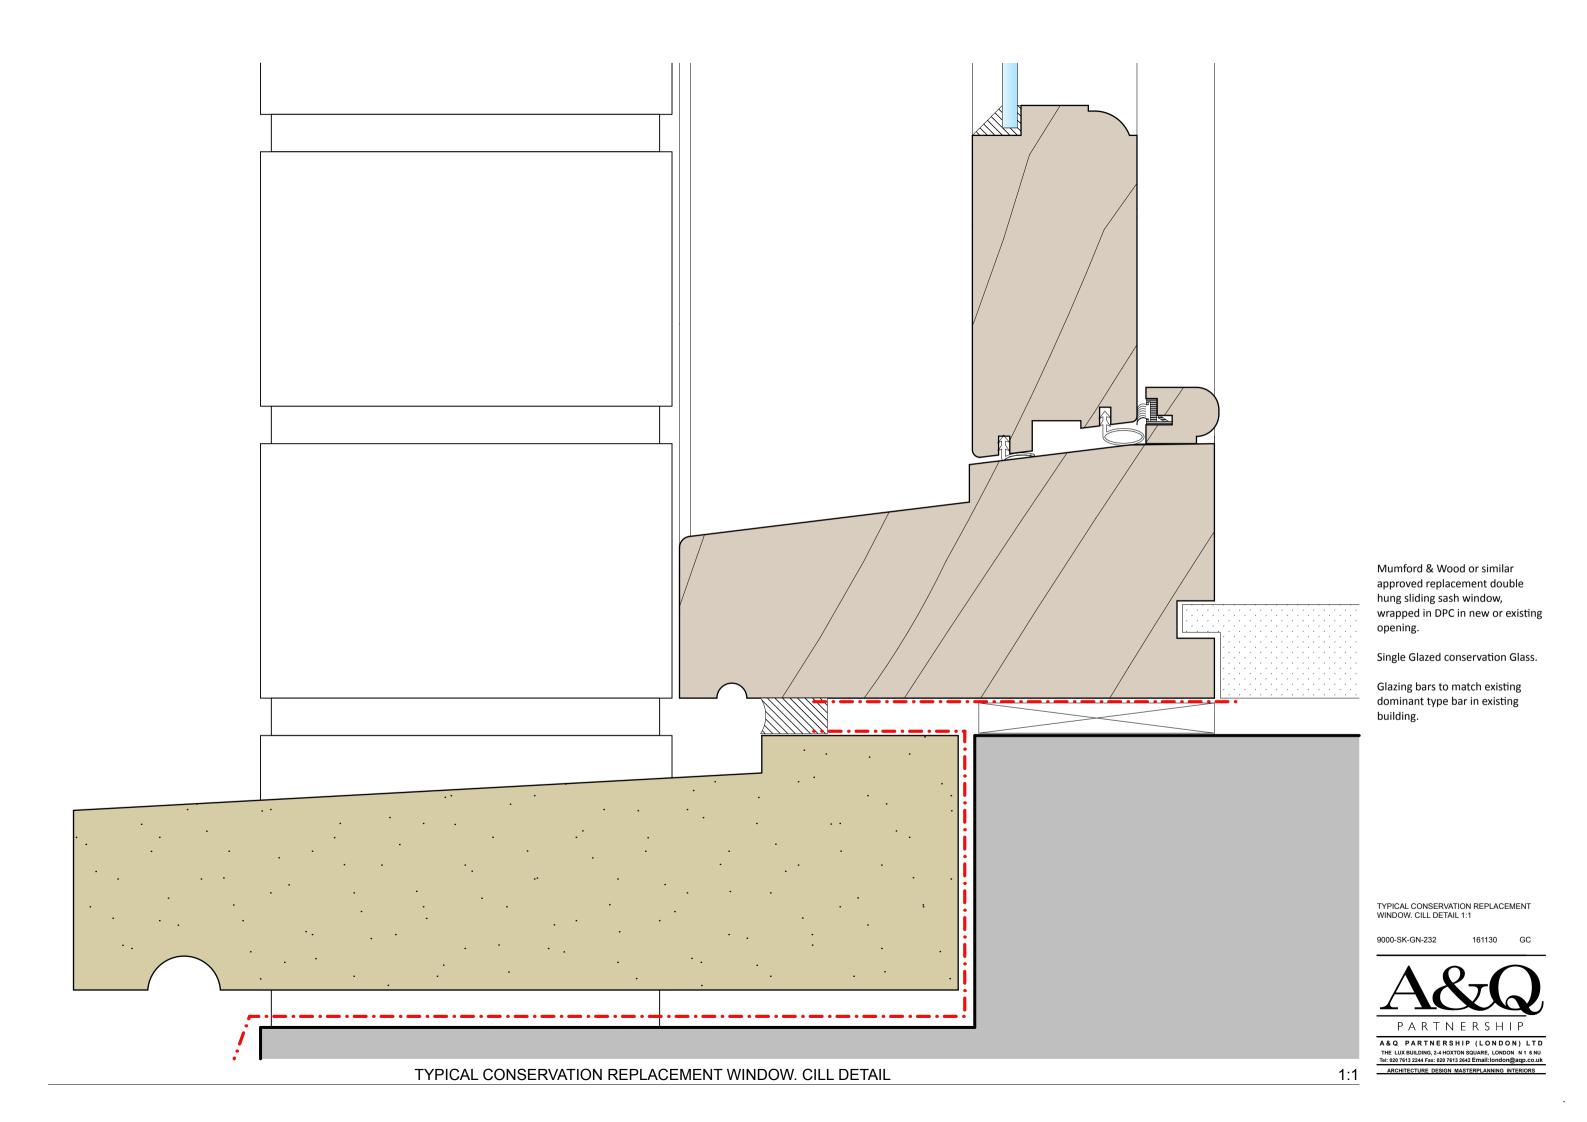

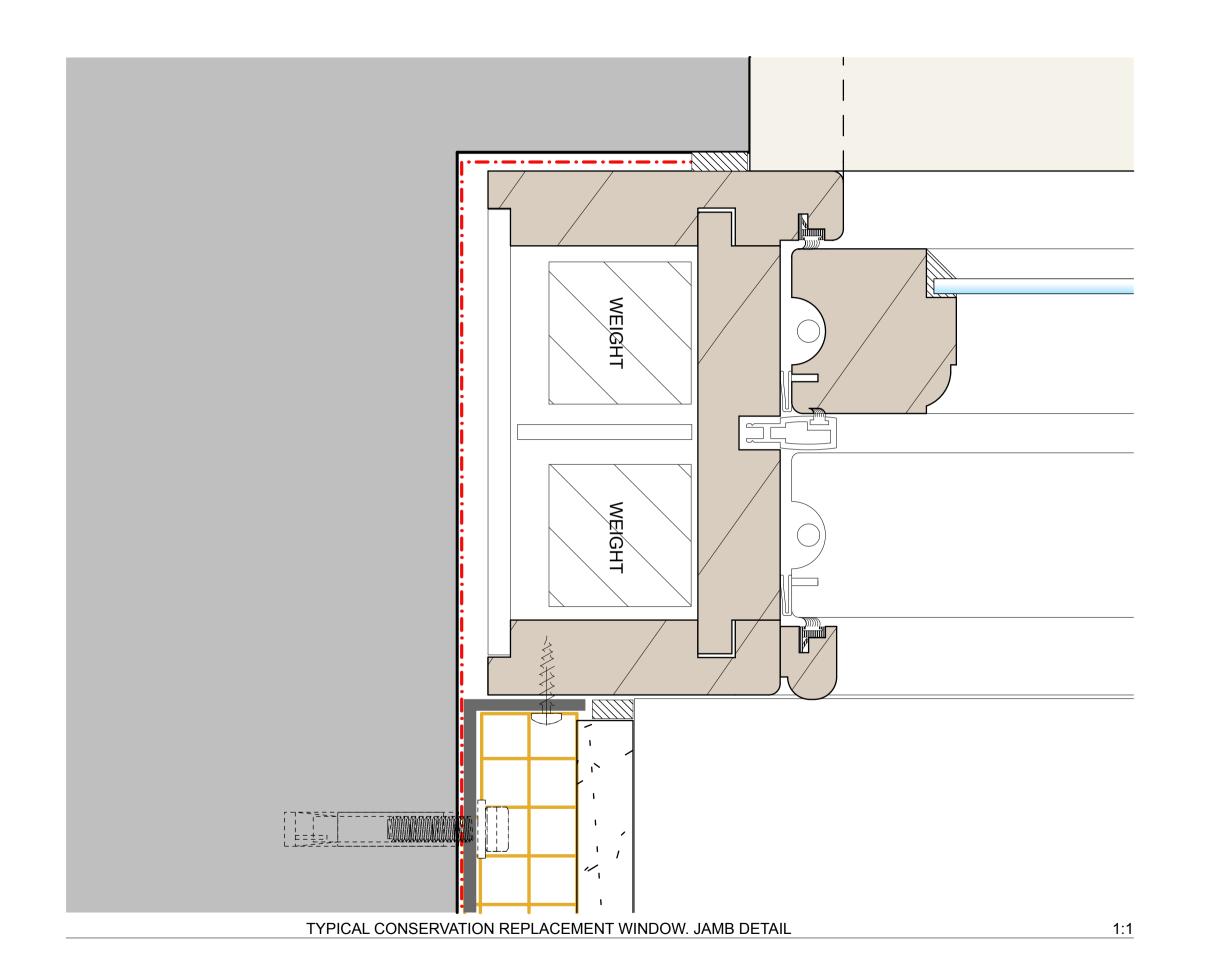

Mumford & Wood or similar approved replacement double hung sliding sash window, wrapped in DPC in new or existing opening.

Single Glazed conservation Glass.

Glazing bars to match existing dominant type bar in existing building.

TYPICAL CONSERVATION REPLACEMENT WINDOW. JAMB DETAIL 1:1

9000-SK-GN-233

161130 GC



A & Q PARTNERSHIP (LONDON) LTD
THE LUX BUILDING, 2-4 HOXTON SQUARE, LONDON N 1 6 NU
Tel: 020 7613 2244 Fax: 020 7613 2642 Email-london@aqp.co.uk