Ref: 11/17802 January 2017

Basement Impact Assessment (Hydrogeological and Structural)

At

Ornan Court, 2 Ornan Road, NW3 4PT

For

Ornan Court Limited

APPENDIX

9. APPENDIX A

CONTENTS

9. APPENDIX A

9.1 Temporary Works

10. APPENDIX B

10.1 Monitoring10.2 Watercourses10.3 Construction Management Plan

9.1 Temporary Works

STANDARD UNDERPINNING REINFORCED CONCRETE S

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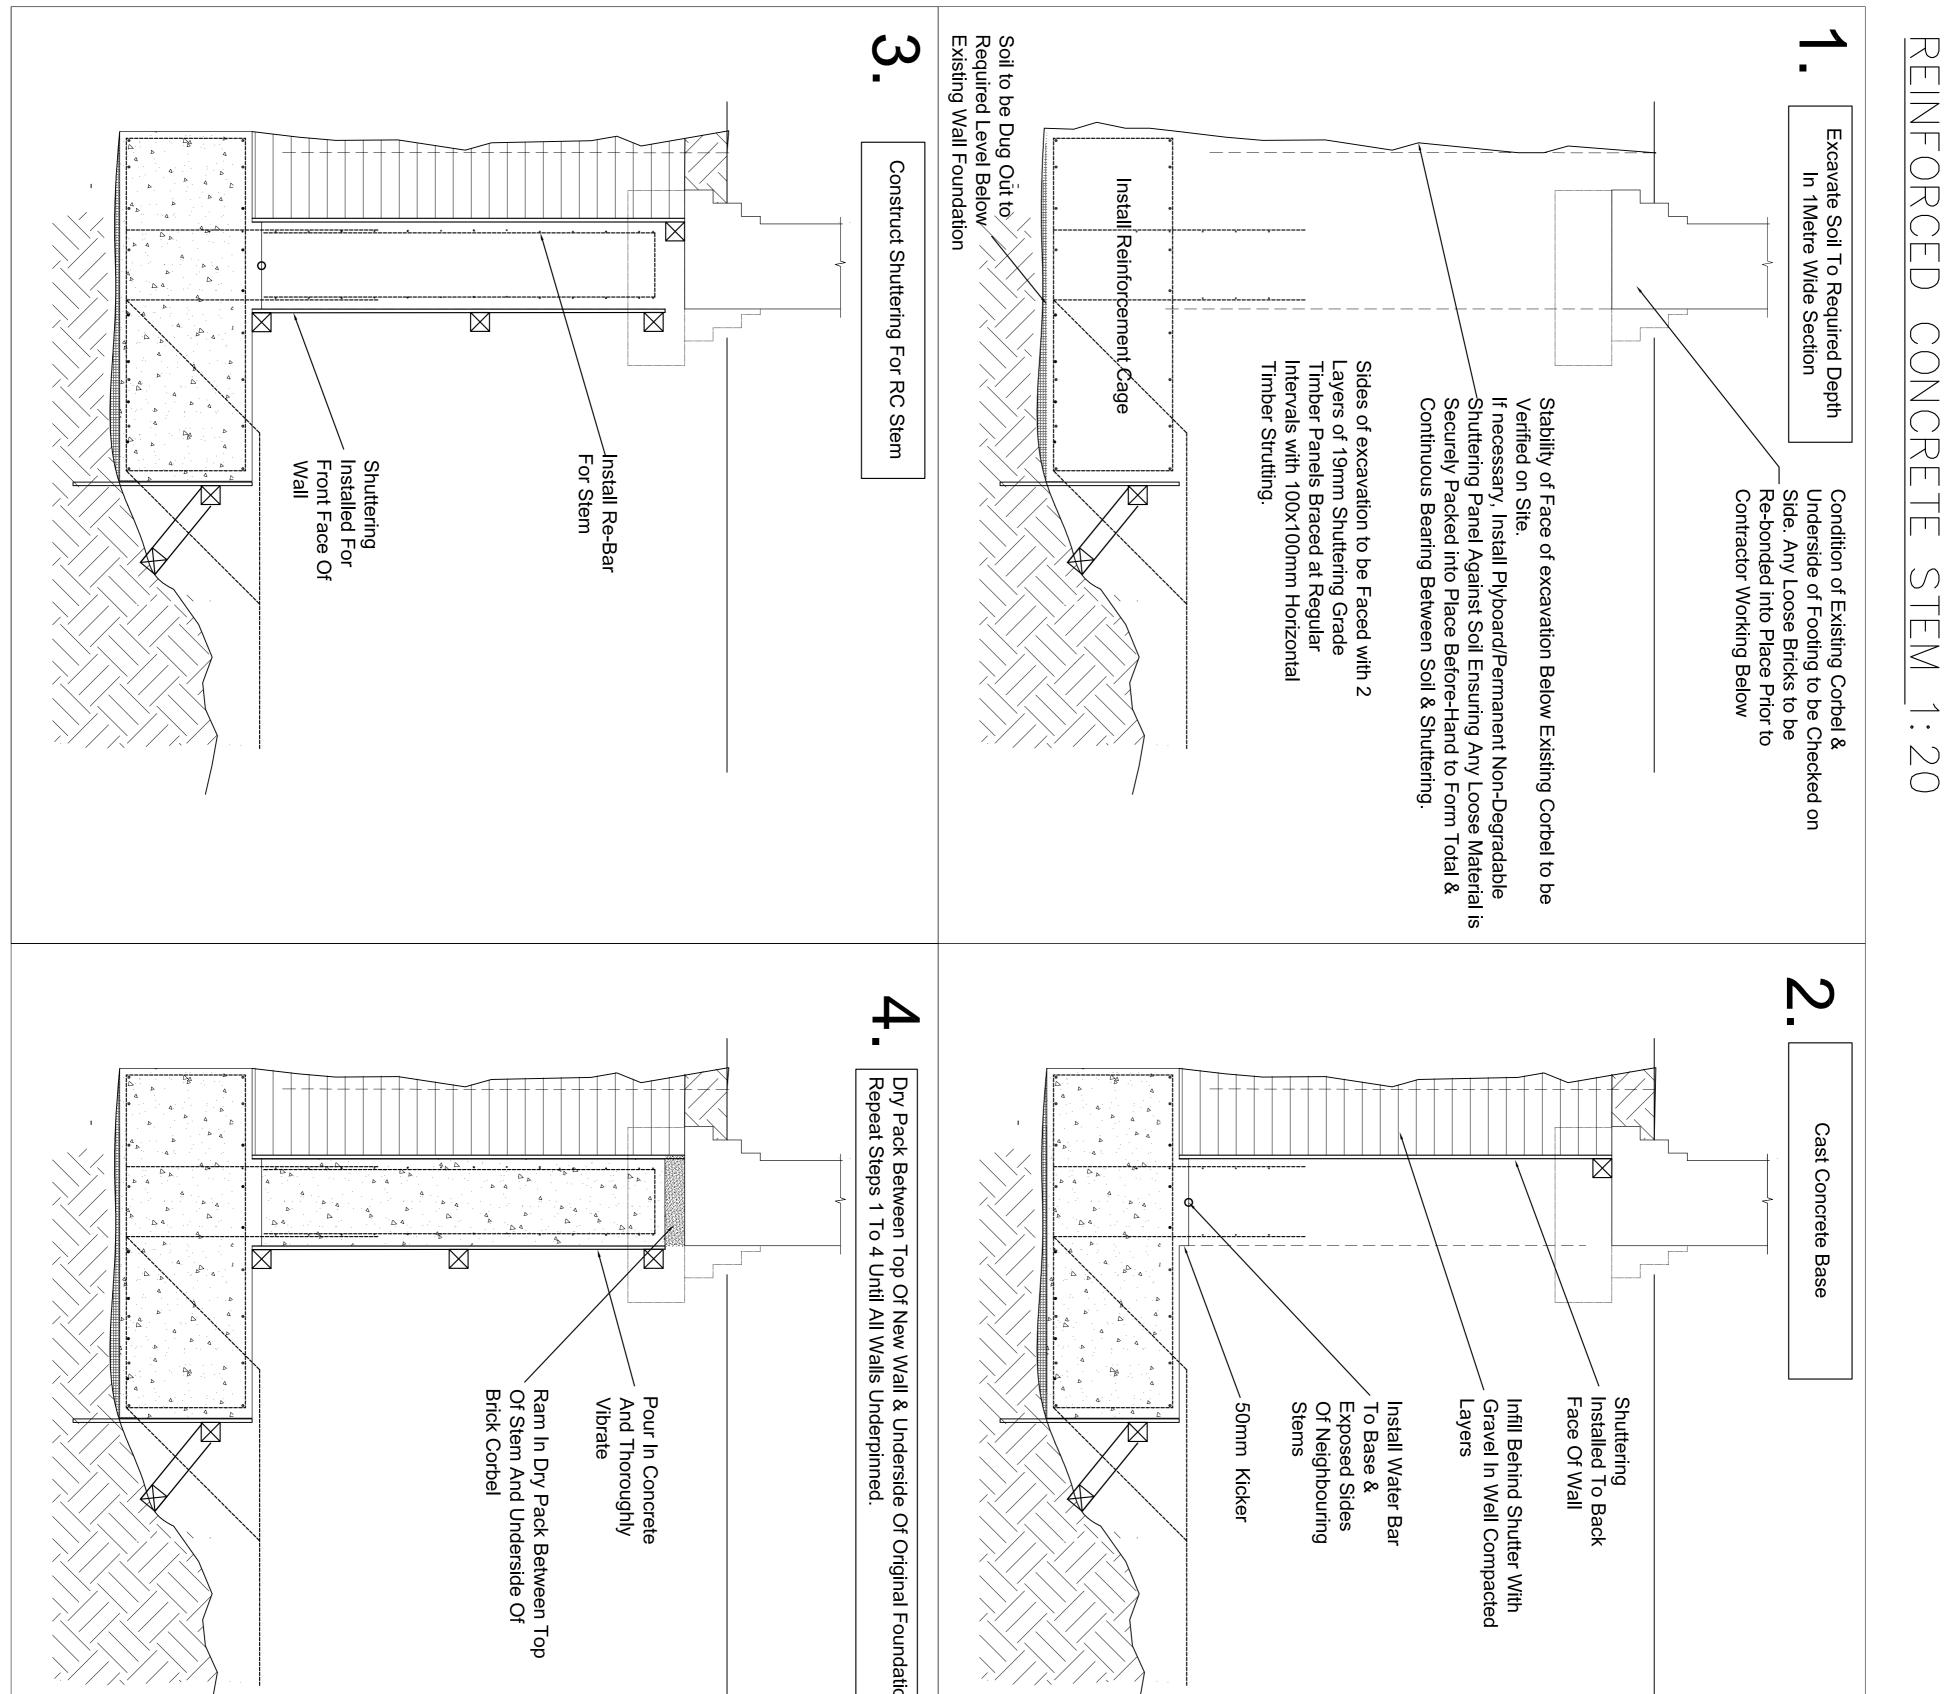
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CONSTRUCTION

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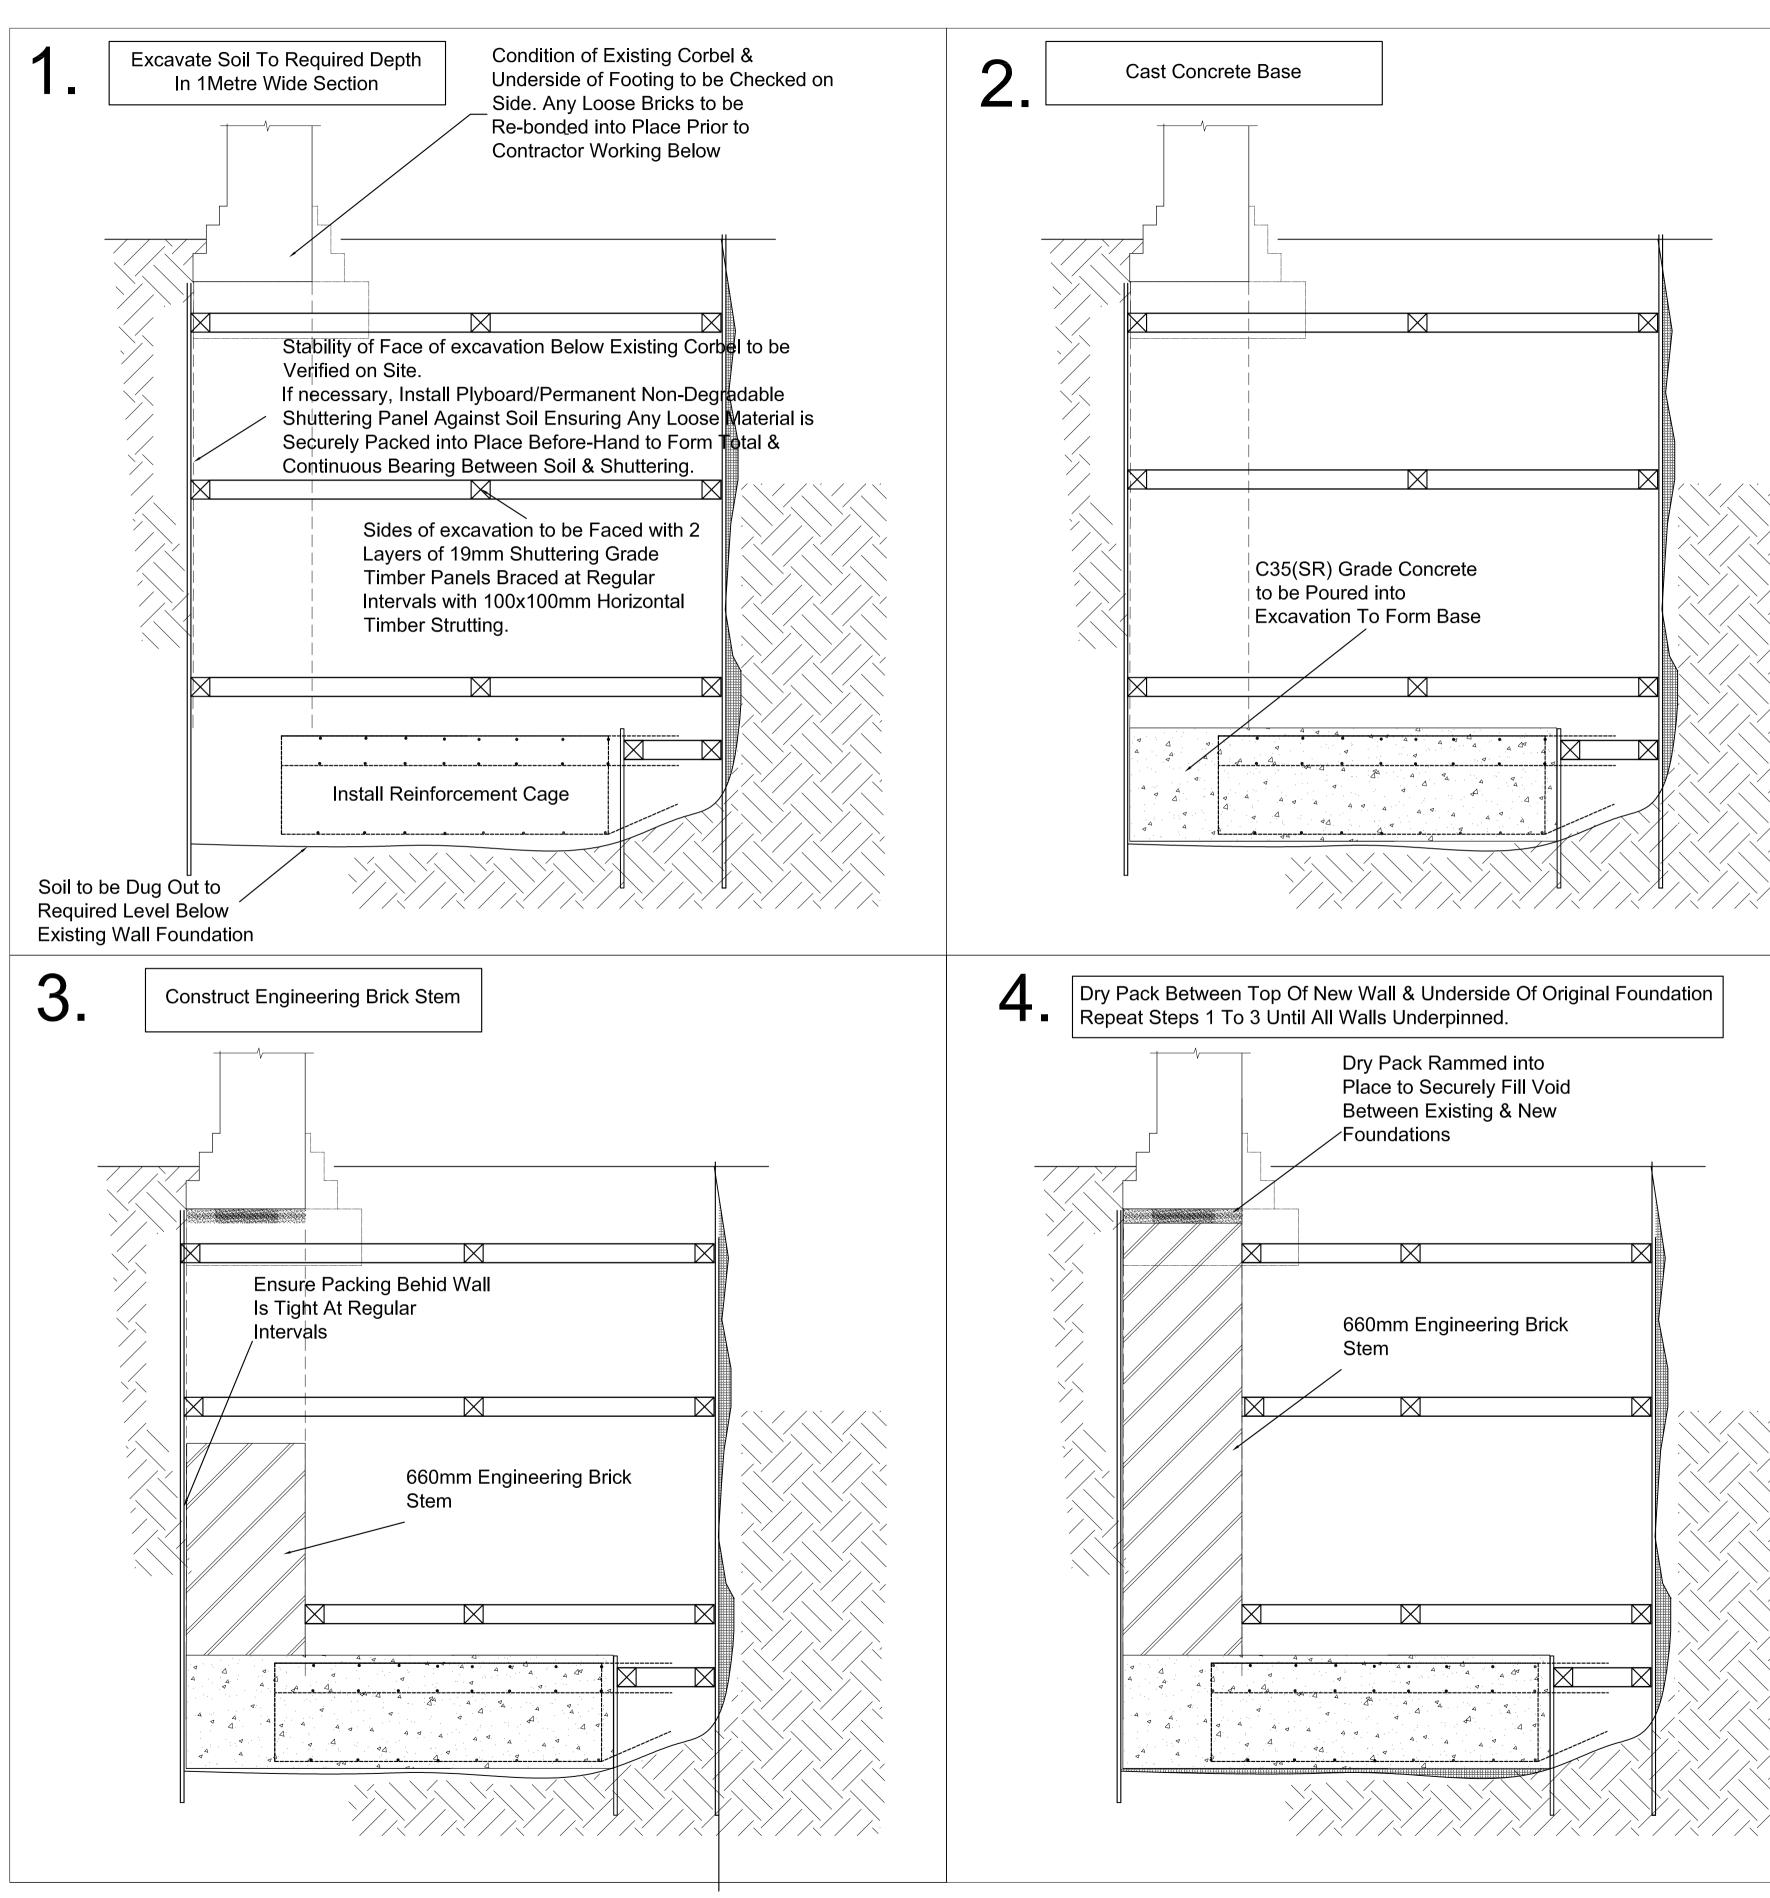
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28.04.2016 Sheet No. Rev GO Scale: 1:50@A1 Sheet No. lo: 16.280 - :t: Ornan Court, Belsize Park, NW3	LIN KEASTON ASSOCIATES Iting Civil & Structural Engineers 20-7837 5377 Fax: 020-7837 3211 ≥ Lane, London NW7 3NX 20-8959 1666 Fax: 020-8906 8503		Construction Method	NO CONCRETE IS TO BE ACED WHEN THE AMBIENT R TEMPERATURE IS LESS IAN 5 DEGREES C.	READY MIX CONCRETE UST BE OBTAINED FROM A ANT WHICH HOLDS A JRRENT CERTIFICATE OF CCREDITATION UNDER THE JALITY SCHEME FOR EADY MIX CONCRETE.	REINFORCEMENT SHALL E TO BS-8110 WITH MAIN ARS TO BE GRADE 460 (HIGH ELD).). TRIAL PIT TO BE EXCAVATED TO CONFIRM EXISTANCE OF ANY EXISTING STRUCTURE.	ALL NEW CONCRETE BELOW GROUND TO BE SULPHATE RESISTING CEMENT CONC. GRADE 35.	.FOUNDATIONS TO BE 1000mm WIDE UNLESS NOTED OTHERWISE.	WHENADJACENTSECTIONSAREOPENEDUPTHEEXPOSEDCONCRETESURFACESSHOULDBETHOROUGHLYCLEANEDOFALLLOOSEMATERIAL&SCABBLEDTOFORMA GOODKEY.KEY.KEY.KEY	5. ENSURE GROUND BEHIND NEW FOUNDATION & WALL IS FULLY BACKFILLED AND COMPACTED. CHECK AT REGULAR INTERVALS TO ENSURE THIS DURING CONSTRUCTION.	RAM IN DRY PACK MORTAR BETWEEN NEW STRUCTURE AND ANY EXISTING FOOTING.	DNSTRUCT RICKWORK/BLOCKWORK TO ITHIN 75mm OF SOFFIT DOTING & ALLOW FOR DNDING INTO NEXT SECTION F WALL.	3. NEVER EXCAVATE TWO ADJACENT STRIPS WITHOUT ALLOWING 3 DAYS BETWEEN OPERATIONS.	CAST NEW CONCRETE AND ALLOW 24 HOURS TO CURE.	1. WORKING IN STRIPS NOT EXCEEDING 1M LONG EXCAVATE TO REQUIRED DEPTH ADJACENT EXISTING STRUCTURE.	EXCAVATION FOR RETAINING WALLS

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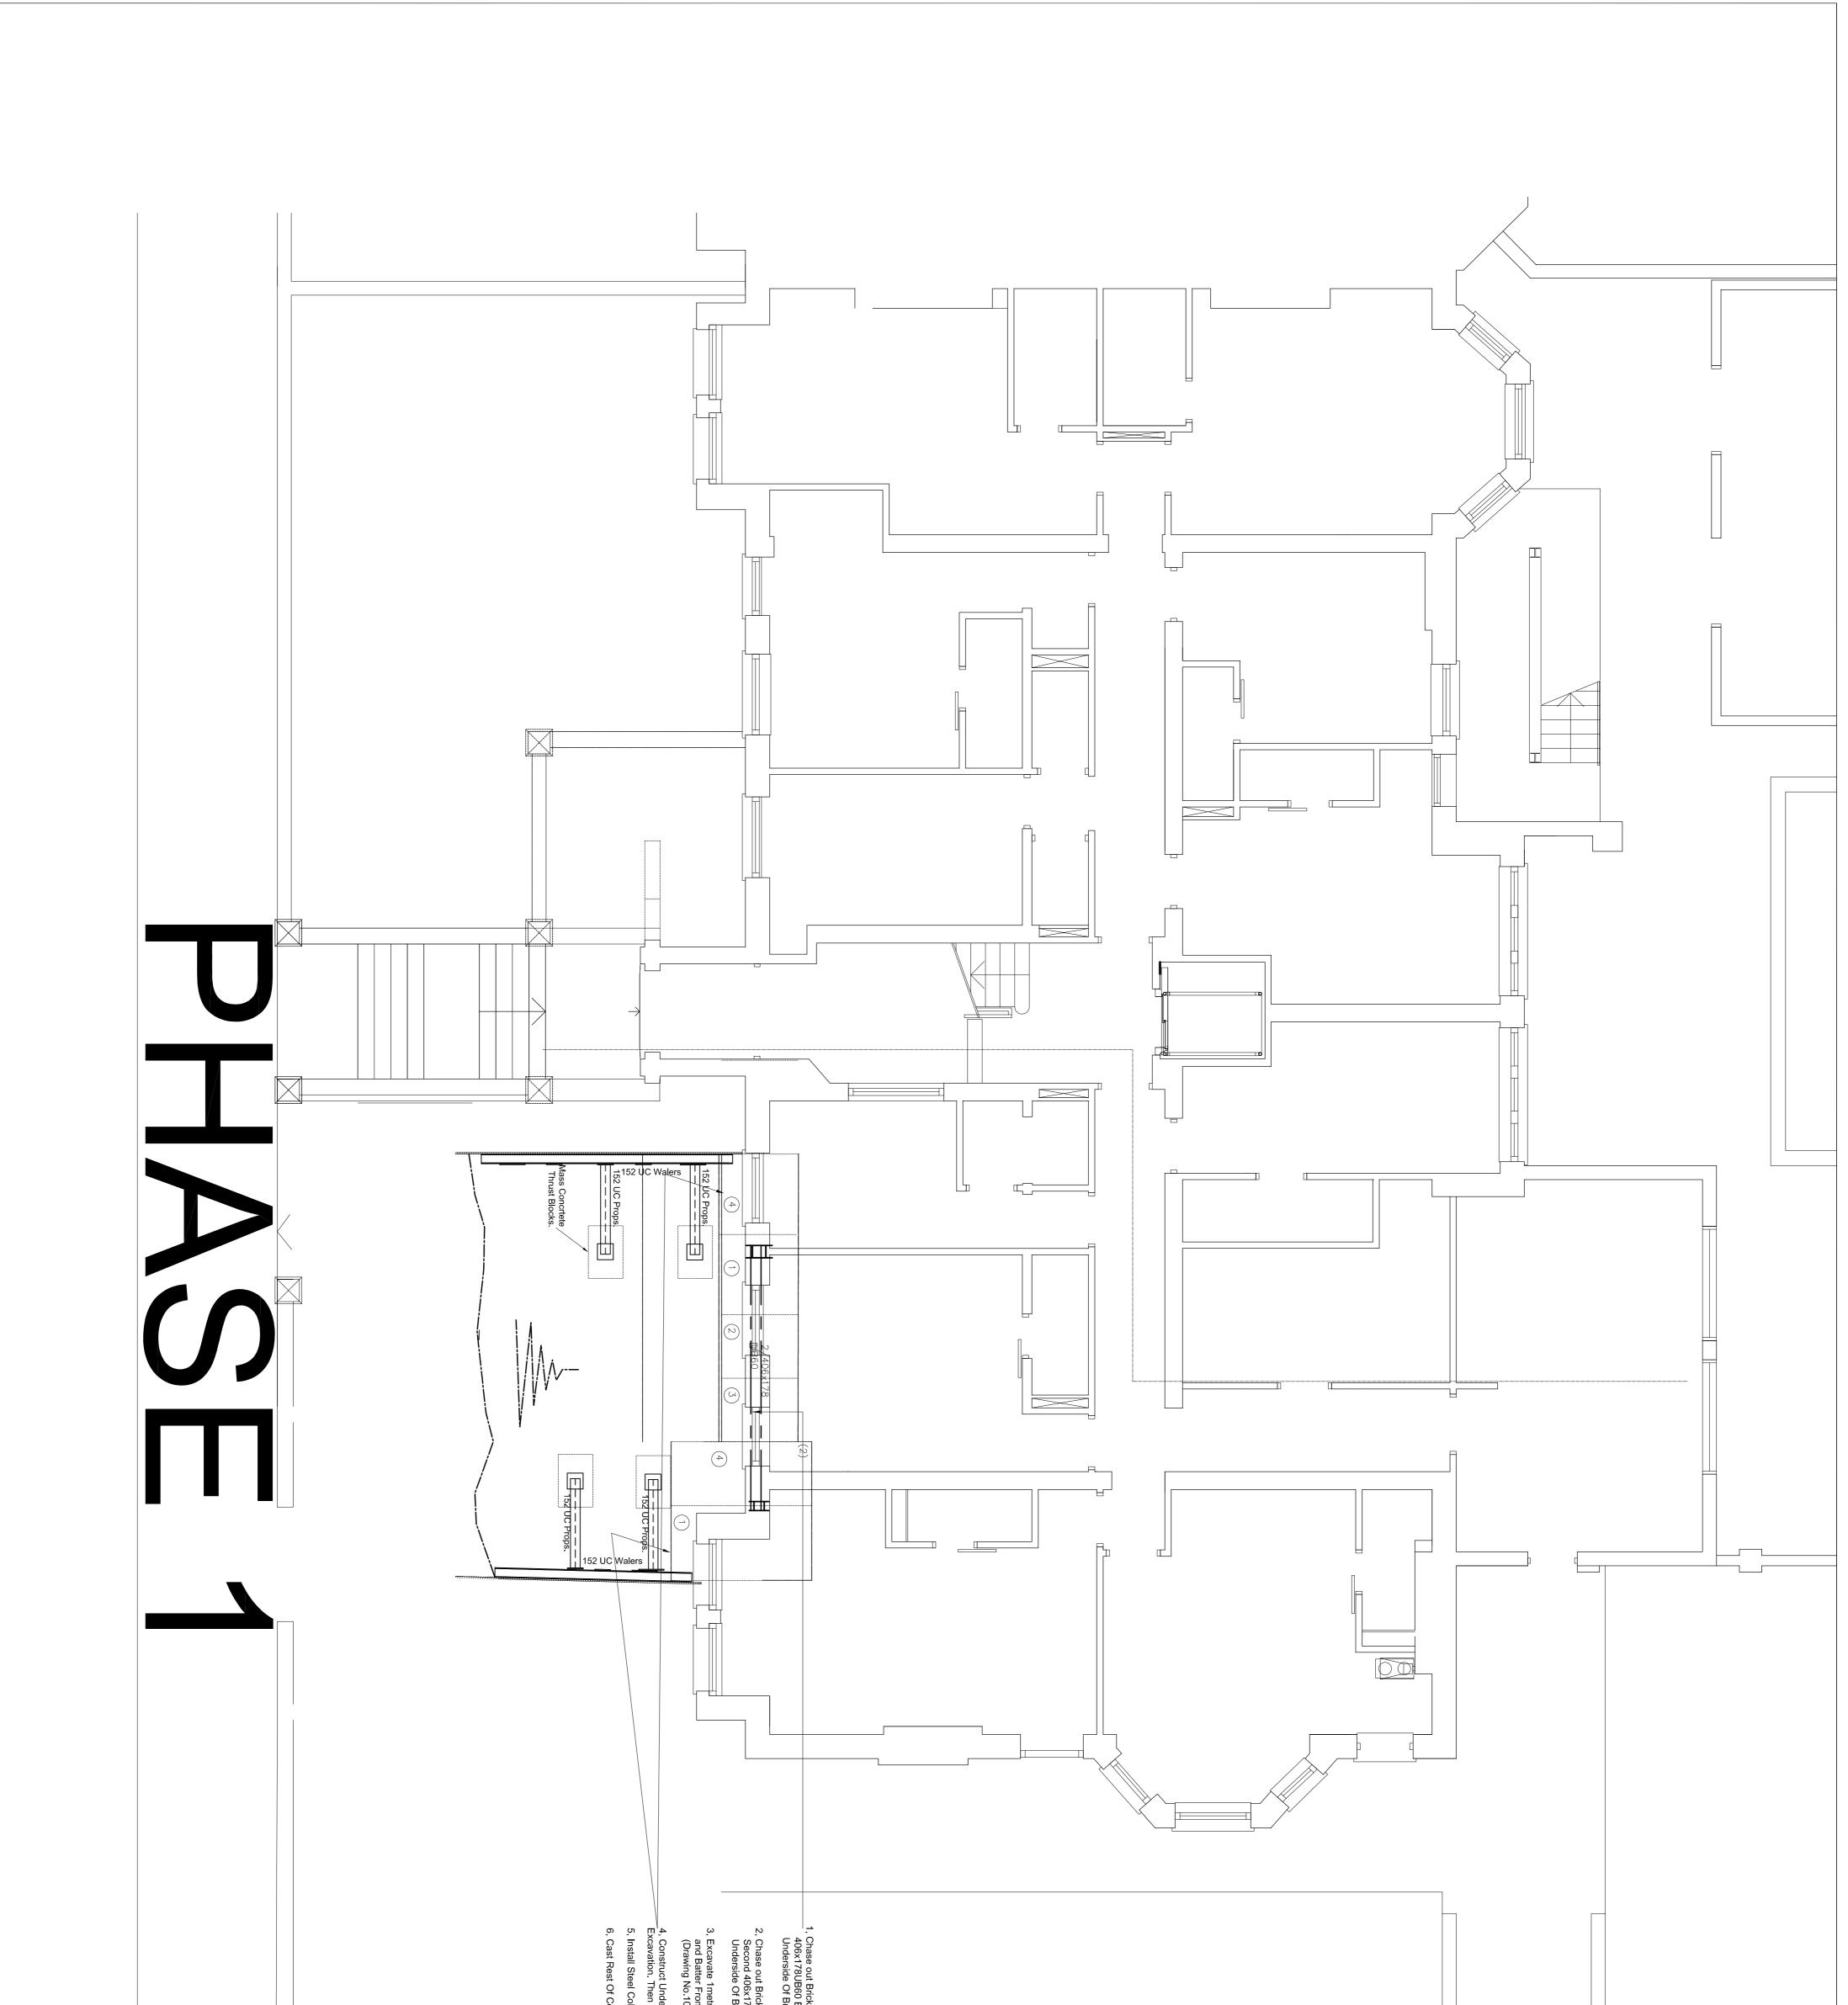


STANDARD UNDERPINNING SEQUENCE OF CONSTRUCTION DETAILS FOR

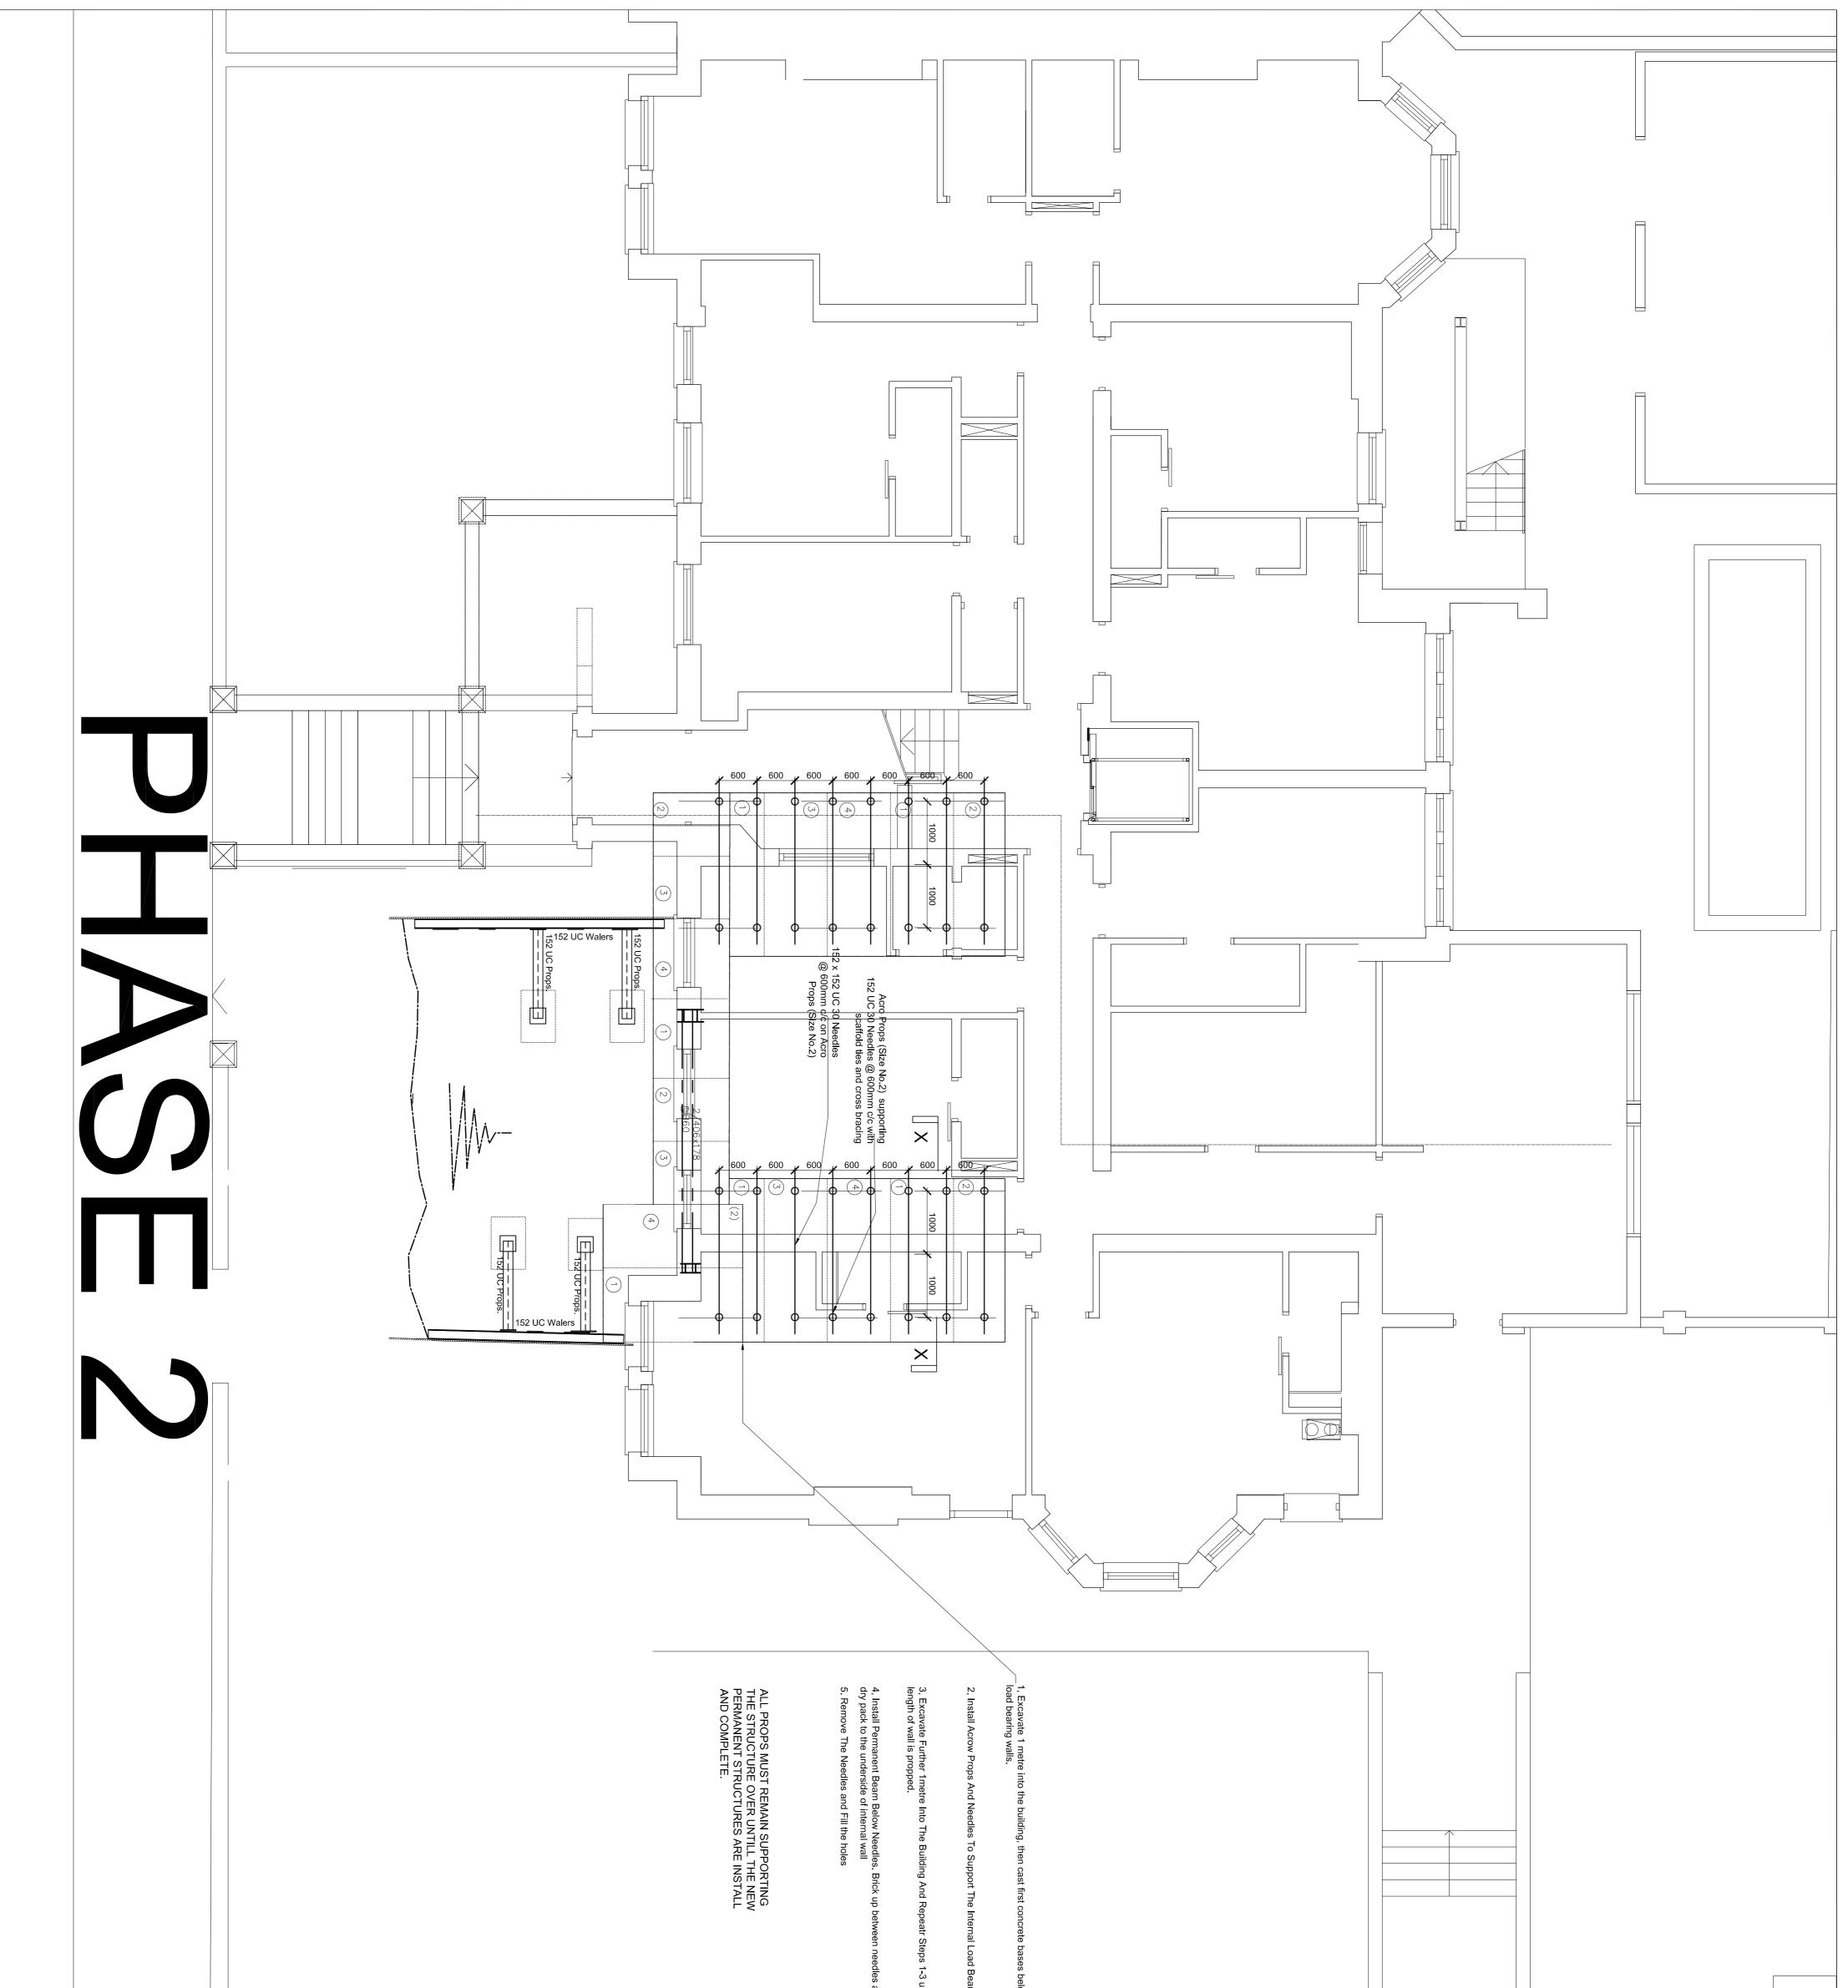
EXCAVATION FOR REINFORCED CONCRETE RETAINING WALLS

- 1. WORKING IN STRIPS NOT EXCEEDING 1M LONG EXCAVATE TO REQUIRED DEPTH ADJACENT EXISTING STRUCTURE.
- 2. CAST NEW CONCRETE BASE AND ALLOW 24 HOURS TO CURE. STARTER BARS TO EXTEND 40d ABOVE BASE FOR LAPPING PURPOSES (SEE DETAILS FOR BAR SIZES).
- 3. VERTICAL & HORIZONTAL REINFORCEMENT TO BE CONSTRUCTED IN ACCORDANCE WITH DESIGN INFORMATION AND ANY REINFORCEMENT SCHEDULES PROVIDED BY THE ENGINEER.
- 4. SHUTTERING & PROPPING TO BE DESIGNED BY CONTRACTOR.
- 5. CAST NEW CONCRETE WALL ENSURING GROUND BEHIND NEW FOUNDATION & WALL IS FULLY BACKFILLED AND COMPACTED. CHECK AT REGULAR INTERVALS TO ENSURE THIS DURING CONSTRUCTION.
- 6. NEVER EXCAVATE TWO ADJACENT STRIPS WITHOUT ALLOWING 3 DAYS BETWEEN OPERATIONS.
- 7. WHEN ADJACENT SECTIONS ARE OPENED UP THE EXPOSED CONCRETE SURFACES SHOULD BE THOROUGHLY CLEANED OF ALL LOOSE MATERIAL & SCABBLED TO FORM A GOOD KEY
- 8. ALL REASONABLE CARE IS TO BE TAKEN TO PREVENT INJURIES TO PERSONS WORKING NEAR EXPOSED BARS ETC. (THREADED COUPLERS WOULD BE SUITABLE).
- 9. FOUNDATIONS TO BE 1200mm WIDE UNLESS NOTED OTHERWISE.
- 10. ALL NEW CONCRETE BELOW GROUND TO BE SULPHATE RESISTING CEMENT CONC. GRADE
- 11. TRIAL PIT TO BE EXCAVATED TO CONFIRM EXISTANCE OF ANY EXISTING STRUCTURE.
- 12. REINFORCEMENT SHALL BE TO EC2 WITH BARS TO BE GRADE 500.
- 13. READY MIX CONCRETE MUST BE OBTAINED FROM A PLANT THAT HOLDS A CURRENT CERTIFICATE OF ACCREDITATION UNDER THE QUALITY SCHEME FOR READY MIX CONCRETE.
- 14. NO CONCRETE IS TO BE PLACED WHEN THE AMBIENT AIR TEMPERATURE IS LESS THAN 5 DEGREES C.

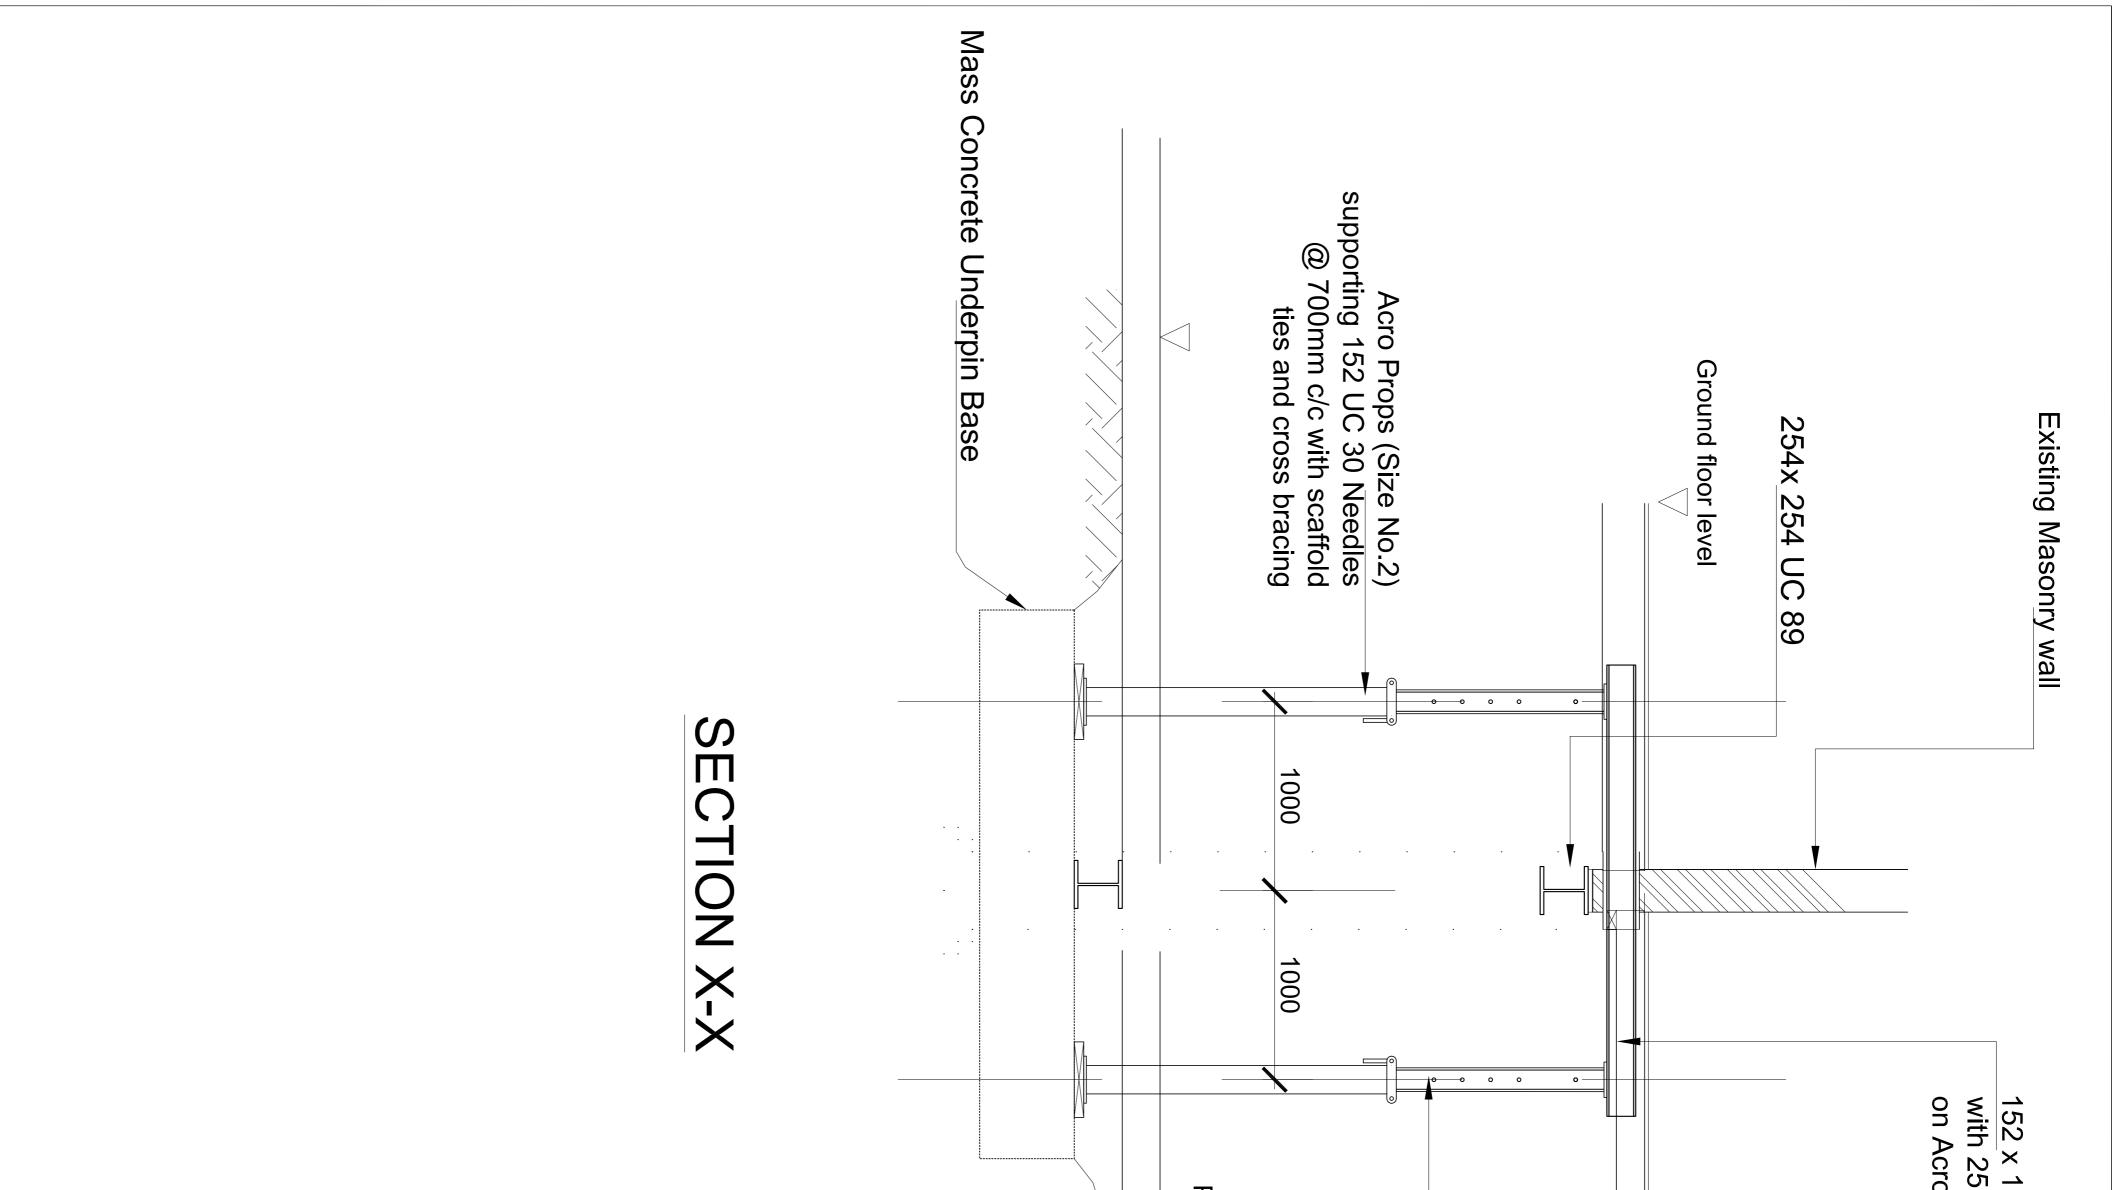
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М	artin R	edston Associ	ates						
Со	nsulting Ci	vil & Structural Engine	eers						
	4 Edward Square, London N1 OSP ■ Tel: 020-7837 5377 Fax: 020-7837 3211								
		London NW7 3NX 59 1666 Fax: 020-8	□ 906 8503	ו					
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Project: Ornan Court, Belsize Park, NW3									



	ckwork to Mid point of Wall To Install O Beam. Dry Pack Rammed In Between Brick And Top Of Steel Beam fBrick And Top Of Steel Beam. Dny Pack Rammed In Between fBrick And Top Of Steel Beam. Bolt Steel Beams Together etre wide Trench To Form First Base. Prop Sides Of Trench om End . See 'Excavation Of Brick Stem Underpinning' 10) For Details an Cast Concrete Bases Below Dolumns To Support Steel Beam Concrete Bases	
Title: Prelin Rev A Ed Tel: - Lob Proje		
Title: Temporary Works 1 Preliminary Date Description Martin Redston Associates Consulting Civil & Structural Engineers 4 Edward Square, London N1 OSP 4 Edward Square, London N1 OSP Tel: 020-7837 3211 Image: Civil & Structural Engineers 4 Edward Square, London N1 OSP Structural Engineers 4 Edward Square, London N1 OSP Structural Engineers 4 Edward Square, London NW7 3NX Image: Civil & Structural Engineers 5 Eng: GO Scale: 1:50@A1 Image: Civil & Structural Engineers 4 Edward Square, London NW7 3NX Image: Civil & Structural Engineers Image: Civil & Structural Engineers 4 Edward Square, London NW7 3NX Image: Civil & Structural Engineers Image: Civil & Structural Engineers Image: Civil & Structural Engineers 4 Edward Square, London NW7 3NX Image: Civil & Structural Engineers Image: Civil & C		



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Title: Temporary Works 2 Preliminary Rev Date Description Rev Date Description App Martin Redston Associates Consulting Civil & Structural Engineers A Edward Square, London NI OSP Table 1020-7837 32111 App 6 Hole Lone, London NW7 3WX Tel: 020-8959 1666 Fox: 020-8006 8503 Sheet No. Rev Project: Sheet No. Rev Job No: 16.280 Total: 200 State: 1:50@A1 Total: App Total: App Project: Oman Court, Belsize Park, NW3 Total: 200 Total: 200			
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152 x 152 UC 30 Needles @ 700mm c/c with 25mm dry pack to brickwall and on Acro Props (Prop Size No.2)

Ground floor level

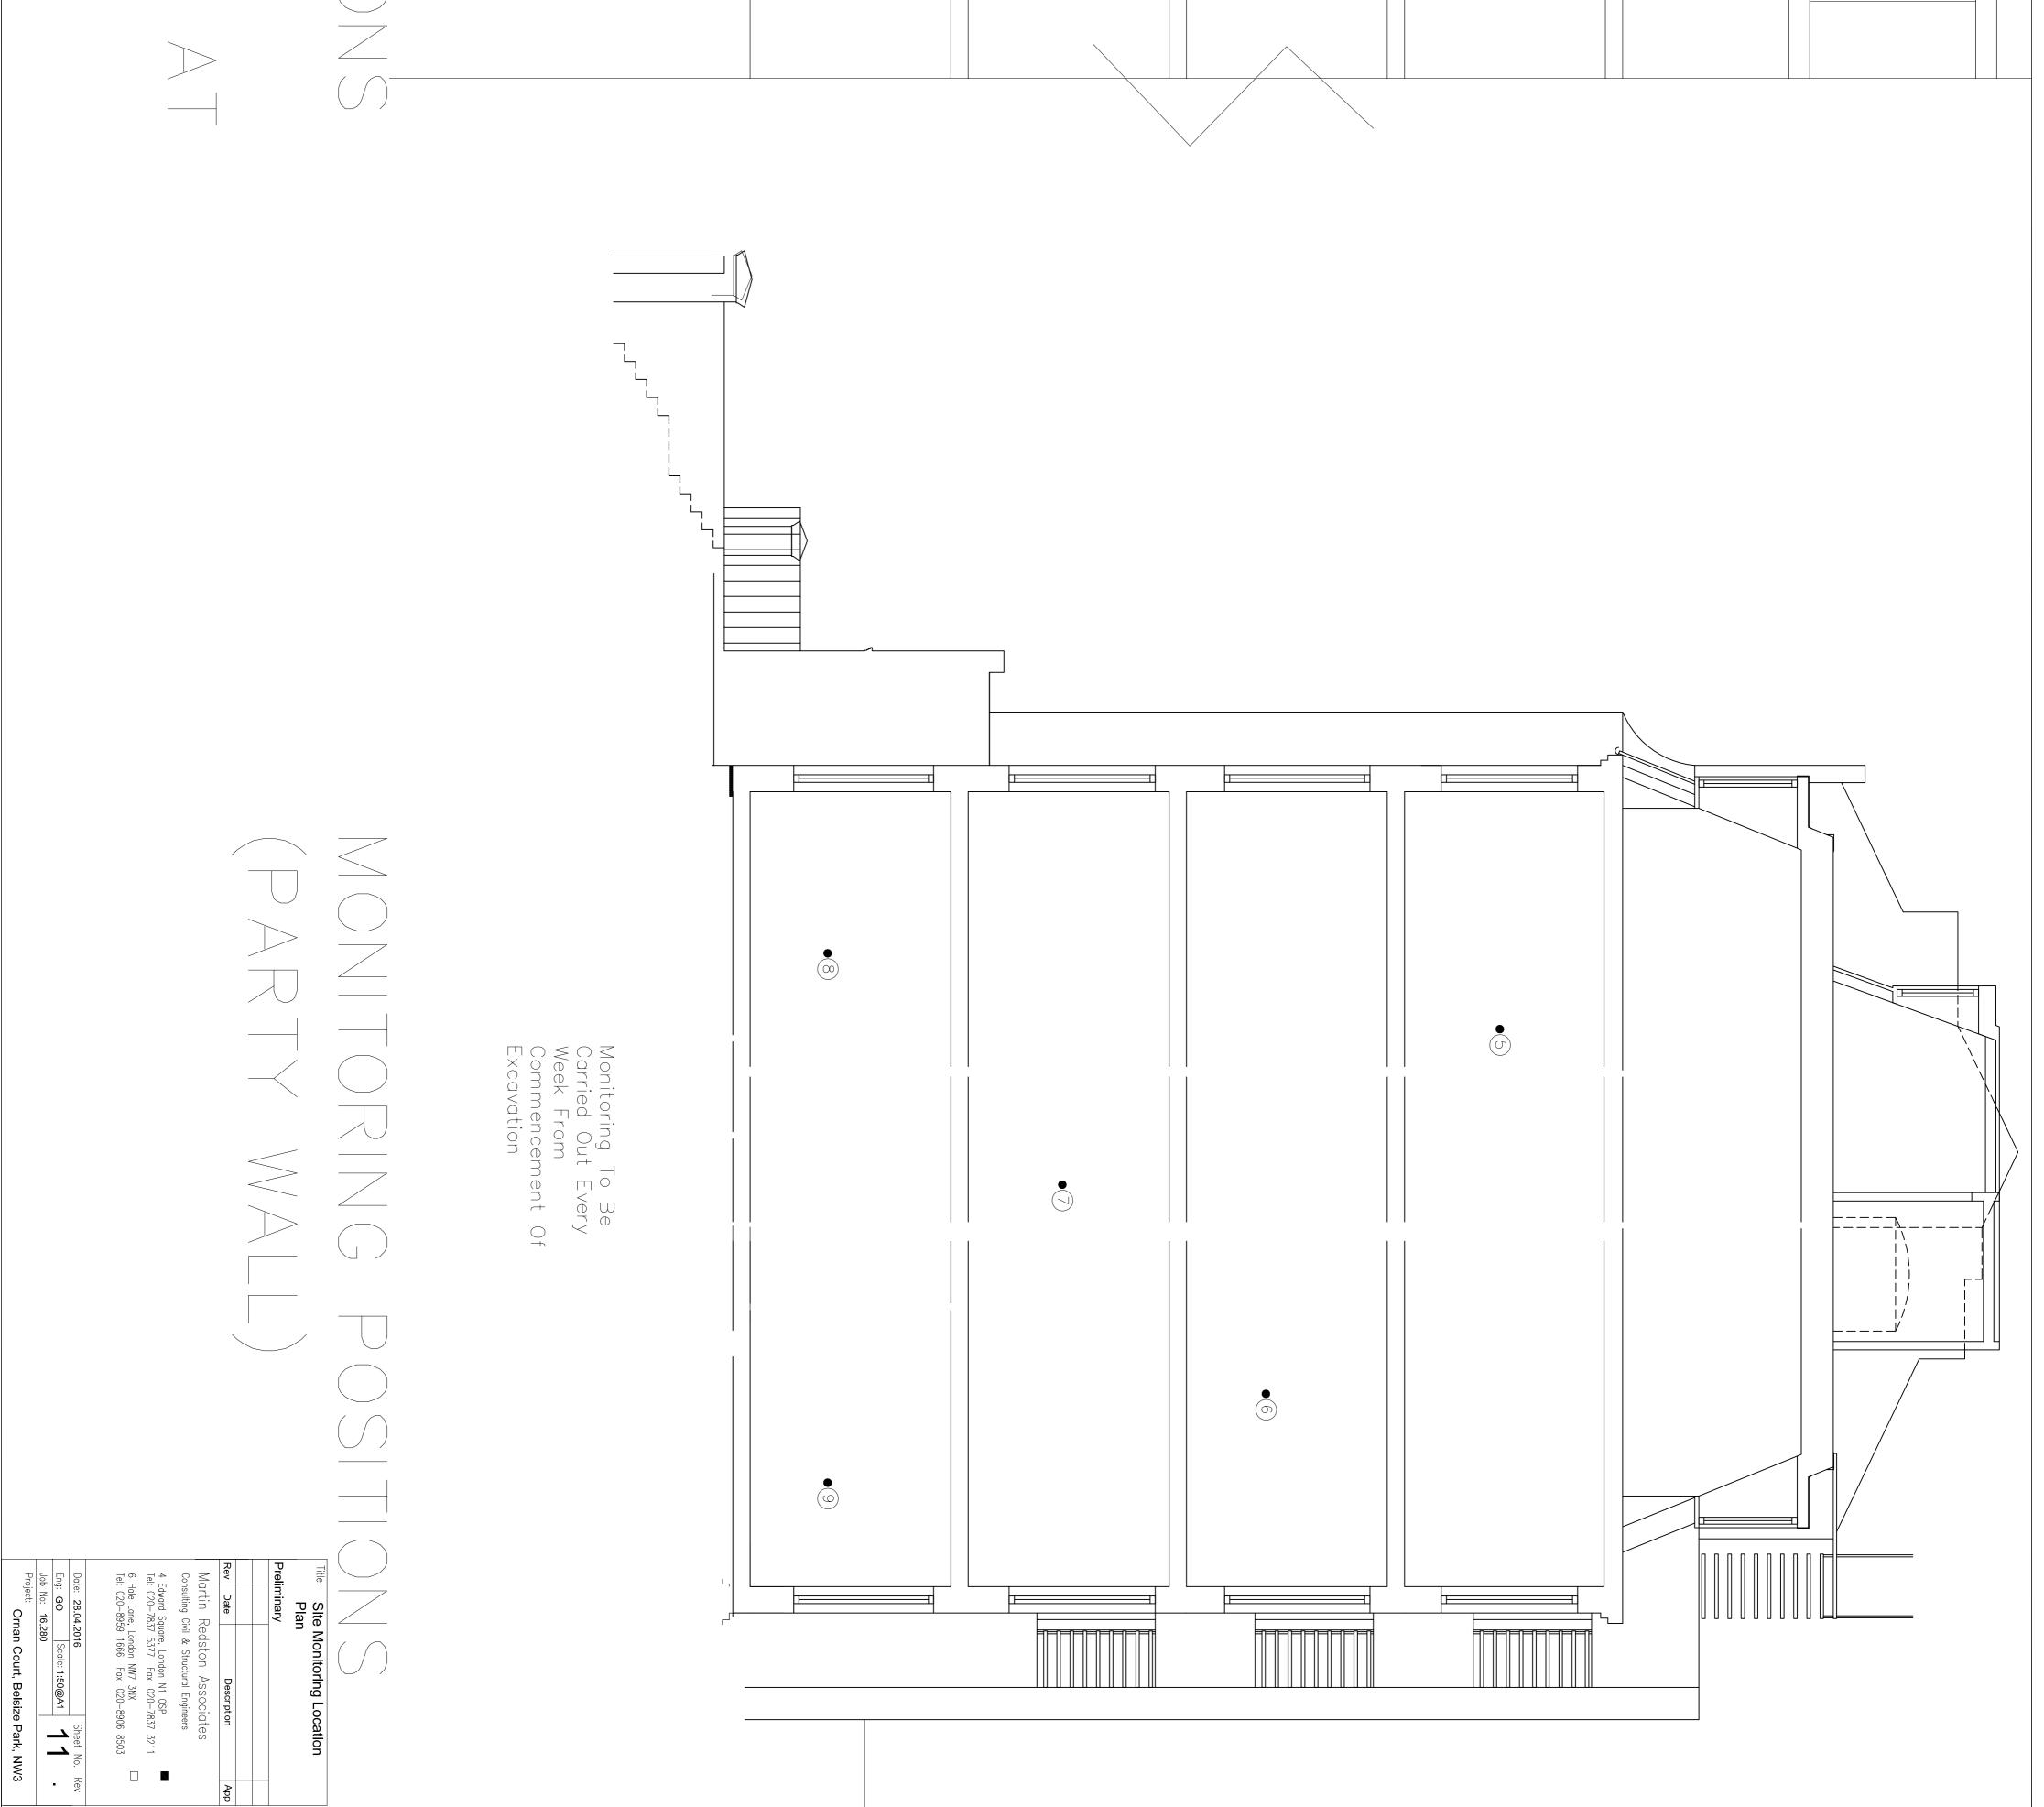
Acro Props (Size No.2) supporting 152 UC 30 Needles @ 700mm c/c with scaffold ties and cross bracing

ProposedcLower Ground floor level

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Project: Ornan Court, Belsize Park, NW3	Eng: GO Scale: 1:50@A1 Job No: 16.280	Date: 28.04.2016	Tel: 020-8959 1666 Fax: 020-8906 8503	6 Hale Lane, London NW7 3NX	4 Edward Square, London N1 OSP Tel: 020–7837 5377 Fax: 020–7837 3211	Consulting Civil & Structural Engineers	Martin Redston Associates	Rev Date Description		Preliminary	
Park, NW3	່ ເບ	0.	6 8503		7 3211	S	.es				
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9.2 Monitoring

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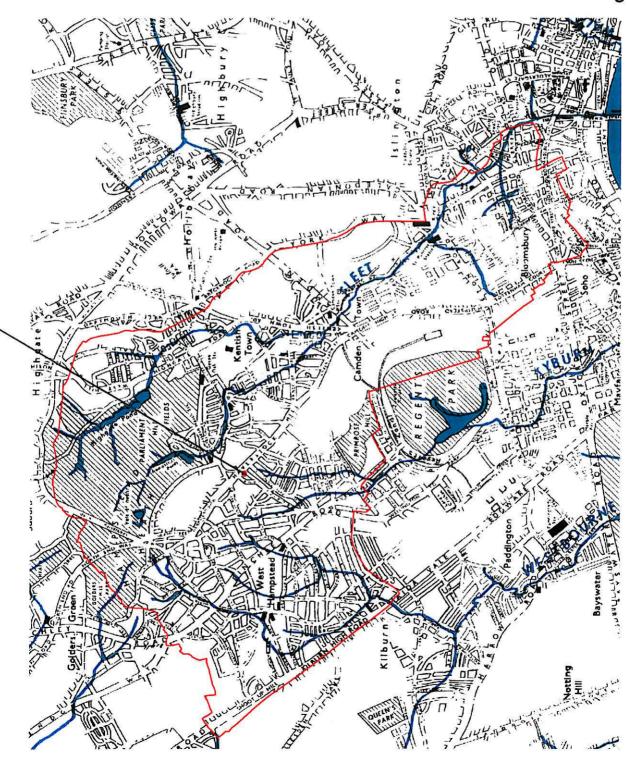


9.3 Watercourses

FIGURE 11

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Camden Geological, Hydrogeological and Hydrological Study Watercourses



-ORNAN COURT

Source - Barton, Lost Rivers of London

