





#### Introduction

Condition 2: GATE APPEARANCE (BASED ON APPLICATION 2016/2416/P)

Detailed drawings, or samples of materials as appropriate, in respect of the following, shall be submitted to and approved in writing by the local planning authority before the relevant part of the work is begun:

a) Plan, elevation and section drawings and manufacturer's specification details of the proposed vehicle and pedestrian gates on the northern boundary of the site as shown in drawing no. MMA(10)100\_P2. The relevant part of the works shall be carried out in accordance with the details thus approved and all ap-

accordance with the details thus approved and all approved samples shall be retained on site during the course of the works.

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REASON: To safeguard the appearance of the premises and the character of the immediate area in accordance with the requirements of policy CS14 of the London Borough of Camden Local Development Framework Core Strategy and policy DP24 of the London Borough of Camden Local Development Framework Development Policies.

# Site Plan

1:200




Galvanised-Recessed Gate Plan **Ground Track** 100mm Timber-Corten Steel-Cladding with Cladding 5mm Spacing 50X50mm Galvanised Video Entry-Metal Frame System PEDESTRIAN GATE FIXED PANEL OPENABLE PANEL OPENABLE PANEL OPENABLE PANEL -OPENING 1050--1160--1160--1160-<del>--</del>1160---1160-



Sections A-A and B-B

Gate Elevtion

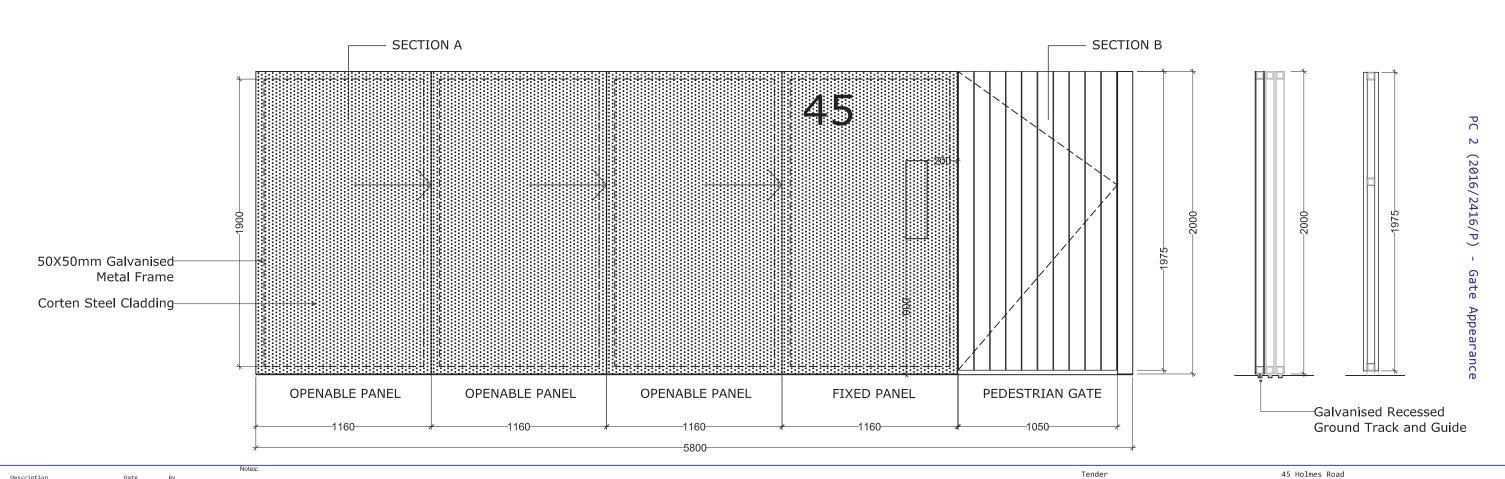


- Drawing is for Design Intent
- Gate to be an electric telescopic gate with 3 opening panels as per the drawing above.
- Intercom/Yideo Entry for pedestrian gate and vehicle gate as well as fob controlled.
- Specialst Designer/Manufacturer to produce factory drawings for discussion/approval.

Entrance Gate - Closed


Drawn by: CK Reviewed by: KS

1 : 25 @A3 (36)900 / P2



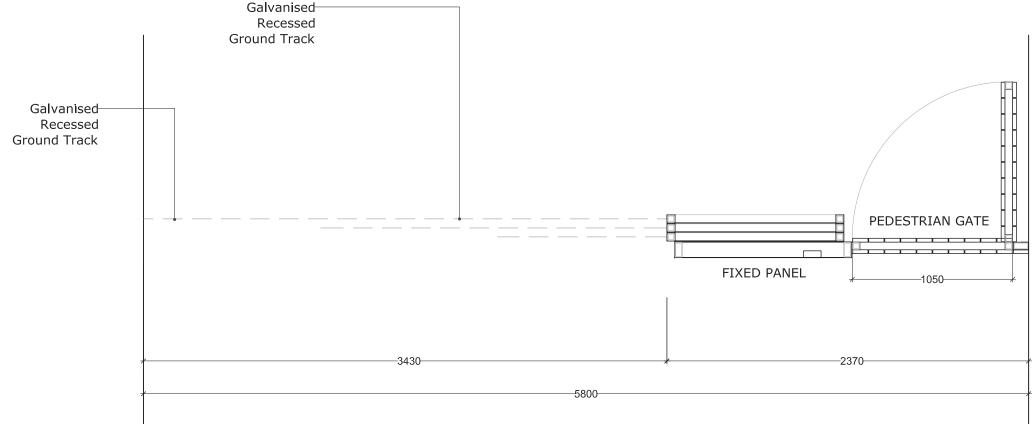

### Gate Elevtion

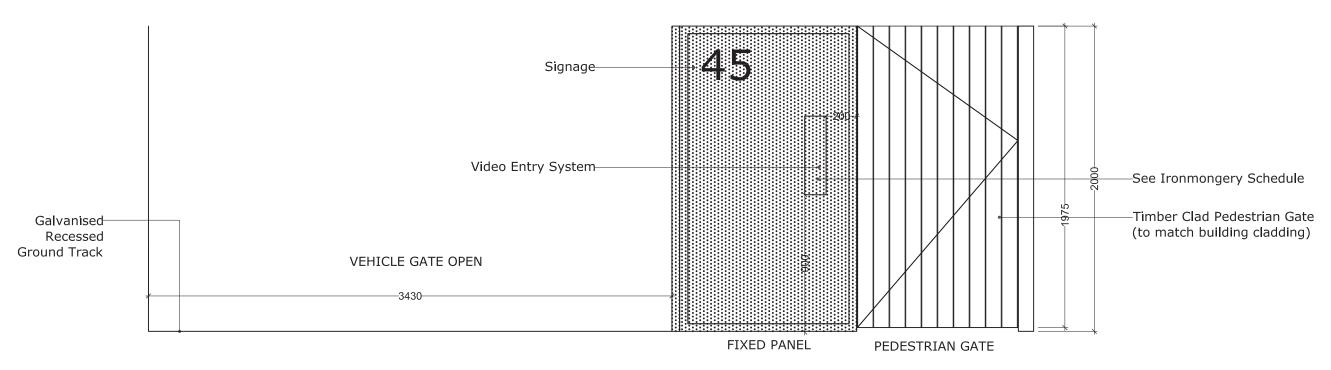


-Drawling is for Design Intent
-Gate to be an electric telescopic gate with 3 opening panels as per the drawing above.
-Intercom/Video Entry for pedestrian gate and vehicle gate as well as for hoortcolled GHR Construction Entrance Gate - Open -Interconvivide Entry for pedestrian gate and vehicle gate as well as fob controlled.
-Specialist Designer/Manufacturer to produce factory drawings for discussion/approval.

1 : 25 @A3 (36)901 / P2

45 Holmes Road




Scale 1:25

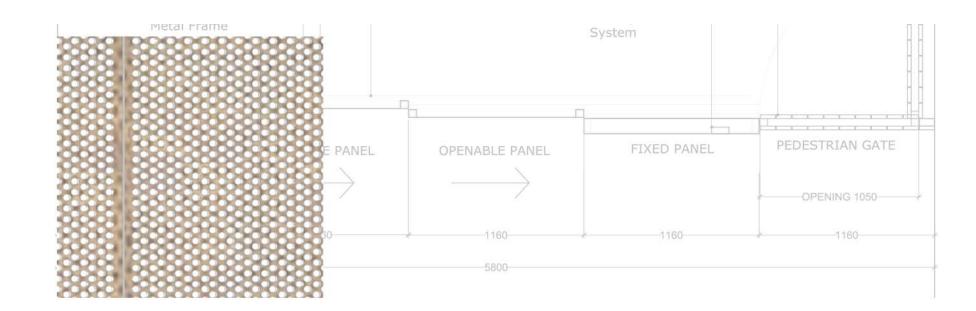

Sections A-A and B-B



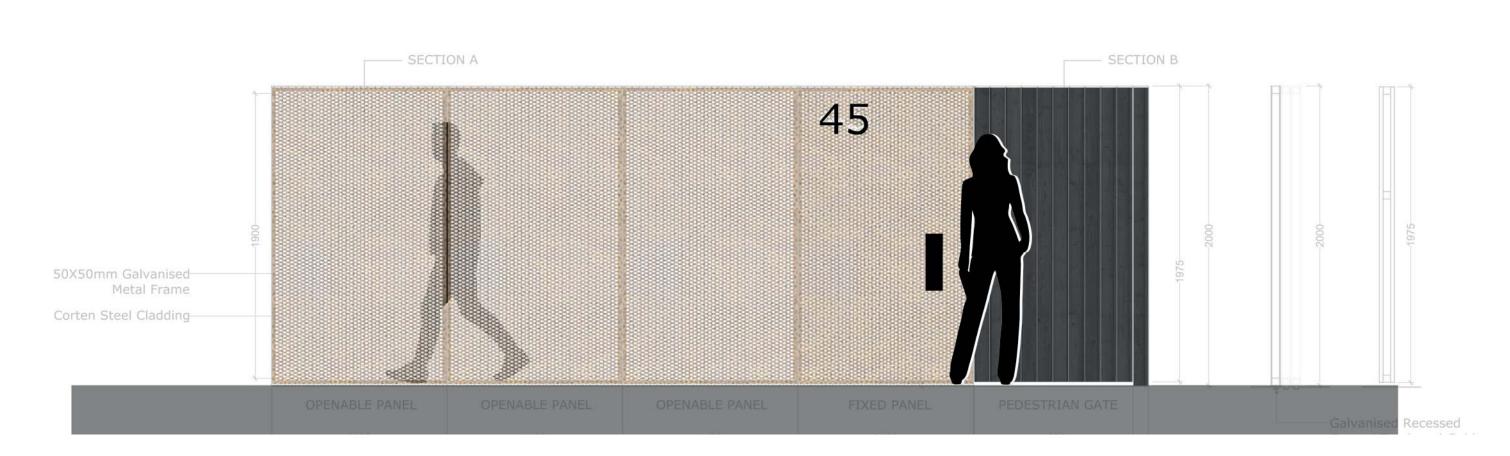

## **Materials**


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The materiality responds to the materiality of the building and uses the perforated corten steel and black timber cladding. Each are used to denote the vehicle and pedestrian entrance gate as different elements to distinguish between both. The gate will have an integrated video intercom and fob control panel as shown in the drawings.

Pedestrian Gate: Black stained Siberian Larch Vehicle Gate: Perforated Corten Steel with a hole diameter of 1.96mm which allows visibility through.


Frame: Galvanised Steel

Perforated Corten

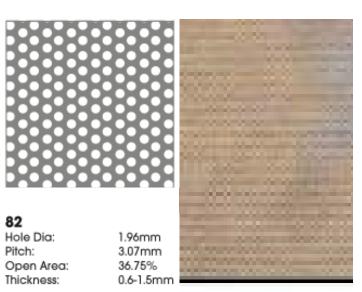

Video Intercom Panel



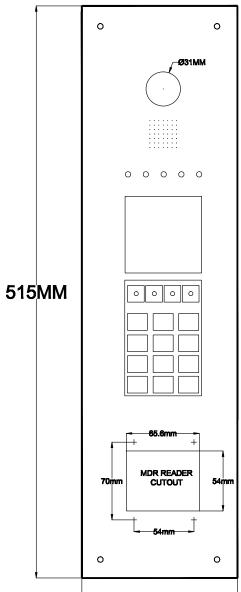

-140MM



#### Black Timber





