NOTE: ALL DIMENSIONS MUST BE CHECKED BY CONTRACTOR PRIOR TO WORKS.

CONTRACTOR TO ALLOW FOR CONFORMING WITH THE FOLLOWING REGULATIONS AS NECESSARY

WALL FINISHES TO BE CLASS 1 GENERALLY WITH CLASS 0 FINISHES TO CORRIDORS AND CIRCULATION AREAS

CAVITY BARRIERS TO BE PROVIDED IN CEILING VOIDS AT MAXIMUM 20M CENTRES. EXCEPT WHEN THE CEILING VOID IS OVER A SINGLE ENCLOSED ROOM WHERE THEY WILL BE PROVIDED AT A MAXIMUM 40 M CENTRES

LIGHTING DIFFUSERS (IF SPECIFIED) METAL LIGHTING DIFFUSERS WILL BE USED IN THE SUSPENDED CEILING SYSTEM

CEILING FINISHES TO BE CLASS 0 GENERALLY THROUGHOUT INCLUDING CORRIDOR AND CIRCULATION AREAS

SPRINKLERS TO BE PROVIDED IN ACCORDANCE WITH BRITISH STANDARD 5306 PART 2, HAZARD CLASS: ORDIN HAZARD GROUP II

FIRE ALARM TO BS5839 PART 1: 1988. A TYPE 'M' BREAK GLASS FIRE ALARM SYSTEM WILL BE PROVIDED, DESIGNED AND INSTALLED IN ACCORDANCE WITH BRITISH STANDARD 5839 PART 1

FIRE EXTINGUISHERS INSTALLED TO BS5036 PART 3 1983 WATER TYPE FIRE EXTINGUISHERS WILL BE PROVIDED AT THE RATE OF ONE FOR EVERY 200M SQ OF FLOOR AREA, SPECIALISE EXTINGUISHER WILL BE PROVIDED TO SUIT THE INDIVIDUAL RISKS WHEN IDENTIFIED

NOTICES TO BS6409 PART 1 1990 SUFFICIENT FIRE NOTICES WILL BE PROVIDED TO ENABLE THE OCCUPANTS OF THE BUILDING TO IDENTIFY ALL THE FIRE EXT ROUTES NOT IN EVERYDAY USE.

ALL FIRE RESISTING DOORS WILL BE PROVIDED WITH EITHER A FIRE DOOR KEEP SHUT NOTICE OR A FIRE DOOR KEEP LOCKED SHUT WHEN NOT IN USE

3 HOUR NON - MAINTAINED EMERGENCY LIGHTING SYSTEM WILL BE PROVIDED DESIGNED AND INSTALLED IN ACCORDANCE WITH BRITISH STANDARD5266 PART 1

STUD PARTITIONING LEGEND

NEW STUD PARTITIONING
CONSISTING OF 70MM STUDS AT
MAXIMUM 600MM CENTRES FACING BOTH
SIDES WITH ONE LAYER OF 12.5MM
PLASTERBOARD SCRIMMED AND TAPED
JOINTS TO RECEIVE DECORATION PROVIDING MINIMUM 1/2 HOUR FIRE RESISTANCE AND MINIMUM CLASS 1 SPREAD OF FLAME

NOTES

DESIGN INTENT DRAWING ONLY - BASED ON DIMENSIONS SUPPLIED.

BUSBYWEBB RECOMMEND FULL MEASURED SURVEY BY CONTRACTOR PRIOR TO FINALISATION OF DETAIL DRAWINGS AND MANUFACTURING.

CROSS REFERENCE WITH OTHER DRAWINGS & CHECK ALL DIMENSIONS.

DO NOT SCALE FROM THIS DRAWING

REV DATE DESCRIPTION

ALL WORKS TO COMPLY WITH LOCAL AUTHORITY AND SITE REGULATIONS.

COPYRIGHT BUSBYWEBB 2016

DWG STATUS Design Intent



DWG NO.

CLIENT	Charmaine Abomnes
PROJECT	Bon Vivant
SITE ADDRESS	75-77 Marchmont St, Kings Cross, London, WC1N 1AP

TITLE Existing Elevation 1.50 @ A1/1:100 @ A3 SCALE DATE 15.11.16

LA CHECKED BY DRAWN BY

BW38_EL00 REVISION /




75-77 MARCHMONT STREET


04 PROPOSED FRONT ELEVATION 02 Scale 1:50



EXISTING PHOTO **EXISTING PHOTO**



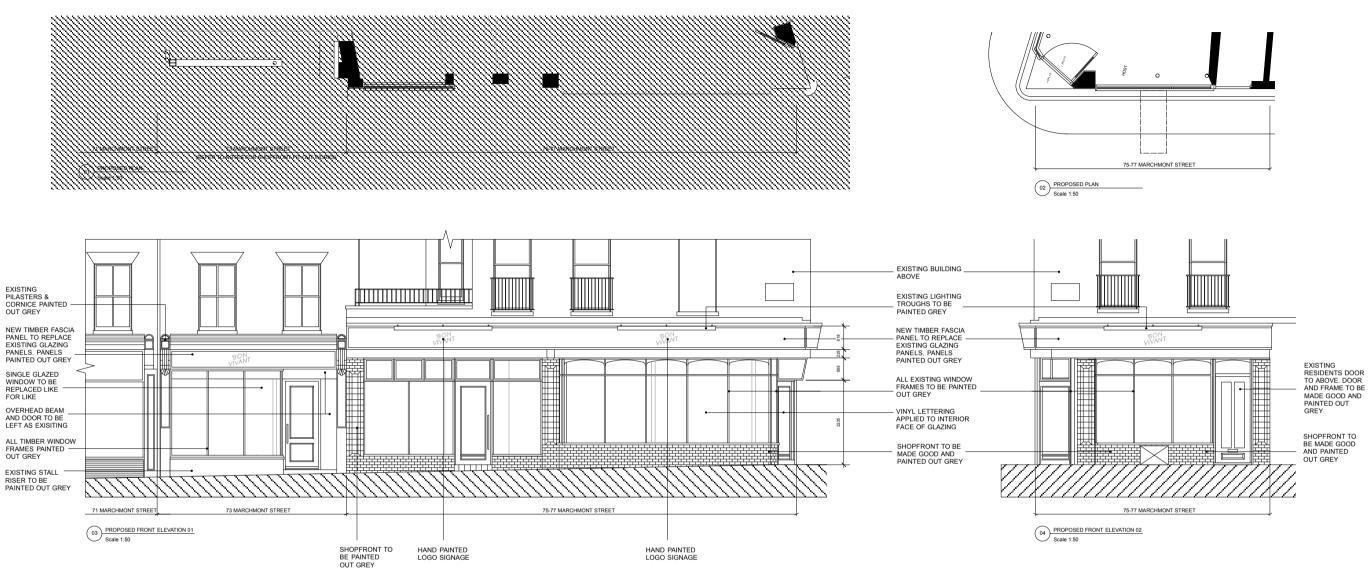

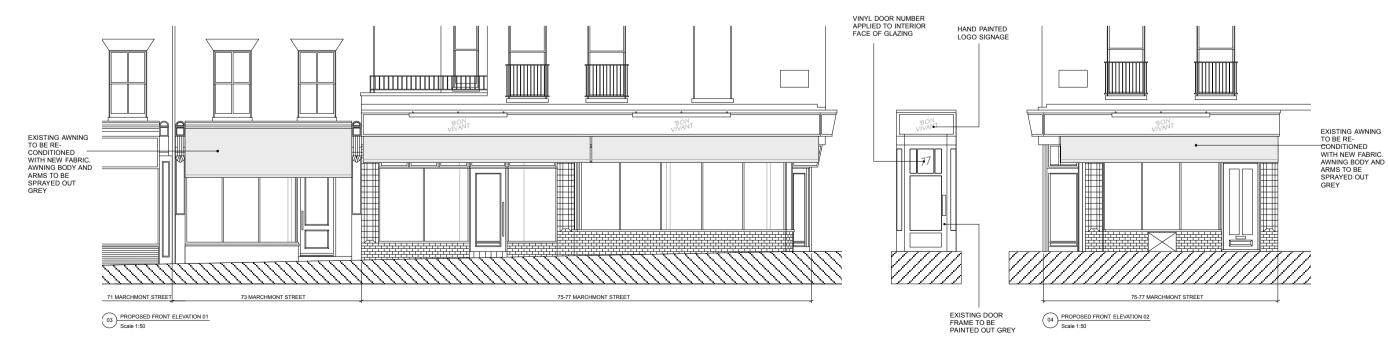

CONTRACTOR TO ALLOW FOR CONFORMING WITH THE FOLLOWING REGULATIONS AS NECESSARY

WALL FINISHES TO BE CLASS 1 GENERALLY WITH CLASS 0 FINISHES TO CORRIDORS AND CIRCULATION AREAS

CAVITY BARRIERS TO BE PROVIDED IN CEILING VOIDS AT MAXIMUM 20M CENTRES. EXCEPT WHEN THE CEILING VOID IS OVER A SINGLE ENCLOSED ROOM WHERE THEY WILL BE PROVIDED AT A MAXIMUM 40 M CENTRES

LIGHTING DIFFUSERS (IF SPECIFIED) METAL LIGHTING DIFFUSERS WILL BE USED IN THE SUSPENDED CEILING

CEILING FINISHES TO BE CLASS 0 GENERALLY THROUGHOUT INCLUDING CORRIDOR AND CIRCULATION AREAS

SPRINKLERS TO BE PROVIDED IN ACCORDANCE WITH BRITISH STANDARD 5306 PART 2, HAZARD CLASS: ORDIN HAZARD GROUP II FIRE ALARM TO BS5839 PART 1: 1988. A TYPE 'M' BREAK GLASS FIRE ALARM SYSTEM WILL BE PROVIDED, DESIGNED AND INSTALLED IN ACCORDANCE WITH BRITISH STANDARD 5839 PART 1

A SMOKE DETECTION SYSTEM WILL BE PROVIDED, DESIGNED AND INSTALLED IN ACCORDANCE WITH B STANDARD 5839 PART 1.

FIRE EXTINGUISHERS INSTALLED TO BS5036 PART 3 1983 HIRE EXTINGUISHERS INSTALLED TO SSOUGH PART 3 1983 WATER TYPE FIRE EXTINGUISHERS WILL BE PROVIDED AT THE RATE OF ONE FOR EVERY 200M SQ OF FLOOR AREA, SPECIALIST EXTINGUISHER WILL BE PROVIDED TO SUIT THE INDIVIDUAL RISKS WHEN IDENTIFIED

NOTICES TO BS6409 PART 1 1990 SUFFICIENT FIRE NOTICES WILL BE PROVIDED TO ENABLE THE OCCUPANTS OF THE BUILDING TO IDENTIFY ALL THE FIRE EXT ROUTES NOT IN EVERYDAY USE.

ALL FIRE RESISTING DOORS WILL BE PROVIDED WITH EITHER A FIRE DOOR KEEP SHUT NOTICE OR A FIRE DOOR KEEP LOCKED SHUT WHEN NOT IN USE

3 HOLIR NON - MAINTAINED EMERGENCY LIGHTING SYSTEM WILL BE PROVIDED DESIGNED AND INSTALLED IN ACCORDANCE WITH BRITISH STANDARD5266 PART 1

STUD PARTITIONING LEGEND

NEW STUD PARTITIONING
CONSISTING OF 70MM STUDS AT
MAXIMUM 600MM CENTRES FACING BOTH
SIDES WITH ONE LAYER OF 12.5MM
PLASTERBOARD SCRIMMED AND TAPED
JOINTS TO RECEIVE DECORATION

PROVIDING MINIMUM 1/2 HOUR FIRE RESISTANCE AND MINIMUM CLASS 1 SPREAD OF FLAME

NOTES

DESIGN INTENT DRAWING ONLY - BASED ON DIMENSION SUPPLIED.

BUSBYWEBB RECOMMEND FULL MEASURED SURVEY BY CONTRACTOR PRIOR TO FINALISATION OF DETAIL DRAWINGS AND MANUFACTURING.

CROSS REFERENCE WITH OTHER DRAWINGS & CHECK ALL DIMENSIONS.

DO NOT SCALE FROM THIS DRAWING

ANY CHANGES ON SPECIFICATION TO BE AGREED WITH BUSBYWEBB

ALL WORKS TO COMPLY WITH LOCAL AUTHORITY AND SITE REGULATIONS.

COPYRIGHT BUSBYWEBB 2016

REV	DATE	DESCRIPTION
A B	28/11/16 14/12/16	TILE FINISH TO PAINT ADDITIONAL INFO ADDED

DWG STATUS Design Intent


Busby Webb

hello@busbywebb.co.uk Unit G13 The Screenworks 22 Highbury Grove N5 2EF

	CLIENT	Charmaine Abomnes
	PROJECT	Bon Vivant
	SITE ADDRESS	75-77 Marchmont St, Kings Cross, London, WC1N 1AP
	TITLE	Proposed External Elevation
	SCALE	1.50 @ A1/1:100 @ A3

DATE 15.11.16

DRAWN BY LA CHECKED BY JC BW38_EL01 REVISION B DWG NO.

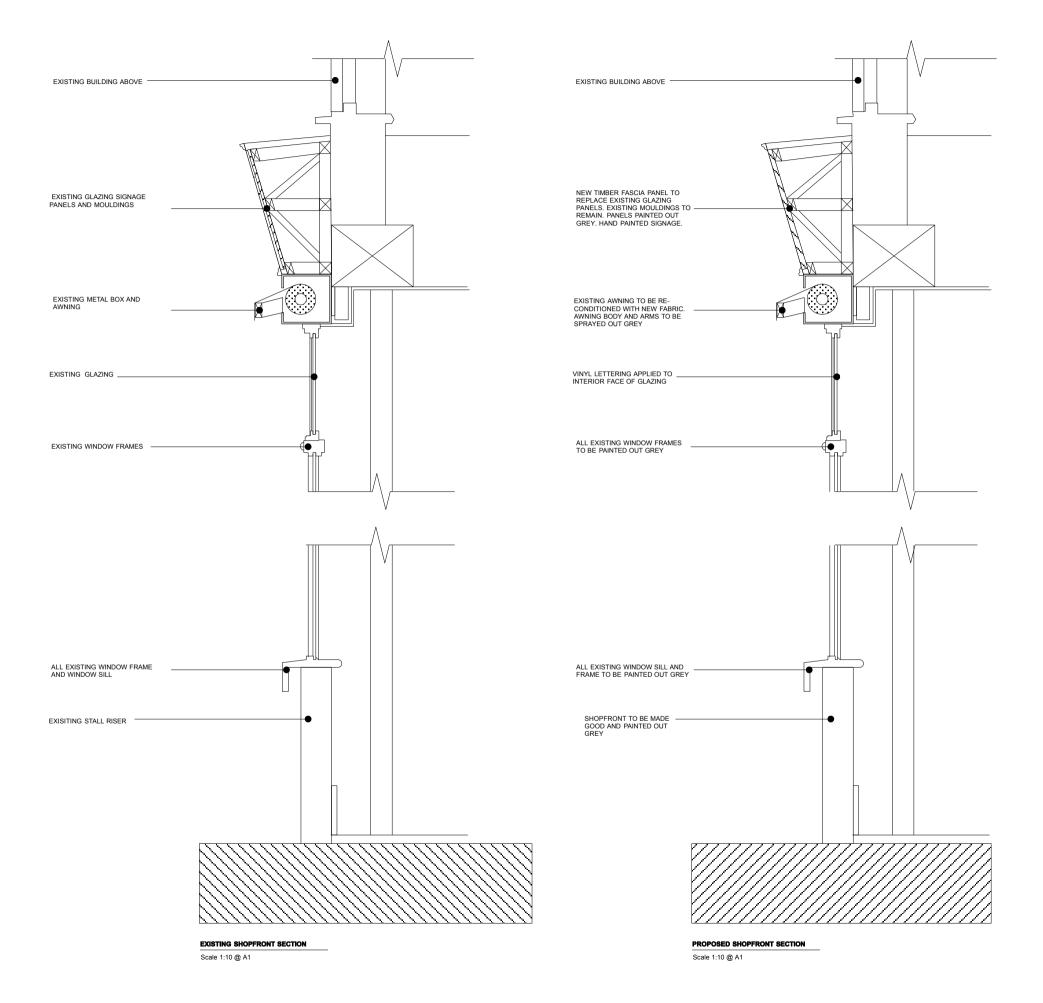

CONTRACTOR TO ALLOW FOR CONFORMING WITH THE FOLLOWING REGULATIONS AS NECESSARY

WALL FINISHES TO BE CLASS 1 GENERALLY WITH CLASS 0 FINISHES TO CORRIDORS AND CIRCULATION AREAS

CAVITY BARRIERS TO BE PROVIDED IN CEILING VOIDS AT MAXIMUM 20M CENTRES. EXCEPT WHEN THE CEILING VOID IS OVER A SINGLE ENCLOSED ROOM WHERE THEY WILL BE PROVIDED AT A MAXIMUM 40 M CENTRES

LIGHTING DIFFUSERS (IF SPECIFIED) METAL LIGHTING DIFFUSERS WILL BE USED IN THE SUSPENDED CEILING SYSTEM

CEILING FINISHES TO BE CLASS 0 GENERALLY THROUGHOUT INCLUDING CORRIDOR AND CIRCULATION AREAS

SPRINKLERS TO BE PROVIDED IN ACCORDANCE WITH BRITISH STANDARD 5306 PART 2, HAZARD CLASS: ORDINAF HAZARD GROUP II

FIRE ALARM TO BS\$839 PART 1 : 1988. A TYPE 'M' BREAK GLASS FIRE ALARM SYSTEM WILL BE PROVIDED, DESIGNED AND INSTALED IN ACCORDANCE WITH BRITISH STANDARD 5839 PART 1

A SMOKE DETECTION SYSTEM WILL BE PROVIDED, DESIGNED AND INSTALLED IN ACCORDANCE WITH BRITISH STANDARD 5839 PART 1.

FIRE EXTINGUISHERS INSTALLED TO BS5036 PART 3 1983
WATER TYPE FIRE EXTINGUISHERS WILL BE PROVIDED AT
THE RATE OF ONE FOR EVERY 200M SQ OF FLOOR AREA,
SPECIALIST EXTINGUISHER WILL BE PROVIDED TO SUIT
THE INDIVIDUAL RISKS WHEN IDENTIFIED

NOTICES TO BS499 PART 1 1990 SUFFICIENT FIRE NOTICES WILL BE PROVIDED TO ENABLE THE OCCUPANTS OF THE BUILDING TO IDENTIFY ALL THE FIRE EXIT ROUTES NOT IN EVERYDAY USE.

ALL FIRE RESISTING DOORS WILL BE PROVIDED WITH EITHER A FIRE DOOR KEEP SHUT NOTICE OR A FIRE DOOR KEEP LOCKED SHUT WHEN NOT IN USE

3 HOUR NON - MAINTAINED EMERGENCY LIGHTING SYSTEM WILL BE PROVIDED DESIGNED AND INSTALLED IN ACCORDANCE WITH BRITISH STANDARD5266 PART 1

STUD PARTITIONING LEGEND

NEW STUD PARTITIONING
CONSISTING OF 70MM STUDS AT
MAXIMUM 600MM CENTRES FACING BOTH
SIDES WITH ONE LAYER OF 125MM
PLASTERBOARD SCRIMMED AND TAPED
JOINTS TO RECEIVE DECORATION
PROVIDING MINIMUM 1/2 HOUR FIRE
RESISTANCE AND MINIMUM CLASS 1
SPREAD OF FLAME

NOTES

DESIGN INTENT DRAWING ONLY - BASED ON DIMENSIONS SUPPLIED.

BUSBYWEBB RECOMMEND FULL MEASURED SURVEY BY CONTRACTOR PRIOR TO FINALISATION OF DETAIL DRAWINGS AND MANUFACTURING.

CROSS REFERENCE WITH OTHER DRAWINGS & CHECK ALL DIMENSIONS.

DO NOT SCALE FROM THIS DRAWING

ANY CHANGES ON SPECIFICATION TO BE AGREED WITH BUSBYWEBB

ALL WORKS TO COMPLY WITH LOCAL AUTHORITY AND SITE REGULATIONS.

COPYRIGHT BUSBYWEBB 2016

REV	DATE	DESCRIPTION

DWG STATUS Design Intent

Busby Webb

DWG NO.

CLIENT	Charmaine Abomnes
PROJECT	Bon Vivant
SITE ADDRESS	75-77 Marchmont St, Kings Cross, London, WC1N 1AP

TITLE Proposed External Sections SCALE 1.50 @ A1/1:100 @ A3 DATE 14.12.16 DRAWN BY LA CHECKED BY JC

BW38_EL02 REVISION /