



- Notes**
- Mild steel frame (60x60x1,980mm)
 - Aluminium panels with anodised finish mechanically fixed to mild steel frame (1,840x10mm)
 - Horizontal glass fins fixed to screen (1,800x55x10mm)
 - Mild steel clamps with anodised finish to support glass fins
 - 6No. Floor LED fixtures (45mm in diameter)
 - 6No. External down lights fixed to screen (50mm in diameter)

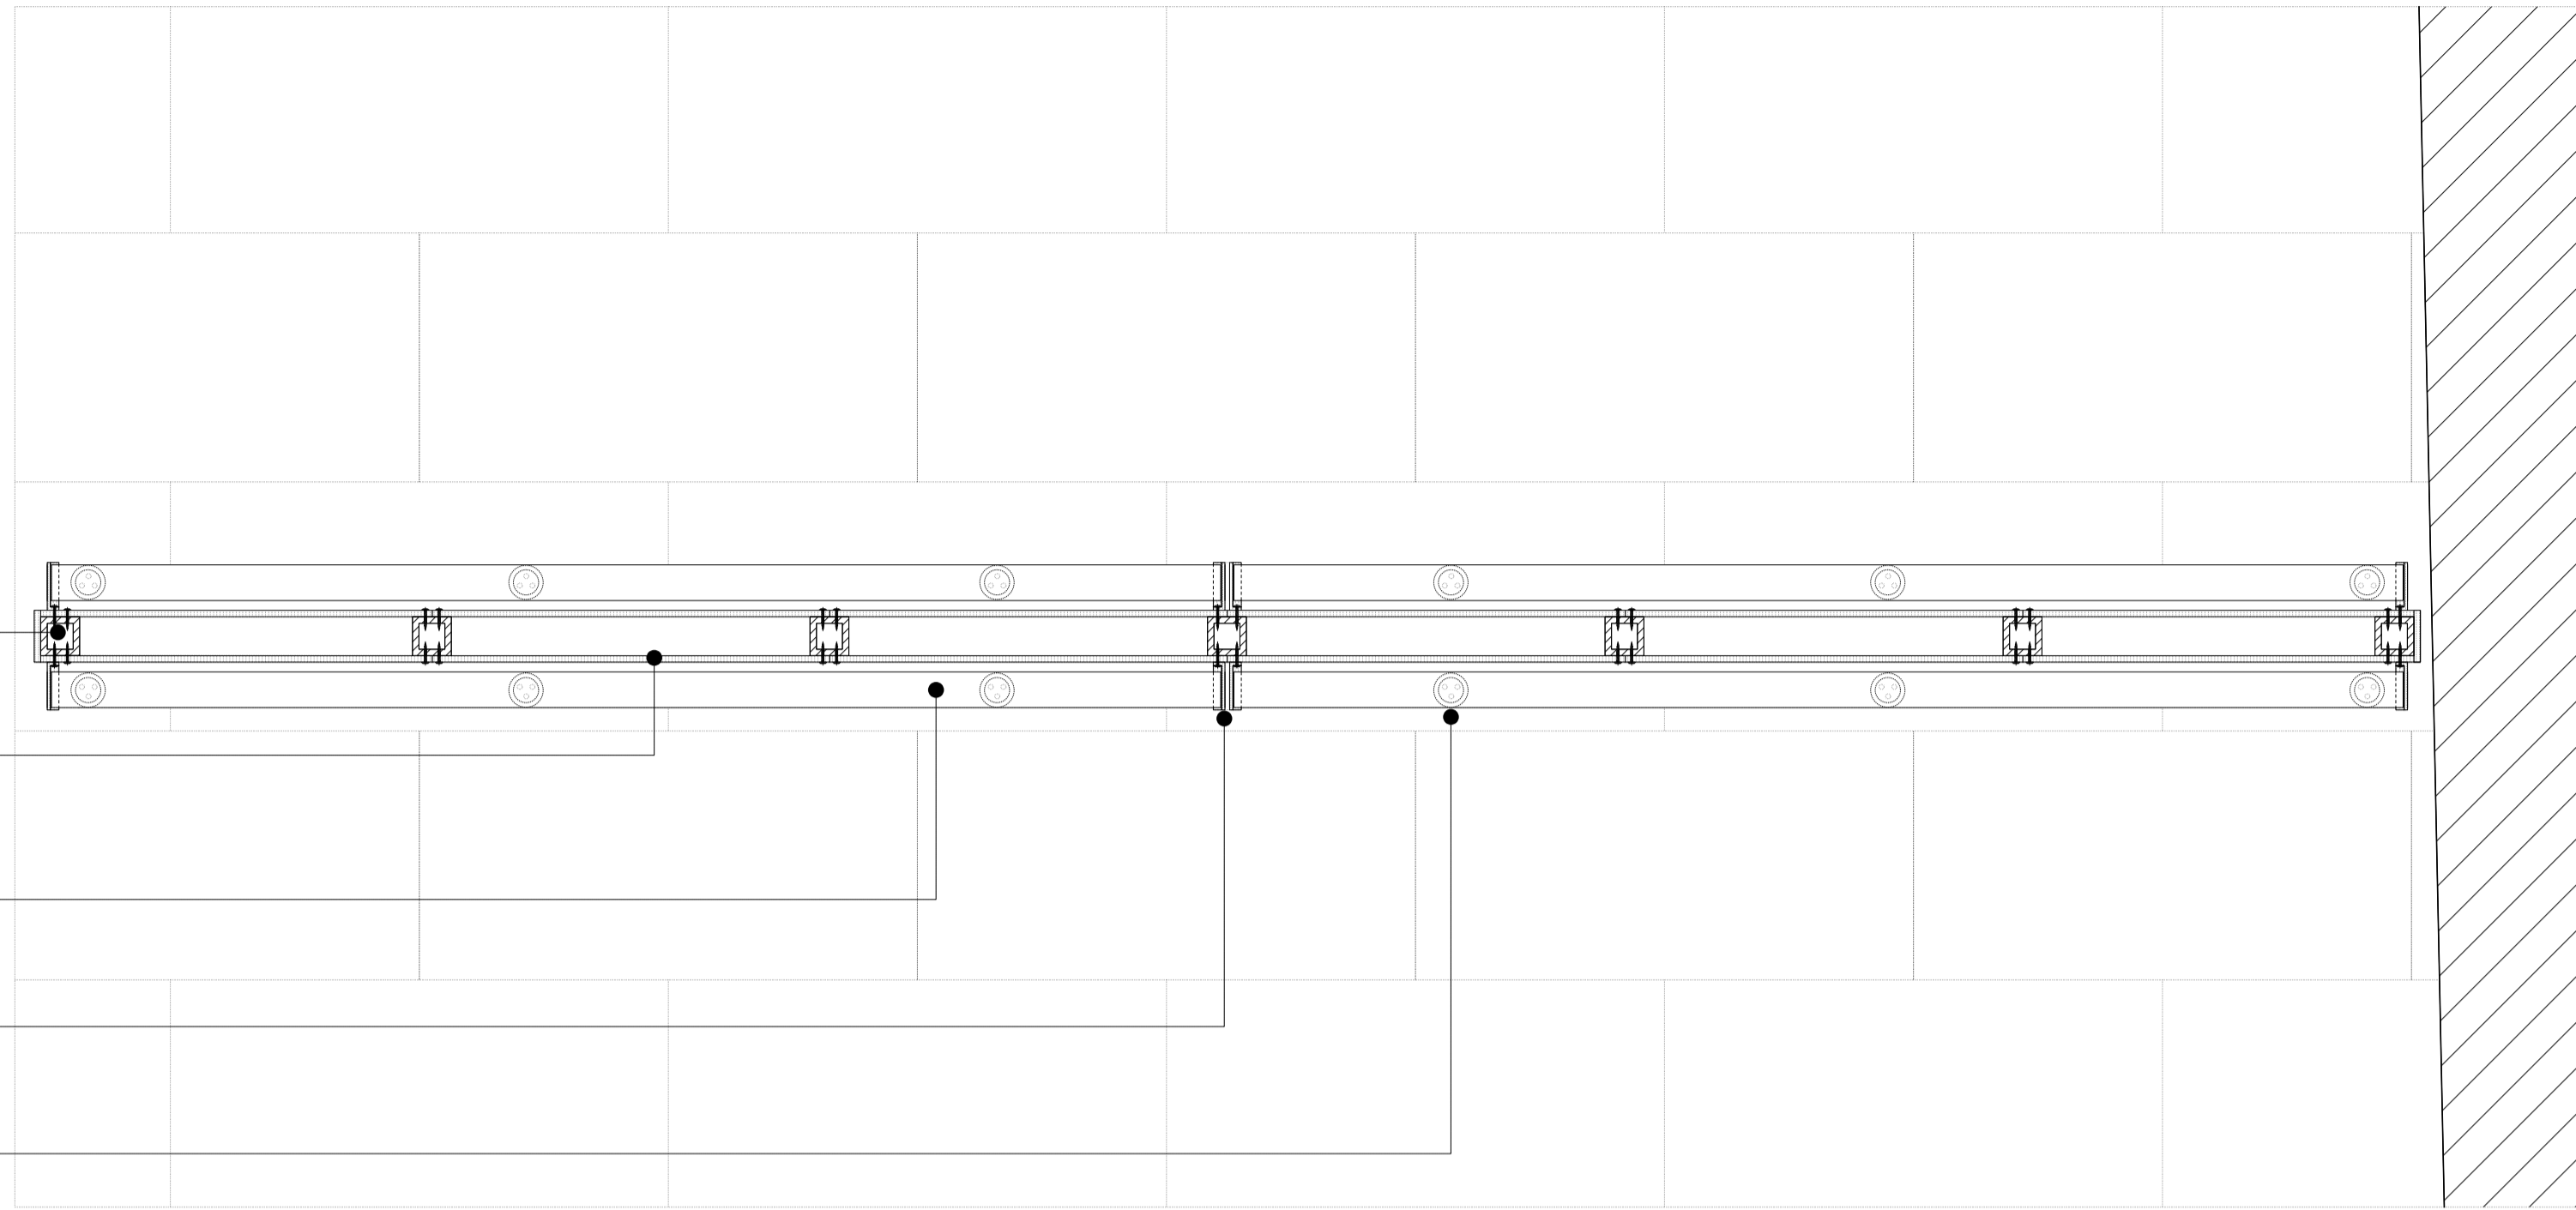

Proposed Basement Plan

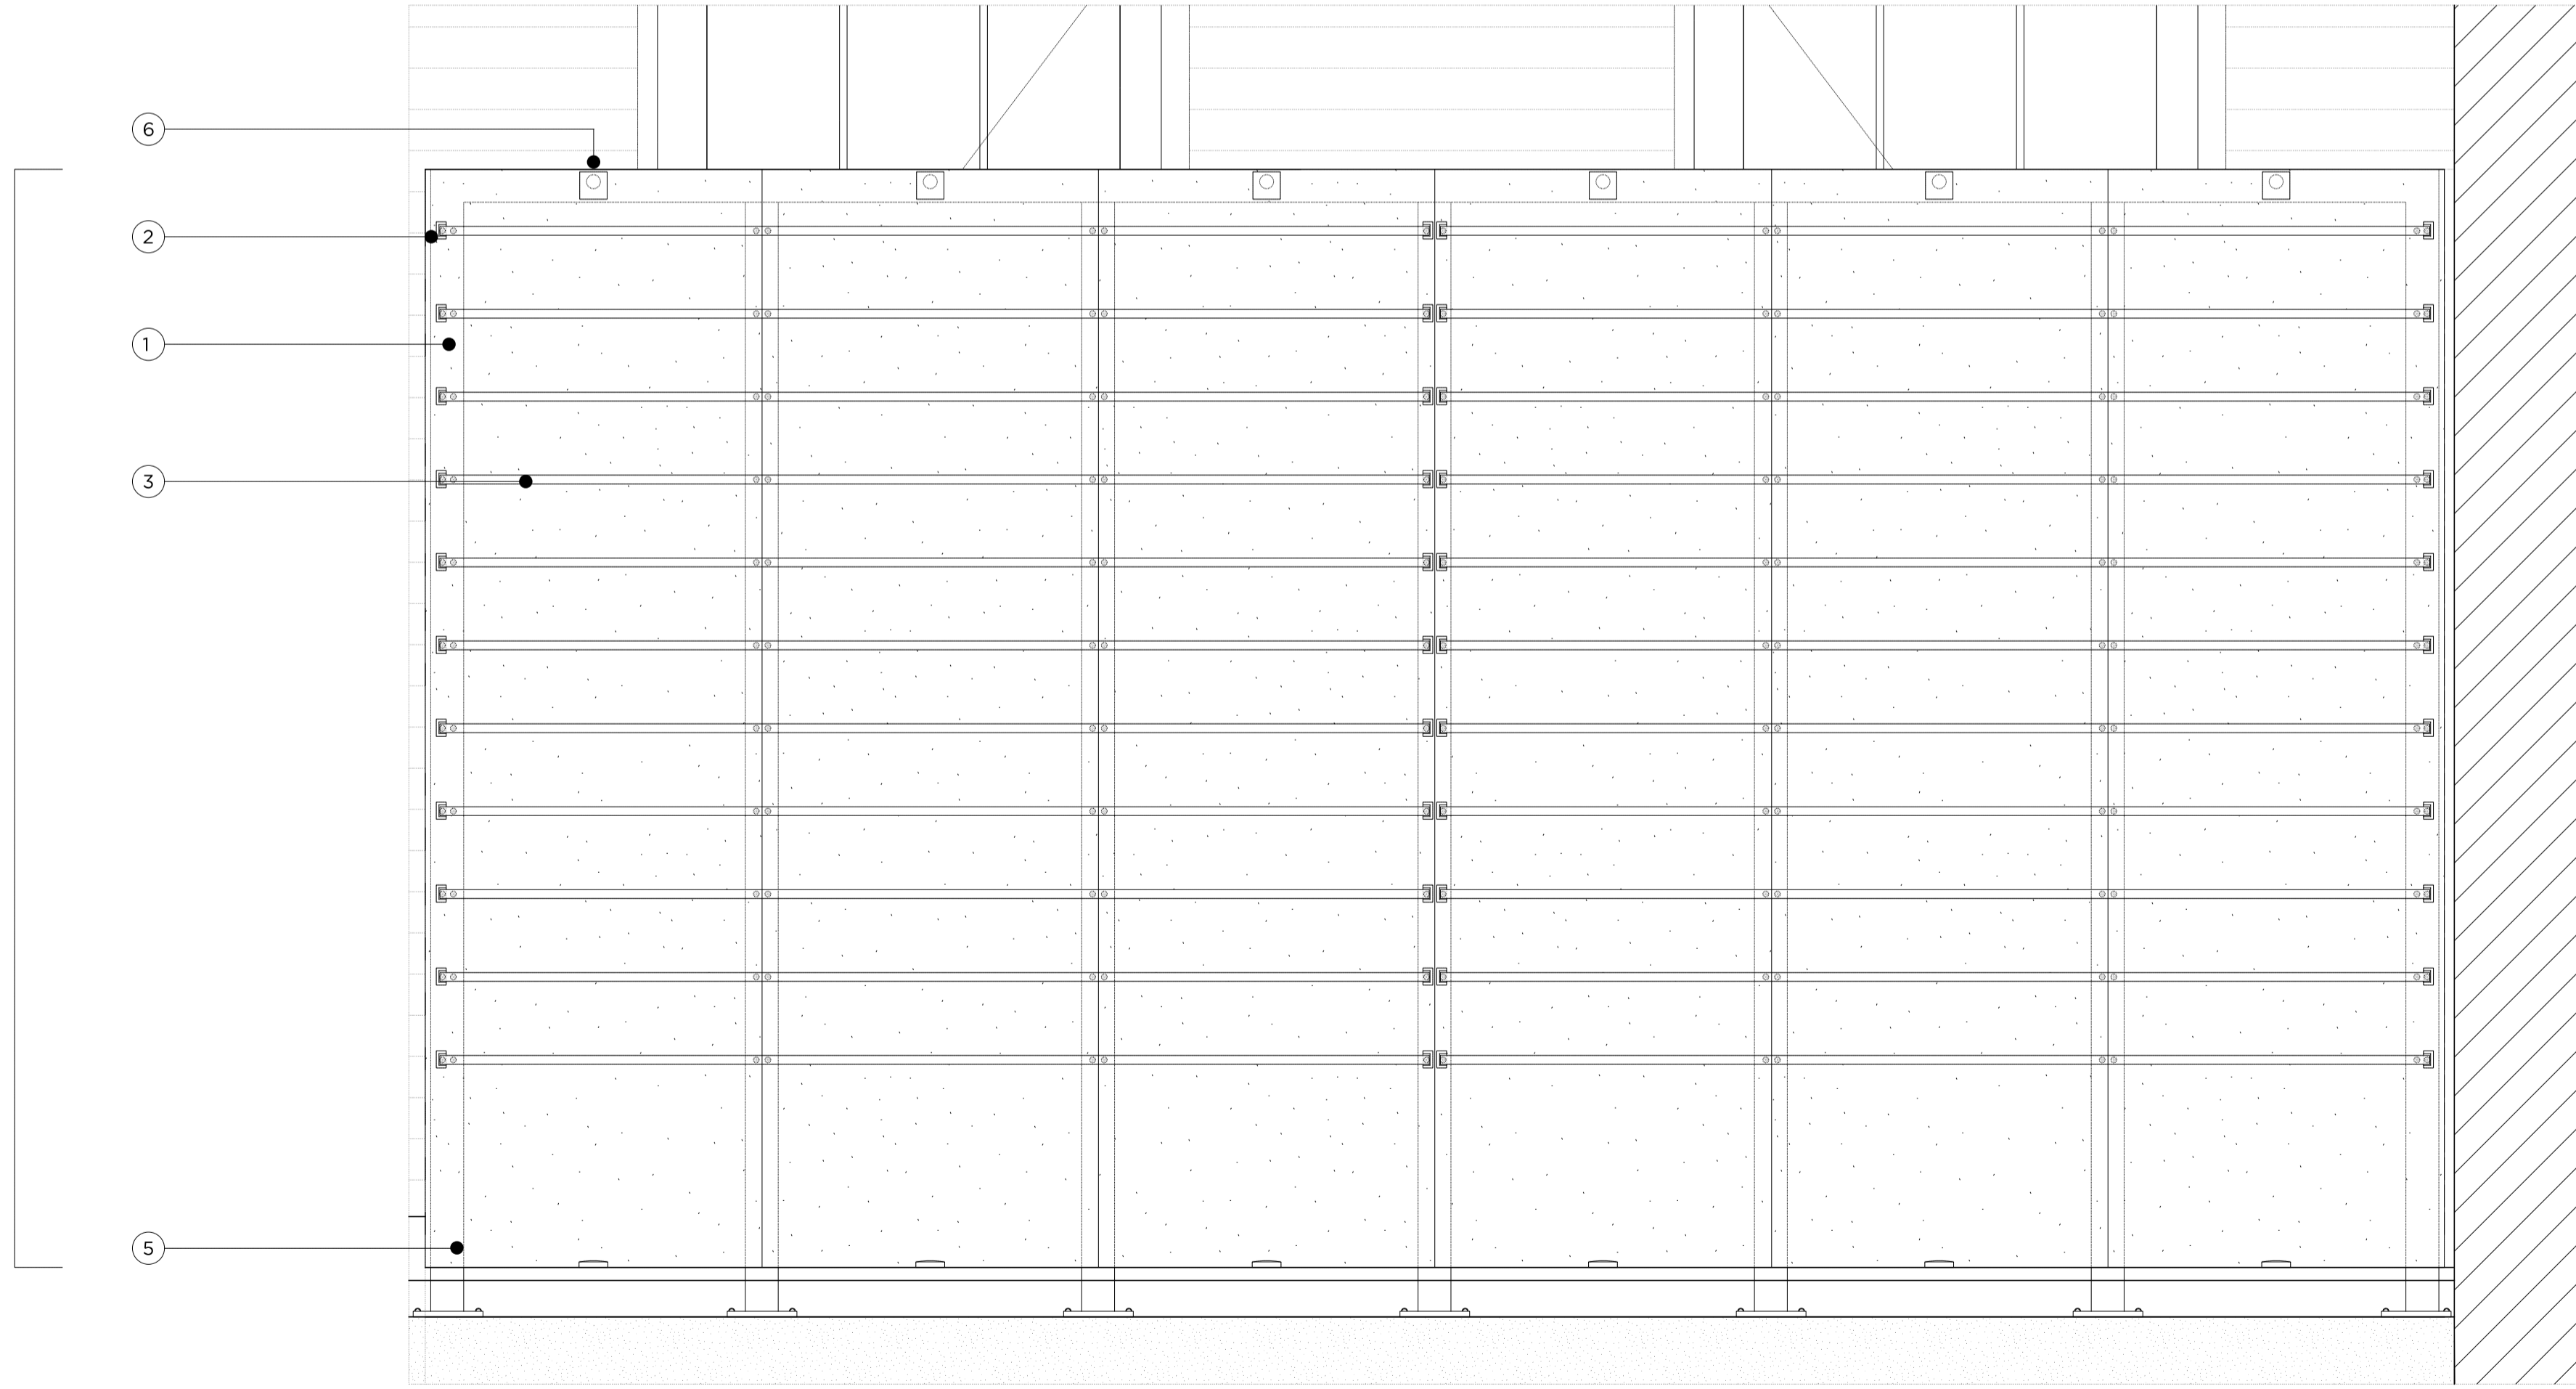

Proposed Section EE

Key Plan, Scale 1:1250

Demolition Key:

- Existing structure / ground
- Proposed removal of existing structure (in section)
- Proposed removal of existing structure/finishes (in elevation)
- Proposed removal of existing structure (in section)
- Hatch denotes removal of existing concrete slab
- Hatch denotes proposed removal of existing structure (in elevation)

Proposed finishes legend

- Proposed straight-grain hardwood floor finish on specified floor build-up
- Proposed floor finish on specified floor build-up
- Portland stone
- Timber decking
- Natural stone floor tiles
- Proposed slate roof finish on existing and new roof structure

General Notes:

- Refer to the Door and Window Schedules for a detailed summary of each door and window.
- All existing floor finishes and existing ply to be carefully removed.
- Existing floorboards to be carefully removed and reused where possible.
- New existing floorboards to be installed. New furniture/joints are to be installed to the top of the existing joists in order to level. See Structural Engineer's Information, Low profile LPH throughout.
- New drainage and concrete slab to be laid at basement level.
- Existing slate roof finish to be carefully removed and stored, and new roof felt installed. Existing slates to be replaced with new slates to match existing to replace any damaged slates. Leakywork to fill portion of the roof existing structure canopy and dormer windows to be removed and replaced on a like-for-like basis.
- Joists are to be inspected and strengthened where required to support increased loads. See Structural Engineer's details.
- Existing internal walls are to be skimmed and prepared to take new wall finishes as required. All defective existing plaster to be removed and replaced.
- All existing panelling, mouldings and cornices to have existing paint finish removed for new paint decoration.
- Existing structural timber beams to be exposed and treated with wood preservative. Ends to be wrapped in DPC and rotten timber to be replaced.

Proposed legend notes

01 Existing gannalling to be refurbished and redecorated.	22 Proposed condensers in attenuated enclosure, refer to M&E design
02 Existing window replaced with double-glazed, timber framed sash window.	23 Reinstated stair to basement level, with compliant, traditionally-detailed, timber balustrade.
03 Non-original fireplace to be removed and replaced with traditionally-detailed fireplace.	24 New, single-glazed, timber framed window to match existing, fitted with secondary glazing internally.
04 Non-original skirting/trunking to be removed.	25 Existing fireplace to be protected and covered.
05 Traditionally detailed, compliant, timber substitute to replace existing.	26 Reconfiguration of existing stair.
06 Existing sash windows refurbished and fitted with secondary glazing internally.	27 New dummy window.
07 New, trompton bicycles & £250 bicycle voucher to be supplied to each flat.	28 New double-glazed, traditionally detailed French door.
08 New, double-glazed, timber framed sash windows. Refer to Detail & Access Statement.	29 Lining to party wall.
09 New lift.	30 Proposed head dormer arrangement to pass through with existing windows. Reconfiguration of existing non-original dormer windows.
10 Damaged window sills replaced on a like-for-like basis.	31 Terrace to flat 02, with new planting and Yorkstone paving.
11 Lightwell to be lowered by 1100mm. New, painted metal stair to accommodate level change.	32 Existing joists to be trimmed out. Single, surviving cast-iron spindle to ground floor stair to be preserved and maintained.
12 Existing rear envelope retained. New, contemporary, insulated rear elevation to be installed.	33 Single, surviving cast-iron spindle to be preserved and maintained.
13 Proposed bin store.	34 Existing structural timber beams to be exposed and treated with wood preservative. Slates to be removed, retained and new membrane installed. Existing slates to be re-laid and any new slates to match existing.
14 New, double-glazed, anodised aluminium, restricted tilt framed windows, with etched glass louvers fitted externally.	35 Slates to be removed, retained and new membrane installed. Existing slates to be re-laid and any new slates to match existing.
15 New, fixed, double-glazed, anodised aluminium framed glazing panels.	36 Facade Refurbishment.
16 New double-glazed, walk-on rooflight.	37 Existing facade to be re-rendered and redecorated.
17 New double-glazed, conservation rooflight.	38 Etched glass partition.
18 Partial demolition of existing roof, new ridge proposed, matching height and width of existing.	39 New Railings.
19 New, automatic-opening vent to communal stair.	40 Fixed & obscure proposed windows.
20 Terrace to the roof of proposed rear extension, with timber decking and glass balustrade.	41 Proposed Roof
21 New, proposed condenser in attenuated enclosure.	42 Paint to be removed from Brickwork and redecorated as required.

Rev A	01.11.16	Issued for planning submission
Rev -	16.09.16	Issued for planning submission

PLANNING

Project No. **14029**

Client **GFZ Developments Ltd.**

Date **October 2015**

Scale **1:20@A3 / 1:10@A1**

Project **7 Warwick Court**

Drawing Title: **Proposed Privacy Screen**

Drawing No. **P_18** Rev. **A**

Drawn	Approved	Signed
DI	MW	AB

Marek Wojciechowski Architects Ltd.

66-68 Margaret Street W1W 8SR T. 020 7580 9336 www.mw-a.co.uk

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0 0.5m 1m 2m 3m 4m 5m