
# APPENDICES

### **APPENDIX A**

Site plans




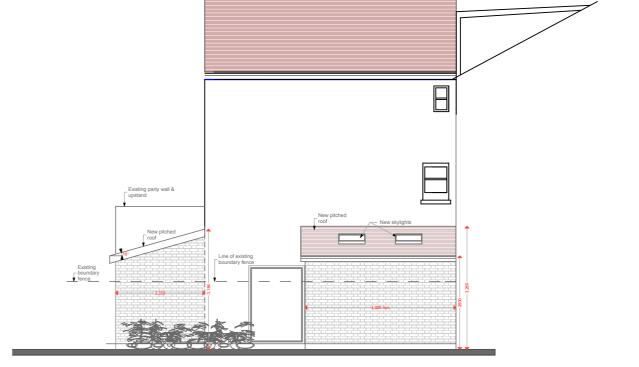

PROPOSED REAR ELEVATION

PROPOSED SIDE ELEVATION



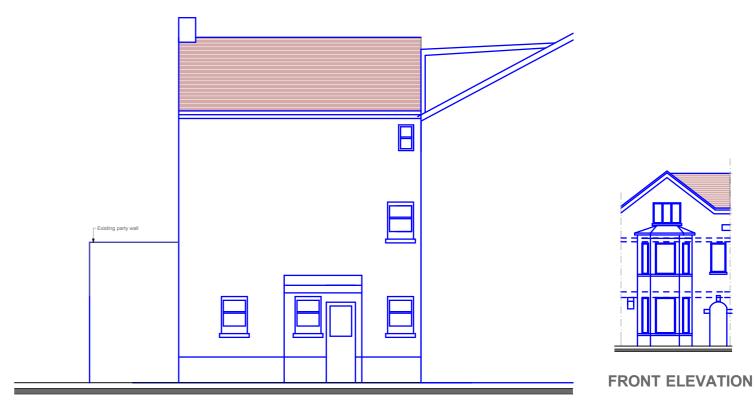

**EXISTING REAR ELEVATION** 

**EXISTING SIDE ELEVATION** 

0 metres

#### Project: 4 Ingham Road, London NW6 1DE

Client: Mr. & Mrs. O'Connor Project No:270

Date: Jan 2015

**Dwgs:** Elevations Scale: 1: 100


Dwg No: PP/ 270/02 Rev. :D


ADMC Ltd.


Architectural Design & Management Co.


7 Ridge Hill, London NW11 8PN. T: 020 8922 8825 E: admcltd@btinternet.com

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Client: Mr. & Mrs. O'Connor

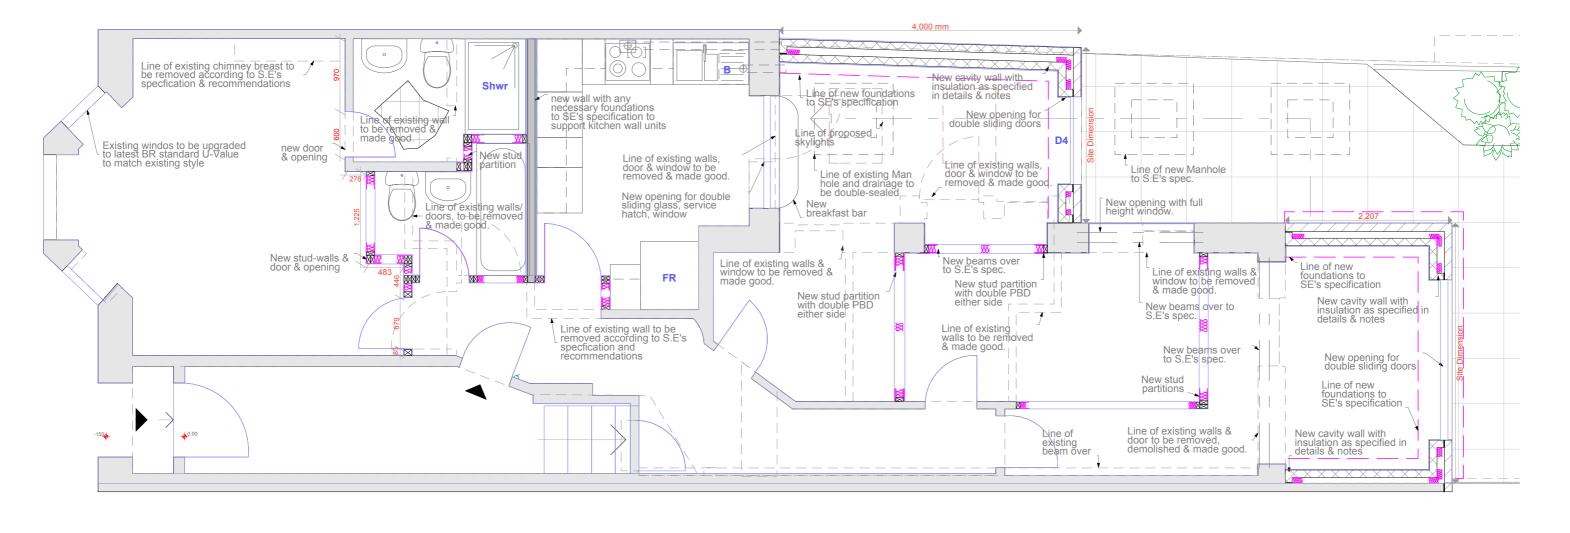Project no: 278

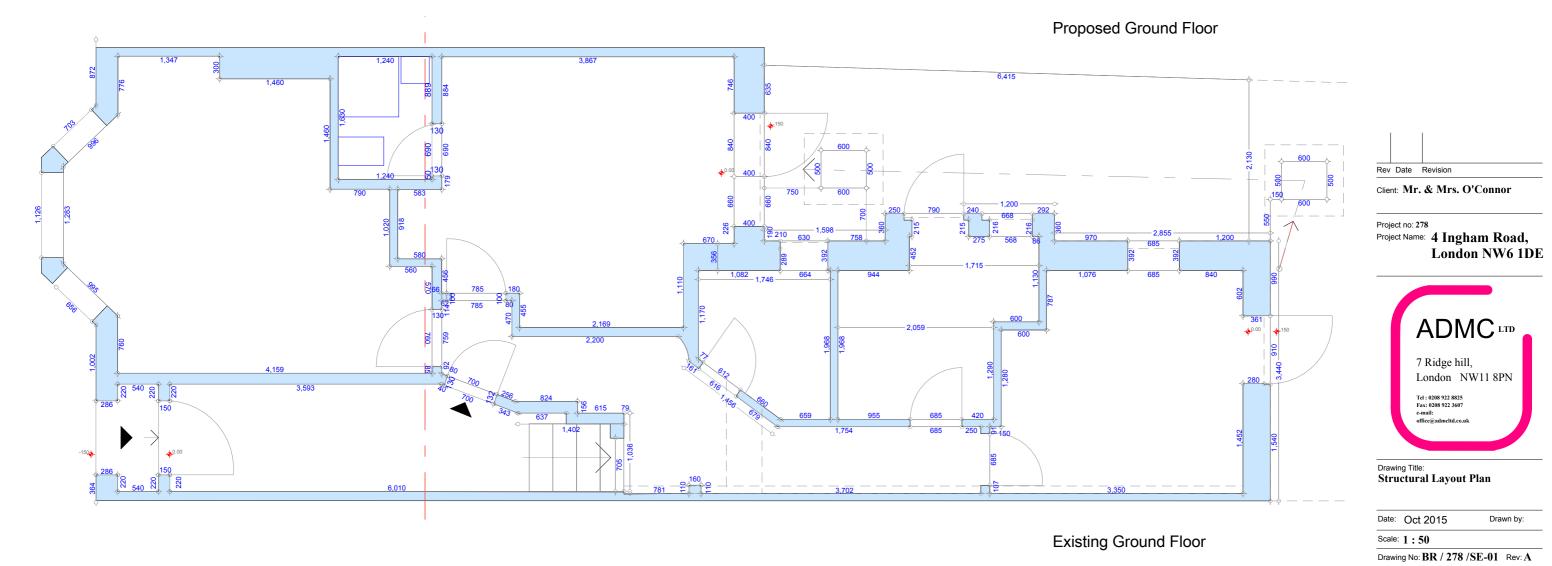Project Name: 4 Ingham Road, **London NW6 1DE** 

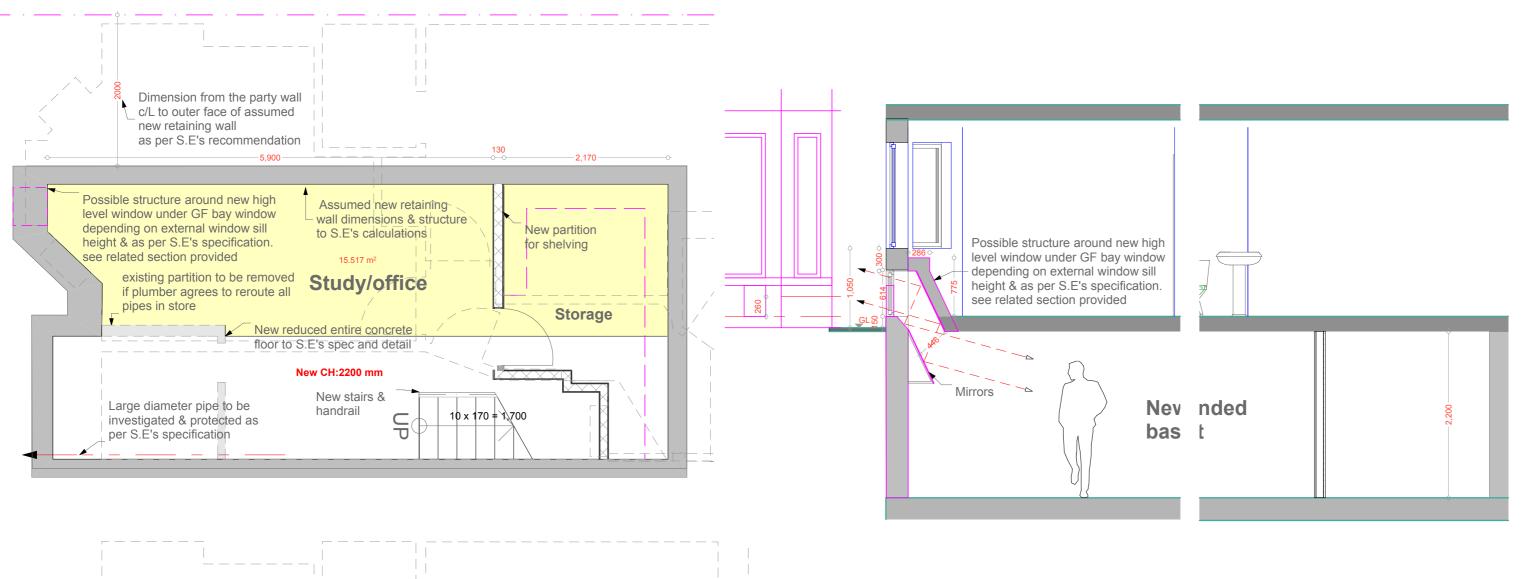

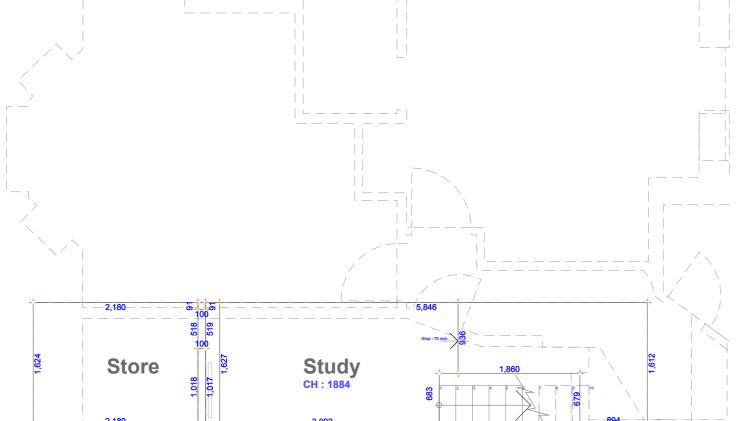Drawing Title:

**Basement Structural Layout** Plan & Section

Date: Feb 2016 Scale: 1:50

Drawing No: BR / 278 /SE-01 Rev: B

## **APPENDIX B**

**BGS** borehole logs

British Geological Survey

MGRD

CLGB

Le.

Scale: I in. = 5 ft. a Disturbed Sample

SOIL MECHANICS LTD, 65 OLD CHURCH ST., SW 3

British Geological Survey بالمهادي وطالق الهوازان والمقدوران والمواقع Fig. 1 BOREHOLE LOG 3117 Westfield College, Hampetend, N.W.3. Council of Westfield College. PREHOLE NO. DIAMETER : 8 Inch British Geological Survey British Geological Survey ROUND LEVEL: 71.7 above DATE: 14th to 16th March, 1959 Clients erbitrery datum Reduced Legend Sample Depth Thickness M/C Description 0101 +71.7 MADE GROUND 119" +69.9 itish Geological Survey 23e logical Survey fire mottled grey and. mening brown and more sandy (CLATGATE BEDS) 12'9" 25 British Geological Surve British Geological Survey 1416" im becoming stiff light grey-brown sandy clayey 416 30 (Probably Claygate Beds) 1910" +52.7 26 29 stiff dark grey silty CLAY ally slightly fissured and my stiff below 40 ft. 20 3119 (LONDON GLAY) 25 3120 29 27 3116" 26 25 25 British Geological Surve British Geological Survey 25 25 British Seplogical Survey British Geological Survey Water Level Observations 5016" Depth Depth Depth BID OF BEURIOUS 17 259 0720 50'6' British Geologi △ Water Sample Core Sample

British Geological Survey

British Geological Survey

British Geological Survey

British Geological Survey

Fig. 2 British Geological SorrEHOLE LOG British Geological Survey British Geological Survey OCATION NO. 3117 Westfield College, Hampstead JARRIED OUT FOR Council of Westfield College. BOREHOLE NO. 2 DIAMETER: 8 10ches GROUND LEVEL: 62.0 ft. above DATE: 19th March, 1959 Olients erbitrory datum REDUCED LEGEND SAMPLE DEFTH THICKNESS MIC DESCRIPTION Birtish Geological Survey British Geological Survey \*62.0 \*61.5 016" 010 forsoIL with turf 1016" SOIL soft becoming firm to stiff brown and grey mottled sandy clayey SILT, 13'6" 25 (CLAYGATE BADS) British Geological Survey CLGB British Geological Survey +4840 14'0" Coarse gypsum crystais 30 Fire becoming stiff at 15 ft and very stiff at 28 ft. grey slightly fissured silty CLAY containing fine gypsum (LONDON CL.Y) 21'0" 27 British Geological Survey British Geological Survey British Geological Survey Date Time Berkett Coming to Weter 3510 AND OF BOTTHOL British Geological Survey Britis SOIL MECHANICS LTD., 65, OLD CHURCH ST., S.W.3.


British Geological Survey

British Geological Survey Fig. 3 BOREHOLE LOG CATION NO. 3117 Westfield College ARIED OUT FOR Council of Westfield College REHOLE NO. 3 DIAMETER : 8 Inches Hound LEVEL: 62.3 ft. above DATE: 20th and 21st Karch, 1959 British Geological Survey British Geological Serv clients arbitrary datum Thickness Ma Reduced Legend Sample Depth Description +62.3 0104 WIL with turf 110 1'0" SOIL 0 31 British Geological Survey British Geological Survey British Geological Surveyire becoming stiff brown al gray mottled sandy milty.

Lif. Vory sandy at the oin.

(GLAYGATE BEDS) 14'0" CLCB British Geological St British Geological Survey British Geological Survey 15'0" 29 7 457 uc. 3119 3120 slightly fissured silty British Geological Survey (LOND N'CLAY) 3510" British Geological Survey British Geological Su British Geological Survey Water Lavel Observations British Geological Survey British Geological Survey Dapth of Copth of Depth : 5010" +12.3 Dota Berchele Caring Water 15 24 21-3-59 6730 10. 0. PINKRIE AO GRF Scale: I in. . 5 ft. . Disturbed Sample | Core Sample British Geological Survey British Geological Survey △ Water Sample SOIL MECHANICS LTD; 65 OLD CHURCH ST, 5.W 3

TO/28NE/119
British Geological Survey 2537-8575.

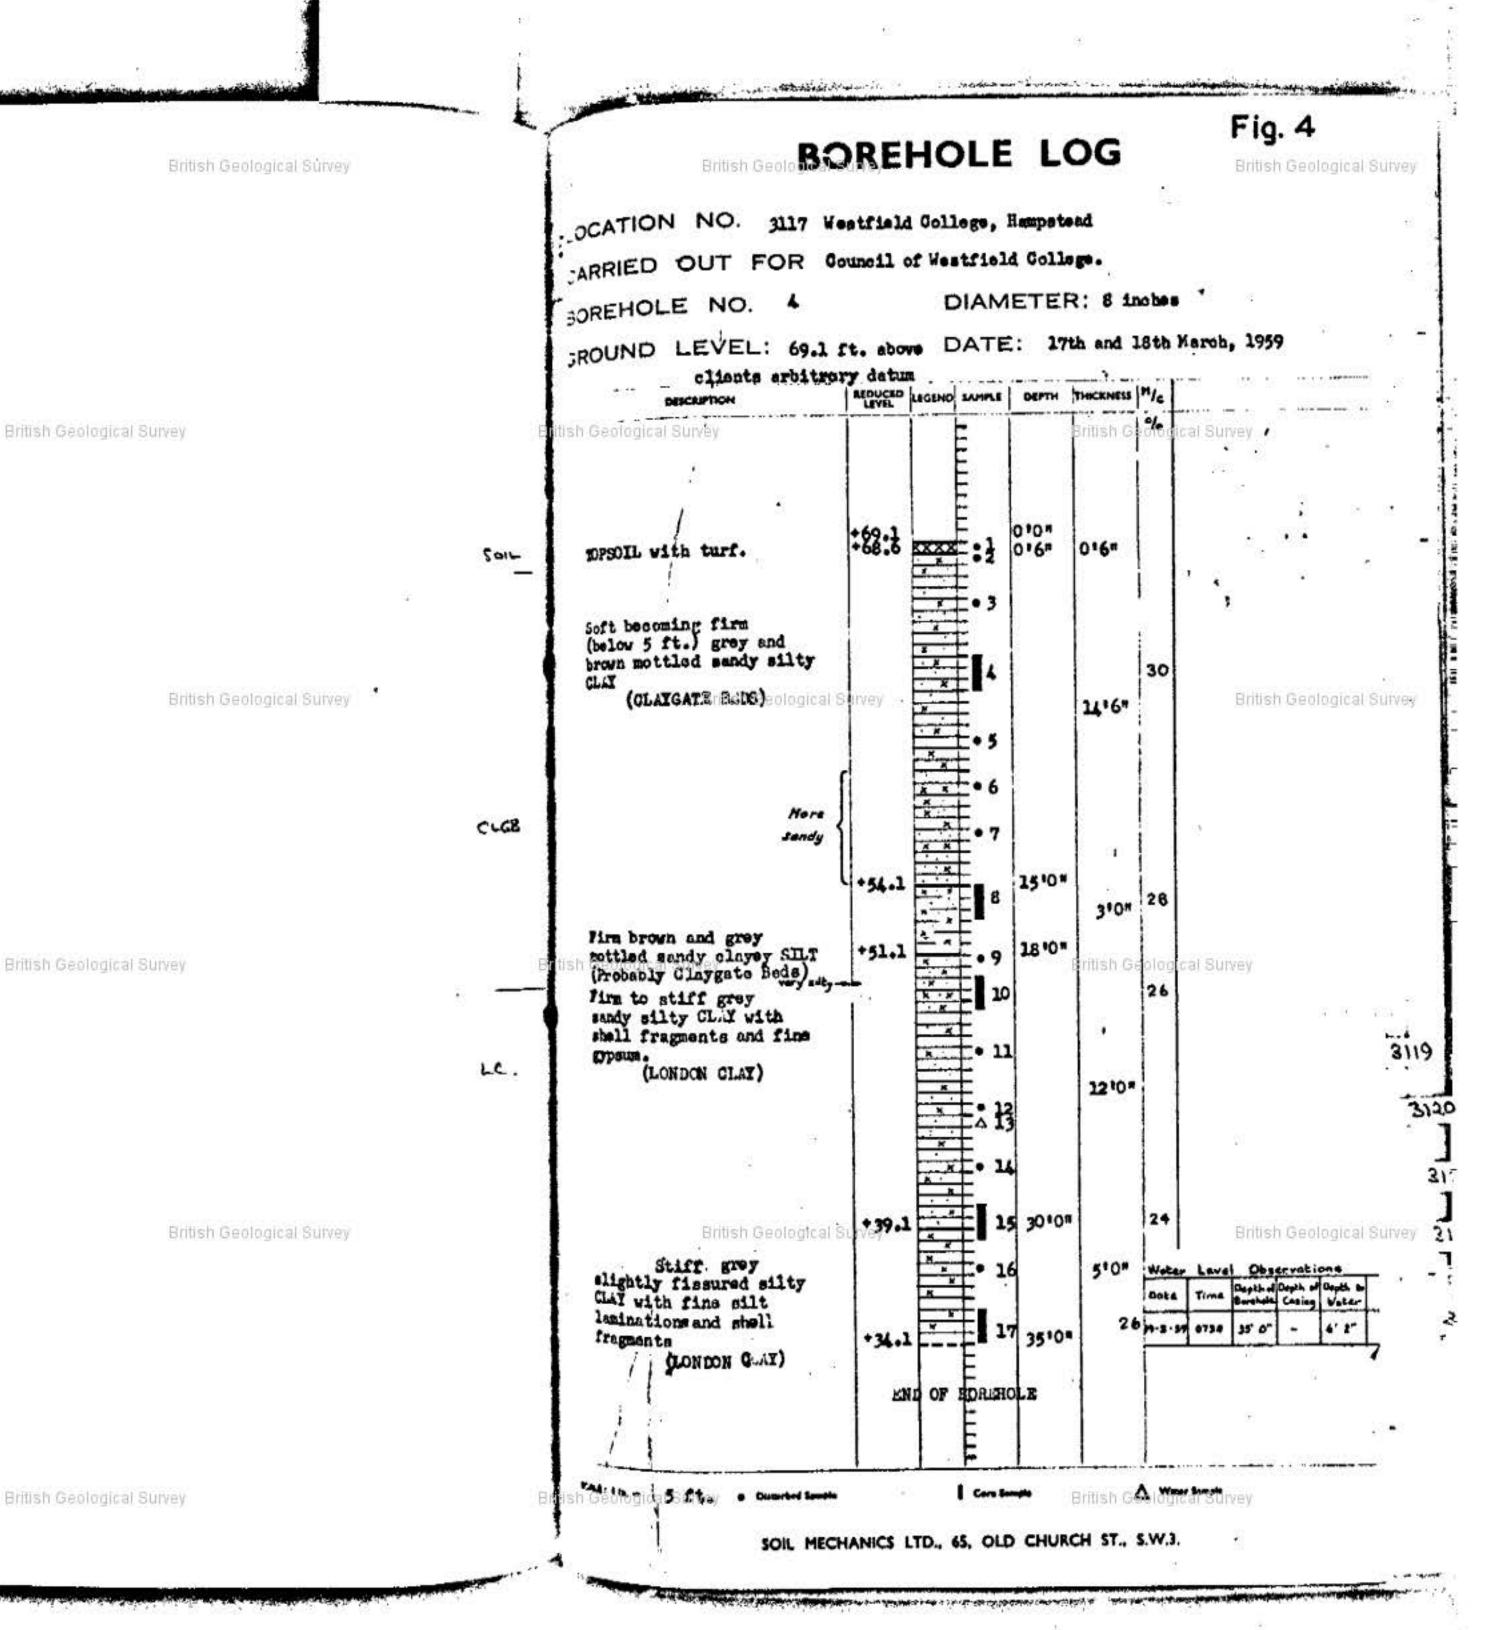

Ţ	Department of the Environment	ent	Investigation	No. Appendix A				
Statis		rdington	FGI	E/1491 Sheet No. 2 British Geological Survey				
	T. E. Extension		HAMPSTEAD					
l	BOR	REHOLE	LOG	Q 28 NE 129 2594 8515				
	Borehole No. 1  British Geological Survey  Ground Level 62-0m A.O.D (approx  Date 11th - 12th, 16th - 18th June 196		ght Cable Po sting-250m Open	below G.L.  Iled - details below				
		gend Sample		Remarks				
Elitis	GOCONGRETE RITER CO.	al Survey	G.L - 62-0 0-2 - 61-8	Standpipe installed to				
	MADE GROUND:- CLAY, sandy, brown, soft to firm, contains scattered cinders, brick	₩	0.7	29.0m below G.L. Bottom 3m of pipe elotted and surrounded by a 4.0m				
MGRD	fragments and flints with lenses and layers of soft organic clay	<b>™</b>	1.2	Gravel response 3000 sealed by a 2.0m thick				
	CLAY, Brown, firm, wilty, lightly E	British Gaelog	1.5 - 60.6	Bentonite plug. Hole backfilled with clay. British Geological Survey				
(m) F(	layers Classo CH	28	2.5					
	E							
Ekitis	Firm to stiff, silly, fissured.	aj Survey 44	3.5	British Geological Survey				
	encentrated into thin		4.0	Reduced to 200 mm dia. boring from 4.0m below G.L				
	layers and pockets, there are also a few small isolated carbonaceous packets  Closs? CH	LW	5-0					
	CLAY, as above, becoming stiff with more pronounced	5G British Geolog	ical Survey	British Geological Survey				
• .	Fireburing Clause CHE							
72	Fissured, with scattered amall Gypsum crystals	~ 59 <b>]</b>	7.0					
Britis	throughout and occasional E seological Survey will/ sand	al Survey	733.166.46	British Geological Survey				
	CLAY, an above, becoming darker brown Classich	31	9.0					
!			8.5					
	clay, Grey brown, etiff, fairly eilty, well firewred, with numerous small Gypsum crystal throughout	British Geolog	9-5	Water added in small quantities to assist boring throughout				
ì	(WRATHERED LONDON CLAY)	ال لنت	. 1 10.0上 52.	contd.				

Department of the Environ			invasii	gation FG1	7	Appendix Sheet No.	3
T.E. Extension	HAMPSTEAD  TO 28 NE 1129 2594 8515						
Borehole No1 contd.  British Geological Survey  Ground Level		Nore: British Geolo				e British Ge	ological Survey
Description of Strata	Legend	Sample	Depth	O.D.		Remarks	
			(E)	( <del>LL</del> )			
(WEATHERED LONDON CLAY)	e glwen	vey •	10-0 -	- 52-0	British (	Seological Survey	*
clay, Gréy, stiff, fairly silty, well fissured with scattered small pockets of brown silt		101	11-0 -	50-9	¥ Gro 11·1r	und water n below G.L	level al on 27·8·1
Class? CH British Geological Survey		iritish Geolo				British Ge	ological Survey
clay, as above with the addition of a few scattered fossil shall fragments		φ <b>Β</b>	13.0		270 270	105 105	
CLAY, as above, contains a few small nodules of Pyrites  Class? CH	Se Mogical Sur	G4 <b>I</b>	14.0		British (	Seological Survey	
British Geological Survey		Blitish Seolo	15 · B gical Survey 10 · O	<u> </u>		British Ge	ological Survey
				Ŋ.			
tish Geological Survey British C	Seo ogical Sur	21 I	17-0	†	British (	Seological Survey	
CLAY, as above, becoming stiffer and very fissure with a blocky and brittle structure  British Geological Survey  Class? Ch	E	GS I	18-5 19-0 gical Survey		Reduc	ed to 150 m	non dia

T = F.L			-	L	IAMDO	TEAD	N	
T. E. Extension BOREHOLE			HAMPSTEAD  LOG TO 28 NE 129 2594 8515					
					2594	3515		
Borehole No	В	Nore: Iritish Geolo				British G	eological Survey	
Description of Strata	Legend	Sample	Depth (m)	0.D. (m)		Remarks	<b>&gt;</b>	
Geological Survey  CLAY, are previous sheet	eological Surve	55 <b>I</b>	20-0 -	- 42-0	British	Geological Survey	•	
		_	21.5		<u></u>	737		
British Geological Survey		85 Iritisk Geolog	: <b>5</b> 570		§ •	British G	eological Suivey	
clay, becoming very stiff and extremely fissured and brittle below 24.0m B.G.L. Too hard to sample, threads sheared on sampling	ediogical Surve	05 <b>I</b>	23.5		<b>∴</b> British	Geological Survey		
tubes when attempting withdrawal. Clay contains numerous fossil fragments, pyrites and fairly frequent thin layers and lenses of dark		↓ ③	2.4-7		7.4	British 6	eological Survey	
SLEA FILL FOUND		₽®	26.2				s oriegresit centrally	
Geological Survey British G	eo <b>G</b> ical Surve	1	27.7		British	Geological Survey		
1983 1983		<b>(47)</b>			All properties of All soperior and recommendations	iter entries	, observe	
(LONDON CLAY) British Geological Survey		Ir ish Geolo	gical Signey.			note dry of t	enginsvey	

# GEOLOGICAL SURVEY OF GREAT BRITAIN

RECORD OF SHAFT OR BORE FOR MINERALS

Name of Shaft or Bore given by Geological Survey:

Name and Number with by owner: by owner:

6-inch Map Registered No.

TQ28NE/21

(For Survey use only)

COLORDO	
Nat	Grid Reference
l	2546.8526
l	Contish Geological Survey

1" N.S.Map 1" O.S.Map Confidential or not

197.34 If not ground level give O.D. of beginning of shaft

..... Date of sinking.....

Date received

Examined by.....

British

Purpose for which made...

Made by .....

Information from.....

Ground Level at shaft relative to O.D....

#### SPECIMEN NUMBERS AND ADDITIONAL NOTES

map, if possible.

British Geological Survey

(For Survey use only)		THICKNESS		DEPTH		
GEOLOGICAL CLASSIFICATION	DESCRIPTION OF STRATA	Fr.	IN.	Ft.	I I	
British Geological Surve	Vegetable Mould	<i>t</i>   1	в/	sh Geological Sui		
ngra	Store growel. Mould with	1 (	/	` 2	2	
Lc (~)	Hard yellow clay	1	0	+		
eological Survey	British Geological Survey	British Geologie	al Survey			
		,,,,,,,,,,,,,,,,,,,,,,,,,,,,,,,,,,,,,,		***************************************		
British Geological Survey	British Geological Survey		Brit	sh Geological Sui	rvey	
				***************************************		
eological Survey	British Geological Survey	B <b>a</b> tish Geologia	al Survey			
British Geological Survey	British Geological Survey		a.v Brit	sh Geological Sui		

# British Geological Survey WEST END LABNE Elogid WEST HAMPSTEAD eological Survey

# FIRE BRIGADE STATION

SECTION Nº43

British Geological Survey


British Geological Survey

British Geological Survey

TOP STRATUM

GEOLOGICAL CLASSIFICATION

British Geological Survey

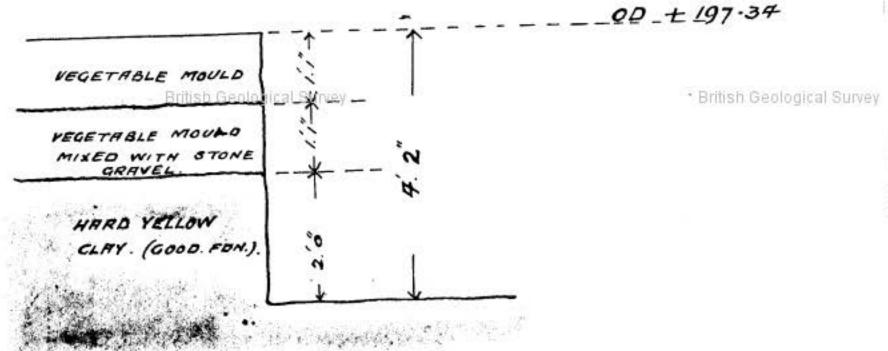

British Geological Survey

British Geological Survey

British Geological Survey

SCALE ZINCH = I FOOT.

British Geological Survey

British Geological Survey

British Geological Survey

TO 28NE/32 2539.8519 256

British Geological Survey

British Geological Survey

British Geological Survey

# **APPENDIX C**

Figure 2 Geological Map, ARUP 2010

