

28th July 2016

Belsize Fire Station – 36 Lancaster Grove, NW3 4PB London

Daylight & Sunlight

In addition to our Daylight and Sunlight report issued on the 11th February 2016, we have been instructed to provide updated daylight results for proposed accommodation within this existing Grade II Listed Building. This revised analysis is based upon the amendments to the proposed scheme.

In the same manner as our original report, the results and analysis are based upon scheme drawings prepared by Shaun Knight Architecture, survey information, photographs and by reference to local planning policy and BRE guidance fully explained in our original report.

Summary

The revised proposal confirms a revised internal layout to the proposed accommodation and improvements would occur when the revised daylight values are compared to our original report.

1.0 Modelling and Analysis

1.1 The model has been updated to include the latest scheme (Appendix 1).

2.0 Daylight Results - Proposed Accommodation

2.1 The revised layout plans for all floors are included within Appendix 2. The following pages show the results of the new residential accommodation. This accommodation would be located within an existing Grade II Listed building, which means the existing fenestration and architectural form is of the foremost importance. Other aspects inevitably demand a degree of compromise, but the revision of the layout has significantly improved the daylight readings when compared to the previous report.

2.2 The results confirm ADF in the majority of locations would remain above BRE's

recommended values. A few exceptions would occur where ADF would fall short of

BRE's recommendations. Two are bedrooms and BRE recognises the daylight to

bedrooms is not as important as other habitable spaces.

2.4 Three living rooms, would have an ADF between 94% and 98% the required value of

1.5% and can be considered equivalent to the BRE's recommended value.

2.5 The only two locations where ADF would then be below BRE's guidelines would be R13

kitchen at 1st floor level, where the existing window and partitions need to be retained

and R7 living room at 2nd floor level where, the proposed figure would be 78% the

recommended value of 1.5%. Were we reporting in the terms of an Environmental

Statement, this would be defined as an effect of minor adverse significance.

2.6 A very good set of results has been achieved when the Grade II Listed Building

constraints are taken into account and the occasional exceptions are not sufficient to

impact upon a planning approval.

3.0 Sunlight Results - Proposed Accommodation

3.1 As stated in our previous report, the layout has been well considered in order to provide

80% of living rooms with sunlight availability. This is in accordance with BRE and London

Plan recommendations.

Yours sincerely

Roberta Mancini MArch

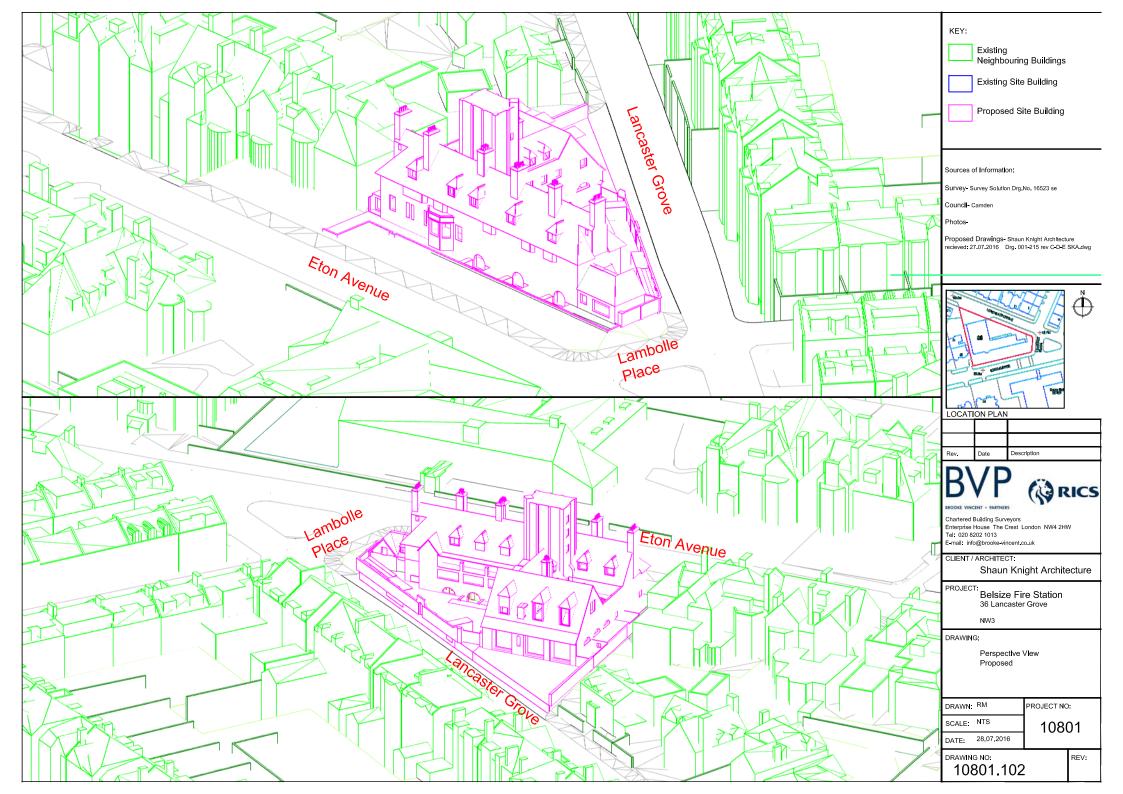
For Brooke Vincent + Partners

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Appendix 1

CAD MODEL images





Appendix 2

Results:

Proposed Accommodation ADF

Project Name: Belsize Fire Station

Project No: 10801

Architect: Shaun Knight Architecture

Iteration Description: ADF Proposed accommodation

Floor Ref.	Room Ref.	Room Attribute	Room Use.	Window Ref.	Glass Transmittance	Glazed Area	Clear Sky Angle Proposed	Room Surface Area	Average Surface Reflectance	Below Working Plane Factor	ADF Proposed	Req'd Value
					Propo	sed						
Lower Ground	R1	Unit 4	Living Room	W8-L	0.68	0.28	61.83	87.53	0.60	0.20	0.04	
				W8-U	0.68	0.40	63.87	87.53	0.60	1.00	0.31	
				W9	0.68	0.87	71.87	87.53	0.60	1.00	0.76	
				W10-L	0.68	0.28	61.29	87.53	0.60	0.20	0.04	
				W10-U	0.68	0.40	62.48	87.53	0.60	1.00	0.30 1.46	1.5
Lower Ground	R2	Unit 3	Living Room	W11-L	0.68	0.28	61.98	89.57	0.60	0.20	0.04	1.5
				W11-U	0.68	0.40	63.70	89.57	0.60	1.00	0.30	
				W12	0.68	0.87	71.41	89.57	0.60	1.00	0.74	
				W13-L	0.68	0.28	61.32	89.57	0.60	0.20	0.04	
				W13-U	0.68	0.40	61.77	89.57	0.60	1.00	0.29	4.5
Lower Ground	R3	Unit 2	Living Room	W14-L	0.68	0.28	61.86	77.02	0.60	0.20	0.05	1.5
Lower Ground	N3	Offic 2	Living Room	W14-L W14-U	0.68	0.28	62.19	77.02	0.60	1.00	0.03	
				W15	0.68	0.40	70.74	77.02	0.60	1.00	0.85	
				W16-L	0.68	0.28	61.60	77.02	0.60	0.15	0.04	
				W16-U	0.68	0.40	62.15	77.02	0.60	1.00	0.34	
											1.62	1.5
Lower Ground	R4	Unit 1	Livingroom	W17	0.68	0.96	71.46	103.34	0.60	1.00	0.71	
				W18	0.68	3.47	73.05	103.34	0.60	1.00	2.61	
	- D.F.	Herit 2	Dadasas	14/40	0.60	4.04		54.02	0.60	1.00	3.31	1.50
Lower Ground	R5	Unit 2	Bedroom	W19	0.68	1.04	55.78	54.02	0.60	1.00	1.14 1.14	1
Lower Ground	R6	Unit 3	Bedroom	W20	0.68	1.32	11.69	52.92	0.60	1.00	0.31	
											0.31	1
Lower Ground	R7	Unit 4	Bedroom	W21	0.68	1.00	16.15	46.43	0.60	1.00	0.37	
			D. J	1444	2.22	4.44	74.07	04.00	0.60	1.00	0.37	1
Ground	R1	Unit 5	Bedroom	W1 W33	0.80 0.80	1.44 0.58	74.97 49.66	81.00 81.00	0.60 0.60	1.00 1.00	1.67	
				VV 33	0.80	0.56	49.00	81.00	0.60	1.00	0.44 2.11	1
Ground	R2	Unit 5	Bedroom	W2	0.80	0.61	66.48	65.43	0.60	1.00	0.77	
				W2	0.80	0.76	69.43	65.43	0.60	1.00	1.01	
											1.78	1
Ground	R3	Unit 5	Livingroom	W3	0.80	0.68	67.14	188.90	0.60	1.00	0.30	
				W4	0.80	1.45	68.77	188.90	0.60	1.00	0.66	
				W5	0.80	2.21	76.30	188.90	0.60	1.00	1.11	
				W6 W7	0.80 0.80	1.52 1.55	68.39 72.11	188.90 188.90	0.60 0.60	1.00 1.00	0.69 0.74	
				VV /	0.80	1.55	/2.11	100.90	0.00	1.00	3.50	1.50
Ground	R4	Unit 1	Bedroom	W19-L	0.68	0.53	70.17	70.06	0.60	0.20	0.11	1.50
				W19-U	0.68	0.29	59.66	70.06	0.60	1.00	0.26	
				W20	0.68	0.79	59.69	70.06	0.60	1.00	0.72	
											1.09	1
First	R9	Unit 7	Living Room	W21	0.80	0.81	68.28	158.56	0.60	1.00	0.43	
				W22	0.80	0.81	71.07	158.56	0.60	1.00	0.45	
				W23	0.80	0.81	72.74	158.56	0.60	1.00	0.46	
				W41	0.80	0.62	23.15	158.56	0.60	1.00	0.11 1.46	1.5
First	R10	Unit 8	Bedroom	W24	0.68	0.86	74.12	83.20	0.60	1.00	0.81	1.5
		Sint 0	200100111	W25	0.80	0.86	74.12	83.20	0.60	1.00	0.96	
							- -		-			1.00

Project Name: Belsize Fire Station

Project No: 10801

Architect: Shaun Knight Architecture

Iteration Description: ADF Proposed accommodation

Date of Analysis: 27/07/2016 00:00:00

Floor Ref.	Room Ref.	Room Attribute	Room Use.	Window Ref.	Glass Transmittance	Glazed Area	Clear Sky Angle Proposed	Room Surface Area	Average Surface Reflectance	Below Working Plane Factor	ADF Proposed	Req'd Value
First	R11	Unit 8	LKD	W26	0.80	2.36	74.65	297.50	0.60	1.00	0.74	
				W27	0.80	2.36	79.30	297.50	0.60	1.00	0.78	
				W28	0.80	1.92	80.42	297.50	0.60	1.00	0.65	
				W29	0.80	2.42	59.42	297.50	0.60	1.00	0.60	
				W30	0.80	0.13	35.06	297.50	0.60	1.00	0.02	
				W31	0.80	0.71	45.41	297.50	0.60	1.00	0.14	
				W32	0.80	0.13	32.47	297.50	0.60	1.00	0.02	
				W33	0.80	1.55	46.20	297.50	0.60	1.00	0.30	
											3.25	2.00
First	R12	Unit 8	Bedroom	W26-L	0.80	1.34	78.44	101.78	0.60	0.20	0.26	
				W26-U	0.80	1.01	74.65	101.78	0.60	1.00	0.93	
				W33-L	0.80	0.61	49.66	101.78	0.60	0.20	0.07	
				W33-U	0.80	0.93	46.20	101.78	0.60	1.00	0.53	
											1.79	1.00
First	R13	Unit 7	Kitchen	W35	0.80	0.78	37.96	43.23	0.60	1.00	0.86	
											0.86	2.00
Second	R1	Unit 10	Livingroom	W1	0.68	0.34	85.60	131.41	0.60	1.00	0.23	
				W2	0.68	1.48	73.83	131.41	0.60	1.00	0.88	
				W13	0.68	1.48	78.18	131.41	0.60	1.00	0.94	
											2.05	1.5
Second	R3	Unit 10	Bedroom	W3	0.68	0.99	78.93	74.24	0.60	1.00	1.12	
											1.12	1
Second	R4	Unit 9	Bedroom	W4	0.68	0.99	72.99	66.51	0.60	1.00	1.15	
											1.15	1
Second	R5	Unit 9	Bedroom	W5	0.68	0.99	72.87	69.94	0.60	1.00	1.10	
											1.10	1
Second	R6	Unit 9	Livingroom	W6	0.68	1.48	73.68	173.14	0.60	1.00	0.67	
				W7	0.68	0.33	85.95	173.14	0.60	1.00	0.17	
				W8	0.68	0.33	86.88	173.14	0.60	1.00	0.17	
				W40	0.68	1.48	72.95	173.14	0.60	1.00	0.66	
											1.68	1.5
Second	R7	Unit 11	Livingroom	W9	0.68	0.77	70.52	97.66	0.60	1.00	0.59	
				W10	0.68	0.77	70.80	97.66	0.60	1.00	0.59	
											1.18	1.5
Second	R8	Unit 11	Bedroom	W11	0.68	0.77	74.10	53.05	0.60	1.00	1.14	
											1.14	1
Second	R9	Unit 10	Bedroom	W12	0.68	1.48	56.19	64.16	0.60	1.00	1.38	

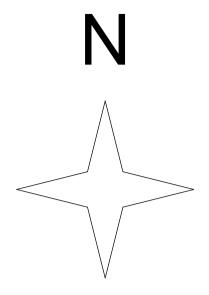


PROPOSED BASEMENT PLAN

<u>KEY</u>

EXISTING RETAINED WALLS
PROPOSED WALLS

0 3 6 9 12 15M 1:100 The copyright of this drawing is the property of SHAUN KNIGHT ARCHITECTURE LIMITED and may not be reproduced in any form without prior written consent.



REV A 15/06/2016
- WC WIDTH AMENDED IN UNIT 1.
REV B 24/06/2016
- LIGHTWELLS AMENDED
- LAYOUTS AMENDED
REV C30/06/2016
- UNIT LAYOUTS AMENDED
REV D27/07/2016
- LIGHTWELLS AMENDED

PLANNING



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PROJECT: 36 LANCASTER GROVE

TITLE : PROPOSED

BASEMENT PLAN

Date: DECEMBER 2015

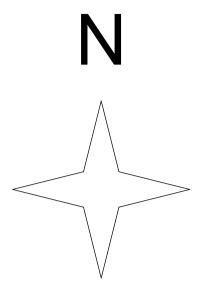
Scale: 1:100 AT A1 Drawn: SDK

DRAWING NUMBER: 003D



PROPOSED GROUND FLOOR PLAN

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REV A 31/03/2016
- PODS REMOVED FROM UNIT 6
- LIFT AMENDED
REV B 18/04/2016
- UNIT 6 OMITTED FROM APPLICATION
REV C 10/05/2016
- UNIT 5 AMENDED TO PROVIDE COMMUNAL PLANT ROOM
REV D 15/06/2016
- LIFT AMENDED TO COMPLY WITH M4(1)
REV E 24/06/2016
- DORMER TO UNIT 1 ENLARGED

PLANNING



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PROJECT: 36 LANCASTER GROVE

TITLE : PROPOSED GROUND FLOOR PLAN

Date: DECEMBER 2015

Scale: 1:100 AT A1 Drawn: SDK

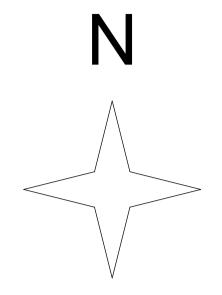
DRAWING NUMBER: 004E



PROPOSED FIRST FLOOR PLAN

EXISTING RETAINED WALLS
PROPOSED WALLS

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REV A 31/03/2016
- LIFT AMENDED
REV B 18/04/2016
- UNIT 6 OMITTED FROM APPLICATION
REV C 15/06/2016
- LIFT AMENDED TO COMPLY WITH M4(1).
REV D 24/06/2016
- UNIT 7 LAYOUT AMENDED
REV E 30/06/2016
- LAYOUT AMENDED

PLANNING



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PROJECT: 36 LANCASTER GROVE

TITLE : PROPOSED FIRST FLOOR PLAN

Date: DECEMBER 2015

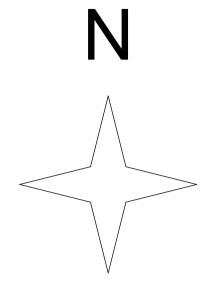
Scale: 1:100 AT A1 Drawn: SDK

DRAWING NUMBER: 005E



PROPOSED SECOND FLOOR PLAN

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REV A 31/03/2016
- PREVIOUS UNIT 12 NOW OMITTED FROM APPLICATION
- 1 DORMER OMITTED FROM EACH OF
UNITS 9 AND 10
- LIFT AMENDED
REV B 15/06/2016
- LIFT AMENDED TO COMPLY WITH M4(1).
- DORMERS AMENDED
REV C 24/06/2016
- LAYOUTS OF UNITS 9, 10 AND 11 AMENDED.

PLANNING



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PROJECT: 36 LANCASTER GROVE

TITLE : PROPOSED SECOND FLOOR PLAN

Date: DECEMBER 2015

Scale: 1:100 AT A1 Drawn: SDK

DRAWING NUMBER: 006C