

Figure 2.0 LB of Camden SFRA Flooded Roads 1975 and 2002.

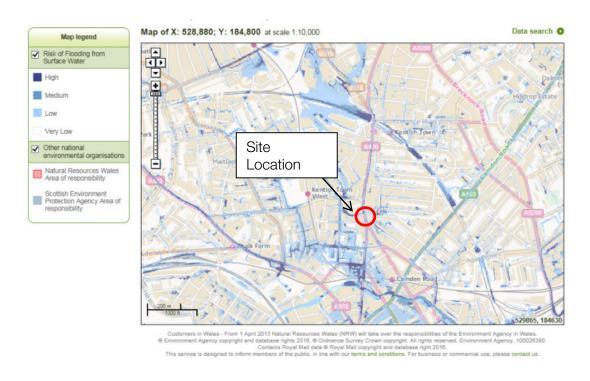


Figure 3.0 EA Surface Water Flood Risk Zone Map

17.5 Mitigation Measures

As the site is shown to be at low risk of flooding due to surface water sources, and does not increase the flood risk elsewhere. However, mitigation measures have been put in place through the use of a sedum green roof which will reducing the peak flows from site and provide a level of surface water attenuation. Allowable discharge rates to the public sewer will be confirmed with Thames Water.

17.6 Ground Water Flooding

Figure 4, shown below which has been taken from the SFRA indicates that the site is not located within an area that is at risk from ground water flooding. However, the Pre-planning Site Investigation and Baseline Impact Assessment Report (Ref No. J15359A) does suggest that;

"The investigation has indicated that the basement may extend below the water table within the upper weathered horizon of the London Clay, however this should be confirmed by purging the standpipes and carrying out further monitoring. Consequently there is potential for groundwater flow beneath the site. However, the gravelly clay stratum extends around the basement excavation such that groundwater should be able to flow around the outside of the excavation and should therefore not impact upon groundwater sensitive features."

In this regards, the flood risk from groundwater is deemed low.

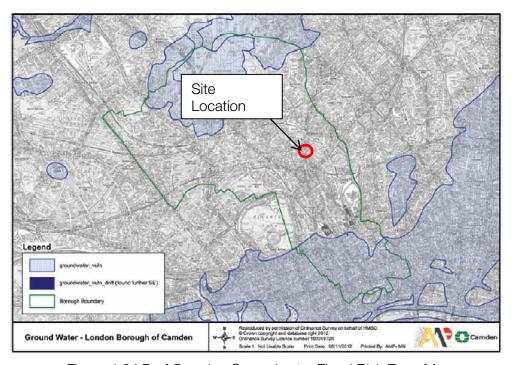


Figure 4.0 LD of Camden Groundwater Flood Risk Zone Map


17.7 Mitigation Measures

Ground water flows should easily flow around the basement and hence the proposal should not affect have a significant effect on groundwater flow paths. As the basement is likely to extend below the water table the proposal will incorporate a cavity drainage system as a form of mitigation.

17.8 Summary

- There is low risk of flooding from Fluvial / Tidal sources and hence no mitigation measure will be required.
- There is low risk of flooding from surface water, any surface water flooding which may occur along Kentish Town Road in close proximity to the site is likely to be contained within kerb upstands of the highways and should not have an adverse effect on the proposed site. The use of a sedum green roof has been incorporated within the proposal as a form of mitigation and will aid in reducing peak flows from site and provide a level of attenuation.
- There is no significant risk of flooding from groundwater. Groundwater flows present at basement level will flow around the basement due the presence of the gravelly clay stratum. The use of a cavity drainage system within the basement has been incorporated as a form of mitigation.

18 App	endix A –	Proposed	Structural	Drawings
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GENERAL NOTES:
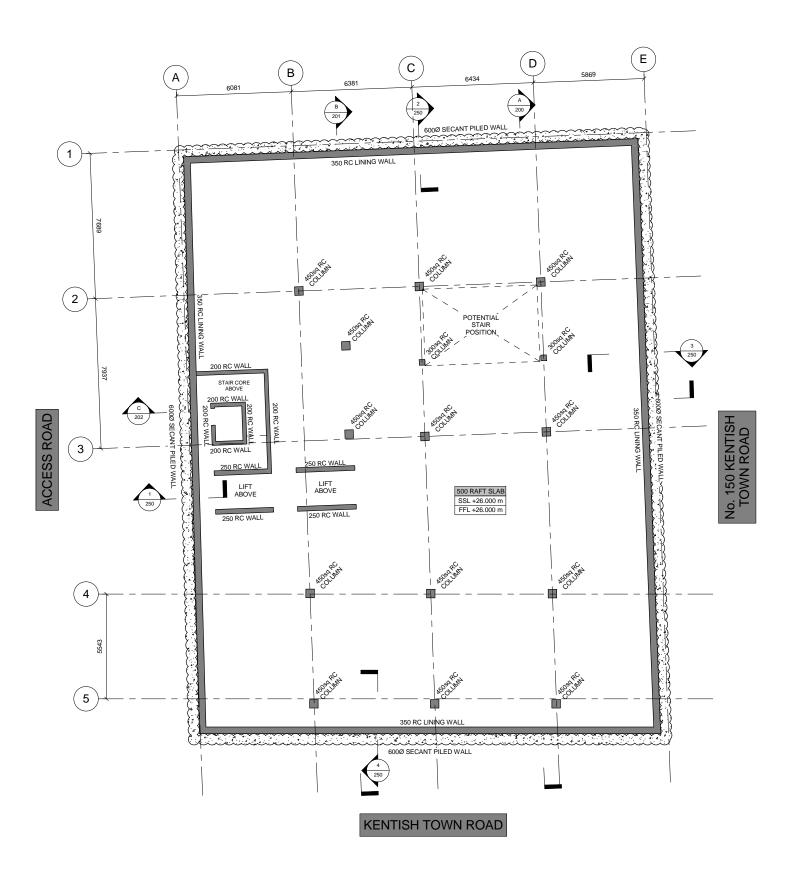
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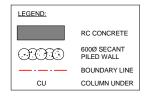
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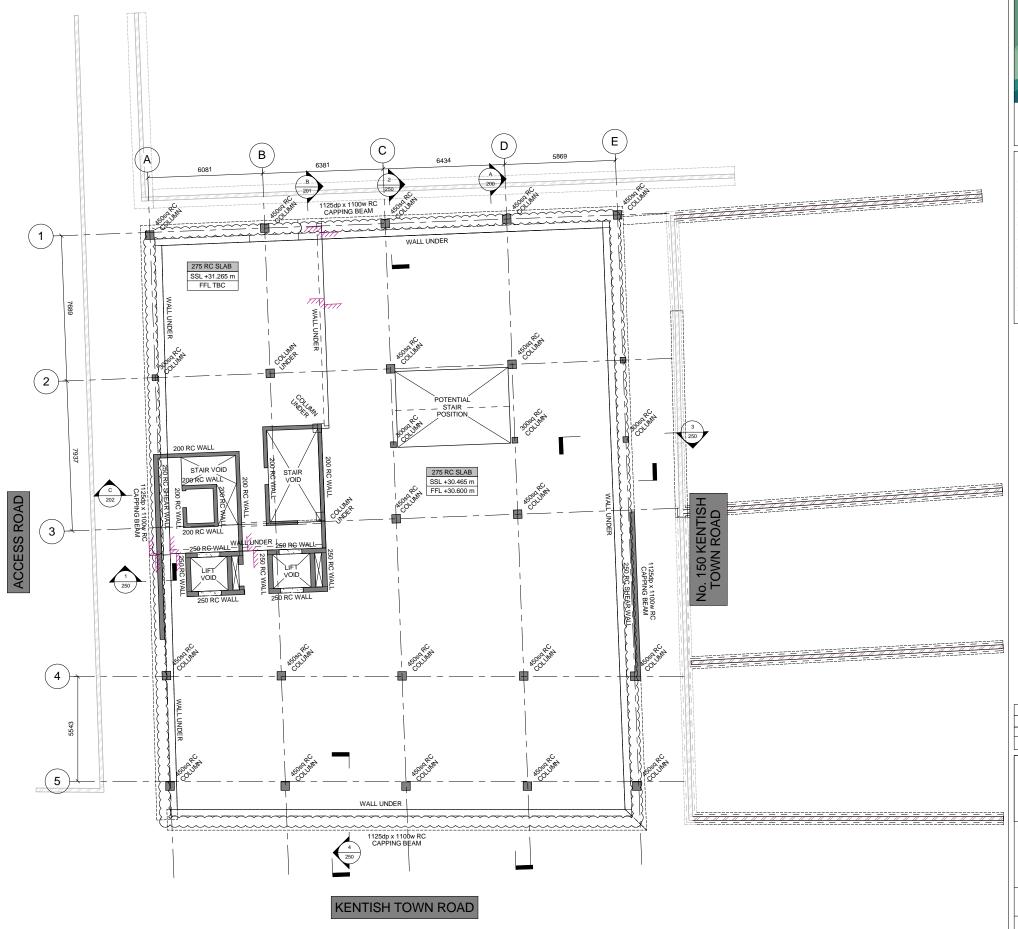
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A01	03.03.16	ISSUED FOR PLANNING	SJE
A02	01.06.16	ISSUED FOR PLANNING	AJE


152-156 KENTISH **TOWN ROAD**

GENERAL ARRANGEMENT LOWER GROUND FLOOR

Client:	AHIG	LTD	
Architect:	MV	VA	
	PLAN	INING	}
Designed:	RSC	Drawn:	SE
Checked:	GR	Date:	MAR '16
Project No:	1599	Scale @ A1:	1:100
Drawing No:	090	Revision:	A02





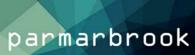

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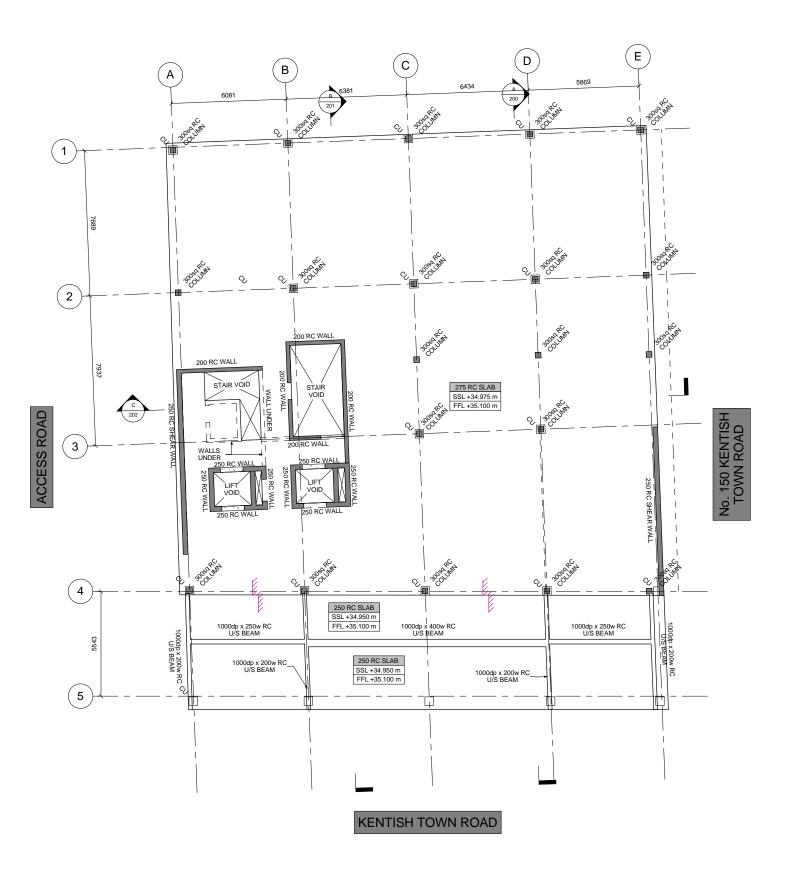
REV	03.03.16 DATE	DESCRIPTION	SJE
A02 A01		ISSUED FOR PLANNING ISSUED FOR PLANNING	AJE SJF

152-156 KENTISH **TOWN ROAD**

GENERAL ARRANGEMENT **GROUND FLOOR**

Client:	AHIG	LTD			
Architect:	Architect: MWA				
	PLAN	INING	è		
Designed:	RSC	Drawn:	SE		
Checked:	GR	Date:	MAR '16		
Project No:	1599	Scale @ A1:	1:100		
Drawing No:	100	Revision:	A02		







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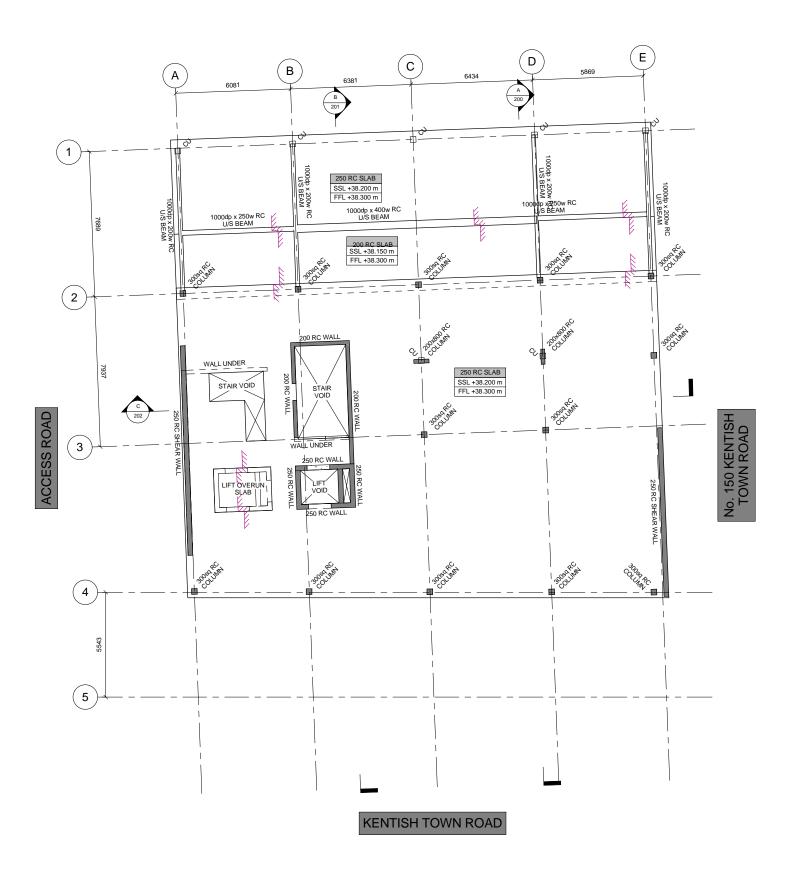
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152-156 KENTISH **TOWN ROAD**

GENERAL ARRANGEMENT FIRST FLOOR

Client:	AHIG	E LTD	
Architect:	M\	ΝA	
	PLAN	INING	;
Designed:	RSC	Drawn:	SE
Checked:	GR	Date:	MAR '16
Project No:	1599	Scale @ A1:	1:100
Drawing No:	110	Revision:	A01







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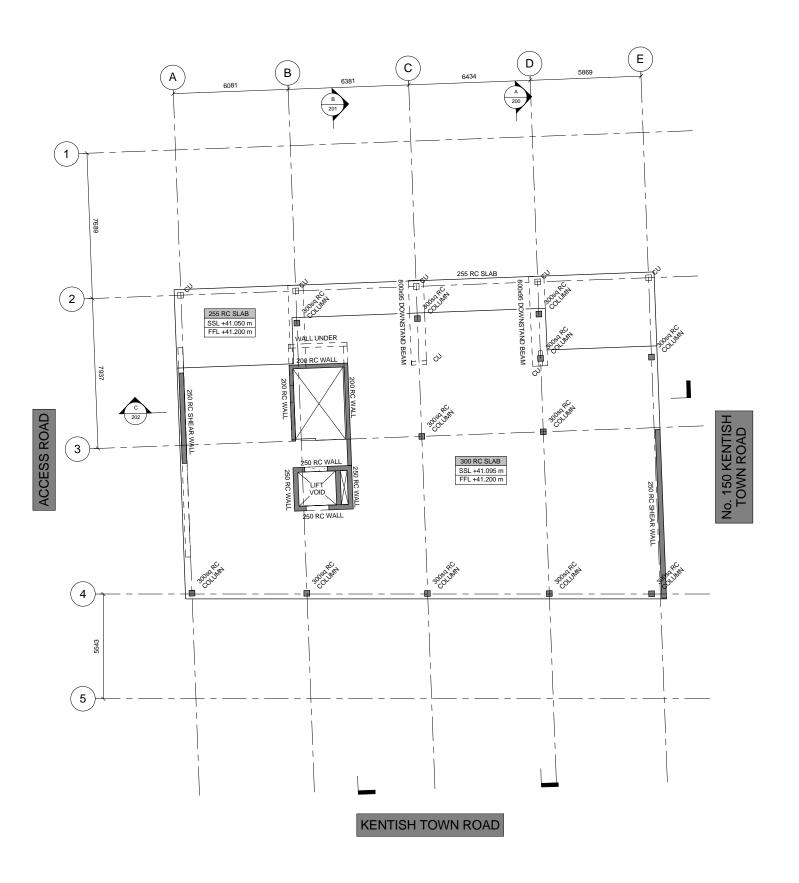
A01 03.03.16 ISSUED FOR PLANNING REV DATE DESCRIPTION	SJE BY
A01 03.03.16 ISSUED FOR PLANNING	SJE
A02 01.06.16 ISSUED FOR PLANNING	AJE

152-156 KENTISH **TOWN ROAD**

GENERAL ARRANGEMENT SECOND FLOOR

Client:	AHIG	LTD	
Architect:	M\	ΝA	
	PLAN	INING	}
Designed:	RSC	Drawn:	SE
Checked:	GR	Date:	MAR '16
Project No:	1599	Scale @ A1:	1:100
Drawing No:	120	Revision:	A02







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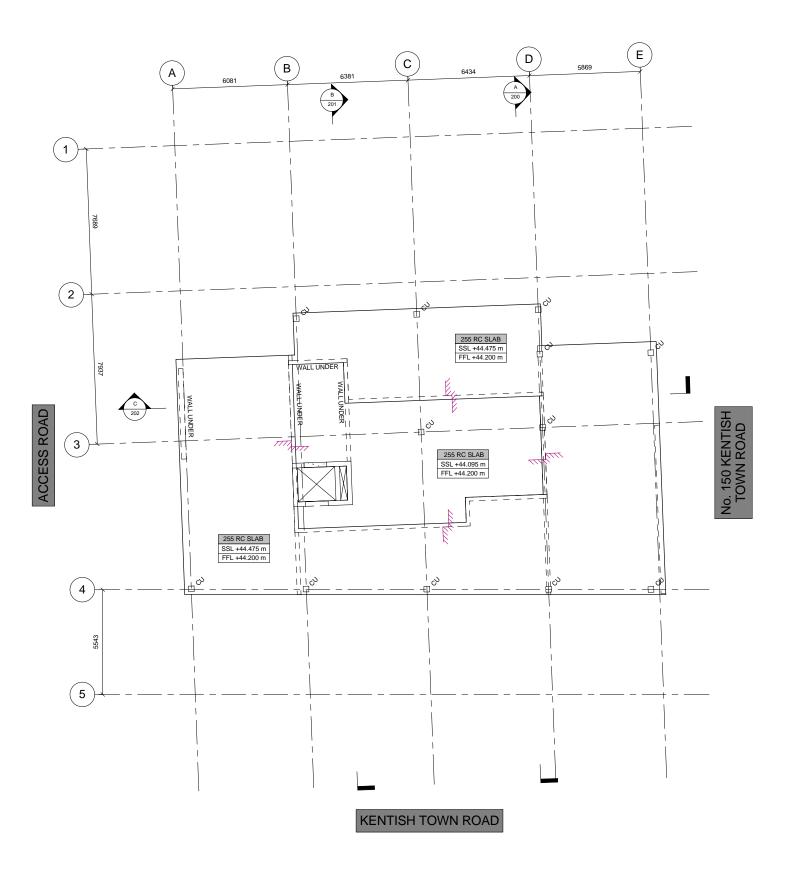
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A01		ISSUED FOR PLANNING	SJE
A02	01.06.16	ISSUED FOR PLANNING	AJE

152-156 KENTISH **TOWN ROAD**

GENERAL ARRANGEMENT THIRD FLOOR

Client:	AHIG	LTD			
Architect:	Architect: MWA				
	PLAN	NING	}		
Designed:	RSC	Drawn:	SE		
Checked:	GR	Date:	MAR '16		
Project No:	1599	Scale @ A1:	1:100		
Drawing No:	130	Revision:	A02		







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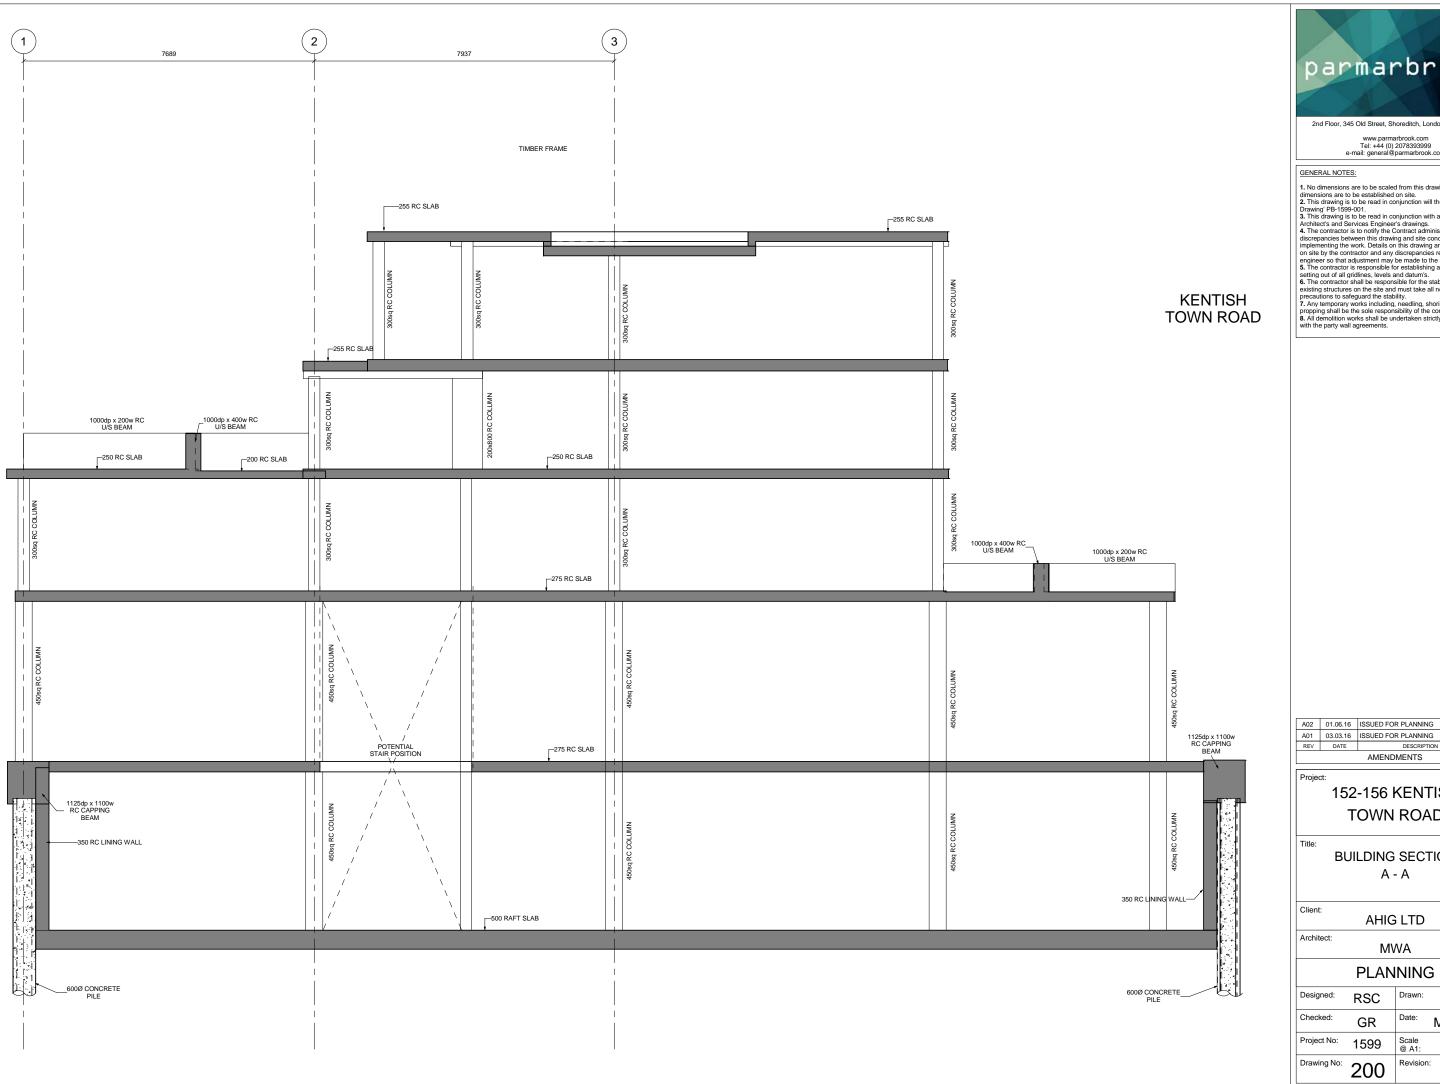
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	A02	01.06.16	ISSUED FOR PLANNING	AJE

152-156 KENTISH **TOWN ROAD**

GENERAL ARRANGEMENT **ROOF PLAN**

AHIG LTD				
Architect:	M\	ΝA		
	PLAN	INING	}	
Designed:	RSC	Drawn:	SE	
Checked:	GR	Date:	MAR '16	
Project No:	1599	Scale @ A1:	1:100	
Drawing No:	140	Revision:	A02	







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	152-156 KENTISH					
	TOWN	ROA	VD			
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ient:	AHIG	LTD				
chitect		VΑ				
	PLANNING					
esigne	d: RSC	Drawn:	SE			
necked	: GR	Date:	MAR '16			

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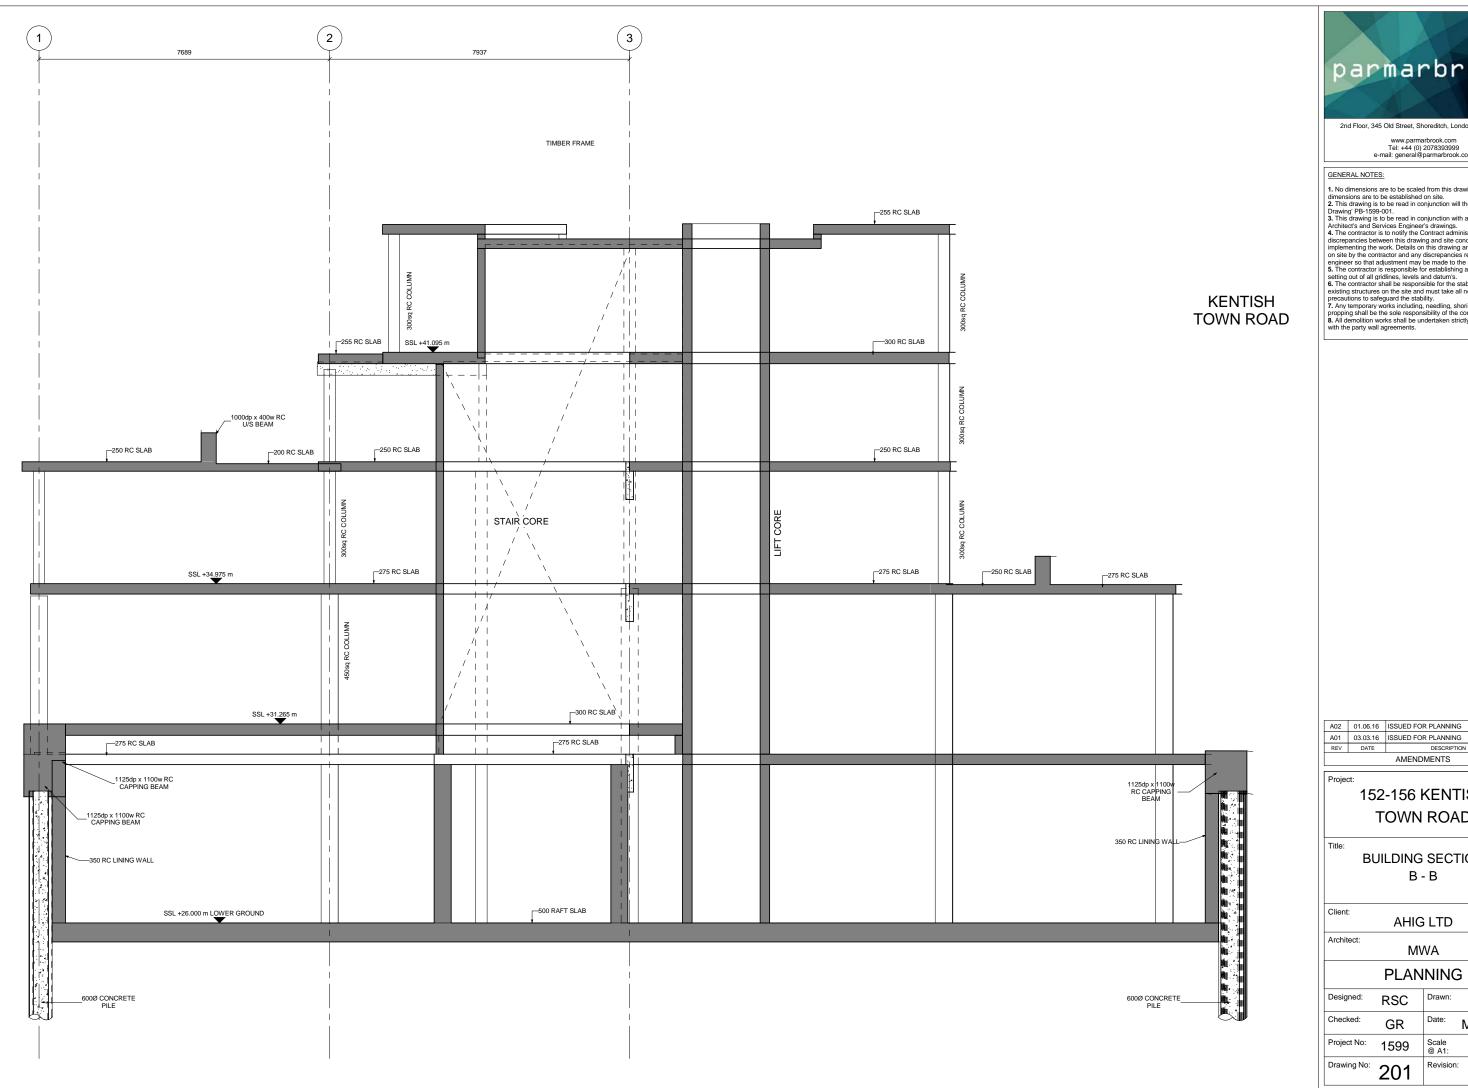
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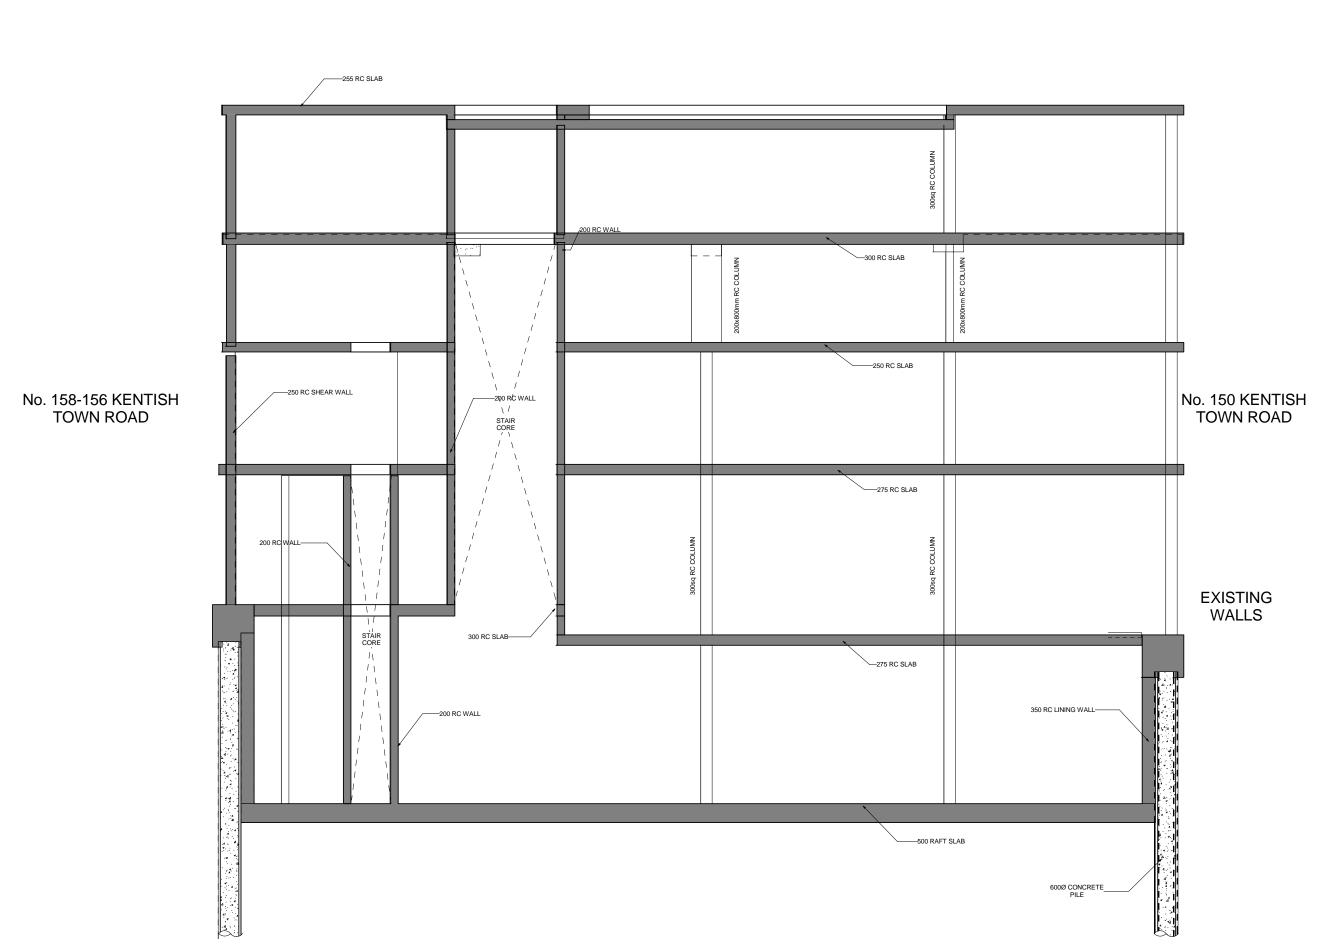
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152-156 KENTISH TOWN ROAD					
BUILDING SECTION B - B					
Client:	AHIG	LTD			
Architect:	M\	ΝA			
	PLAN	INING	3		
Designed:	RSC	Drawn:	SE		
Checked:	GR	Date:	MAR '16		
Project No:	1599	Scale @ A1:	1:50		
Drawing No: 201 Revision: A02					

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-	AMENDMENTS						
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	A02	01.06.16	ISSUED FOR PLANNING	AJE			

152-156 KENTISH **TOWN ROAD**

BUILDING SECTION

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AHIG LTD


Architect: MWA

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RSC SE Checked: MAR '16 Project No: 1599 1:50


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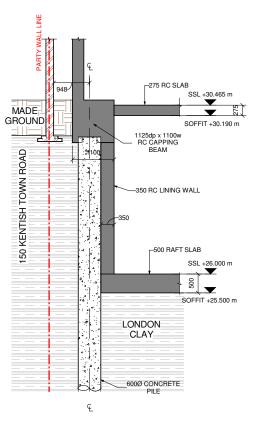
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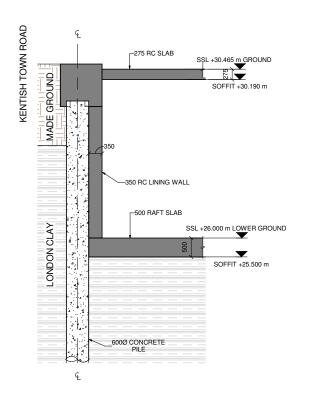


SECTION 1 - 1

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SECTION 4 - 4

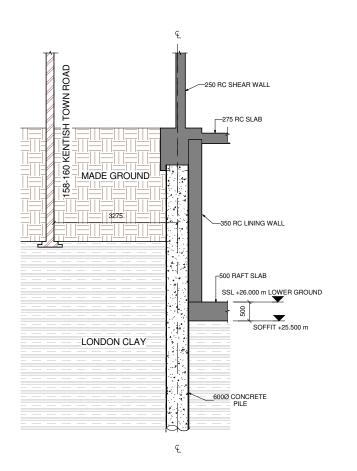Scale: 1:50

SECTION 2 - 2 SECTION 3 - 3 Scale: 1:50 Scale: 1:50
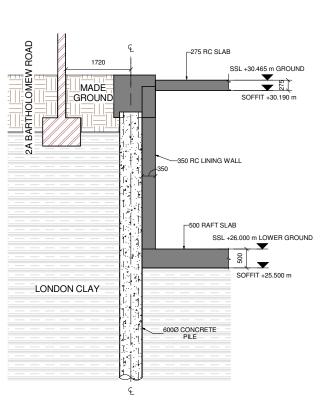
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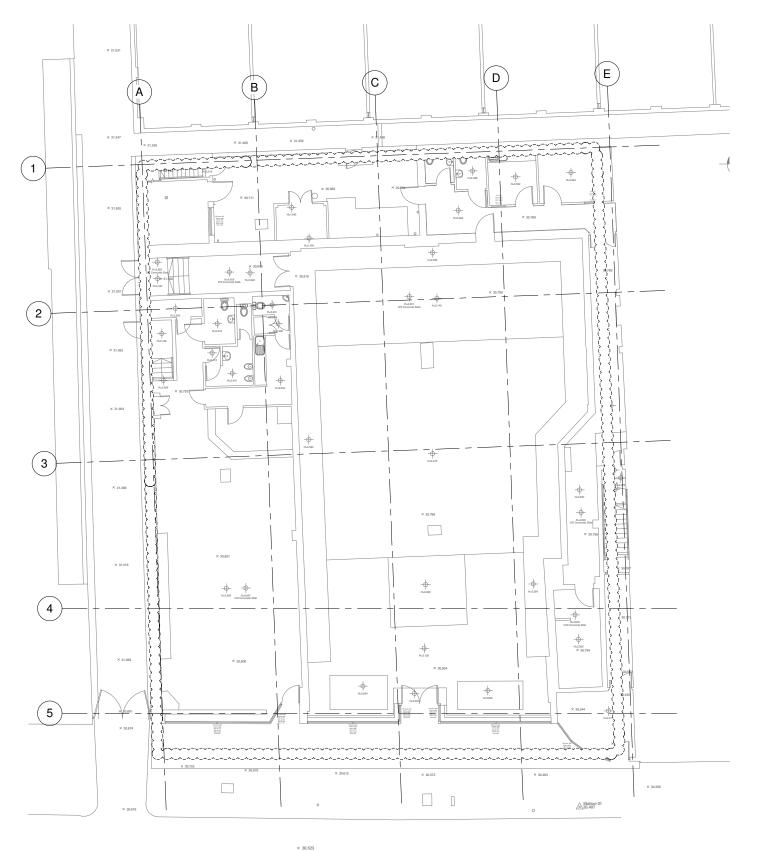
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	REV	DATE	DESCRIPTION	BY		
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152-156 KENTISH **TOWN ROAD**

SECTIONS & DETAILS SHEET 1

Client:	AHIC	LTD	
Architect:	M	ΝA	
	PLAN	INING	à
Designed:	RSC	Drawn:	SE
Checked:	GR	Date:	MAR '16
Project No:	1599	Scale @ A1:	1 : 50
Drawing No:	250	Revision:	A01



PB-1599-GF-GA--- PILES

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ı	REV	DATE	DESCRIPTION	BY		
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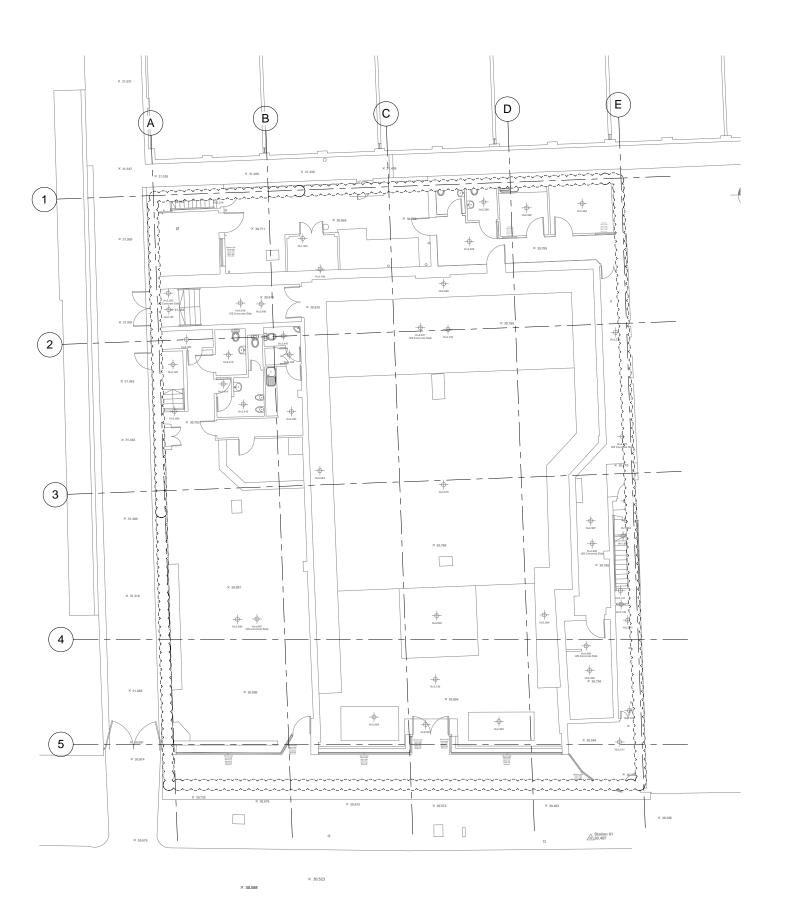
Project

152-156 KENTISH TOWN ROAD

Title

EXISTING STRUCTURES AND PILE LOCATIONS GROUND LEVEL PLAN

Client: AHIG LTD				
Architect:	MV	VA		
	PLAN	NING	ત્રે	
Designed:	RSC	Drawn:	SE	
Checked:	GR	Date:	MAR '16	
Project No:	1599	Scale @ A1:	1:100	
Drawing No:	500	Revision	A01	





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152-156 KENTISH TOWN ROAD


Title

EXISTING STRUCTURES AND PILE LOCATIONS GROUND LEVEL PLAN

0002 ==					
Client: AHIG LTD					
Architect:	itect: MWA				
PLANNING					
Designed:	RSC	Drawn:	SE		
Checked:	GR	Date:	MAR '16		
Project No:	1599	Scale @ A1:	1:100		

A02

Drawing No: 500

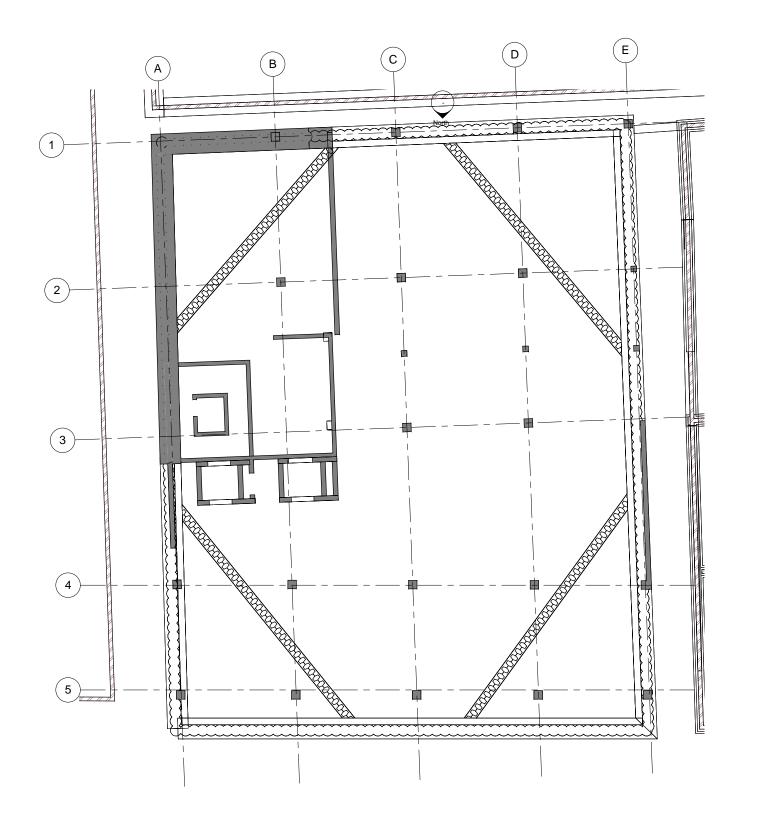



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A01	03.03.16	ISSUED FOR PLANNING	SJE			
A02	01.06.16	ISSUED FOR PLANNING	AJE			

152-156 KENTISH **TOWN ROAD**

PROPOSED TEMPORARY WORKS GROUND FLOOR PLAN

Client:	AHIG	LTD	
Architect:	M\	ΝA	
	PLAN	INING	}
Designed:	RSC	Drawn:	SE
Checked:	GR	Date:	MAR '16
Project No:	1599	Scale @ A1:	1:100
Drawing No:	501	Revision	A02

A02

19 Appendix B – Thames Water Asset Search

Asset Location Search



Mr Richard Colley Parmarbrook Third Floor 345 Old Street LONDON EC1V 9LL

Search address supplied 152 - 156

Kentish Town Rd

London NW1 9QB

Your reference N/A

Our reference ALS/ALS Standard/2016_3240057

Search date 29 January 2016

You are now able to order your Asset Location Search requests online by visiting www.thameswater-propertysearches.co.uk



Asset Location Search



Search address supplied: 152 - 156, Kentish Town Rd, London, NW1 9QB

Dear Sir / Madam

An Asset Location Search is recommended when undertaking a site development. It is essential to obtain information on the size and location of clean water and sewerage assets to safeguard against expensive damage and allow cost-effective service design.

The following records were searched in compiling this report: - the map of public sewers & the map of waterworks. Thames Water Utilities Ltd (TWUL) holds all of these.

This searchprovides maps showing the position, size of Thames Water assets close to the proposed development and also manhole cover and invert levels, where available.

Please note that none of the charges made for this report relate to the provision of Ordnance Survey mapping information. The replies contained in this letter are given following inspection of the public service records available to this company. No responsibility can be accepted for any error or omission in the replies.

You should be aware that the information contained on these plans is current only on the day that the plans are issued. The plans should only be used for the duration of the work that is being carried out at the present time. Under no circumstances should this data be copied or transmitted to parties other than those for whom the current work is being carried out.

Thames Water do update these service plans on a regular basis and failure to observe the above conditions could lead to damage arising to new or diverted services at a later date.

Contact Us

If you have any further queries regarding this enquiry please feel free to contact a member of the team on 0845 070 9148, or use the address below:

Thames Water Utilities Ltd Property Searches PO Box 3189 Slough SL1 4WW

Email: searches@thameswater.co.uk

Web: www.thameswater-propertysearches.co.uk

Asset Location Search



Waste Water Services

Please provide a copy extract from the public sewer map.

Enclosed is a map showing the approximate lines of our sewers. Our plans do not show sewer connections from individual properties or any sewers not owned by Thames Water unless specifically annotated otherwise. Records such as "private" pipework are in some cases available from the Building Control Department of the relevant Local Authority.

Where the Local Authority does not hold such plans it might be advisable to consult the property deeds for the site or contact neighbouring landowners.

This report relates only to sewerage apparatus of Thames Water Utilities Ltd, it does not disclose details of cables and or communications equipment that may be running through or around such apparatus.

The sewer level information contained in this response represents all of the level data available in our existing records. Should you require any further Information, please refer to the relevant section within the 'Further Contacts' page found later in this document.

For your guidance:

- The Company is not generally responsible for rivers, watercourses, ponds, culverts
 or highway drains. If any of these are shown on the copy extract they are shown for
 information only.
- Any private sewers or lateral drains which are indicated on the extract of the public sewer map as being subject to an agreement under Section 104 of the Water Industry Act 1991 are not an 'as constructed' record. It is recommended these details be checked with the developer.

Clean Water Services

Please provide a copy extract from the public water main map.

Enclosed is a map showing the approximate positions of our water mains and associated apparatus. Please note that records are not kept of the positions of individual domestic supplies.

For your information, there will be a pressure of at least 10m head at the outside stop valve. If you would like to know the static pressure, please contact our Customer Centre on 0800 316 9800. The Customer Centre can also arrange for a full flow and

Asset Location Search



pressure test to be carried out for a fee.

For your guidance:

- Assets other than vested water mains may be shown on the plan, for information only.
- If an extract of the public water main record is enclosed, this will show known public
 water mains in the vicinity of the property. It should be possible to estimate the
 likely length and route of any private water supply pipe connecting the property to
 the public water network.

Payment for this Search

Thank you for your payment covering the cost of this enquiry. We have enclosed a VAT Receipt for your records.

Asset Location Search



Further contacts:

Waste Water queries

Should you require verification of the invert levels of public sewers, by site measurement, you will need to approach the relevant Thames Water Area Network Office for permission to lift the appropriate covers. This permission will usually involve you completing a TWOSA form. For further information please contact our Customer Centre on Tel: 0845 920 0800. Alternatively, a survey can be arranged, for a fee, through our Customer Centre on the above number.

If you have any questions regarding sewer connections, budget estimates, diversions, building over issues or any other questions regarding operational issues please direct them to our service desk. Which can be contacted by writing to:

Developer Services (Waste Water) Thames Water Clearwater Court Vastern Road Reading RG1 8DB

Tel: 0845 850 2777

Email: developer.services@thameswater.co.uk


Clean Water queries

Should you require any advice concerning clean water operational issues or clean water connections, please contact:

Developer Services (Clean Water) Thames Water Clearwater Court Vastern Road Reading RG1 8DB

Tel: 0845 850 2777

Email: developer.services@thameswater.co.uk

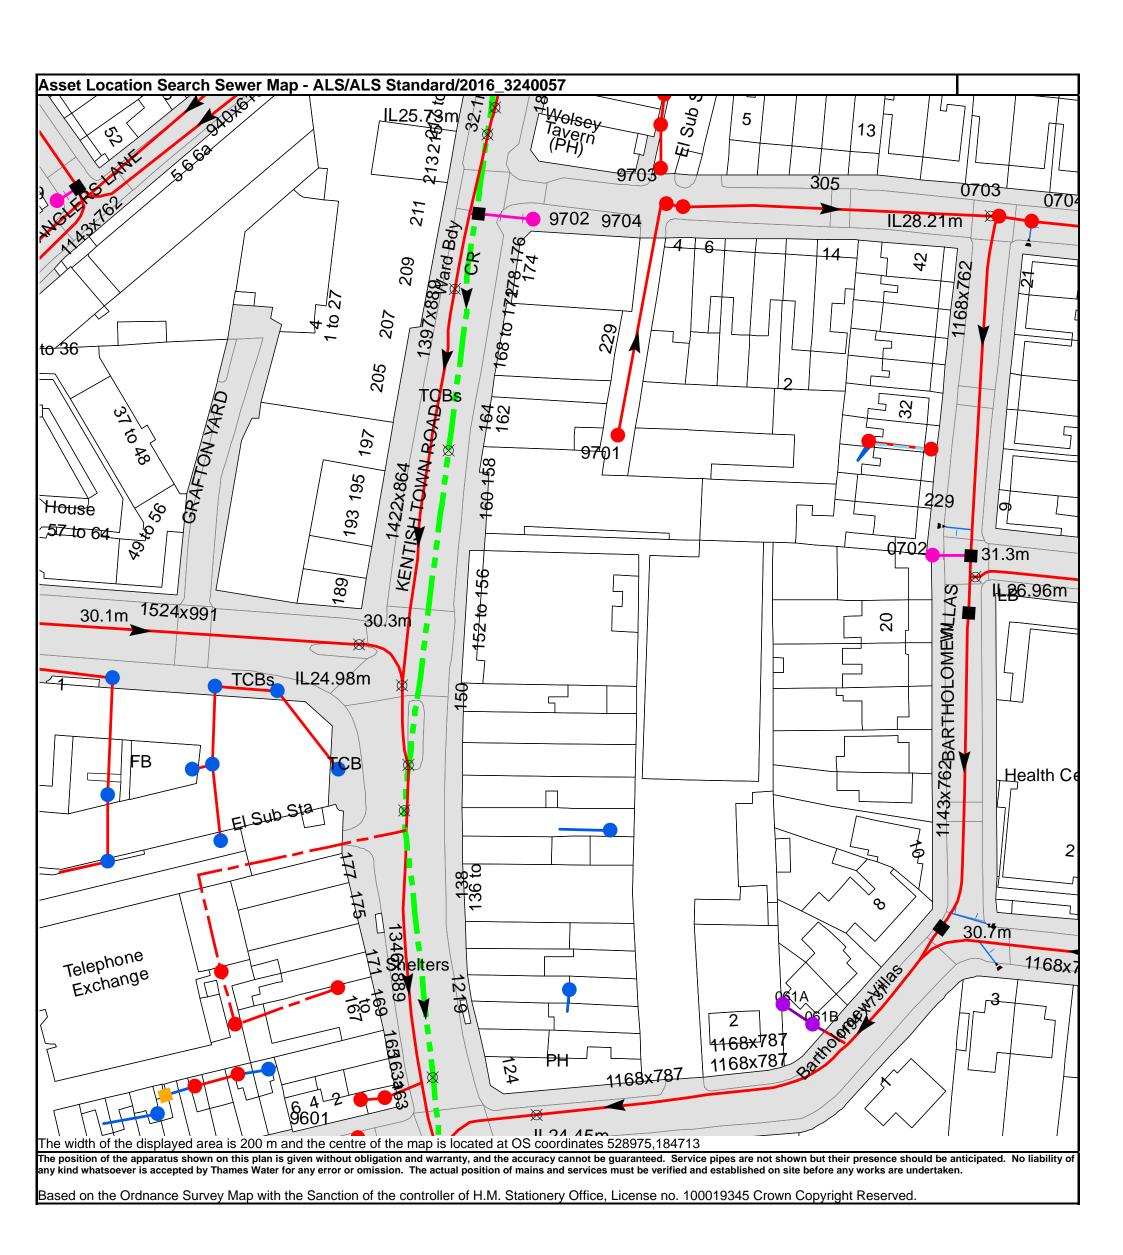


<u>Thames Water Utilities Ltd</u>, Property Searches, PO Box 3189, Slough SL1 4W, DX 151280 Slough 13 T 0845 070 9148 E searches@thameswater.co.uk I www.thameswater-propertysearches.co.uk

Manhole Reference	Manhole Cover Level	Manhole Invert Level
86DA	n/a	n/a
96EE	n/a	n/a
86DB	n/a	n/a
96EJ	n/a	n/a
96EI	n/a	n/a
96EG	n/a	n/a
87CI	n/a	n/a
8709	n/a	n/a
96BF	n/a	n/a
96BI	n/a	n/a
96EH	n/a	n/a
96DJ	n/a	n/a
96EF	n/a	n/a
96AG	n/a	n/a
9702	n/a	n/a
96CC	n/a	n/a
96CJ	n/a	n/a
9701	n/a	n/a
97BG	n/a	n/a
98BJ	n/a	n/a
9703	n/a	n/a
9704	32.05	29.4
061A	n/a	n/a
061B	n/a	n/a
07BH	n/a	n/a
07BI	n/a	n/a
0702	n/a	n/a
0703	n/a	n/a
0704	32.05	27.92
86AG	n/a	n/a
96BG	n/a	n/a
9602	n/a	n/a
9603	n/a	n/a
96AF	n/a	n/a

The position of the apparatus shown on this plan is given without obligation and warranty, and the accuracy cannot be guaranteed. Service pipes are not shown but their presence should be anticipated. No liability of any kind whatsoever is accepted by Thames Water for any error or omission. The actual position of mains and services must be verified and established on site before any works are undertaken.



Public Sewer Types (Operated & Maintained by Thames Water)

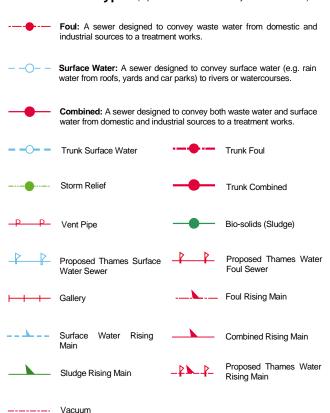

Sewer Fittings

A feature in a sewer that does not affect the flow in the pipe. Example: a vent is a fitting as the function of a vent is to release excess gas.



Fitting

Meter

Meter

✓ Vent Column

Operational Controls

A feature in a sewer that changes or diverts the flow in the sewer. Example: A hydrobrake limits the flow passing downstream.



Weir

End Items

End symbols appear at the start or end of a sewer pipe. Examples: an Undefined End at the start of a sewer indicates that Thames Water has no knowledge of the position of the sewer upstream of that symbol, Outfall on a surface water sewer indicates that the pipe discharges into a stream or river.



Other Symbols

Symbols used on maps which do not fall under other general categories

▲ / ▲ Public/Private Pumping Station
 ★ Change of characteristic indicator (C.O.C.I.)
 ☑ Invert Level

< Summit

Areas


Lines denoting areas of underground surveys, etc.



Tunnel

Conduit Bridge


Other Sewer Types (Not Operated or Maintained by Thames Water)

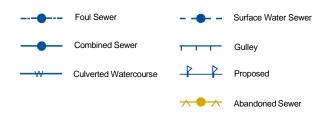

Notes:

- 1) All levels associated with the plans are to Ordnance Datum Newlyn.
- 2) All measurements on the plans are metric.
- Arrows (on gravity fed sewers) or flecks (on rising mains) indicate direction of flow.
- 4) Most private pipes are not shown on our plans, as in the past, this information has not been recorded.
- 5) 'na' or '0' on a manhole level indicates that data is unavailable.

6) The text appearing alongside a sewer line indicates the internal diameter of the pipe in milimetres. Text next to a manhole indicates the manhole reference number and should not be taken as a measurement. If you are unsure about any text or symbology present on the plan, please contact a member of Property Insight on 0845 070 9148.

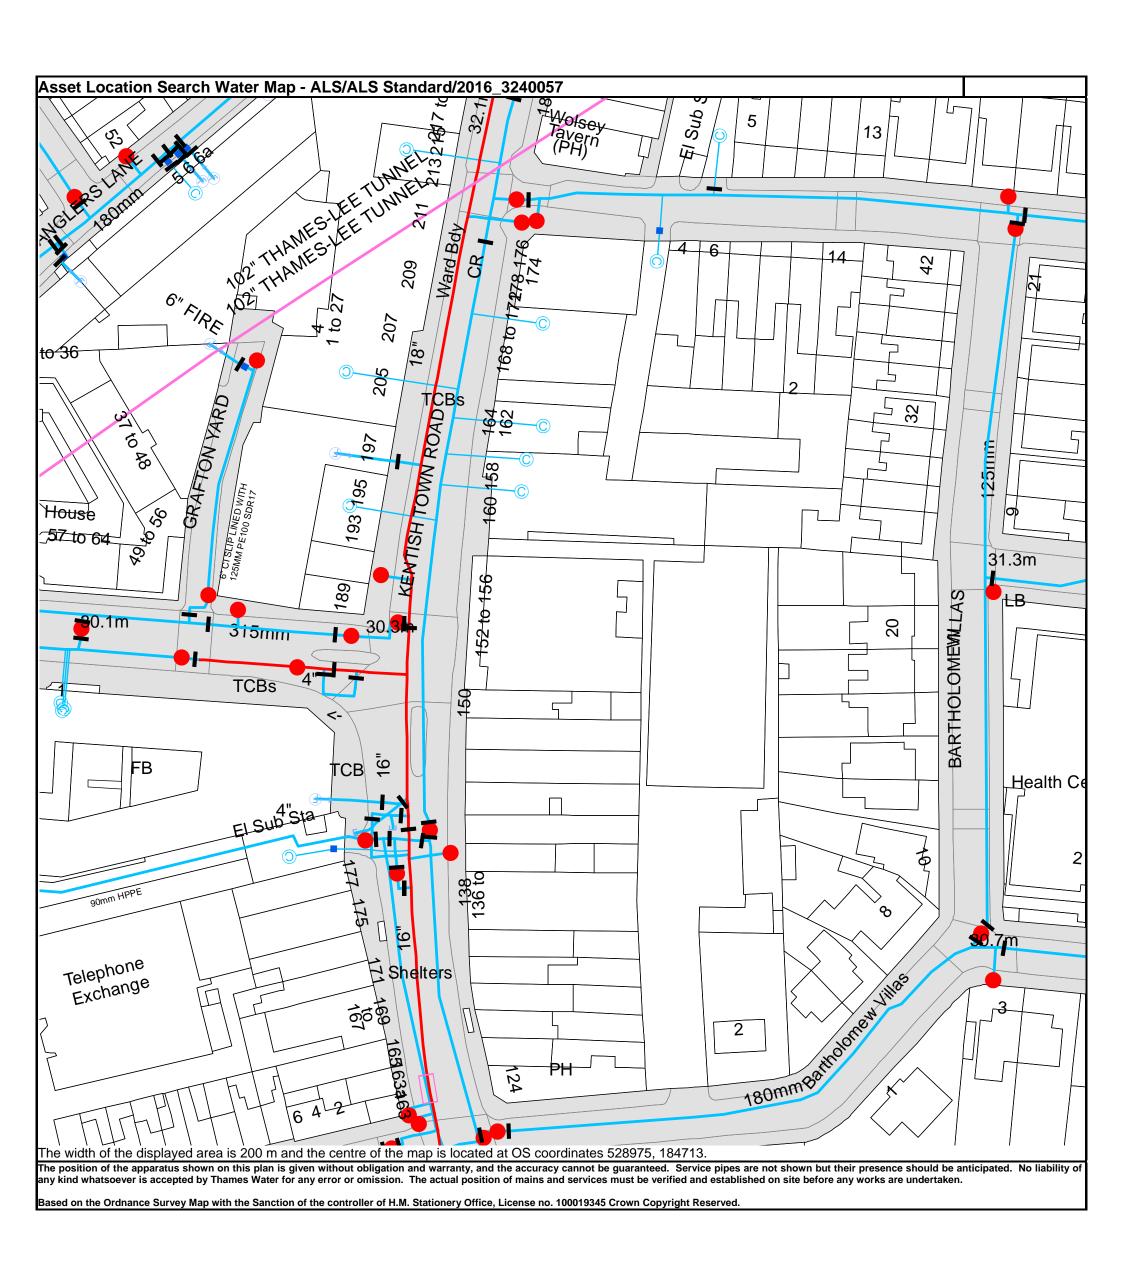



3" SUPPLY

3" FIRE

3" METERED

Water Pipes (Operated & Maintained by Thames Water)

Distribution Main: The most common pipe shown on water maps.
 With few exceptions, domestic connections are only made to distribution mains.

Trunk Main: A main carrying water from a source of supply to a treatment plant or reservoir, or from one treatment plant or reservoir to another. Also a main transferring water in bulk to smaller water mains used for supplying individual customers.

Supply Main: A supply main indicates that the water main is used as a supply for a single property or group of properties.

Fire Main: Where a pipe is used as a fire supply, the word FIRE will be displayed along the pipe.

Metered Pipe: A metered main indicates that the pipe in question supplies water for a single property or group of properties and that quantity of water passing through the pipe is metered even though there may be no meter symbol shown.

Transmission Tunnel: A very large diameter water pipe. Most tunnels are buried very deep underground. These pipes are not expected to affect the structural integrity of buildings shown on the map provided.

Proposed Main: A main that is still in the planning stages or in the process of being laid. More details of the proposed main and its reference number are generally included near the main.

Valves

General PurposeValve

Air Valve

Pressure ControlValve

Customer Valve

Hydrants

Single Hydrant

Meters

Meter

End Items

Symbol indicating what happens at the end of $^{\perp}$ a water main.

Blank Flange
Capped End

Emptying Pit
Undefined End

Manifold

Customer Supply

Fire Supply

Operational Sites

Booster Station
Other

Other (Proposed)

Pumping Station

Service Reservoir

Shaft Inspection

Treatment Works

____ Unknown

———── Water Tower

Other Symbols

_____ Data Logger

PIPE DIAMETER DEPTH BELOW GROUND

Up to 300mm (12")	900mm (3')
300mm - 600mm (12" - 24")	1100mm (3' 8")
600mm and bigger (24" plus)	1200mm (4')

Other Water Pipes (Not Operated or Maintained by Thames Water)

Other Water Company Main: Occasionally other water company water pipes may overlap the border of our clean water coverage area. These mains are denoted in purple and in most cases have the owner of the pipe displayed along them.

Private Main: Indiates that the water main in question is not owned by Thames Water. These mains normally have text associated with them indicating the diameter and owner of the pipe.

Terms and Conditions

All sales are made in accordance with Thames Water Utilities Limited (TWUL) standard terms and conditions unless previously agreed in writing.

- 1. All goods remain in the property of Thames Water Utilities Ltd until full payment is received.
- 2. Provision of service will be in accordance with all legal requirements and published TWUL policies.
- 3. All invoices are strictly due for payment 14 days from due date of the invoice. Any other terms must be accepted/agreed in writing prior to provision of goods or service, or will be held to be invalid.
- 4. Thames Water does not accept post-dated cheques-any cheques received will be processed for payment on date of receipt.
- 5. In case of dispute TWUL's terms and conditions shall apply.
- 6. Penalty interest may be invoked by TWUL in the event of unjustifiable payment delay. Interest charges will be in line with UK Statute Law 'The Late Payment of Commercial Debts (Interest) Act 1998'.
- 7. Interest will be charged in line with current Court Interest Charges, if legal action is taken.
- 8. A charge may be made at the discretion of the company for increased administration costs.

A copy of Thames Water's standard terms and conditions are available from the Commercial Billing Team (cashoperations@thameswater.co.uk).

We publish several Codes of Practice including a guaranteed standards scheme. You can obtain copies of these leaflets by calling us on 0800 316 9800

If you are unhappy with our service you can speak to your original goods or customer service provider. If you are not satisfied with the response, your complaint will be reviewed by the Customer Services Director. You can write to him at: Thames Water Utilities Ltd. PO Box 492, Swindon, SN38 8TU.

If the Goods or Services covered by this invoice falls under the regulation of the 1991 Water Industry Act, and you remain dissatisfied you can refer your complaint to Consumer Council for Water on 0121 345 1000 or write to them at Consumer Council for Water, 1st Floor, Victoria Square House, Victoria Square, Birmingham, B2 4AJ.

Ways to pay your bill

Credit Card	BACS Payment	Telephone Banking	Cheque
Call 0845 070 9148 quoting your invoice number starting CBA or ADS.	Account number 90478703 Sort code 60-00-01 A remittance advice must be sent to: Thames Water Utilities Ltd., PO Box 3189, Slough SL1 4WW. or email ps.billing@thameswater. co.uk	By calling your bank and quoting: Account number 90478703 Sort code 60-00-01 and your invoice number	Made payable to 'Thames Water Utilities Ltd' Write your Thames Water account number on the back. Send to: Thames Water Utilities Ltd., PO Box 3189, Slough SL1 4WW or by DX to 151280 Slough 13

Thames Water Utilities Ltd Registered in England & Wales No. 2366661 Registered Office Clearwater Court, Vastern Rd, Reading, Berks, RG1 8DB.

Invoice

Mr Richard Colley

Customer Reference:

Description of Charges

Parmarbrook Thames Water Utilities Ltd.

PO Box 3189

345 Old Street Slough SL1 4WW London

EC1V 9LL

Invoice No: ADS16388451

ALS/ALS Our Ref:

Unit Price

Standard/2016_3240057

VAT (20%) Amount (Inc VAT)

Posting Date: 29-01-2016 Customer Number: ADS128312 **Purchase Order No: Due Date:** 12-02-2016

Search Address Supplied: 152 - 156, Kentish Town Rd, London, NW1 9QB

Qty

Asset Location Search £47.40 £9.48 £56.88

Thank you for your payment of £56.88

111111

OUTSTANDING AMOUNT (Inc. VAT)

£0.00

Please send any outstanding amount to Thames Water Utilities Ltd., PO Box 3189, Slough SL1 4WW.

For queries please contact the Property Searches Customer Support Team on Tel: 0845 070 9148.

VAT Reg. No GB 537456915





Search Code

IMPORTANT CONSUMER PROTECTION INFORMATION

This search has been produced by Thames Water Property Searches, Clearwater Court, Vastern Road, Reading RG1 8DB, which is registered with the Property Codes Compliance Board (PCCB) as a subscriber to the Search Code. The PCCB independently monitors how registered search firms maintain compliance with the Code.

The Search Code:

- provides protection for homebuyers, sellers, estate agents, conveyancers and mortgage lenders who
 rely on the information included in property search reports undertaken by subscribers on residential
 and commercial property within the United Kingdom
- sets out minimum standards which firms compiling and selling search reports have to meet
- promotes the best practise and quality standards within the industry for the benefit of consumers and property professionals
- enables consumers and property professionals to have confidence in firms which subscribe to the code, their products and services.

By giving you this information, the search firm is confirming that they keep to the principles of the Code. This provides important protection for you.

The Code's core principles

Firms which subscribe to the Search Code will:

- display the Search Code logo prominently on their search reports
- act with integrity and carry out work with due skill, care and diligence
- at all times maintain adequate and appropriate insurance to protect consumers
- conduct business in an honest, fair and professional manner
- handle complaints speedily and fairly
- ensure that products and services comply with industry registration rules and standards and relevant laws
- monitor their compliance with the Code

Complaints

If you have a query or complaint about your search, you should raise it directly with the search firm, and if appropriate ask for any complaint to be considered under their formal internal complaints procedure. If you remain dissatisfied with the firm's final response, after your complaint has been formally considered, or if the firm has exceeded the response timescales, you may refer your complaint for consideration under The Property Ombudsman scheme (TPOs). The Ombudsman can award compensation of up to £5,000 to you if he finds that you have suffered actual loss as a result of your search provider failing to keep to the Code.

Please note that all queries or complaints regarding your search should be directed to your search provider in the first instance, not to TPOs or to the PCCB.

TPOs Contact Details


The Property Ombudsman scheme Milford House 43-55 Milford Street Salisbury Wiltshire SP1 2BP Tel: 01722 333306

Fax: 01722 332296 Email: admin@tpos.co.uk

You can get more information about the PCCB from www.propertycodes.org.uk

PLEASE ASK YOUR SEARCH PROVIDER IF YOU WOULD LIKE A COPY OF THE SEARCH CODE

20 Appendix C – Below Ground Drainage Drawings

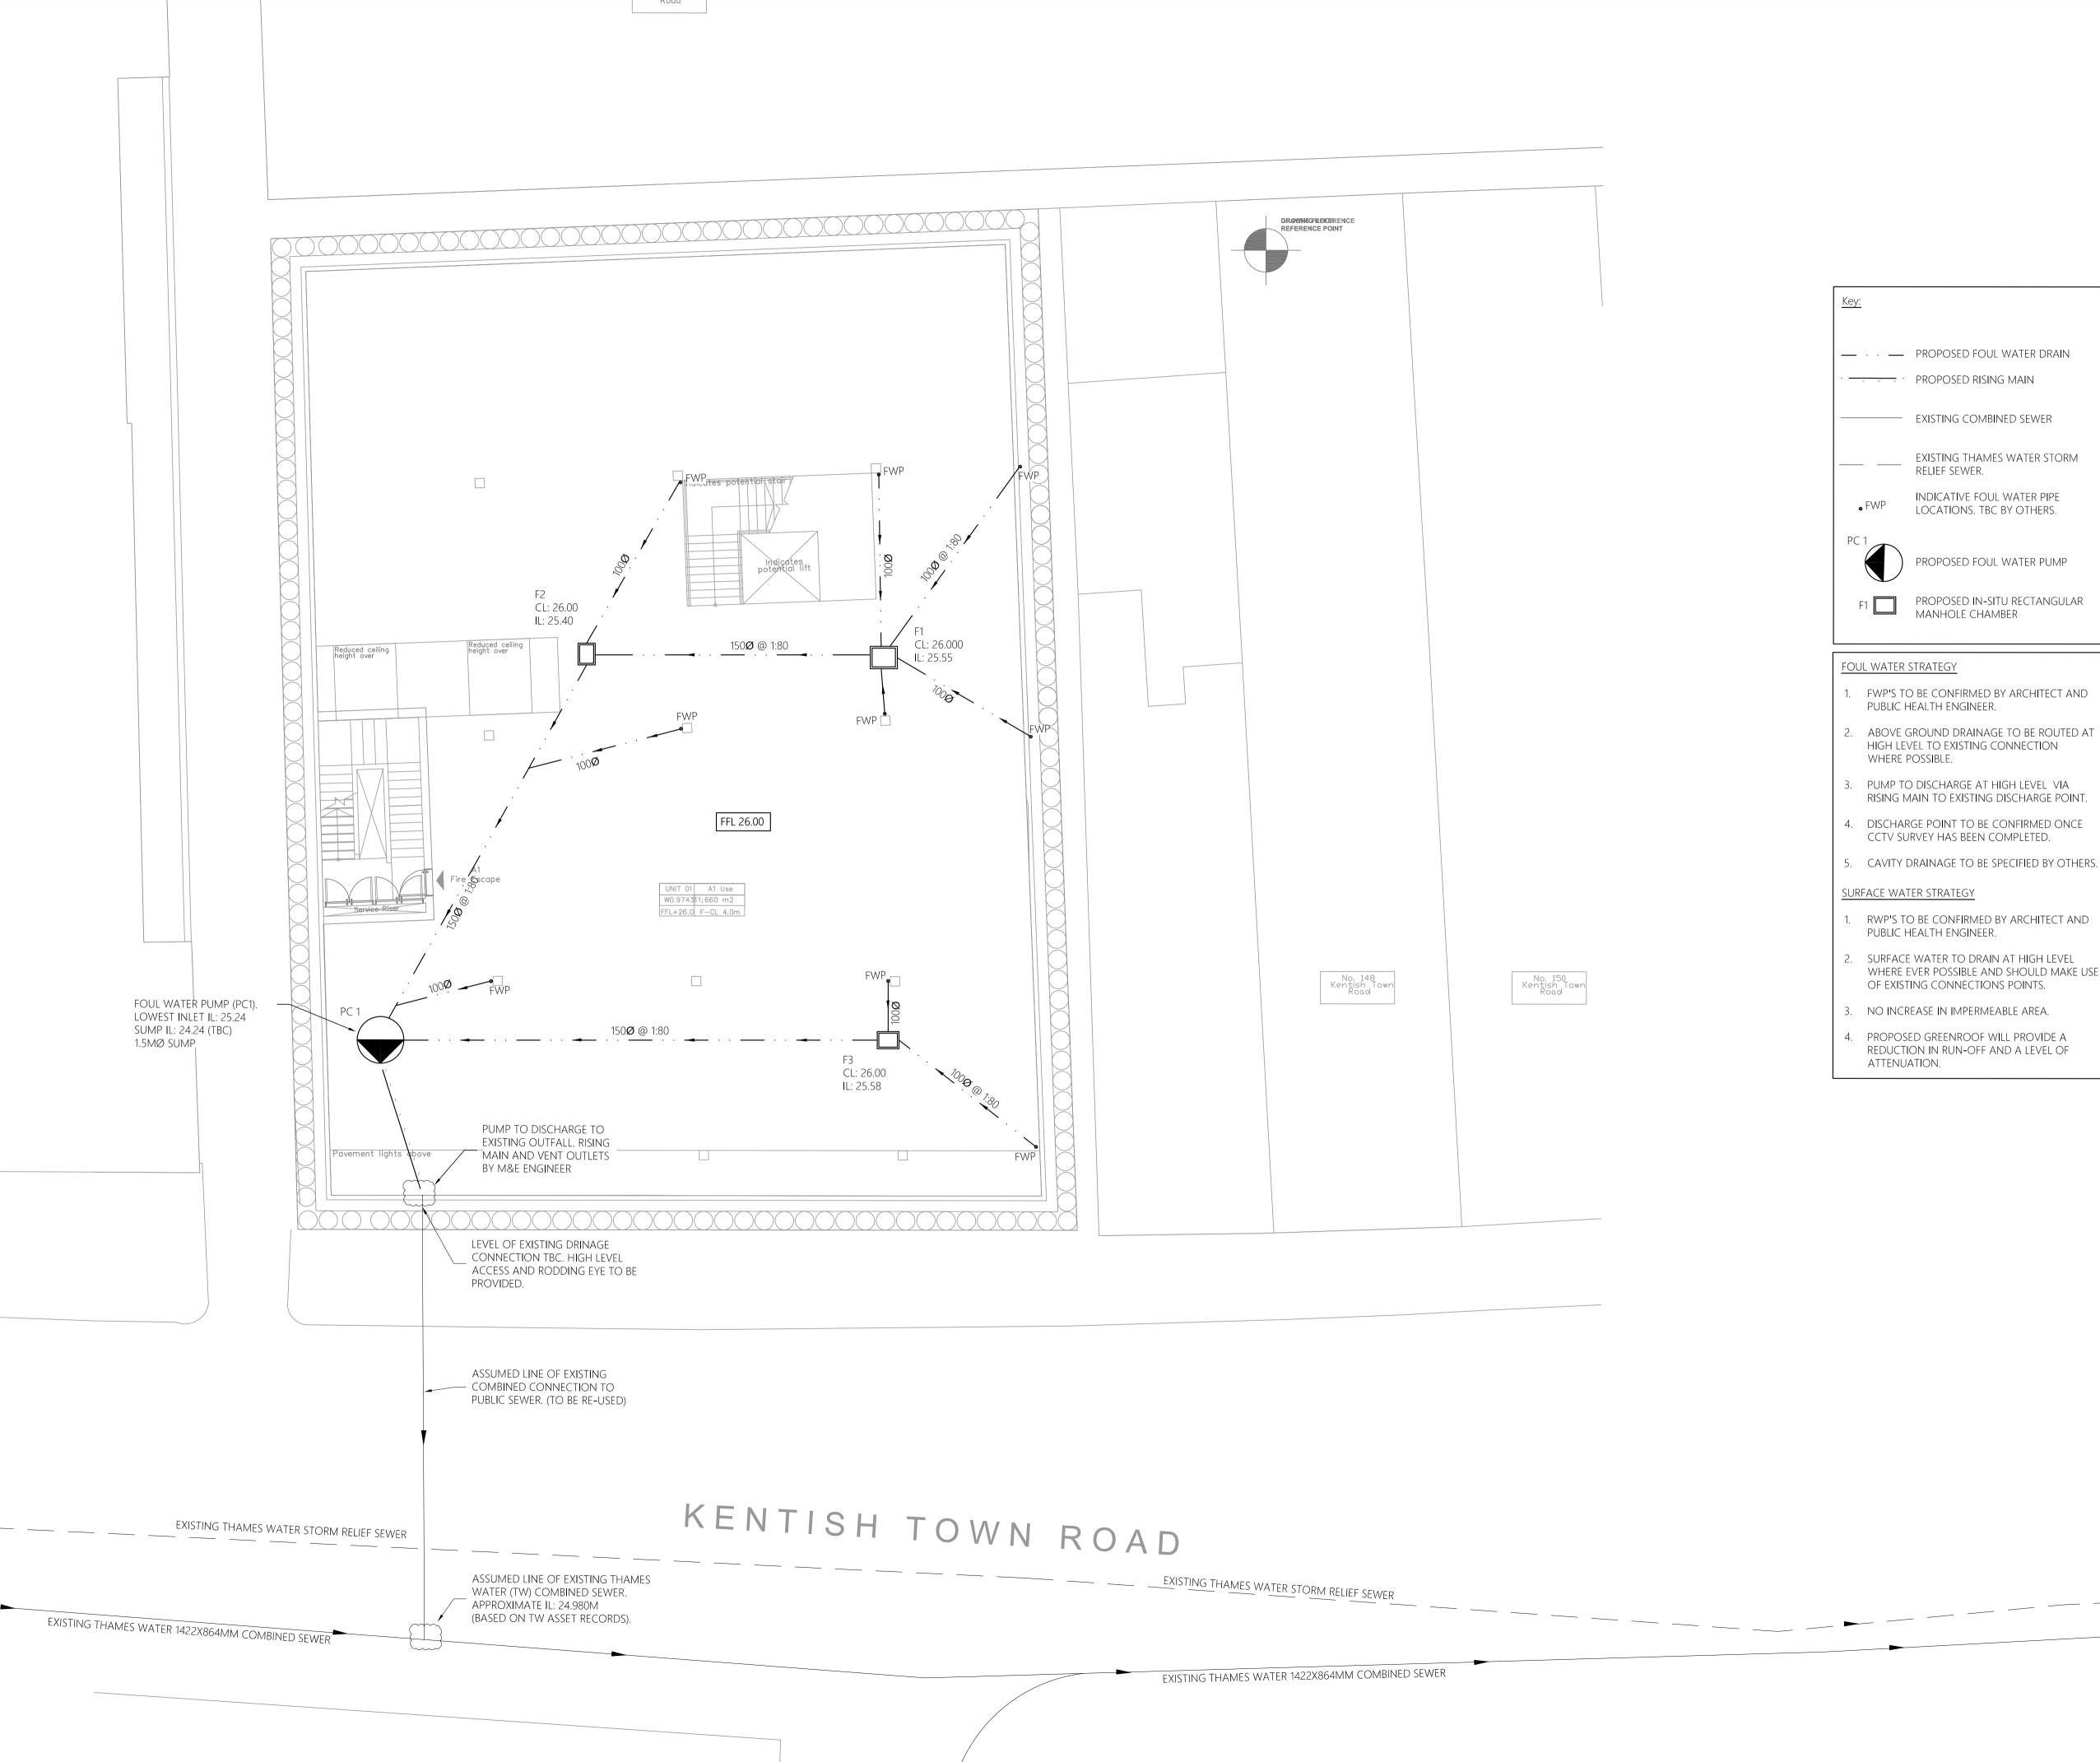

parmarbrook

2nd Floor, 345 Old Street, Shoreditch, London EC1V 9LL

www.parmarbrook.com Tel: +44 (0) 2078393999 e-mail: general@parmarbrook.com

GENERAL NOTES:

- LOCATION OF ALL NEW FWP POINTS ARE INDICATIVE AND SHOULD BE CONFIRMED BY OTHERS.
- CONNECTION TO PUBLIC SEWERS SUBJECT TO SECTION 106 APPLICATION.
- ALL CONNECTIONS NOT CONNECTING INTO CHAMBER TO have above ground access points.
- 4. THIS DRAWING IS TO BE READ IN CONJUNCTION WITH ALL OTHER ENGINEERING DRAWINGS AND CALCULATIONS ASSOCIATED WITH THIS PROJECT.
- ALL ADOPTABLE DRAINAGE WORKS ARE TO BE CARRIED OUT TO THE REQUIREMENTS AND FULL SATISFACTION OF THAMES
- WATER SERVICES LTD. ALL BUILDING DRAINAGE TO BE INSTALLED AND TESTED IN
- COMPLIANCE WITH THE 'BUILDING REGULATIONS 2000 Drainage and waste disposal approved document h 2002 EDITION'.
- INSPECTION CHAMBERS AND MANHOLES IN BUILDINGS TO HAVE MECHANICALLY FIXED AIRTIGHT COVERS UNLESS THE DRAIN ITSELF HAS WATERTIGHT ACCESS COVERS.
- ALL ABOVE GROUND DRAINAGE TO INCORPORATE RODDING ACCESS FACILITIES.
- ALL EXPOSED DRAINAGE WITHIN THE BUILDING FOOTPRINT TO BE INSTALLED IN ACCORDANCE WITH THE M&E SPECIFICATIONS AND RECOMMENDATIONS.
- 10. ALL PIPEWORK TO BE 100MMØ CAST IRON UNLESS STATED OTHERWISE.

SURFACE WATER STRATEGY

- RWP'S TO BE CONFIRMED BY ARCHITECT AND PUBLIC HEALTH ENGINEER.
- Surface water to drain at high level where ever possible and should make use of existing connections points.
- 3. NO INCREASE IN IMPERMEABLE AREA.
- 4. PROPOSED GREENROOF WILL PROVIDE A REDUCTION IN RUN-OFF AND A LEVEL OF ATTENUATION.

0 04.03.16 PLANNING REV DATE DESCRIPTION **AMENDMENTS**

Project:

152-156

KENTISH TOWN ROAD

PROPOSED BELOW GROUND DRAINAGE STRATEGY

LOWER GROUND FLOOR

Client:


MHA LONDON

Architect:

MAREK WOJCIECHOWSKI ARCHITECTS

PLANNING

Designed:	JD	Drawn:	JD
Checked:	MG	Date:	02.02.2016
Project No:	1599	Scale @ A1:	1:100
Drawing No:	SK001	Revision:	000

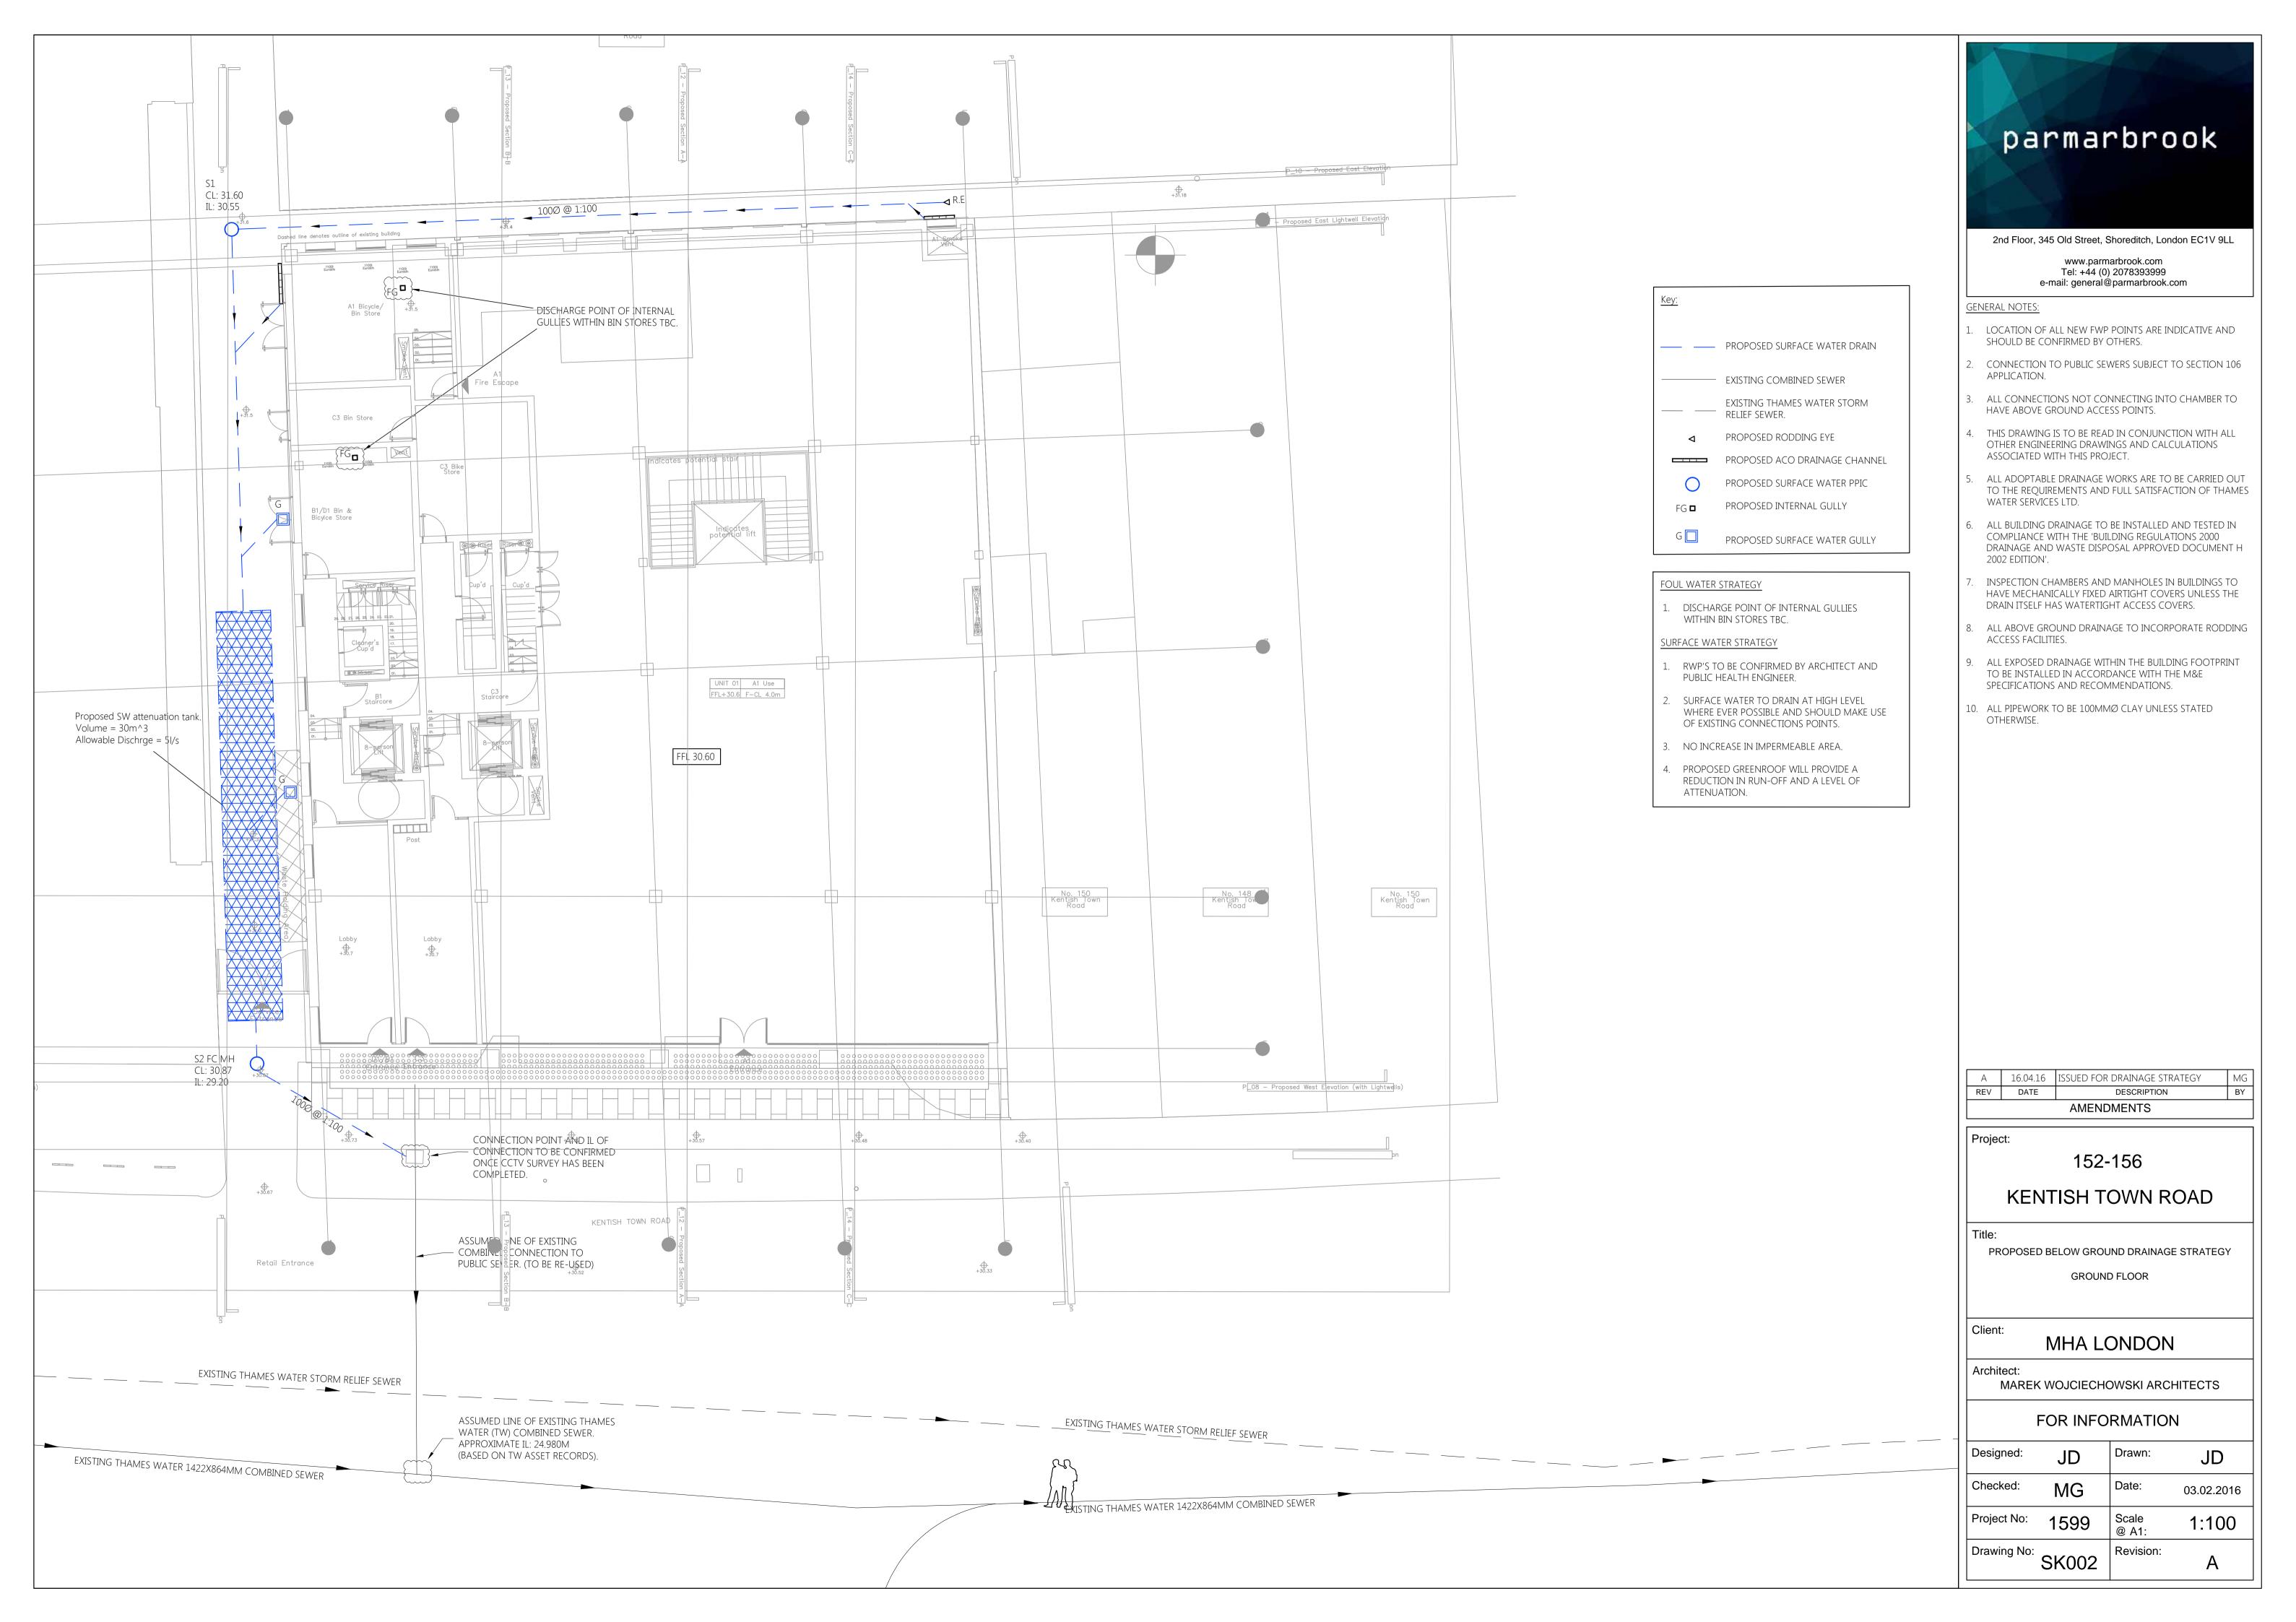

21 Appendix D – Strategic Flood Risk Assessment Maps