
Douglas and King Architects

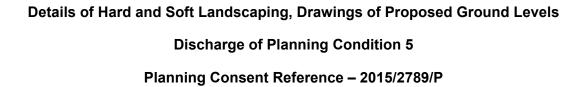

252 Finchley Road. London. NW3 7AA

Revision A – 24th May 2016

1.0 Introduction

Please note the SUDs drainage design has been prepared by Conisbee Engineers and is submitted as part of a separate document.

Please find enclosed;

Drawing FINc252 ga 150 (Details of Hard and Soft Landscaping) External Works Strategy.

Drawing FINc252 ga 700 Details of Hard and Soft Landscaping.

Drawing FINc252 ga 702
Bat and Bird Box Specification and Locations
Specification of Bird and Bat Boxes

Drawing FCH 252 DMGA 101
Site Layout Providing Hoarding Arrangement

Drawing FCH 252 DMGA 105 Hoarding Arrangement - Plan


Drawing FCH 252 DMGA 106 Details of Hoardings

For details of Changes in Ground Levels please refer to the following drawings that indicate comparative sectional levels.

FINc252 PLEX 001 FINc252 PLEX 100 FINc252 PLEX 101 FINc252 PLEX 102 FINc252 PLEX 103 FINc252 PLEX 104 FINc252 PLEX 200 FINc252 PLEX 201 FINc252 PLEX 300 FINc252 PLEX 302 FINc252 PLEX 303 FINc252 PLGA 101 FINc252 PLGA 102 FINc252 PLGA 103 FINc252 PLGA 104 FINc252 PLGA 105 FINc252 PLGA 106 FINc252 PLGA 107 FINc252 PLGA 200 FINc252 PLGA 201

FINc252 PLGA 202



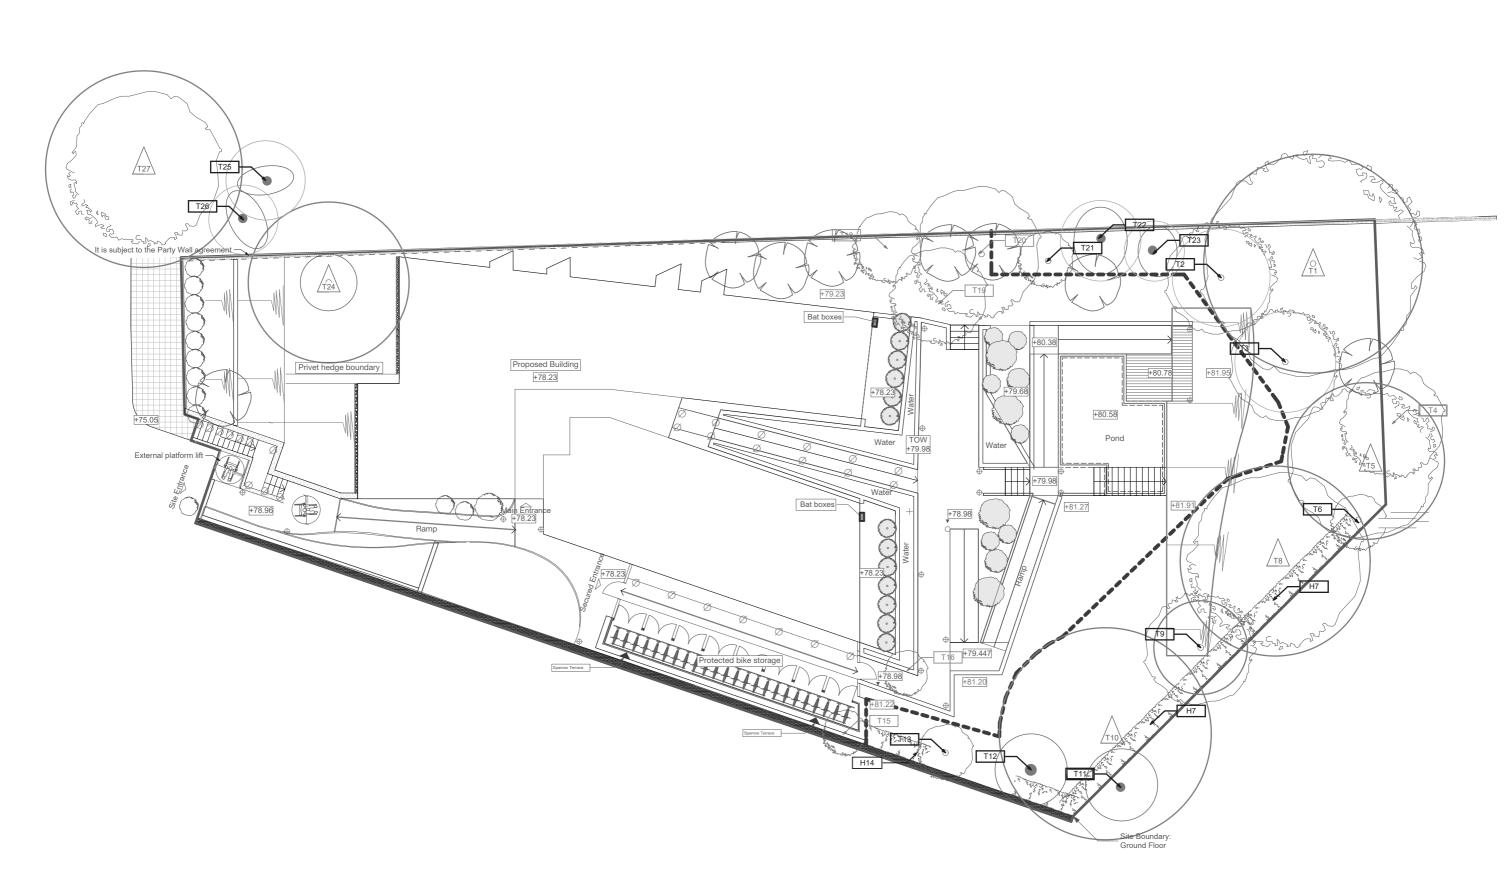

- Notes

 1. All dimensions to be checked on site.


 2. All dimensions are to masonry unless otherwise stated (ie not plaster finishes)

 3. All information is to be checked and verified by the contractors and sub-contractors for accuracy and fit.

 4. Discrepancies or omissions to be brought to the attention of Douglas & King prior to construction.


 5. Do not scale from this drawing.

To not scale from this drawing.									
	148-150 Curtain Road London EC2A 3AR t + 44 (020) 7613 1395 info@douglasandking.com www.douglasandking.com	revision	date	notes	project:	drawing title:	scale:	date:	
Douglas and King Architects					FINc252 252 Finchley Road NW3 7AA	Hard and Soft Landscape	1:200@A3	May	Ü
							1.200@A3	2016	ıΖ
									ıΞ
					client:		drawing no:		٦,
					Finchley Road Developments		FINc252 GA 150		교
									1
		I .	1	1		1	1	,	1

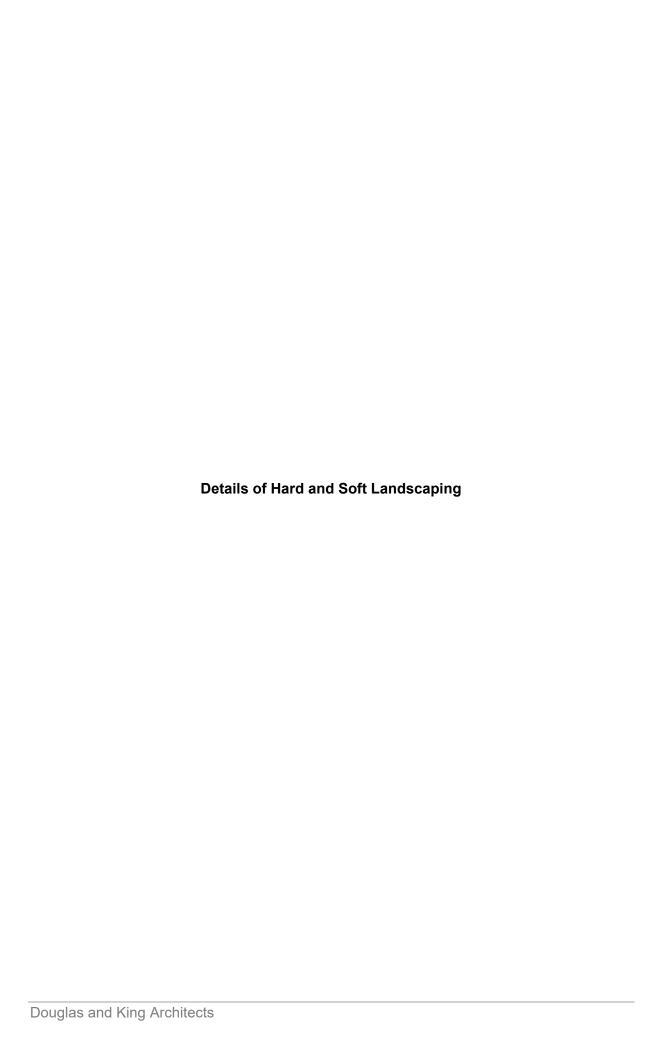

Notes:

All existing trees to be surveyed in line with Arboriculturalist recommendations on commencement of works. All planting and environmental details are as outlined in Middlemarch Environmental report issued in August 2015. For bat box locations refer to Drawing FINc252 GA 702A. For Garden and Access lighting refer to Drawing FINc252 GA 701A. Five Hedgehog gaps to be built into existing boundaries.

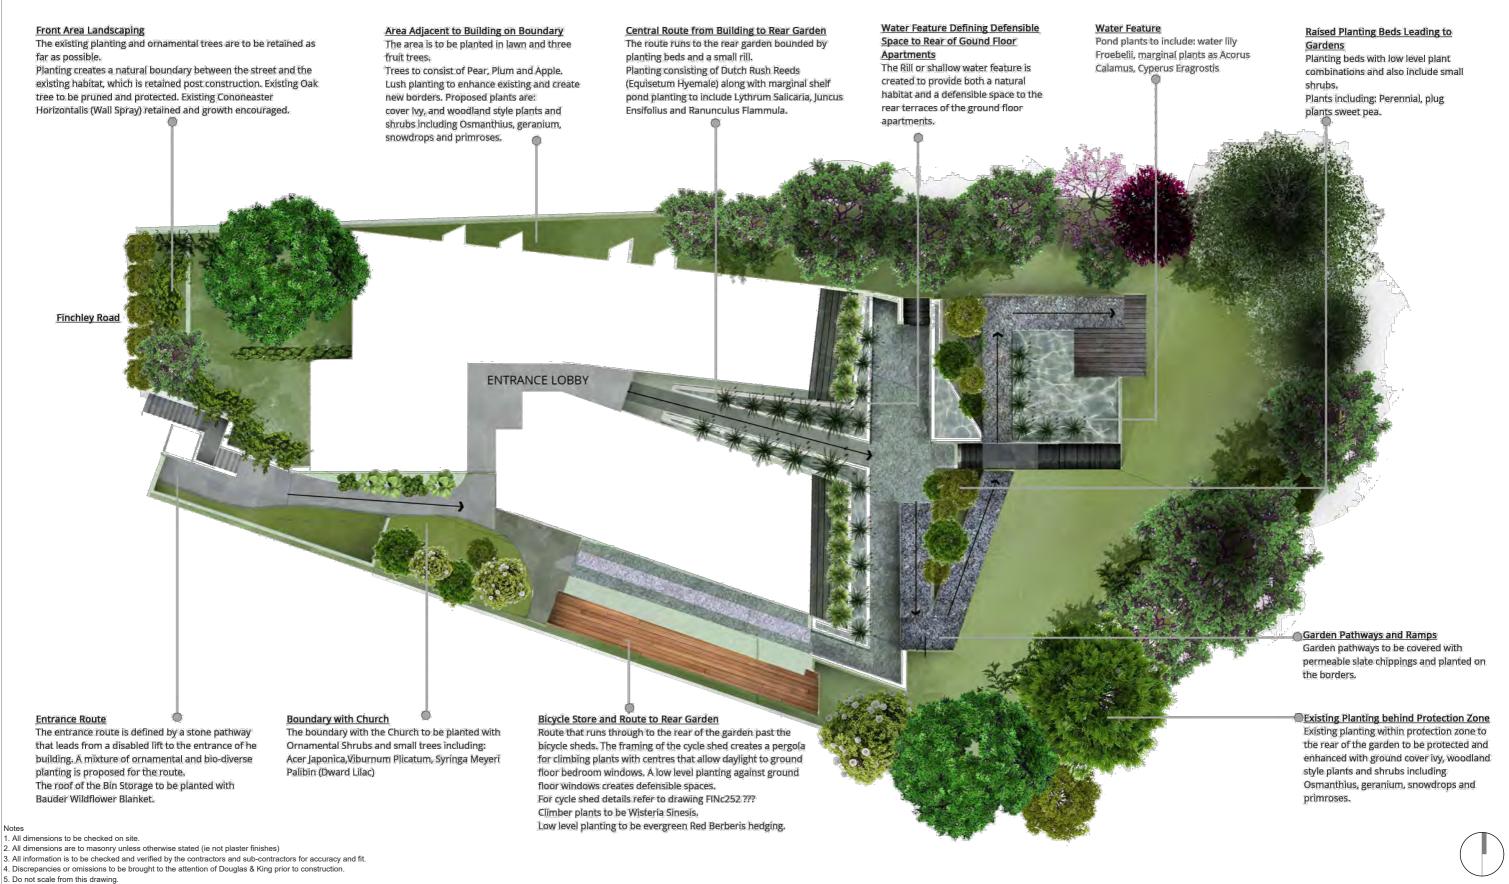

Douglas and King Architects

148-150 Curtain Road London EC2A 3AR t + 44 (020) 7613 1395 info@douglasandking.com


			FINc252 252 Finch
		client:	
			Finch
			Finch Devel
		i .	

ject:
FINc252
252 Finchley Road NW3 7AA
int:
Finchley Road
Developments

Proposed Landscaping, Hard and Soft Landscaping plan

| scale: | date: | May | 2016 |



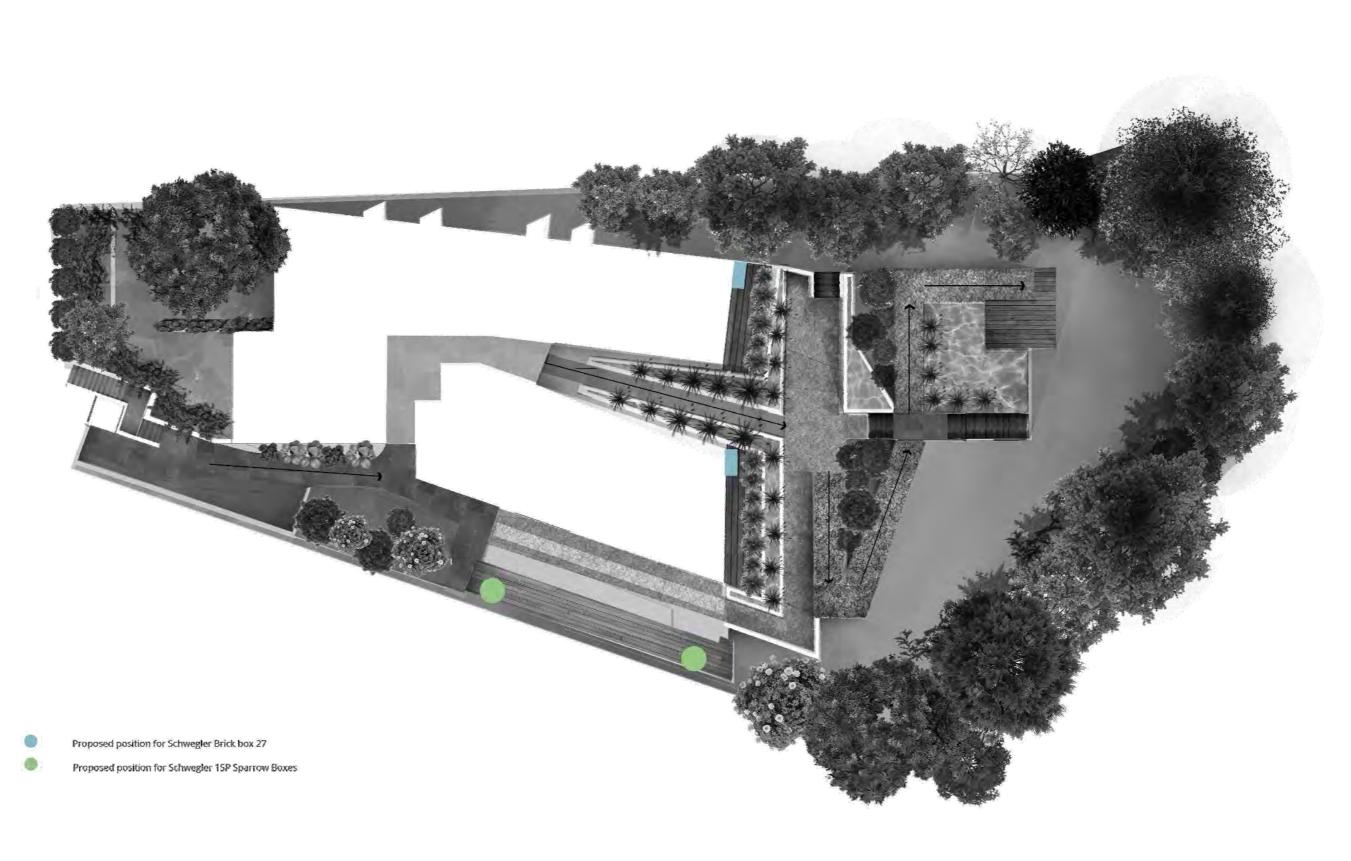

- Notes

 1. All dimensions to be checked on site.

 2. All dimensions are to masonry unless otherwise stated (ie not plaster finishes)

 3. All information is to be checked and verified by the contractors and sub-contractors for accuracy and fit.

 4. Discrepancies or omissions to be brought to the attention of Douglas & King prior to construction.

 5. Do not scale from this drawing.

Douglas and King	Architects
------------------	------------

148-150 Curtain Road London EC2A 3AR t + 44 (020) 7613 1395 info@douglasandking.com www.douglasandking.com

	П
	П

date	notes	project:
		FINc252
		252 Finchley Road NW3 7AA
		,
		client:
		Finchley Road
		Finchley Road Developments
		i .

Proposed Bird and Bat Box Locations

1:200@A3 FINc252 GA 702A

© Douglas and King Itd.

WILDLIFE HABITATS



The Schwegler Brick Box 27 has been specifically designed for bats. This box should be cemented into a wall in a building or underneath a bridge, arch or tunnel where conditions are relatively humid. Particularly useful for incorporating into new buildings to attract bats, or to provide new roost sites where existing buildings with bats are being renovated. This box contains a single internal wooden panel to simulate a crevice where bats can roost. The front panel is removeable for easy cleaning.

Dimensions: 265H x 180W x 240D mm. Entrance hole: $55 \times 26 \text{mm}$



The ISP Sparrow Terrace has been designed to help redress the balance of falling house sparrow numbers. The current UK population of 6 million pairs is half what it was in 1980 and this is thought to be due to habitat destruction and lack of suitable nesting spaces. Sparrows are social birds and like to nest in company. This terrace provides ideal nesting opportunities for three families. Made of Schwegler's revolutionary wood-concrete mix, this terrace is durable, breathable and will last many decades. It may also occasionally attract tits, redstarts and spotted flycatchers.

The terrace can be fixed on to the surface of a suitable wall or incorporated into the wall. It is suitable for all types of houses in built-up areas, and on industrial and agricultural buildings such as barns, sheds and factories. Due to its weight (15kg), it is not suitable for fences or garden sheds. Ideally place the terrace two metres or more above the ground. Either install on the surface of the wall using the plugs and screws provided, or install directly into the wall. Cleaning is advisable but not necessary. The front panel can be removed by turning the screw hook.

The Sparrow Terrace is available in either Stone or Brown Brood chamber dimensions:


- * Height: 16cm
- * Width: 10.5cm
- * Depth: 15cm


External dimensions:

- * Height: 24.5cm
- * Width: 43cm
- * Depth: 20cm
- * Weight: 15kg.






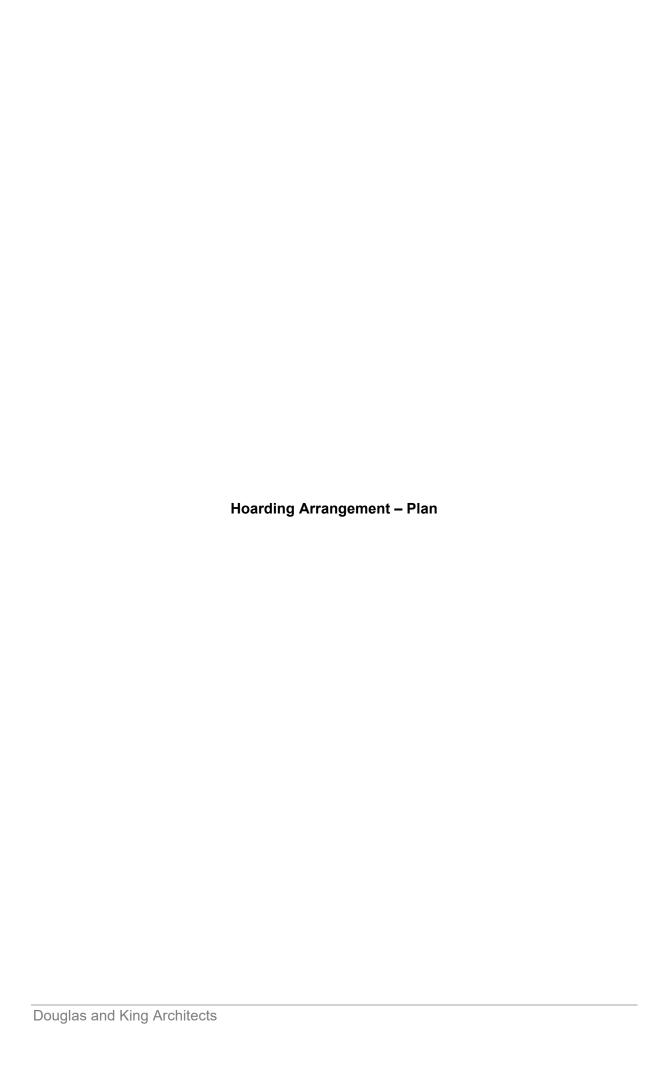

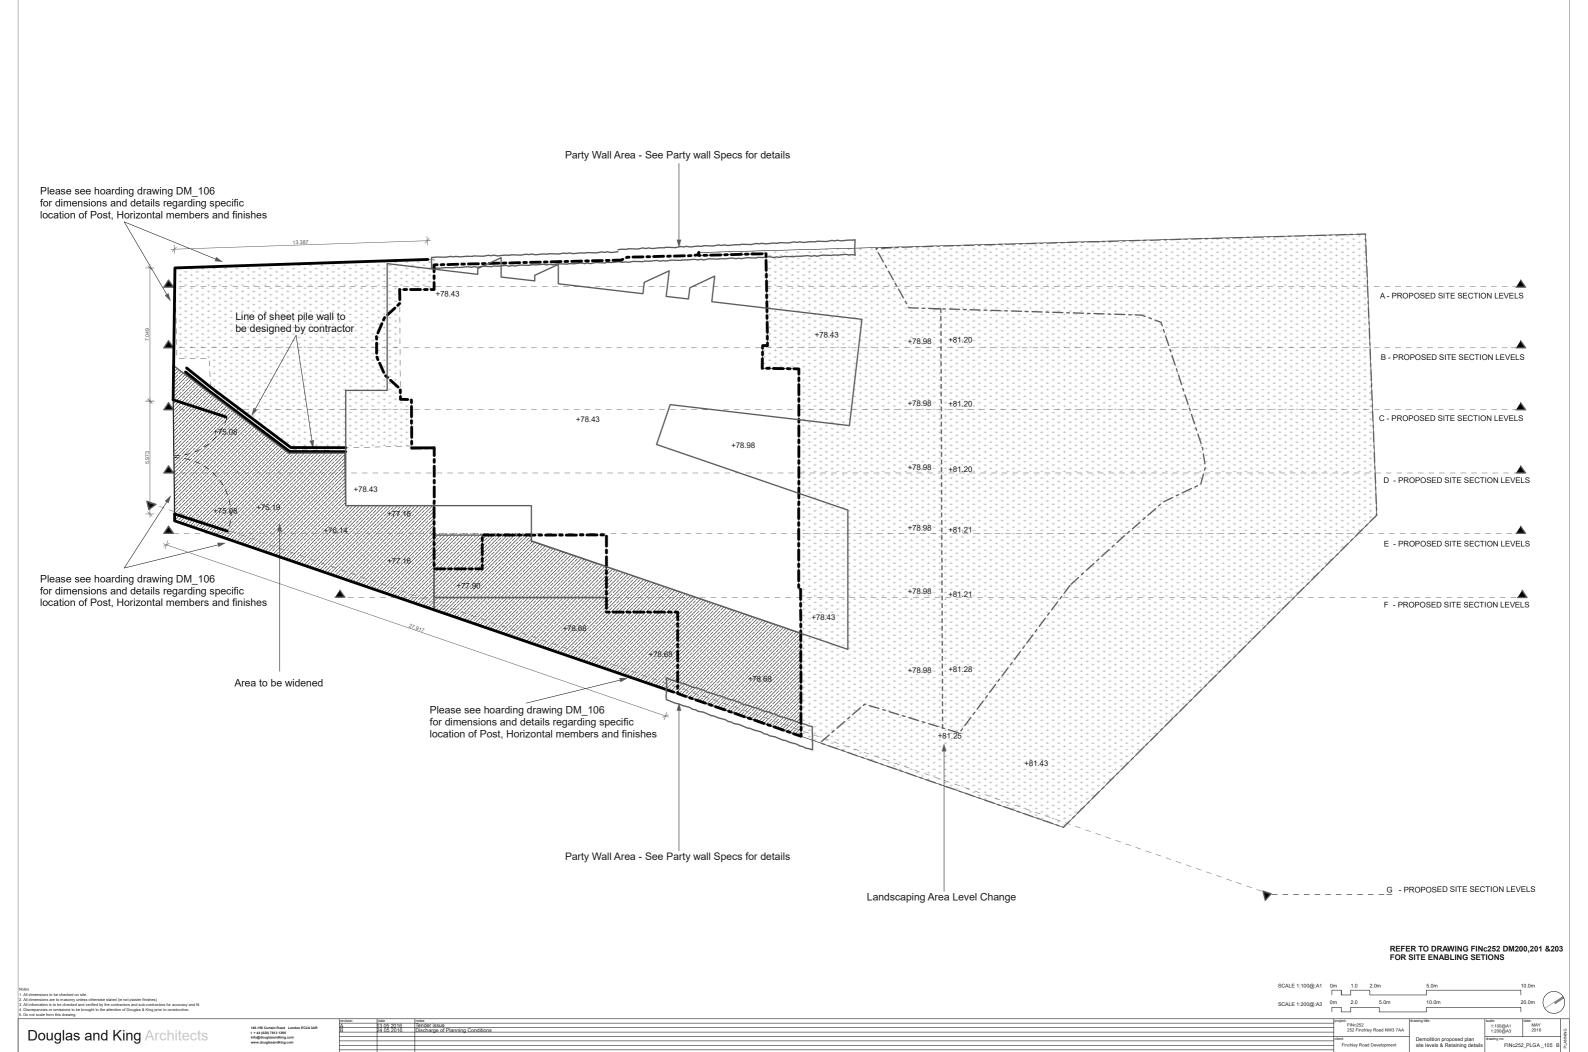



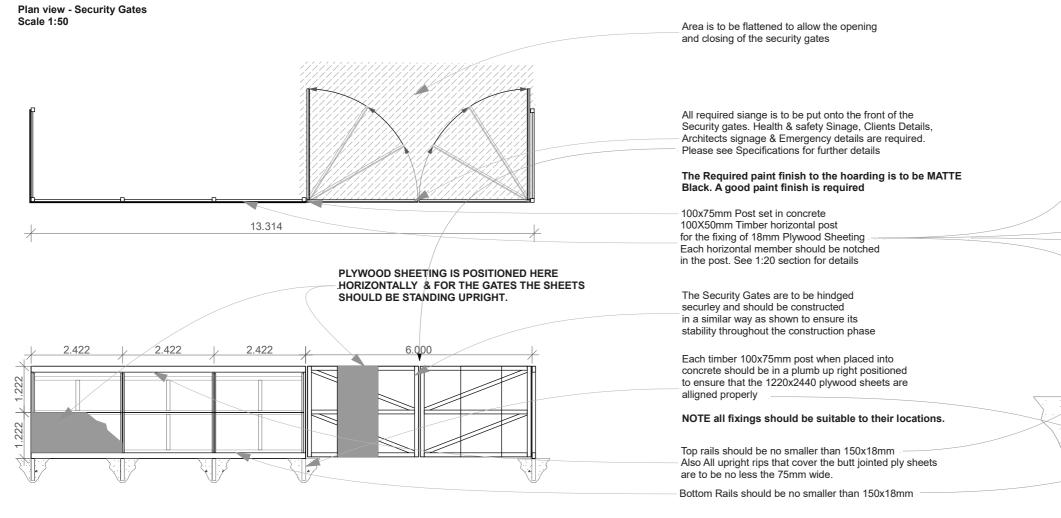

NOTE: The build up shown here is the typical build up for the complete hoarding set up.

Front Elevation & Section Scale 1:20

lobes . All dimensions to be checked on site. . All dimensions so be checked on site. . All dimensions are to manorny unless otherwise stated (ie not plaster finishes) . All information is to be checked and verified by the contractors and sub-contractors for accuracy an . Discrepancies or emissions to be between 10 Douglas & King prior to construction.

Scale 1:50

Douglas and King Architects

Front Elevation - Security Gates

148-150 Curtain Road London EC2 t + 44 (020) 7613 1395 info@douglasandking.com www.douglasandking.com A B date
13 05 2016 Tender issue
24 05 2016 Discharge of Planning Conditions

FINCESZ 252 Finchley Road NW3 7AA client: Ho

232_FLGA_100 B

For details of Changes in Ground Levels please refer to the following drawings that indicate comparative sectional levels.

FINc252 PLEX 001

FINc252 PLEX 100

FINc252 PLEX 101

FINc252 PLEX 102

FINc252 PLEX 103

FINc252 PLEX 104

FINc252 PLEX 200

FINc252 PLEX 201

FINc252 PLEX 300

FINc252 PLEX 302 FINc252 PLEX 303

FINc252 PLGA 101

FINc252 PLGA 102

FINc252 PLGA 103

FINc252 PLGA 104 FINc252 PLGA 105

FINc252 PLGA 106

FINc252 PLGA 107

FINc252 PLGA 200

FINc252 PLGA 201

FINc252 PLGA 202



