Advertisement Application Hub – London, Goodge Street



Heritage Status

O Within a conservation area A listed building

Statutory Requirements

- Advertisement Consent
- O Listed Buildings Consent
- O Planning Application for Lighting

165 Tower Bridge Road London SE1 3LW

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endpoint.

Project Number 7933

Revision F-AA

Date 30.10.2015



Site Information

SITE DETAILS

Site Name London Goodge Street

Address Brook House 2-16 Torrington Place London WC1E 7HB

Site Contacts Simon Lancaster (Whitbread) Mob: 07836 614600 Email: simon.lancaster@whitbread.com

Toby Wait (Tower 8) Mob: 07799 038758 Email: toby.wait@eu.jll.co

LANDLORD

Name

Address

Contact Name

LOCAL TOWN PLANNING AUTHORITY

Authority Name Camden Council

Address Planning – Development control Camden Council Camden Town Hall Judd Street London WC1H 8ND

Telephone 0207 974 4444

Website

www.camden.gov.uk

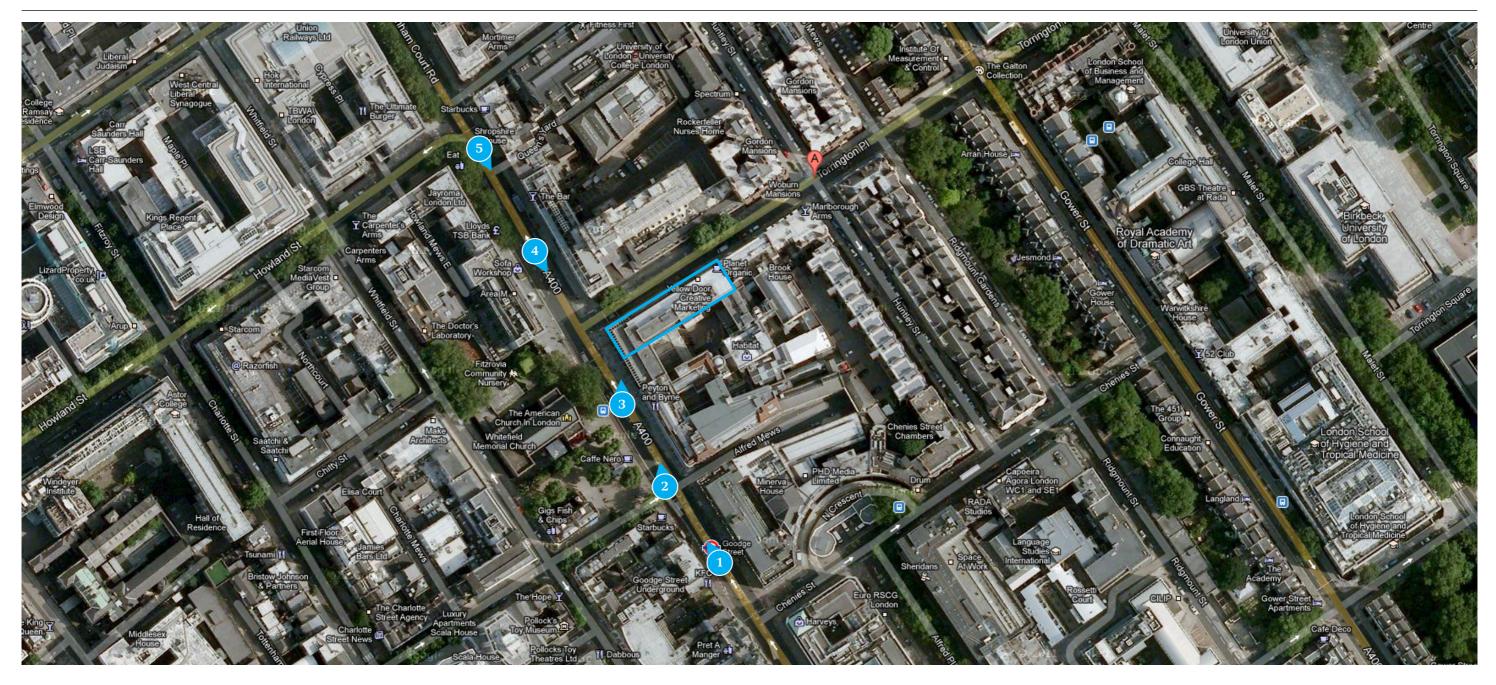
LOCATION Euston Square St. George's Gardens 0 (1) The Foundling Tavistock Square Gardens nsbury Theatre Warren Street 😝 swic -A50 rdon Square Garde The Brunswick 🙆 University Go College Londor Grant Museum of Zoology a St Corams Field Nursery Fitzroy Square Garden Russell Square 😝 coloni ۲ Guilford St University of London Hotel Russell SOAS, University of London -۲ Royal Academy of Dramatic Art University of Westminster Senate House Library 💵 London School . Goodge Street 😝 of Hygiene and... Pollock's Toy Museum 💼 ogle St he British Museum 😰 Grange Holborn Fitzroy Tavern ham Place A5204 Holborn 😝 St Giles 🖿 New Oxford St Sir Jo New Oxford St Dominion Theatre O Tottenham Court Road

NOTES

1. -

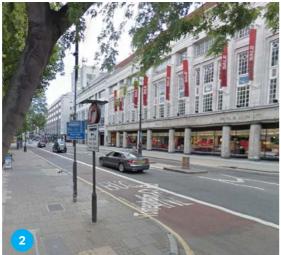
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Site Approaches

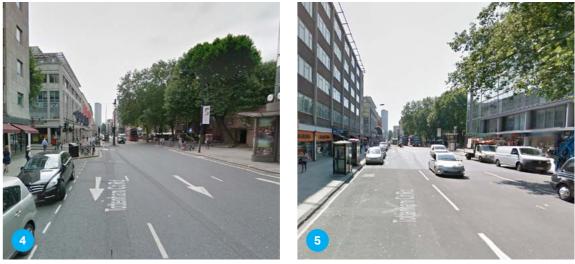


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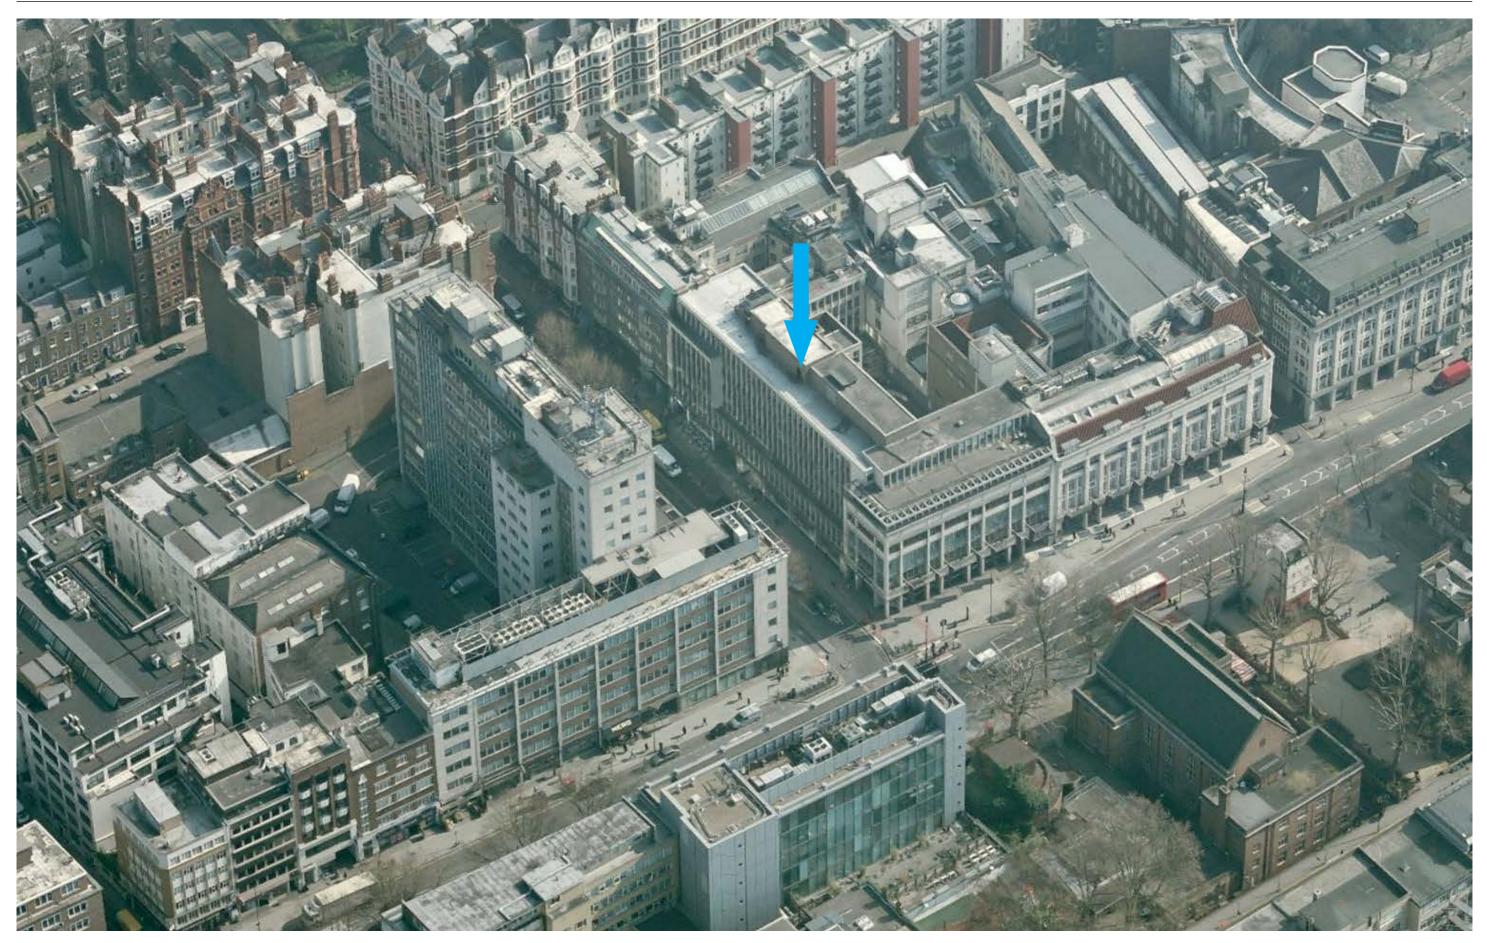


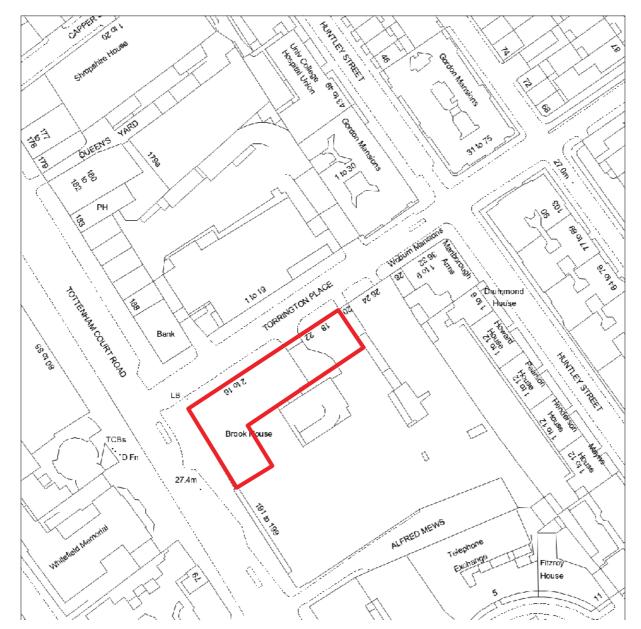




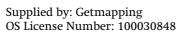
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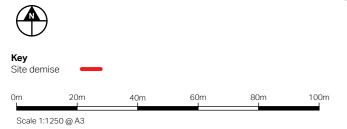
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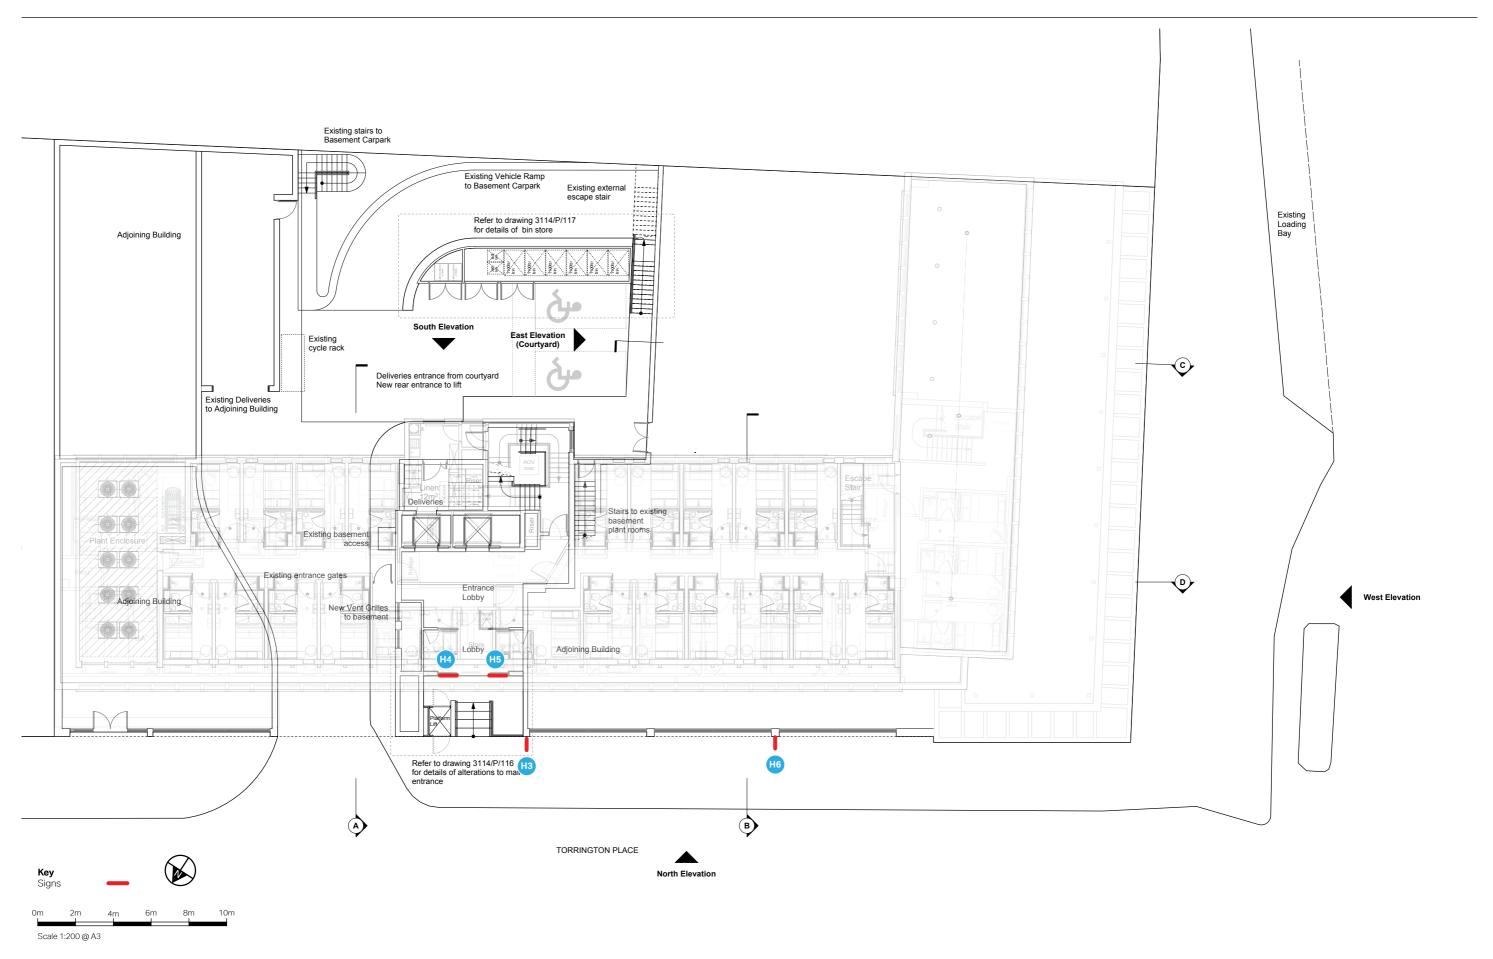
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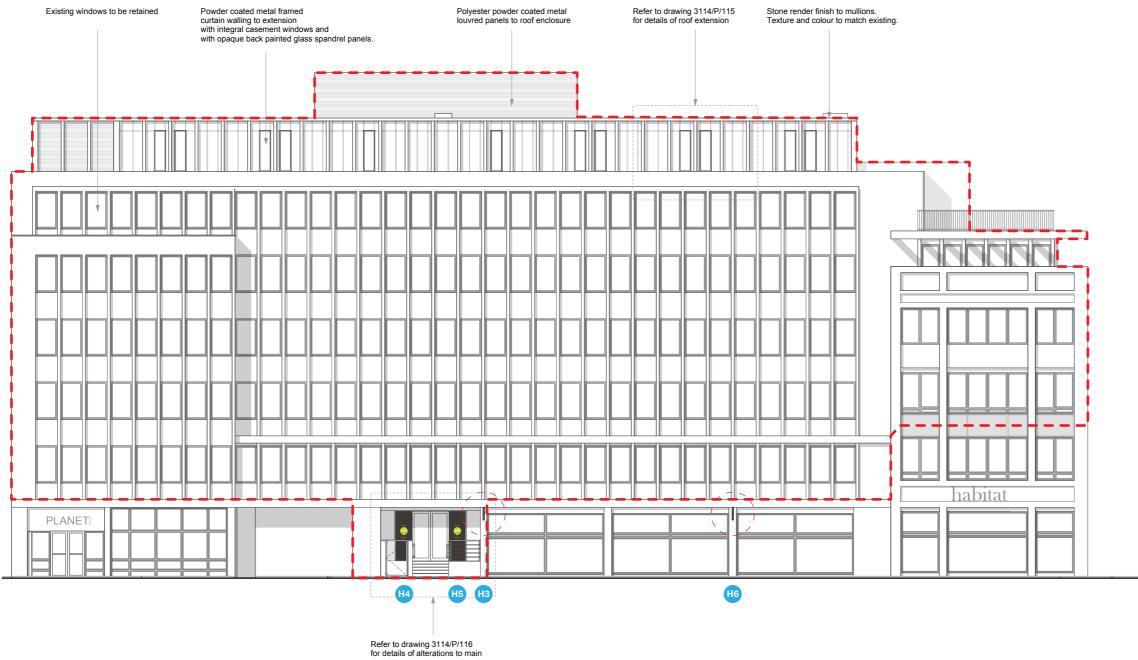
Sign Locations



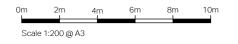
© Copyright Endpoint

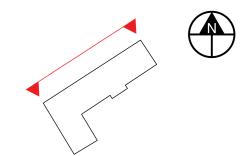
..... Note: Signs shown on plan are not to scale and are indicative of location only

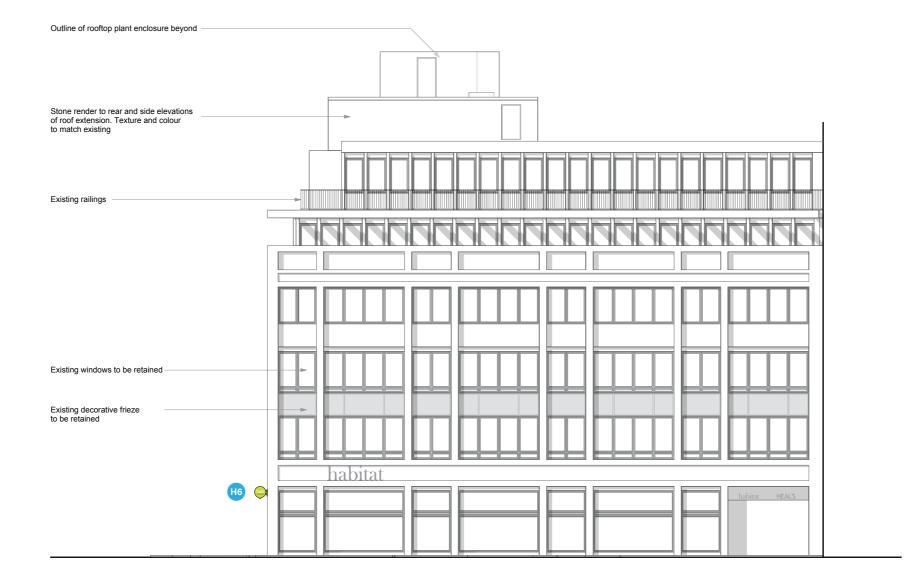
..... Front Elevation (North)



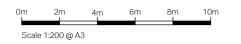
entrance

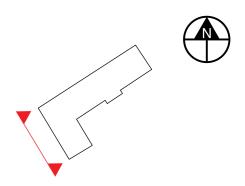






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H3 H6

Projecting Sign

Description:

Polished optically clear acrylic faced logo panel each side, both back decorated internally illuminated double sided logo on bracket mounted brushed stainless steel lightbox.

Illumination:

Logos face illuminated with 6000K LED lightsheet to provide maximum face light output of 250 candelas m2.

Colour:

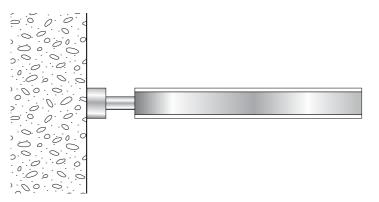
Logo to HUB standard logo colour specs. Refer to printing specification in general notes in technical intent appended to these guidelines. Lightbox casing, support brackets and bracket fixings shroud: Stainless steel with 240s grade brushed finish.

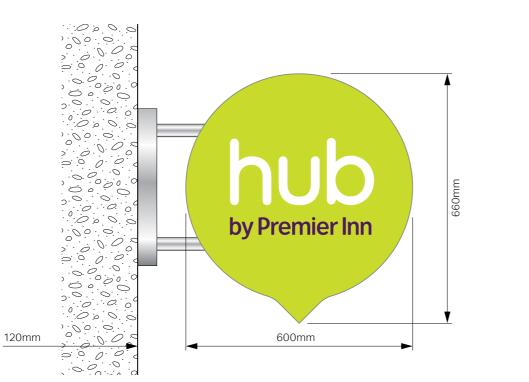
O/A sign size:

Logo Roundel 600mm x 660mm x 105mm Overall projection 720mm

H3 Height to underside: 3080mm H6 Height to underside: 3080mm

Qty: 2







Scale 1:10 @ A3

HUB-200-A HUB-201-A

Refer to drawing no.

H4 H5

Illuminated glass panels

Description:

The main guest entrance will be branded glass panels integrated into the buildings façade as part of the window glazing. The panels are face clad in polished clear low iron laminated safety glass back decorated with a Hub grey opaque finish with cut in translucent LED backed illuminated Hub logo. This is held in place by a LED light sheet support structure.

Illumination:

The logo is face illuminated by 8mm lightsheet (6000K), mounted immediately behind the translucent logo graphic

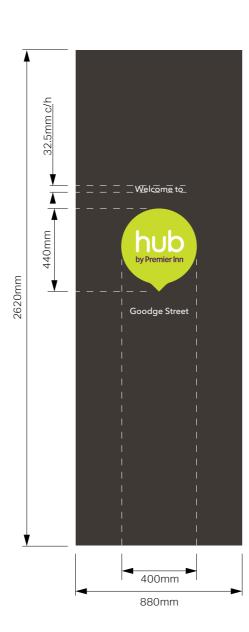
Colour:

The glass is back decorated in Hub grey vinyl. The logo is to Hub colour specification, made up of 4 No vinyl layers to achieve the tone and illumination requested by Whitbread.

H4 size: 880mm x 2620mm H5 size: 880mm x 2620mm

H4 Height to underside: 910mm H5 Height to underside: 910mm

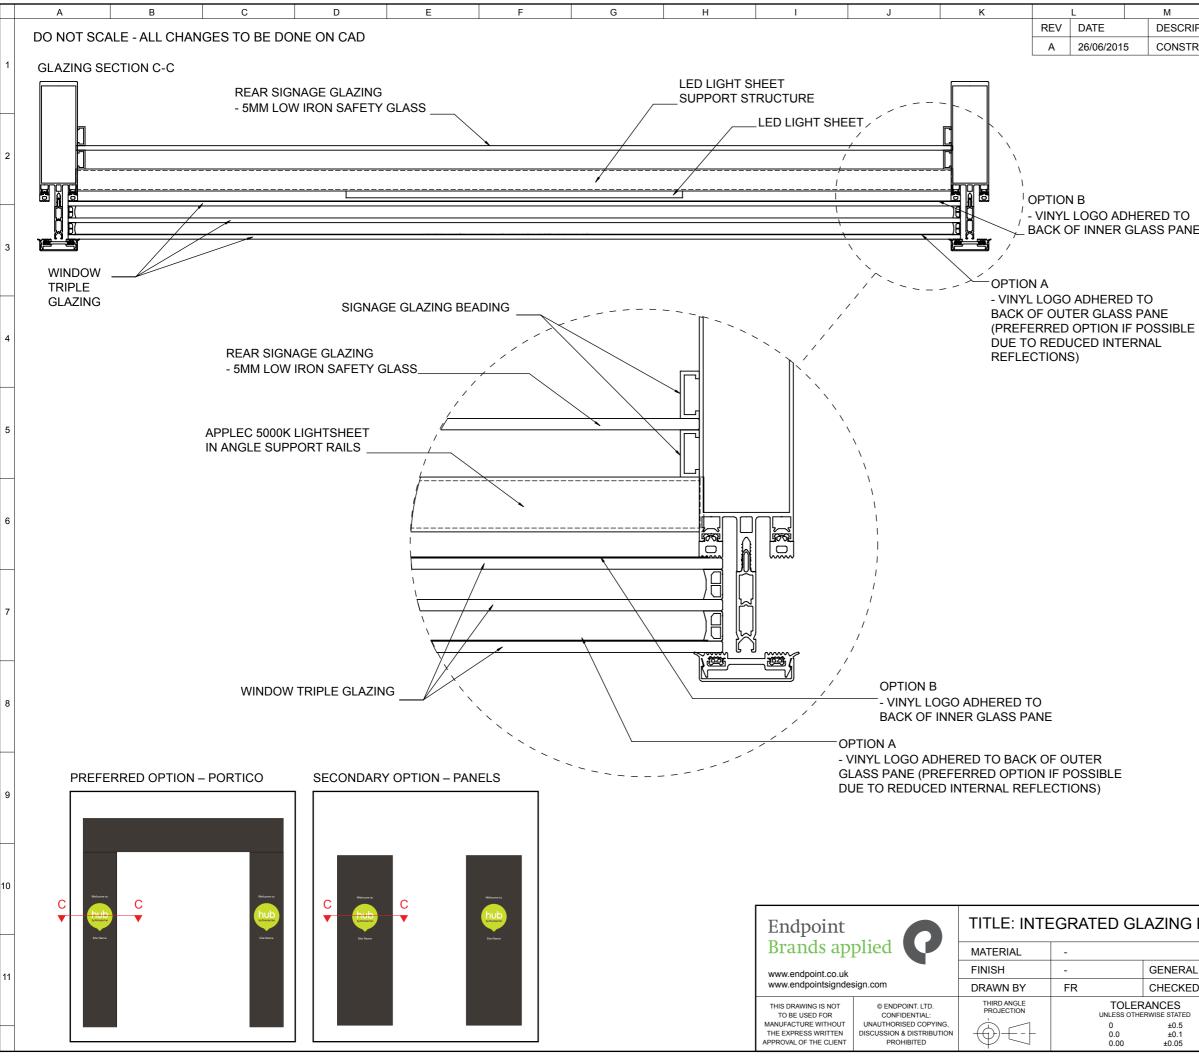
Qty: 2



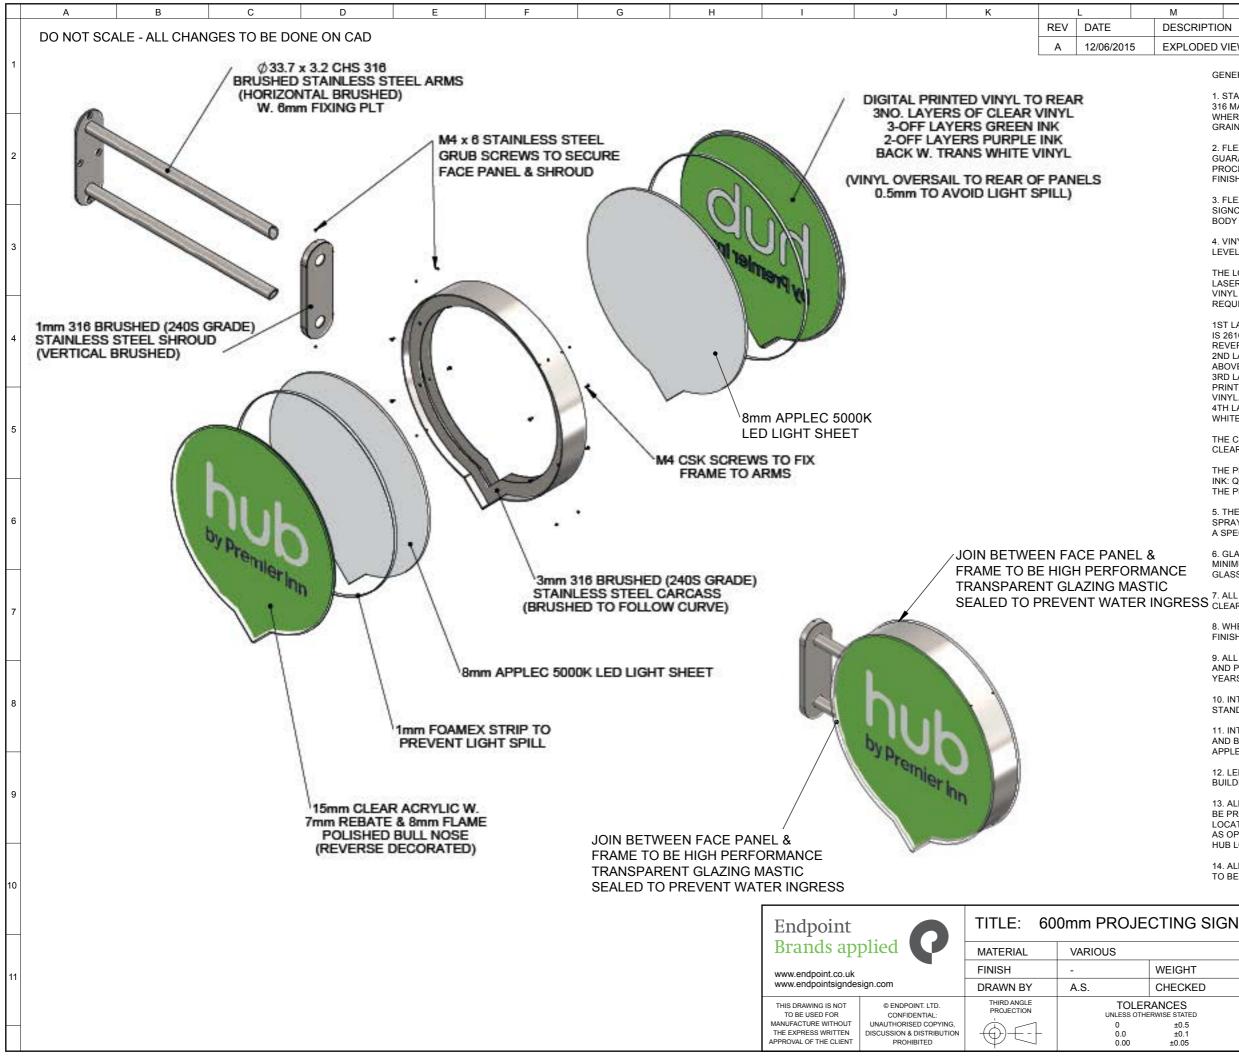
Scale 1:20 @ A3

HUB-120-A

Refer to drawing no.



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RUCTION INTENT DETAILS OPTION 2 -						
1. 5	GENERAL NOTES: 1. STAINLESS STEEL: WHERE STAINLESS STEEL IS SPECIFIED IT IS 316 MARINE GRADE					
WH GR	HERE BRUSHED FINISH IS SPECIFIED IT IS TO BE 240S GRADE, RAIN DIRECTION AS SPECIFIED ON THE DRAWING.					
GU PR	JARANTEE) TO FACE OCESS DIRECT TO V	KFACE LOGO: TO BE DIGITALLY PRINTED (3 YEARS MINIMUM ANTEE) TO FACE ONLY WITH EFI VUTEK INKS, 8 COLOUR ESS DIRECT TO VUFLEX BACKLIT 520GP TRANSLUCENT PVC. - SMOOTH MATT PR LACQUER BOTH SIDES.				
SIC		FACE LIGHTBOXES TO BE FABRICATED FROM ALUMINIUM OMP FLEXFACE EXTRUSION ECONOFLEX SINGLE SIDED				
	VINYL LOGO TO ENTR VEL PROJECTING SIG		ASS PANEL	FEATURE	AND LOW	
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IS : RE	1ST LAYER GREEN & PURPLE – GREEN IS PANTONE 382C, PURPLE IS 261C – BOTH ARE PRINTED 540DPI, DOUBLE STRIKE, ON THE REVERSE OF CLEAR VINYL. 2ND LAYER GREEN & PURPLE – EXACTLY THE SAME AS THE					
3R PR	OVE. D LAYER GREEN ONL INTED 540DPI, DOUB					
4TI	H LAYER TRANS WHI HITE TRANSLUCENT	TE VINYL	TO FULL RE	AR - AVER	Y 4500	
	E CLEAR VINYL USEE EAR.	ON ALL	THE ABOVE	IS METAM	ARK MD3	
INF	E PRINTING IS CARR (: QS SERIES 2 UV IN E PRINTER PRINTS D	KJET SYS	TEM			
SP	5. THE HUB GREY GLASS ENTRANCE PANEL IS EITHER BACK SPRAYED RAL 7022 OR METAMARK CHARCOAL M5 -292 M4 BUT ON A SPECIAL M7 BACKING.					
MIN	6. GLASS PANELS FOR THE ENTRANCE FEATURE ARE TO BE MINIMUM 10MM OPTICALLY CLEAR LOW IRON LAMINATED SAFETY GLASS.					
	7. ALL GLASS PANELS TO BE EDGE SEALED WITH HIGH GRADE, CLEAR GLAZING MASTIC.					
	WHERE EXTERNAL PANNERE EXTERNAL PANNERE EXTERNAL PANNERE PAINT – LE				SPRAY	
AN	9. ALL M/STEEL SUPPORT STRUCTURES TO BE CLEANED, PRIMED AND POWDER COATED AFTER FABRICATION TO GIVE MINIUMUM 10 YEARS CORROSION RESISTANCE					
	10. INTERNAL ILLUMINATION FOR HIGH LEVEL SIGNS TO BE SLOAN STANDARD V180 LARGE LED MODULES (6500K)					
AN	11. INTERNAL ILLUMINATION FOR LOW LEVEL PROJECTING SIGN AND BACK ILLUMINATED LOGOS ON ENTRANCE PANELS TO BE APPLELEC 8MM LED LIGHT SHEET (5000K)					
	12. LED DRIVERS: ALL LED DRIVERS TO BE LOCATED IN THE BUILDING, WITHIN 5M OF THE SIGN LOCATION.					
13. ALL EXTERNAL ILLUMINATION LUMINAIRES AND PLACEMENT TO BE PROTOTYPED TO DETERMINE OPTIMUM SPECIFICATION, LOCATION, ILLUMINATION LEVEL AND LIGHT COVERAGE AS WELL AS OPTIMUM COLOUR TEMPERATURE FOR BEST RENDITION OF HUB LOGO COLOURS.						
14. ALL INSTALLATION DIMENSIONS AND STRUCTURAL SUPPORT TO BE DETERMINED AND CHECKED ON SITE BY THE CONTRACTOR.						
PANEL						
		SH	RINKAGE		-	
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DESCRIPTION					ED
EXPLODED VIEW					

GENERAL NOTES:

1. STAINLESS STEEL: WHERE STAINLESS STEEL IS SPECIFIED IT IS 316 MARINE GRADE WHERE BRUSHED FINISH IS SPECIFIED IT IS TO BE 240S GRADE, GRAIN DIRECTION AS SPECIFIED ON THE DRAWING

2 ELEXEACE LOGO: TO BE DIGITALLY PRINTED (3 YEARS MINIMUM GUARANTEE) TO FACE ONLY WITH EFI VUTEK INKS, 8 COLOUR PROCESS DIRECT TO VUFLEX BACKLIT 520GP TRANSLUCENT PVC. FINISH - SMOOTH MATT PR LACQUER BOTH SIDES.

3. FLEXFACE LIGHTBOXES TO BE FABRICATED FROM ALUMINIUM SIGNCOMP FLEXFACE EXTRUSION ECONOFLEX SINGLE SIDED BODY

4. VINYL LOGO TO ENTRANCE GLASS PANEL FEATURE AND LOW LEVEL PROJECTING SIGN

THE LOGO IS BACK APPLIED TO THE GLASS OVER AN OPENING LASER CUT INTO THE GREY VINYL. THE LOGO IS MADE UP OF 4 NO VINYL LAYERS TO ACHIEVE THE TONE AND ILLUMINATION REQUESTED BY WHITBREAD.

1ST LAYER GREEN & PURPLE - GREEN IS PANTONE 382C, PURPLE IS 261C – BOTH ARE PRINTED 540DPI, DOUBLE STRIKE, ON THE REVERSE OF CLEAR VINYL. 2ND LAYER GREEN & PURPLE - EXACTLY THE SAME AS THE

ABOVE

3RD LAYER GREEN ONLY - GREEN IS PANTONE 382C ONLY -PRINTED 540DPI, DOUBLE STRIKE, ON THE REVERSE OF CLEAR VINYL

4TH LAYER TRANS WHITE VINYL TO FULL REAR - AVERY 4500 WHITE TRANSLUCENT

THE CLEAR VINYL USED ON ALL THE ABOVE IS METAMARK MD3 CLEAR.

THE PRINTING IS CARRIED OUT ON VUTEK UV PRINTER QS 2000 INK: QS SERIES 2 UV INKJET SYSTEM THE PRINTER PRINTS DIRECT FROM PANTONE REFERENCES.

5. THE HUB GREY GLASS ENTRANCE PANEL IS EITHER BACK SPRAYED RAL 7022 OR METAMARK CHARCOAL M5 -292 M4 BUT ON A SPECIAL M7 BACKING.

6. GLASS PANELS FOR THE ENTRANCE FEATURE ARE TO BE MINIMUM 10MM OPTICALLY CLEAR LOW IRON LAMINATED SAFETY GLASS

SEALED TO PREVENT WATER INGRESS CLEAR GLAZING MASTIC.

8. WHERE EXTERNAL PAINT FINISH IS SPECIFIED IT IS SPRAY FINISH WET PAINT - LECHLER MG7055 - SILVER

9. ALL M/STEEL SUPPORT STRUCTURES TO BE CLEANED, PRIMED AND POWDER COATED AFTER FABRICATION TO GIVE MINIUMUM 10 YEARS CORROSION RESISTANCE

10. INTERNAL ILLUMINATION FOR HIGH LEVEL SIGNS TO BE SLOAN STANDARD V180 LARGE LED MODULES (6500K)

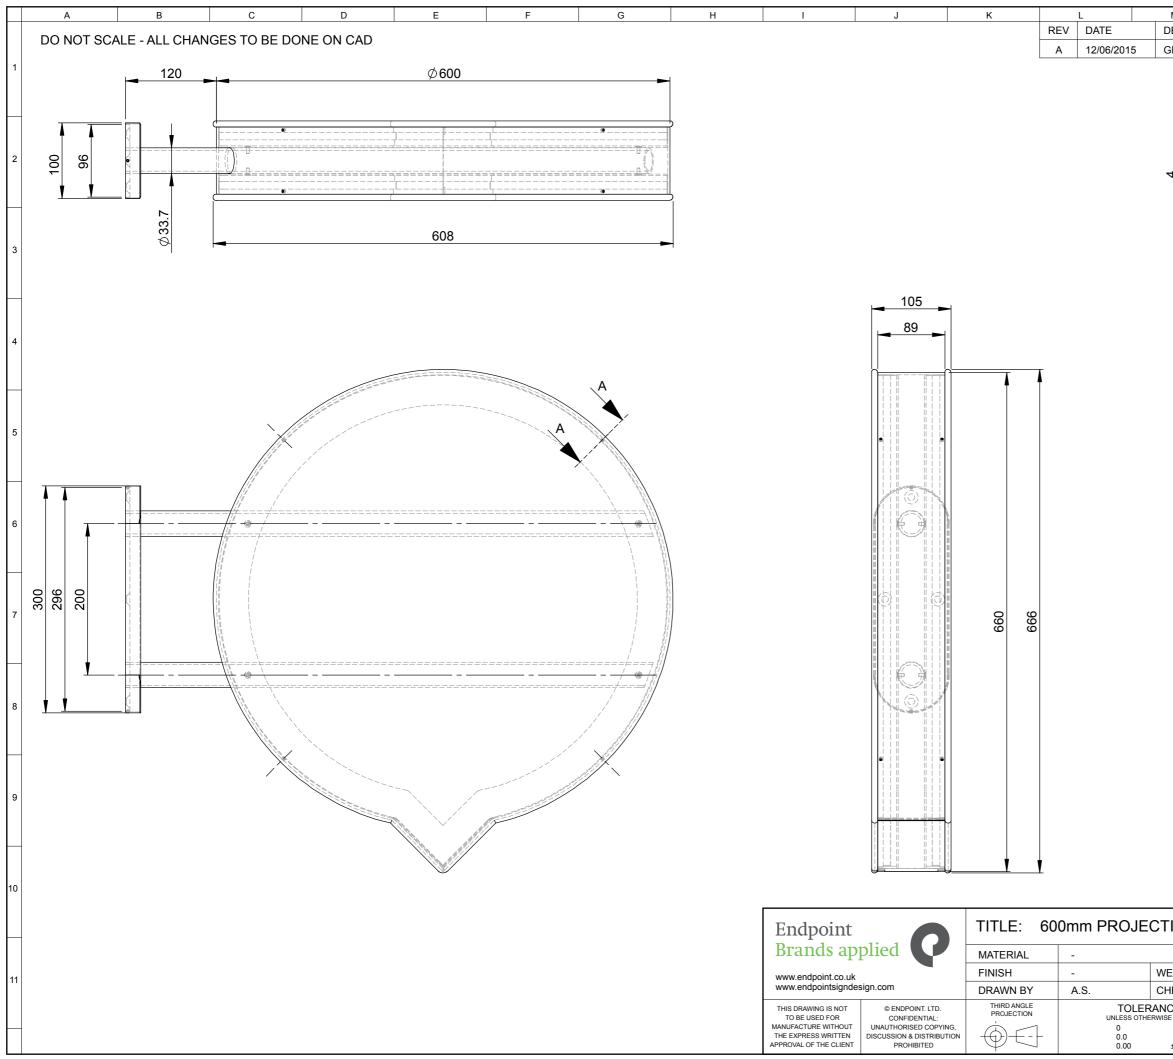
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		SHRINKAGE	-	
EIGHT	26KG	GENERAL DRAFT	-	
HECKED	CL/MA	SCALE	1:10 @ A3	
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±0.5 ±0.1 ±0.05	DRG No.	HUB-201-A	
±0.05			

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