

3 COMPARTMENT DADO TRUNKING (UPVC)

READER, DOOR RELEASE, MAG LOC AND BREAKGLASS

ISOLATOR

DATA POINT

13A TWIN SWITCHED SOCKET OUTLET

13A CLEANERS SOCKET OUTLET

FOR FIRE DAMPER AT HIGH LEVEL

UNSWITCHED FUSED SPUR

SWITCHED FUSED SPUR

UNIT IN CEILING VOID

BS4343 SOCKET OUTLET

CCTV CAMERA

TP & N DISTRIBUTION BOARD

- 150mm x 150mm x 50mm DEEP ADAPTABLE BOX AT LOW LEVEL FOR POWER & DATA LINK TO TRUNKING BELOW DESK VIA FLEXIBLE CONDUIT. ONE BOX FOR POWER & SEPARATE ONE 2. CONTRACTOR TO REFER TO LEGEND OF SYMBOLS TO UNDERSTAND
- FOR DATA WITH CONDUIT LINK TO HIGH LEVEL DISTRIBUTION
 - 3. CONTRACTOR SHALL BE RESPONSIBLE FOR THE DESIGN SUPPLY,

1. THIS DRAWING TO BE READ IN CONJUNCTION WITH THE

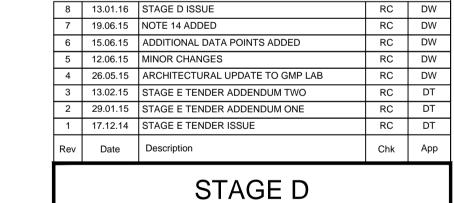
THE SYMBOLS USED ON THE DRAWING.

THE WORKS PROPOSED.

<u>NOTES</u>

SPECIFICATION.

- INSTALLATION AND COMMISSIONING OF THE ELECTRICAL SERVICES.
- 4. CONTRACTOR TO REFER TO THE ROOM DATA SHEETS FOR THE ELECTRICAL SERVICES REQUIREMENTS IN THE LAB AREAS. 5. CONTRACTOR IS TO ALLOW FOR SITE SURVEY TO INSPECT
- CONDITION OF THE EXISTING ELECTRICAL SYSTEM. 6. CONTRACTOR TO REVIEW THE RECORD DRAWINGS TO UNDERSTAND
- 7. DADO TRUNKING SHOWN IS TO BE 3 COMPARTMENT TYPE AS
- SPECIFIED.
- 8. WHERE FIXED TO DESKS DADO TRUNKING IS TO BE FIXED WITH SUITABLE BRACKETS.
- 9. FOR CIRCUIT CABLE DETAILS REFER TO DISTRIBUTION BOARD
 - SCHEDULES.
- 10. ALL LAYOUTS ARE DIAGRAMATIC. ALL PIPEWORK & TRUNKING AROUND PERIMETER TO FOLLOW INTERNAL LINE OF EXTERNAL
- 11. SETTING OUT OF VERTICAL TRUNKING/CONDUIT DROPS AND ADAPTABLE BOXES TBA ON SITE WITH ARCHITECT FOLLOWING DEMOLITION AND ENABLING WORKS.
- 12. WIFI DATA OUTLETS TO BE PROVIDED THROUGHOUT IN ACCORDANCE WITH WCL ISD SURVEY DRAWINGS.
- 13. CIRCUIT DETAILS SHOWN ARE INDICATIVE ONLY.
- 14. MECHANICAL PLANT FOR GMP LAB LOCATED IN FIRST FLOOR
- PLANTROOM. BMS CONNECTIONS MADE IN THIS AREA.
- 15. WIRING ACCESSORIES IN RADIO CHEMISTRY LAB TO BE FLUSH METAL PLATE TYPE. WITHIN SURFACE AREAS SURFACE METALCLAD WIRING ACCESSORIES TO BE USED. WHITE PLASTIC TYPE ELSEWHERE. WIRING ACCESSORY BACK BOXES WITHIN RADIO CHEMISTRY LAB TO BE SUITABLY SEALED.



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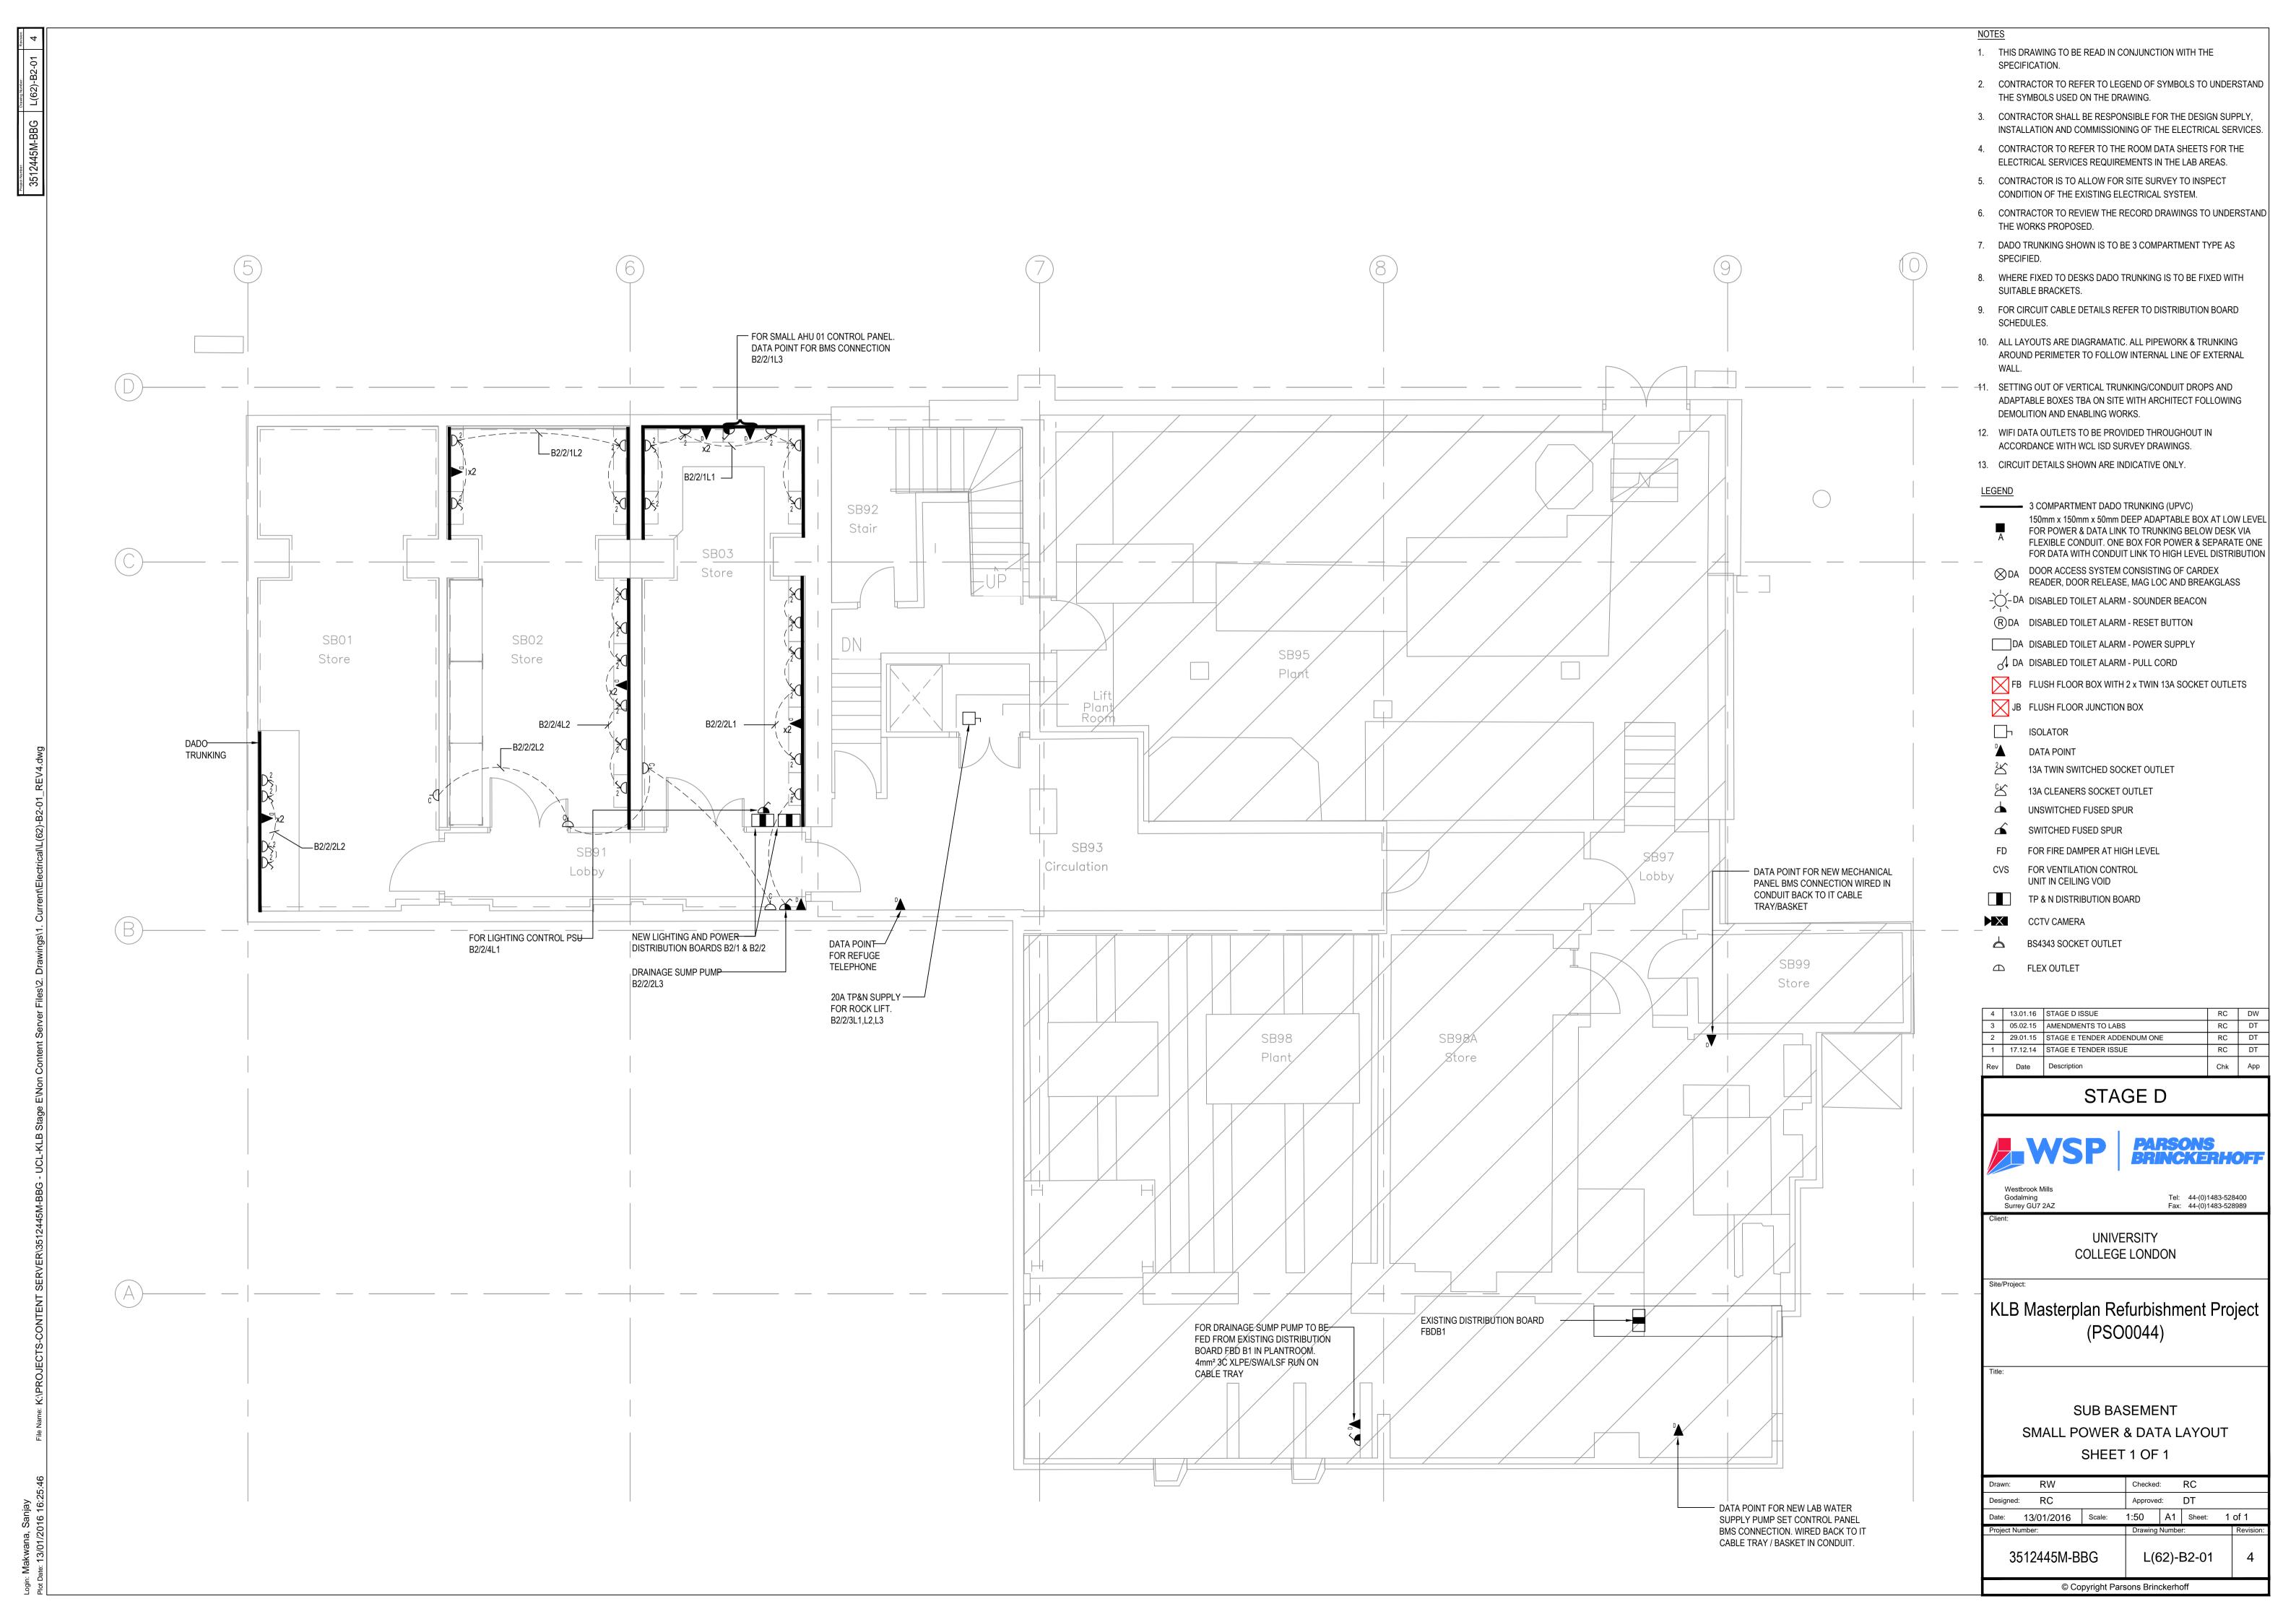
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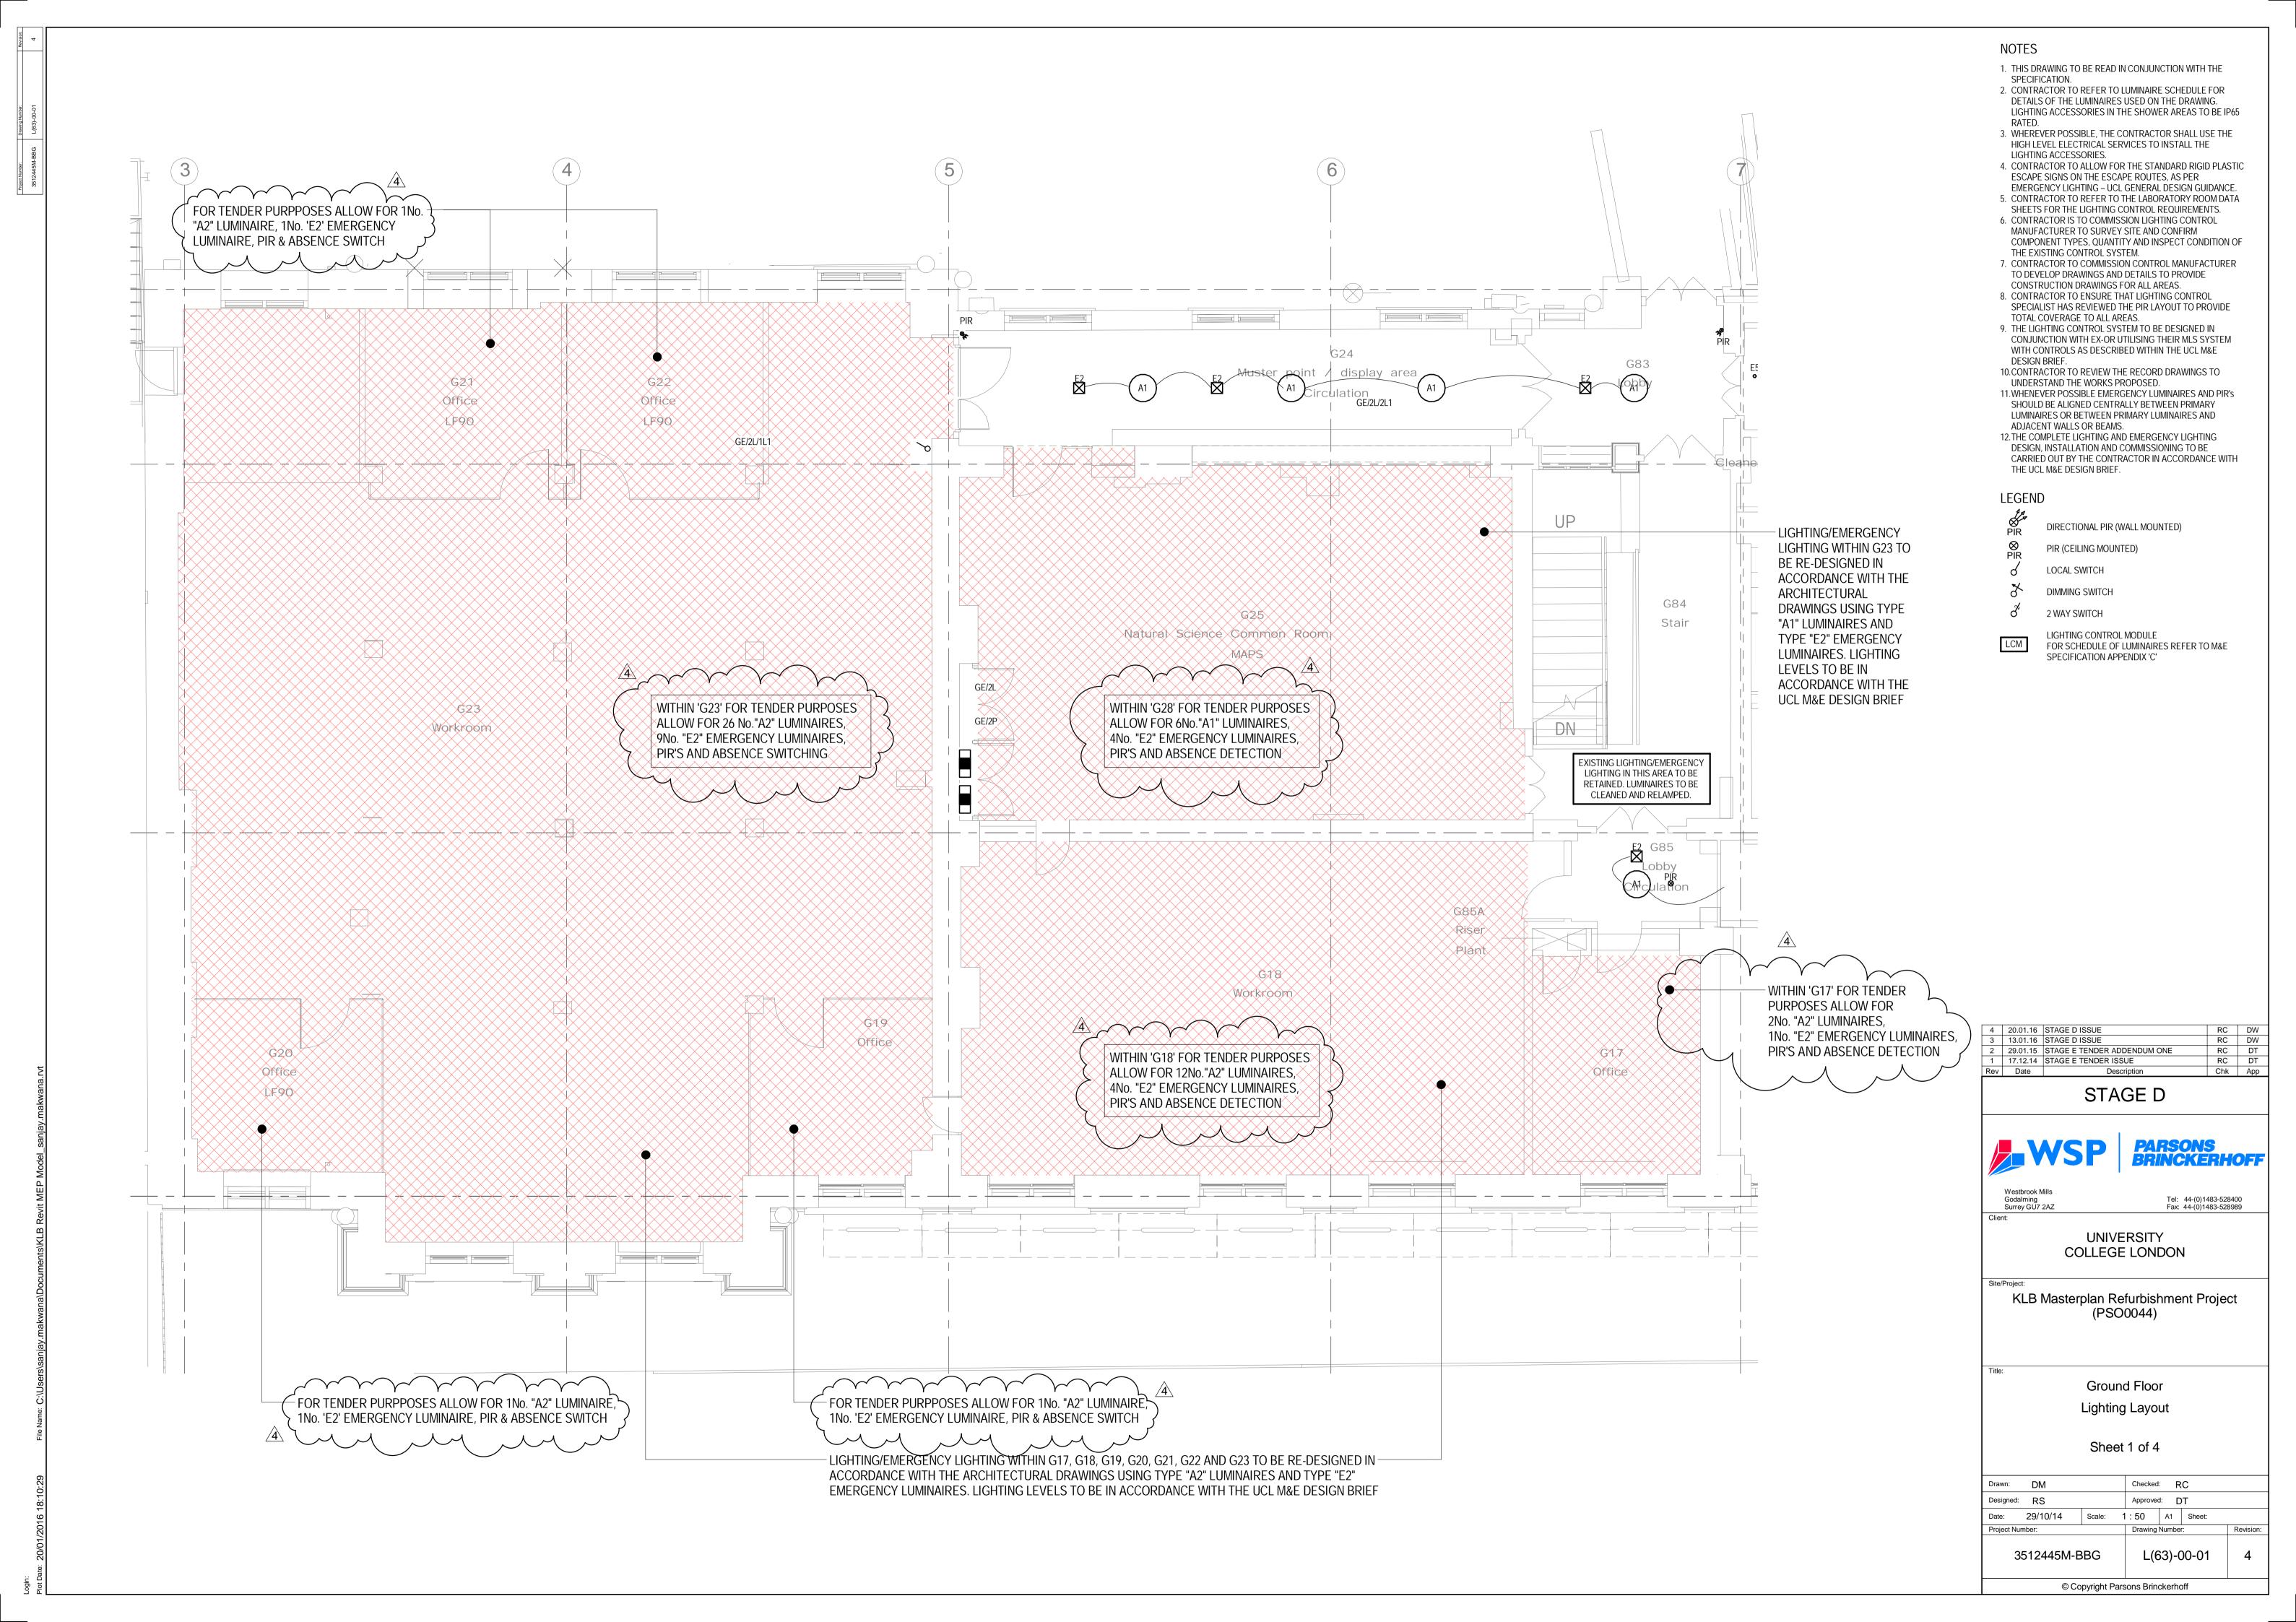
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KLB Masterplan Refurbishment Project (PSO0044)

BASEMENT SMALL POWER & DATA LAYOUT SHEET 3 OF 3

Designed: RC		Approv	ed:	DT		
Date: 13/01/20	16 Scale:	1:50	A1	Sheet:	3	of 3
Project Number:	<u>'</u>	Drawin	g Numbe	er:		Revision





- 1. THIS DRAWING TO BE READ IN CONJUNCTION WITH THE
- SPECIFICATION.

 2. CONTRACTOR TO REFER TO LUMINAIRE SCHEDULE FOR DETAILS OF THE LUMINAIRES USED ON THE DRAWING.
- LIGHTING ACCESSORIES IN THE SHOWER AREAS TO BE IP65 RATED.

 3. WHEREVER POSSIBLE, THE CONTRACTOR SHALL USE THE HIGH LEVEL ELECTRICAL SERVICES TO INSTALL THE
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 4. CONTRACTOR TO ALLOW FOR THE STANDARD RIGID PLASTIC ESCAPE SIGNS ON THE ESCAPE ROUTES, AS PER
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 5. CONTRACTOR TO REFER TO THE LABORATORY ROOM DATA SHEETS FOR THE LIGHTING CONTROL REQUIREMENTS.
- 6. CONTRACTOR IS TO COMMISSION LIGHTING CONTROL MANUFACTURER TO SURVEY SITE AND CONFIRM COMPONENT TYPES, QUANTITY AND INSPECT CONDITION OF THE EXISTING CONTROL SYSTEM.
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 9. THE LIGHTING CONTROL SYSTEM TO BE DESIGNED IN CONJUNCTION WITH EX-OR UTILISING THEIR MLS SYSTEM WITH CONTROLS AS DESCRIBED WITHIN THE UCL M&E
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- DESIGN, INSTALLATION AND COMMISSIONING TO BE CARRIED OUT BY THE CONTRACTOR IN ACCORDANCE WITH THE UCL M&E DESIGN BRIEF.

LEGEND

DIRECTIONAL PIR (WALL MOUNTED)

PIR (CEILING MOUNTED)

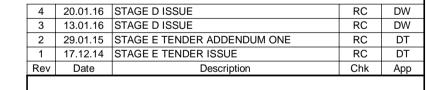
LOCAL SWITCH

DIMMING SWITCH

2 WAY SWITCH

LCM

LIGHTING CONTROL MODULE FOR SCHEDULE OF LUMINAIRES REFER TO M&E SPECIFICATION APPENDIX 'C'



STAGE D



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Godalming
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_{oject:} KI B Masterplan Refurbi

KLB Masterplan Refurbishment Project (PSO0044)

Lighting Layout

Ground Floor

Sheet 2 of 4

Drawn:	DM		Checked	R	C	
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LEGEND

DIRECTIONAL PIR (WALL MOUNTED)

PIR (CEILING MOUNTED)

LOCAL SWITCH

DIMMING SWITCH

ADJACENT WALLS OR BEAMS.

2 WAY SWITCH

LIGHTING CONTROL MODULE FOR SCHEDULE OF LUMINAIRES REFER TO M&E SPECIFICATION APPENDIX 'C'

4 20.01.16 STAGE D ISSUE 3 13.01.16 STAGE D ISSUE
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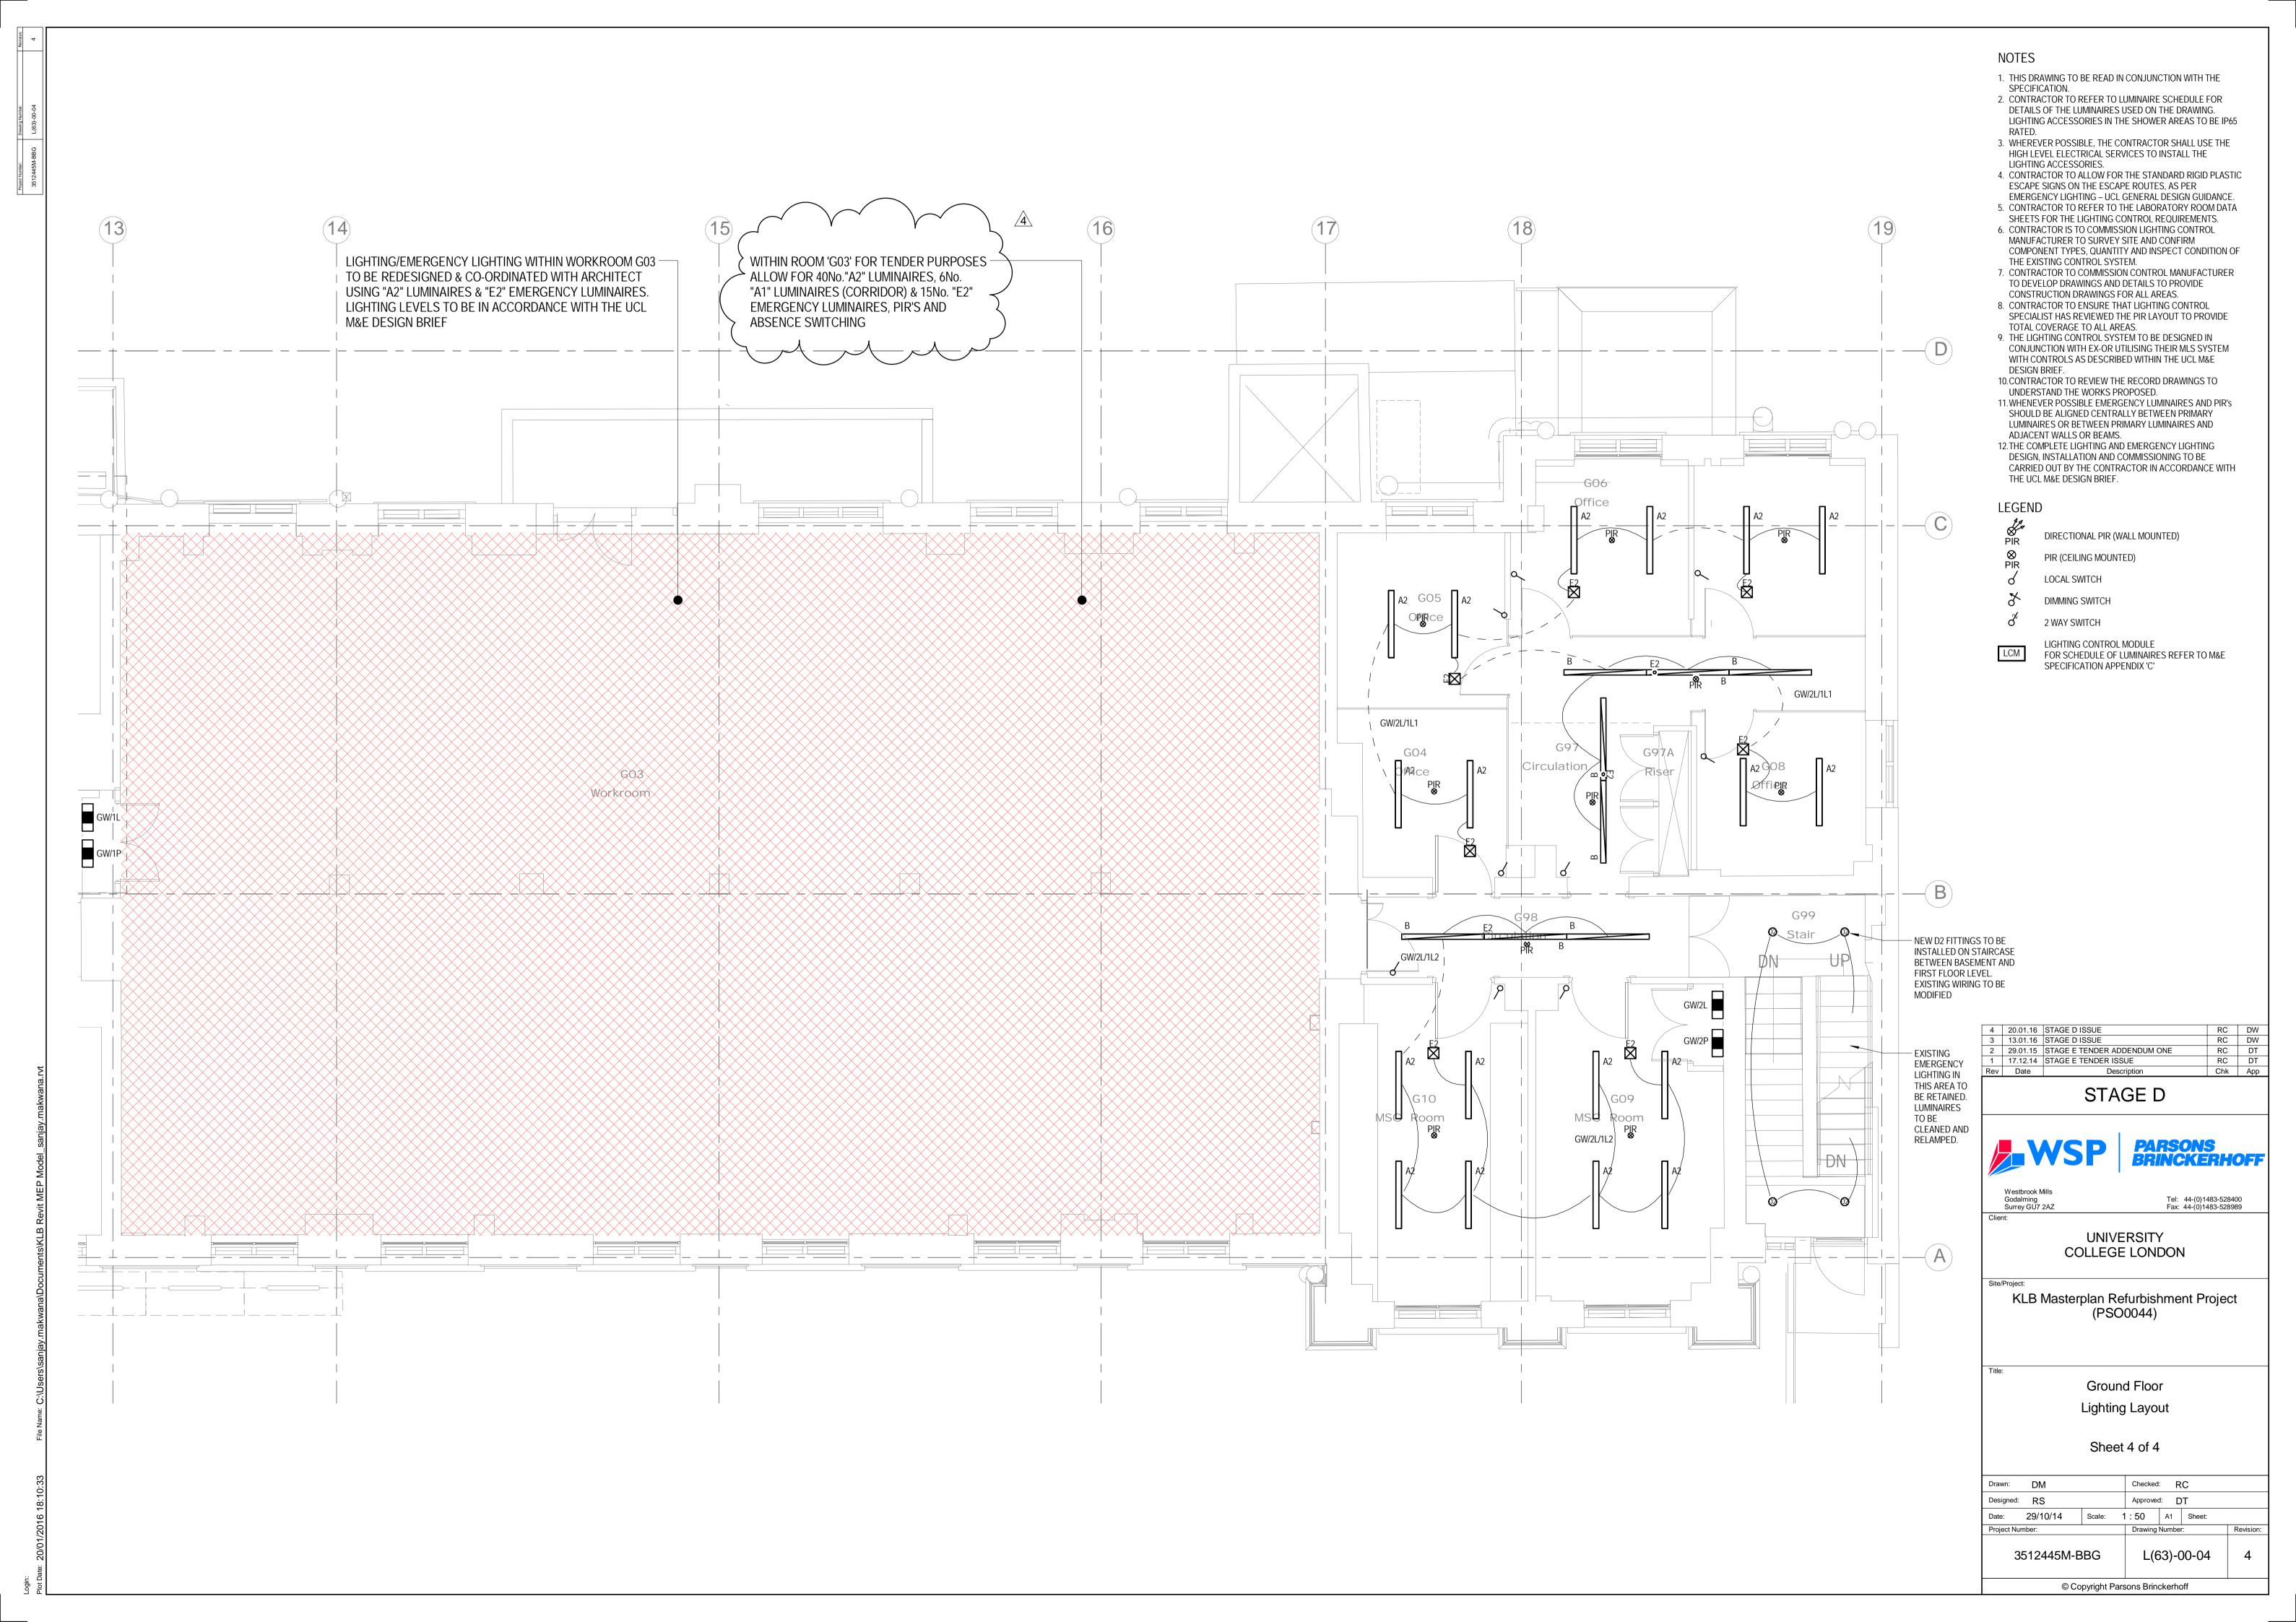
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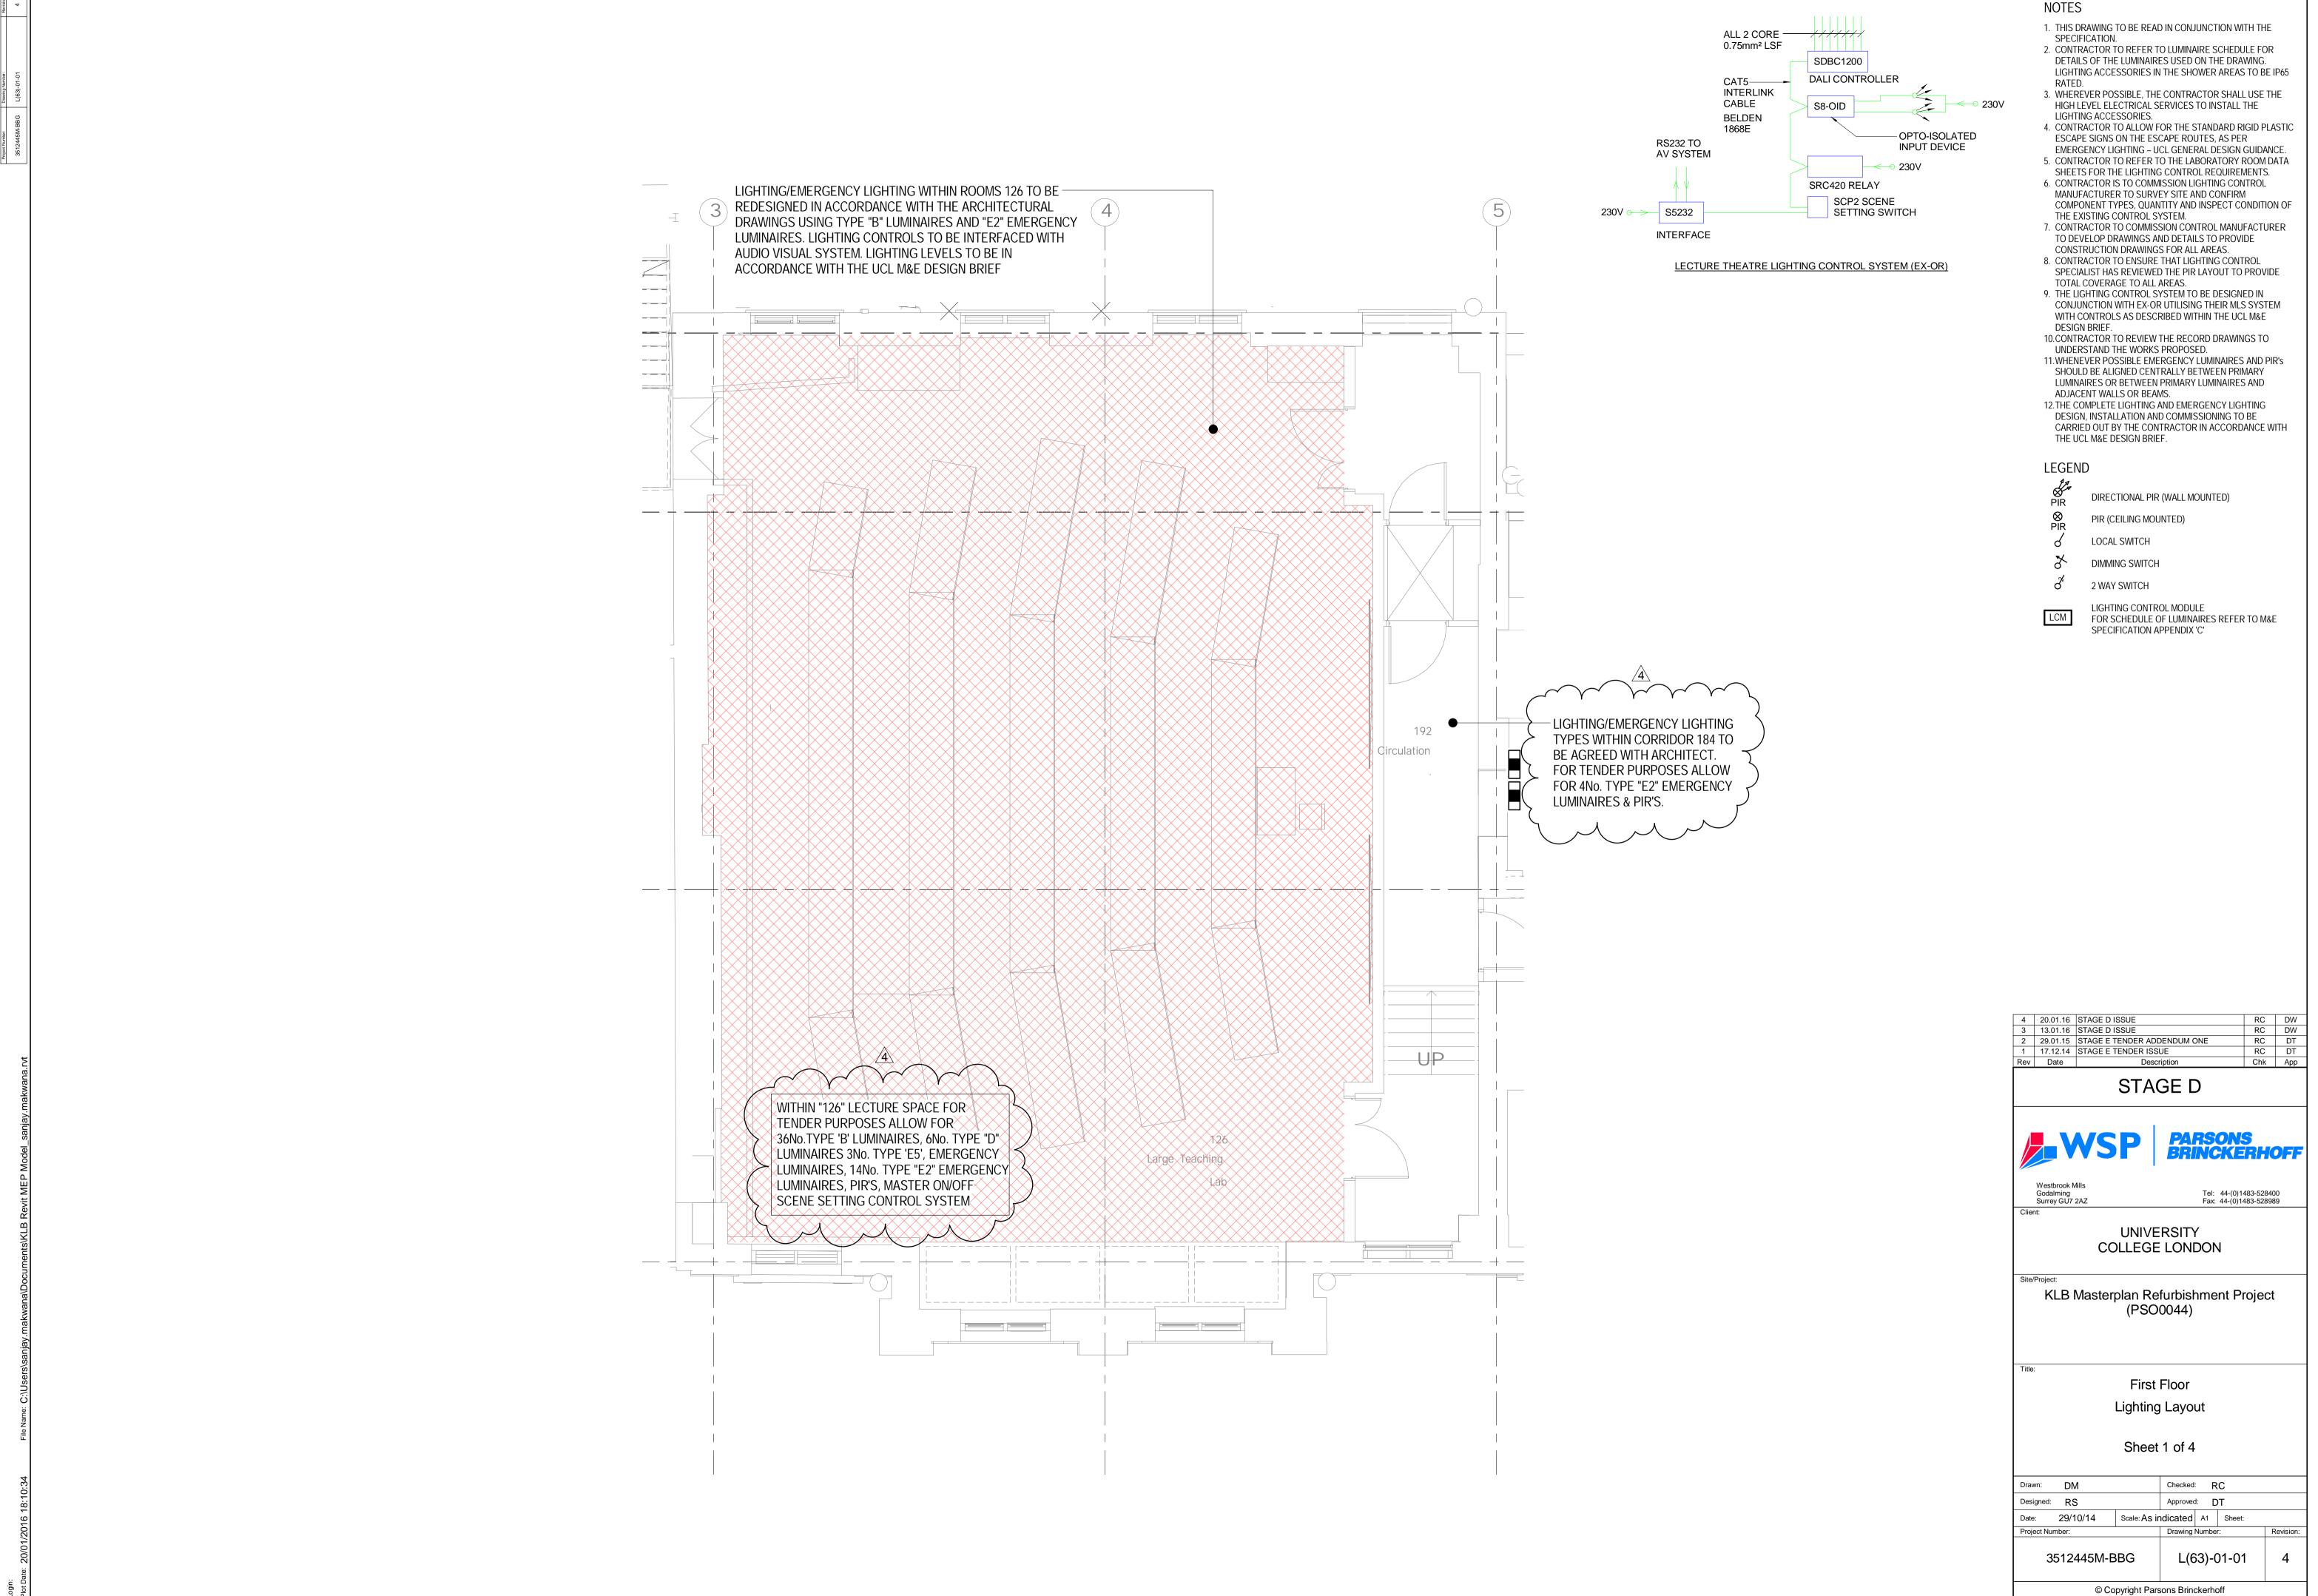
KLB Masterplan Refurbishment Project (PSO0044)

Ground Floor Lighting Layout

Sheet 3 of 4

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LEGEND

DIRECTIONAL PIR (WALL MOUNTED)

PIR (CEILING MOUNTED) LOCAL SWITCH

DIMMING SWITCH

2 WAY SWITCH

LIGHTING CONTROL MODULE

FOR SCHEDULE OF LUMINAIRES REFER TO M&E SPECIFICATION APPENDIX 'C'

5 07.04.16 STAGE D ISSUE 4 20.01.16 STAGE D ISSUE 3 13.01.16 STAGE D ISSUE 2 29.01.15 STAGE E TENDER ADDENDUM ONE 1 17.12.14 STAGE E TENDER ISSUE Chk App Rev Date STAGE D



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KLB Masterplan Refurbishment Project (PSO0044)

> First Floor Lighting Layout

Sheet 2 of 4

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LEGEND

PIR DIRECTIONAL PIR (WALL MOUNTED)

PIR (CEILING MOUNTED)

LOCAL SWITCH

DIMMING SWITCH

2 WAY SWITCH

_____ LIGHTING CO

LIGHTING CONTROL MODULE FOR SCHEDULE OF LUMINAIRES REFER TO M&E SPECIFICATION APPENDIX 'C'

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STAGE D



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Project:

KLB Masterplan Refurbishment Project (PSO0044)

First Floor Lighting Layout

Sheet 3 of 4

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THIS DRAWING TO BE READ IN CONJUNCTION WITH THE
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LIGHTING ACCESSORIES IN THE SHOWER AREAS TO BE IP65 RATED.

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LEGEND

PIR

DIRECTIONAL PIR (WALL MOUNTED)

PIR (CEILING MOUNTED)

d LOCAL SWITCH

DIMMING SWITCH

ර් 2 WAY SWITCH

LCM F

LIGHTING CONTROL MODULE
FOR SCHEDULE OF LUMINAIRES REFER TO M&E
SPECIFICATION APPENDIX 'C'

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KLB Masterplan Refurbishment Project (PSO0044)

First Floor Lighting Layout

Sheet 4 of 4

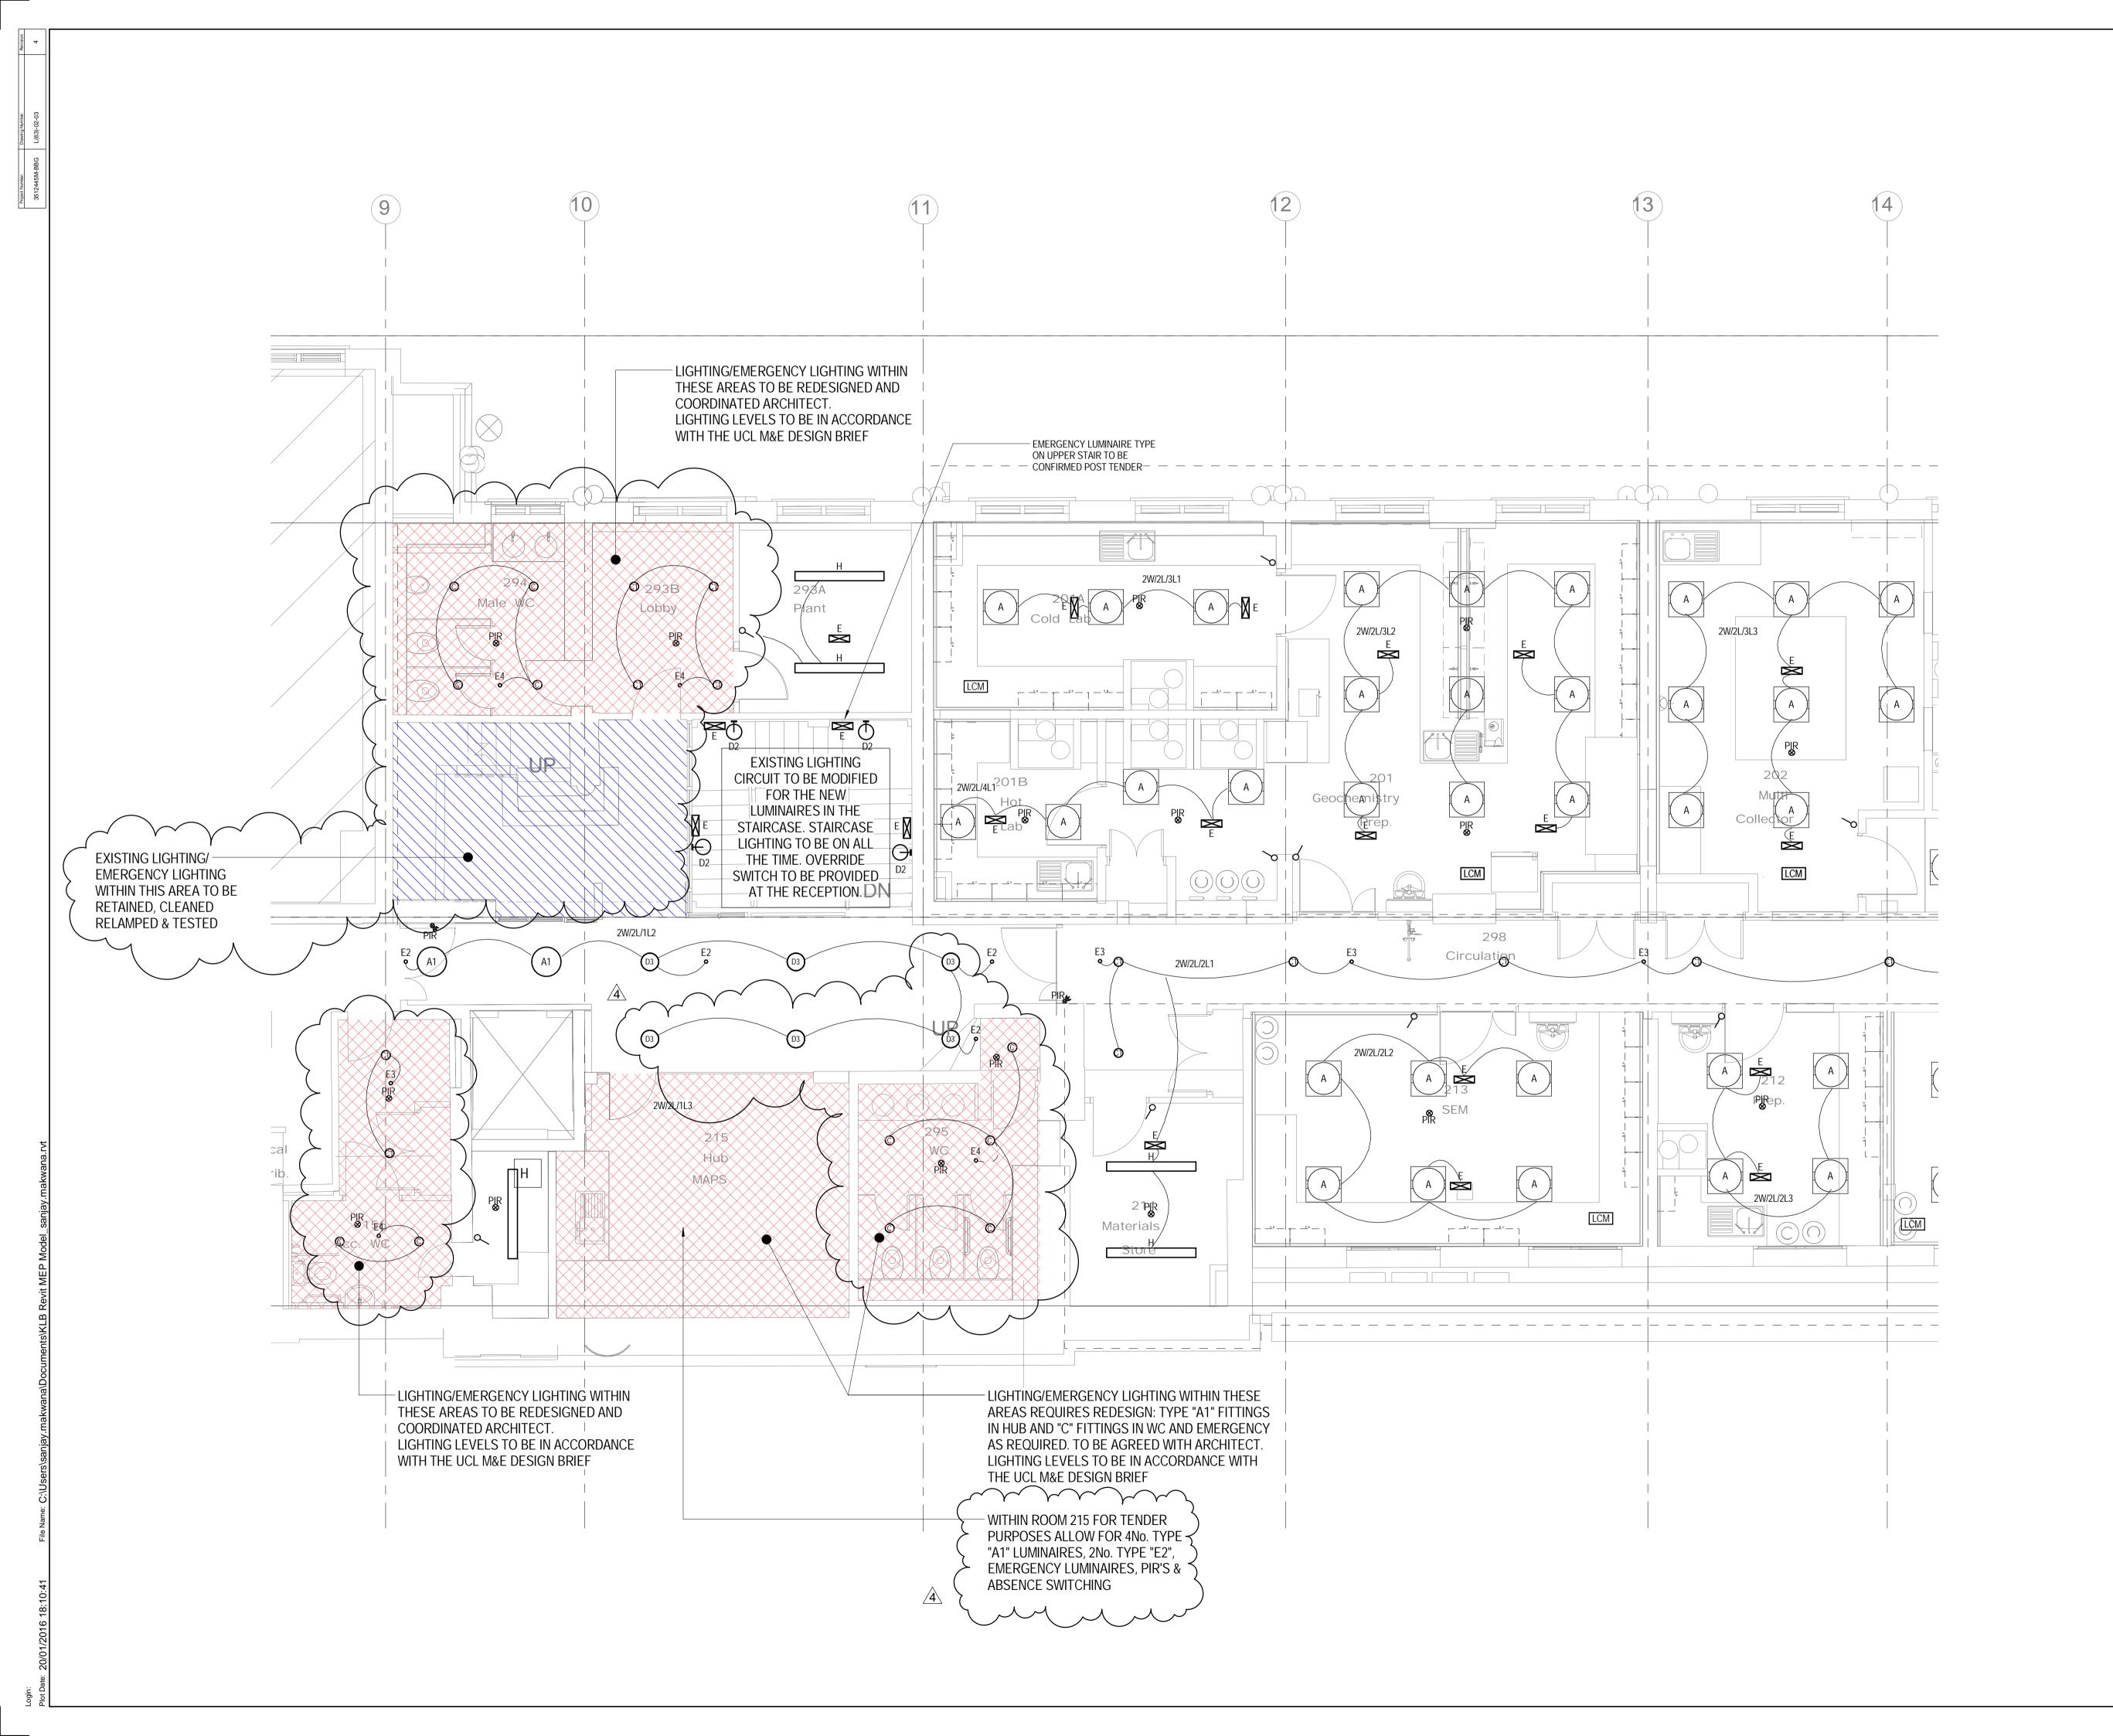
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LEGEND

DIRECTIONAL PIR (WALL MOUNTED)

PIR (CEILING MOUNTED)

LOCAL SWITCH

DIMMING SWITCH

2 WAY SWITCH

4 20.01.16 STAGE D ISSUE 3 13.01.16 STAGE D ISSUE

2 29.01.15 STAGE E TENDER ADDENDUM ONE

LIGHTING CONTROL MODULE FOR SCHEDULE OF LUMINAIRES REFER TO M&E SPECIFICATION APPENDIX 'C'



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PIR DIRECTIONAL PIR (WALL MOUNTED)

PIR (CEILING MOUNTED)

LOCAL SWITCH

DIMMING SWITCH

2 WAY SWITCH

LIGHTING CON

LIGHTING CONTROL MODULE
FOR SCHEDULE OF LUMINAIRES REFER TO M&E
SPECIFICATION APPENDIX 'C'

1		STAGE E TENDER ISSUE	RC	D
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3	13.01.16	STAGE D ISSUE	RC	D١
4	20.01.16	STAGE D ISSUE	RC	D١

STAGE D



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KLB Masterplan Refurbishment Project (PSO0044)

Second Floor Mezzanine Lighting Layout

Sheet 1 of 3

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- 10. CONTRACTOR TO REVIEW THE RECORD DRAWINGS TO UNDERSTAND THE WORKS PROPOSED. 11. WHENEVER POSSIBLE EMERGENCY LUMINAIRES AND PIR'S SHOULD BE ALIGNED CENTRALLY BETWEEN PRIMARY
- LUMINAIRES OR BETWEEN PRIMARY LUMINAIRES AND ADJACENT WALLS OR BEAMS. 12.THE COMPLETE LIGHTING AND EMERGENCY LIGHTING
- DESIGN, INSTALLATION AND COMMISSIONING TO BE CARRIED OUT BY THE CONTRACTOR IN ACCORDANCE WITH THE UCL M&E DESIGN BRIEF.

LEGEND

DIRECTIONAL PIR (WALL MOUNTED)

PIR (CEILING MOUNTED)

LOCAL SWITCH

DIMMING SWITCH

2 WAY SWITCH

LIGHTING CONTROL MODULE FOR SCHEDULE OF LUMINAIRES REFER TO M&E

SPECIFICATION APPENDIX 'C'

4	20.01.16	STAGE D ISSUE	RC
3	13.01.16	STAGE D ISSUE	RC
2	29.01.15	STAGE E TENDER ADDENDUM ONE	RC
1	17.12.14	STAGE E TENDER ISSUE	RC
Rev	Date	Description	Chk

STAGE D



Godalming Surrey GU7 2AZ

Tel: 44-(0)1483-528400 Fax: 44-(0)1483-528989

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KLB Masterplan Refurbishment Project (PSO0044)

Second Floor Mezzanine Lighting Layout

Sheet 2 of 3

Drawn:	Checked	: R	C.				
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- 1. THIS DRAWING TO BE READ IN CONJUNCTION WITH THE SPECIFICATION.
- CONTRACTOR TO REFER TO LUMINAIRE SCHEDULE FOR DETAILS OF THE LUMINAIRES USED ON THE DRAWING. LIGHTING ACCESSORIES IN THE SHOWER AREAS TO BE IP65
- LIGHTING ACCESSORIES IN THE SHOWER AREAS TO BE IP65 RATED.

 3. WHEREVER POSSIBLE, THE CONTRACTOR SHALL USE THE HIGH LEVEL ELECTRICAL SERVICES TO INSTALL THE
- LIGHTING ACCESSORIES.

 4. CONTRACTOR TO ALLOW FOR THE STANDARD RIGID PLASTIC ESCAPE SIGNS ON THE ESCAPE ROUTES, AS PER EMERGENCY LIGHTING UCL GENERAL DESIGN GUIDANCE.

 5. CONTRACTOR TO REFER TO THE LABORATORY ROOM DATA
- SHEETS FOR THE LIGHTING CONTROL REQUIREMENTS.

 6. CONTRACTOR IS TO COMMISSION LIGHTING CONTROL MANUFACTURER TO SURVEY SITE AND CONFIRM COMPONENT TYPES, QUANTITY AND INSPECT CONDITION OF THE EXISTING CONTROL SYSTEM.
- CONTRACTOR TO COMMISSION CONTROL MANUFACTURER
 TO DEVELOP DRAWINGS AND DETAILS TO PROVIDE
 CONSTRUCTION DRAWINGS FOR ALL AREAS.
 CONTRACTOR TO ENSURE THAT LIGHTING CONTROL
- SPECIALIST HAS REVIEWED THE PIR LAYOUT TO PROVIDE TOTAL COVERAGE TO ALL AREAS.

 9. THE LIGHTING CONTROL SYSTEM TO BE DESIGNED IN CONJUNCTION WITH EX-OR UTILISING THEIR MLS SYSTEM WITH CONTROLS AS DESCRIBED WITHIN THE UCL M&E
- DESIGN BRIEF.

 10. CONTRACTOR TO REVIEW THE RECORD DRAWINGS TO UNDERSTAND THE WORKS PROPOSED.

11.WHENEVER POSSIBLE EMERGENCY LUMINAIRES AND PIR'S

- SHOULD BE ALIGNED CENTRALLY BETWEEN PRIMARY LUMINAIRES OR BETWEEN PRIMARY LUMINAIRES AND ADJACENT WALLS OR BEAMS.

 12.THE COMPLETE LIGHTING AND EMERGENCY LIGHTING
- DESIGN, INSTALLATION AND COMMISSIONING TO BE CARRIED OUT BY THE CONTRACTOR IN ACCORDANCE WITH THE UCL M&E DESIGN BRIEF.

LEGEND

PIR DIRECTIONAL PIR (WALL MOUNTED)

PIR (CEILING MOUNTED)

LOCAL SWITCH

DIMMING SWITCH

2 WAY SWITCH

LIGHTIN

LIGHTING CONTROL MODULE FOR SCHEDULE OF LUMINAIRES REFER TO M&E SPECIFICATION APPENDIX 'C'

 2
 29.01.15
 STAGE E TENDER ADDENDUM ONE
 RC

 1
 17.12.14
 STAGE E TENDER ISSUE
 RC

 Rev
 Date
 Description
 Chk

STAGE D

-WSP

3 13.01.16 STAGE D ISSUE

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KLB Masterplan Refurbishment Project (PSO0044)

Second Floor Mezzanine Lighting Layout

Sheet 3 of 3

 Drawn:
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 Designed:
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 Sheet:

 Project Number:
 Drawing Number:
 Revision:

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Login:

- 1. THIS DRAWING TO BE READ IN CONJUNCTION WITH THE SPECIFICATION.
- 2. CONTRACTOR TO REFER TO LUMINAIRE SCHEDULE FOR DETAILS OF THE LUMINAIRES USED ON THE DRAWING. LIGHTING ACCESSORIES IN THE SHOWER AREAS TO BE IP65 RATED.
- RATED.

 3. WHEREVER POSSIBLE, THE CONTRACTOR SHALL USE THE HIGH LEVEL ELECTRICAL SERVICES TO INSTALL THE
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LEGEND

Ø PIR ⊗

DIRECTIONAL PIR (WALL MOUNTED)

PIR (CEILING MOUNTED)

LOCAL SWITCH

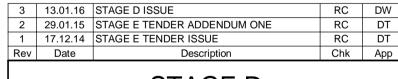
DIMMING SWITCH

2 WAY SWITCH

LIGHTING

LCM

LIGHTING CONTROL MODULE
FOR SCHEDULE OF LUMINAIRES REFER TO M&E
SPECIFICATION APPENDIX 'C'



STAGE D



Westbrook Mills
Godalming
Tel: 44-(0)1483-528400
Surrey GU7 2AZ
Fax: 44-(0)1483-528989

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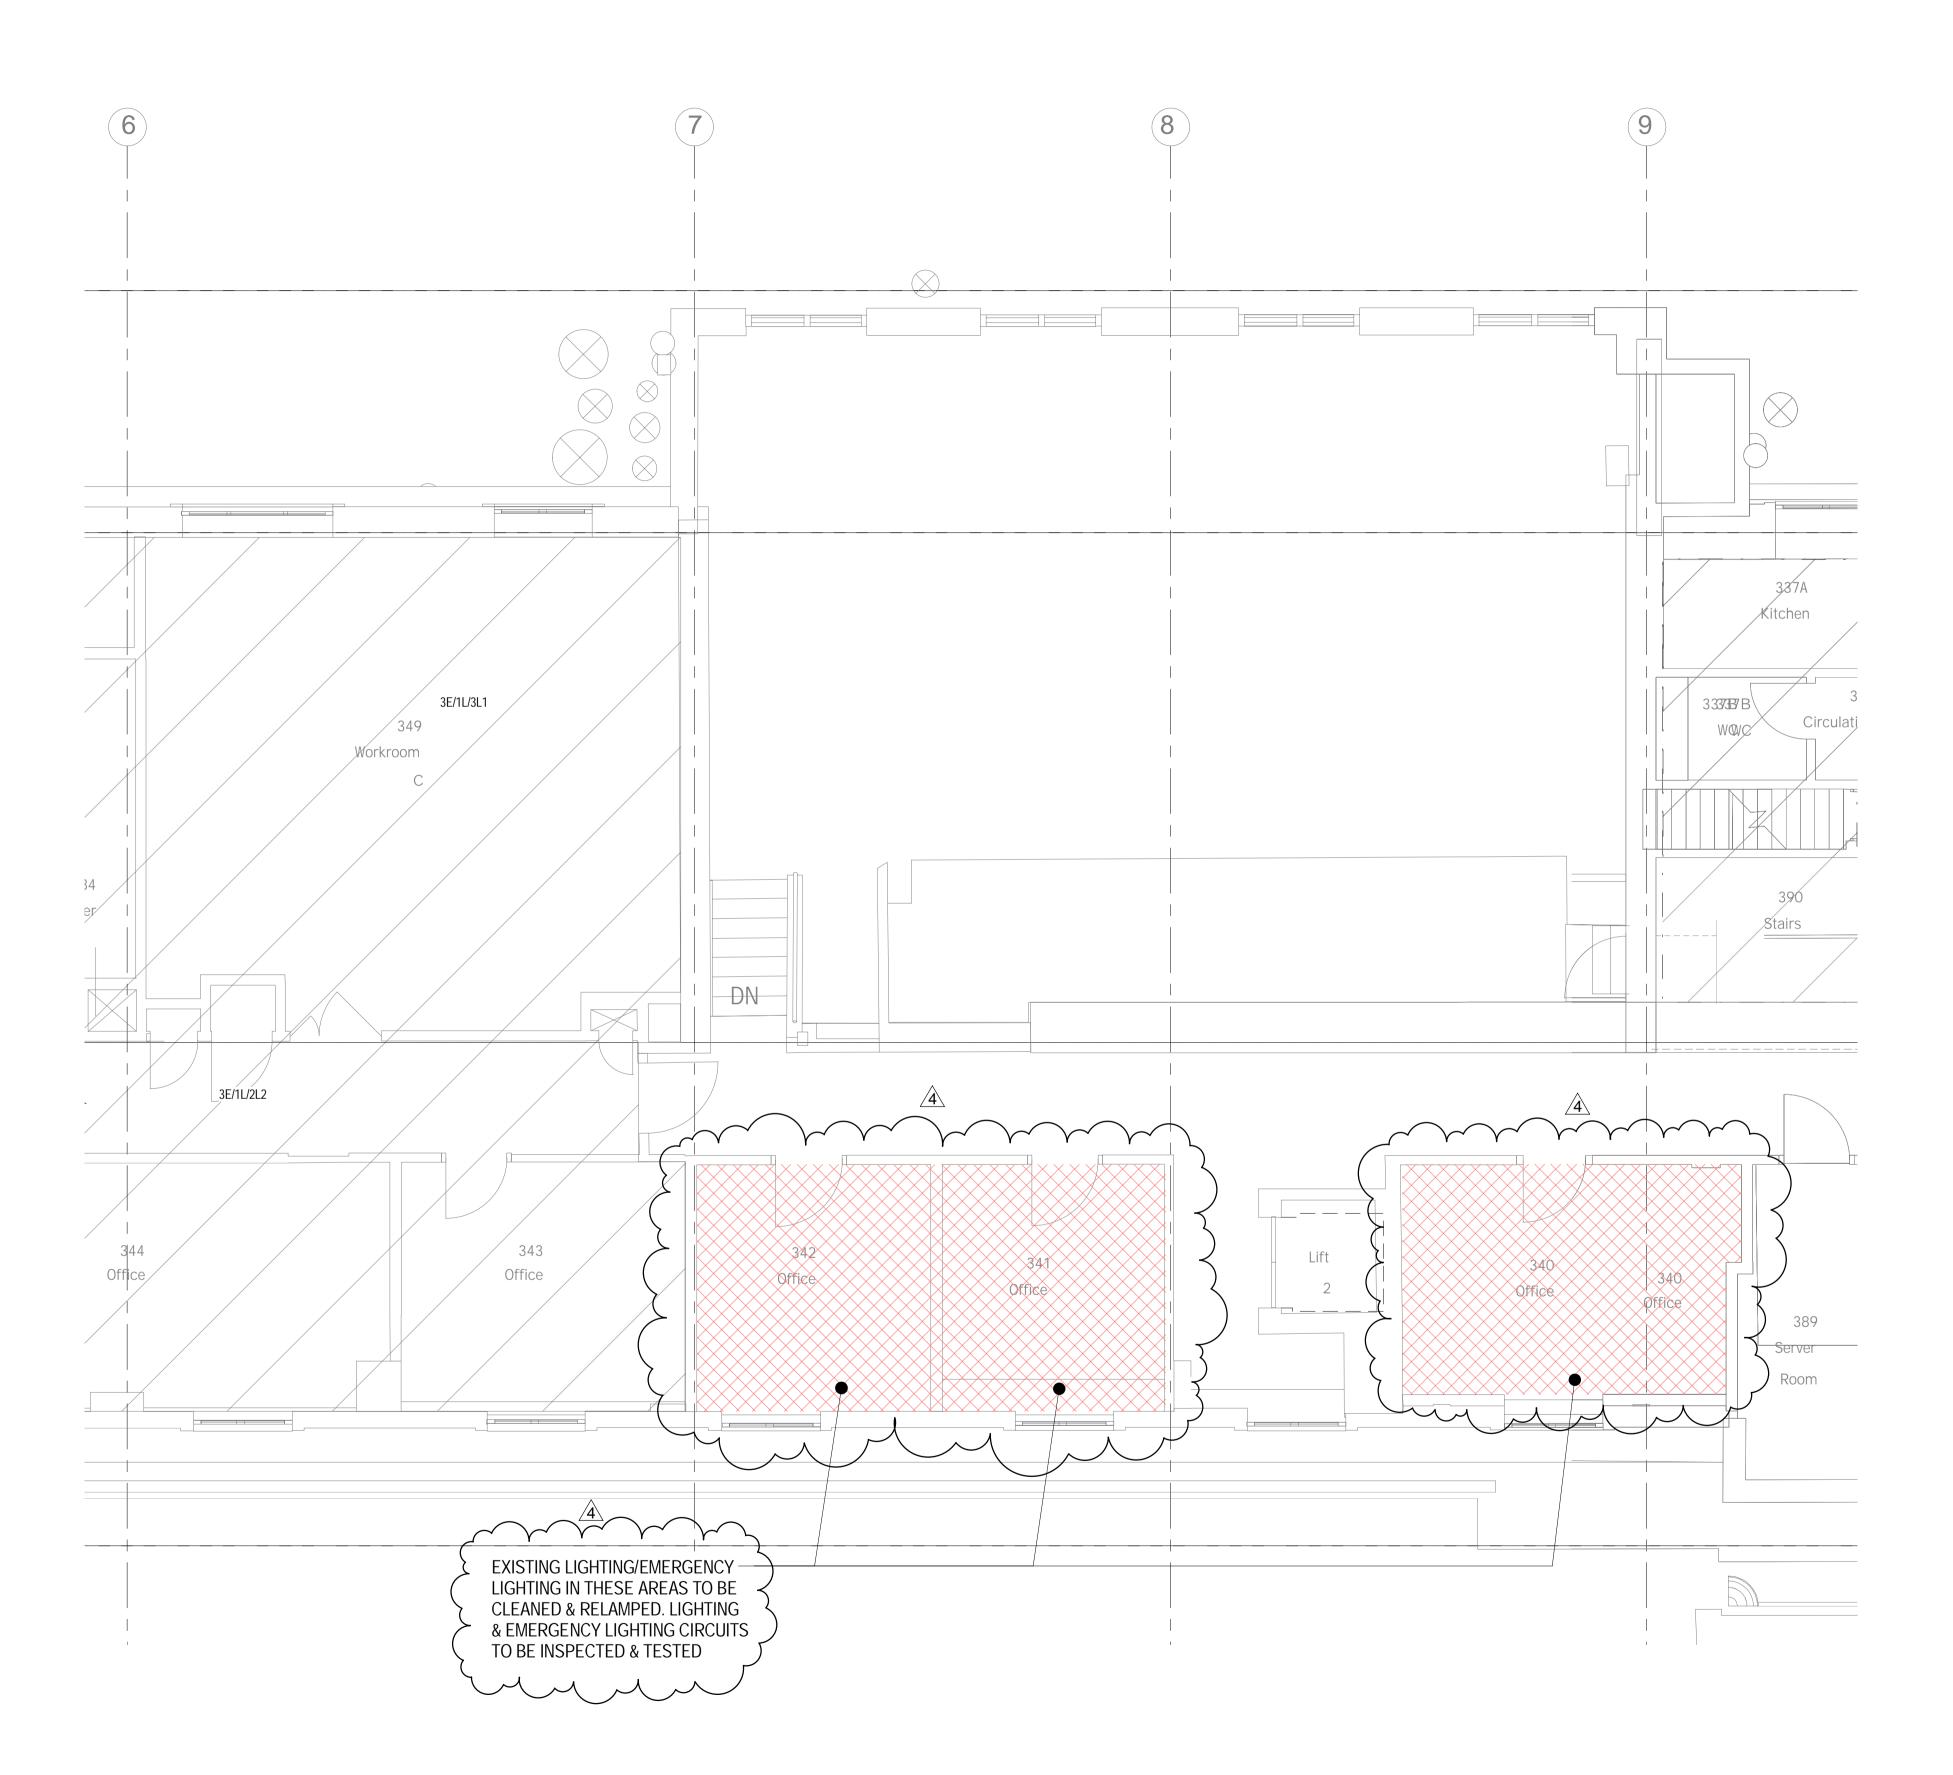
KLB Masterplan Refurbishment Project (PSO0044)

Third Floor Lighting Layout

Sheet 1 of 4

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Designed: RS Approved: DT								
Date: 29/10/14	Scale: 1	: 50	A1	Sheet:				
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LUMINAIRES OR BETWEEN PRIMARY LUMINAIRES AND

LEGEND

DIRECTIONAL PIR (WALL MOUNTED)

PIR (CEILING MOUNTED)

THE UCL M&E DESIGN BRIEF.

LOCAL SWITCH

DIMMING SWITCH

2 WAY SWITCH

LIGHTING CONTROL MODULE FOR SCHEDULE OF LUMINAIRES REFER TO M&E SPECIFICATION APPENDIX 'C'

4	20.04.40	CTACE DICCUE	DC	DIM
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3	13.01.16	STAGE D ISSUE	RC	DW
2	29.01.15	STAGE E TENDER ADDENDUM ONE	RC	DT
1	17.12.14	STAGE E TENDER ISSUE	RC	DT
Rev	Date	Description	Chk	App

STAGE D



Westbrook Mills Godalming Surrey GU7 2AZ

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KLB Masterplan Refurbishment Project (PSO0044)

Third Floor Lighting Layout

Sheet 2 of 4

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LEGEND

DIRECTIONAL PIR (WALL MOUNTED)

PIR (CEILING MOUNTED)

LOCAL SWITCH

DIMMING SWITCH

2 WAY SWITCH

3 13.01.16 STAGE D ISSUE

LIGHTING CONTROL MODULE FOR SCHEDULE OF LUMINAIRES REFER TO M&E

SPECIFICATION APPENDIX 'C'



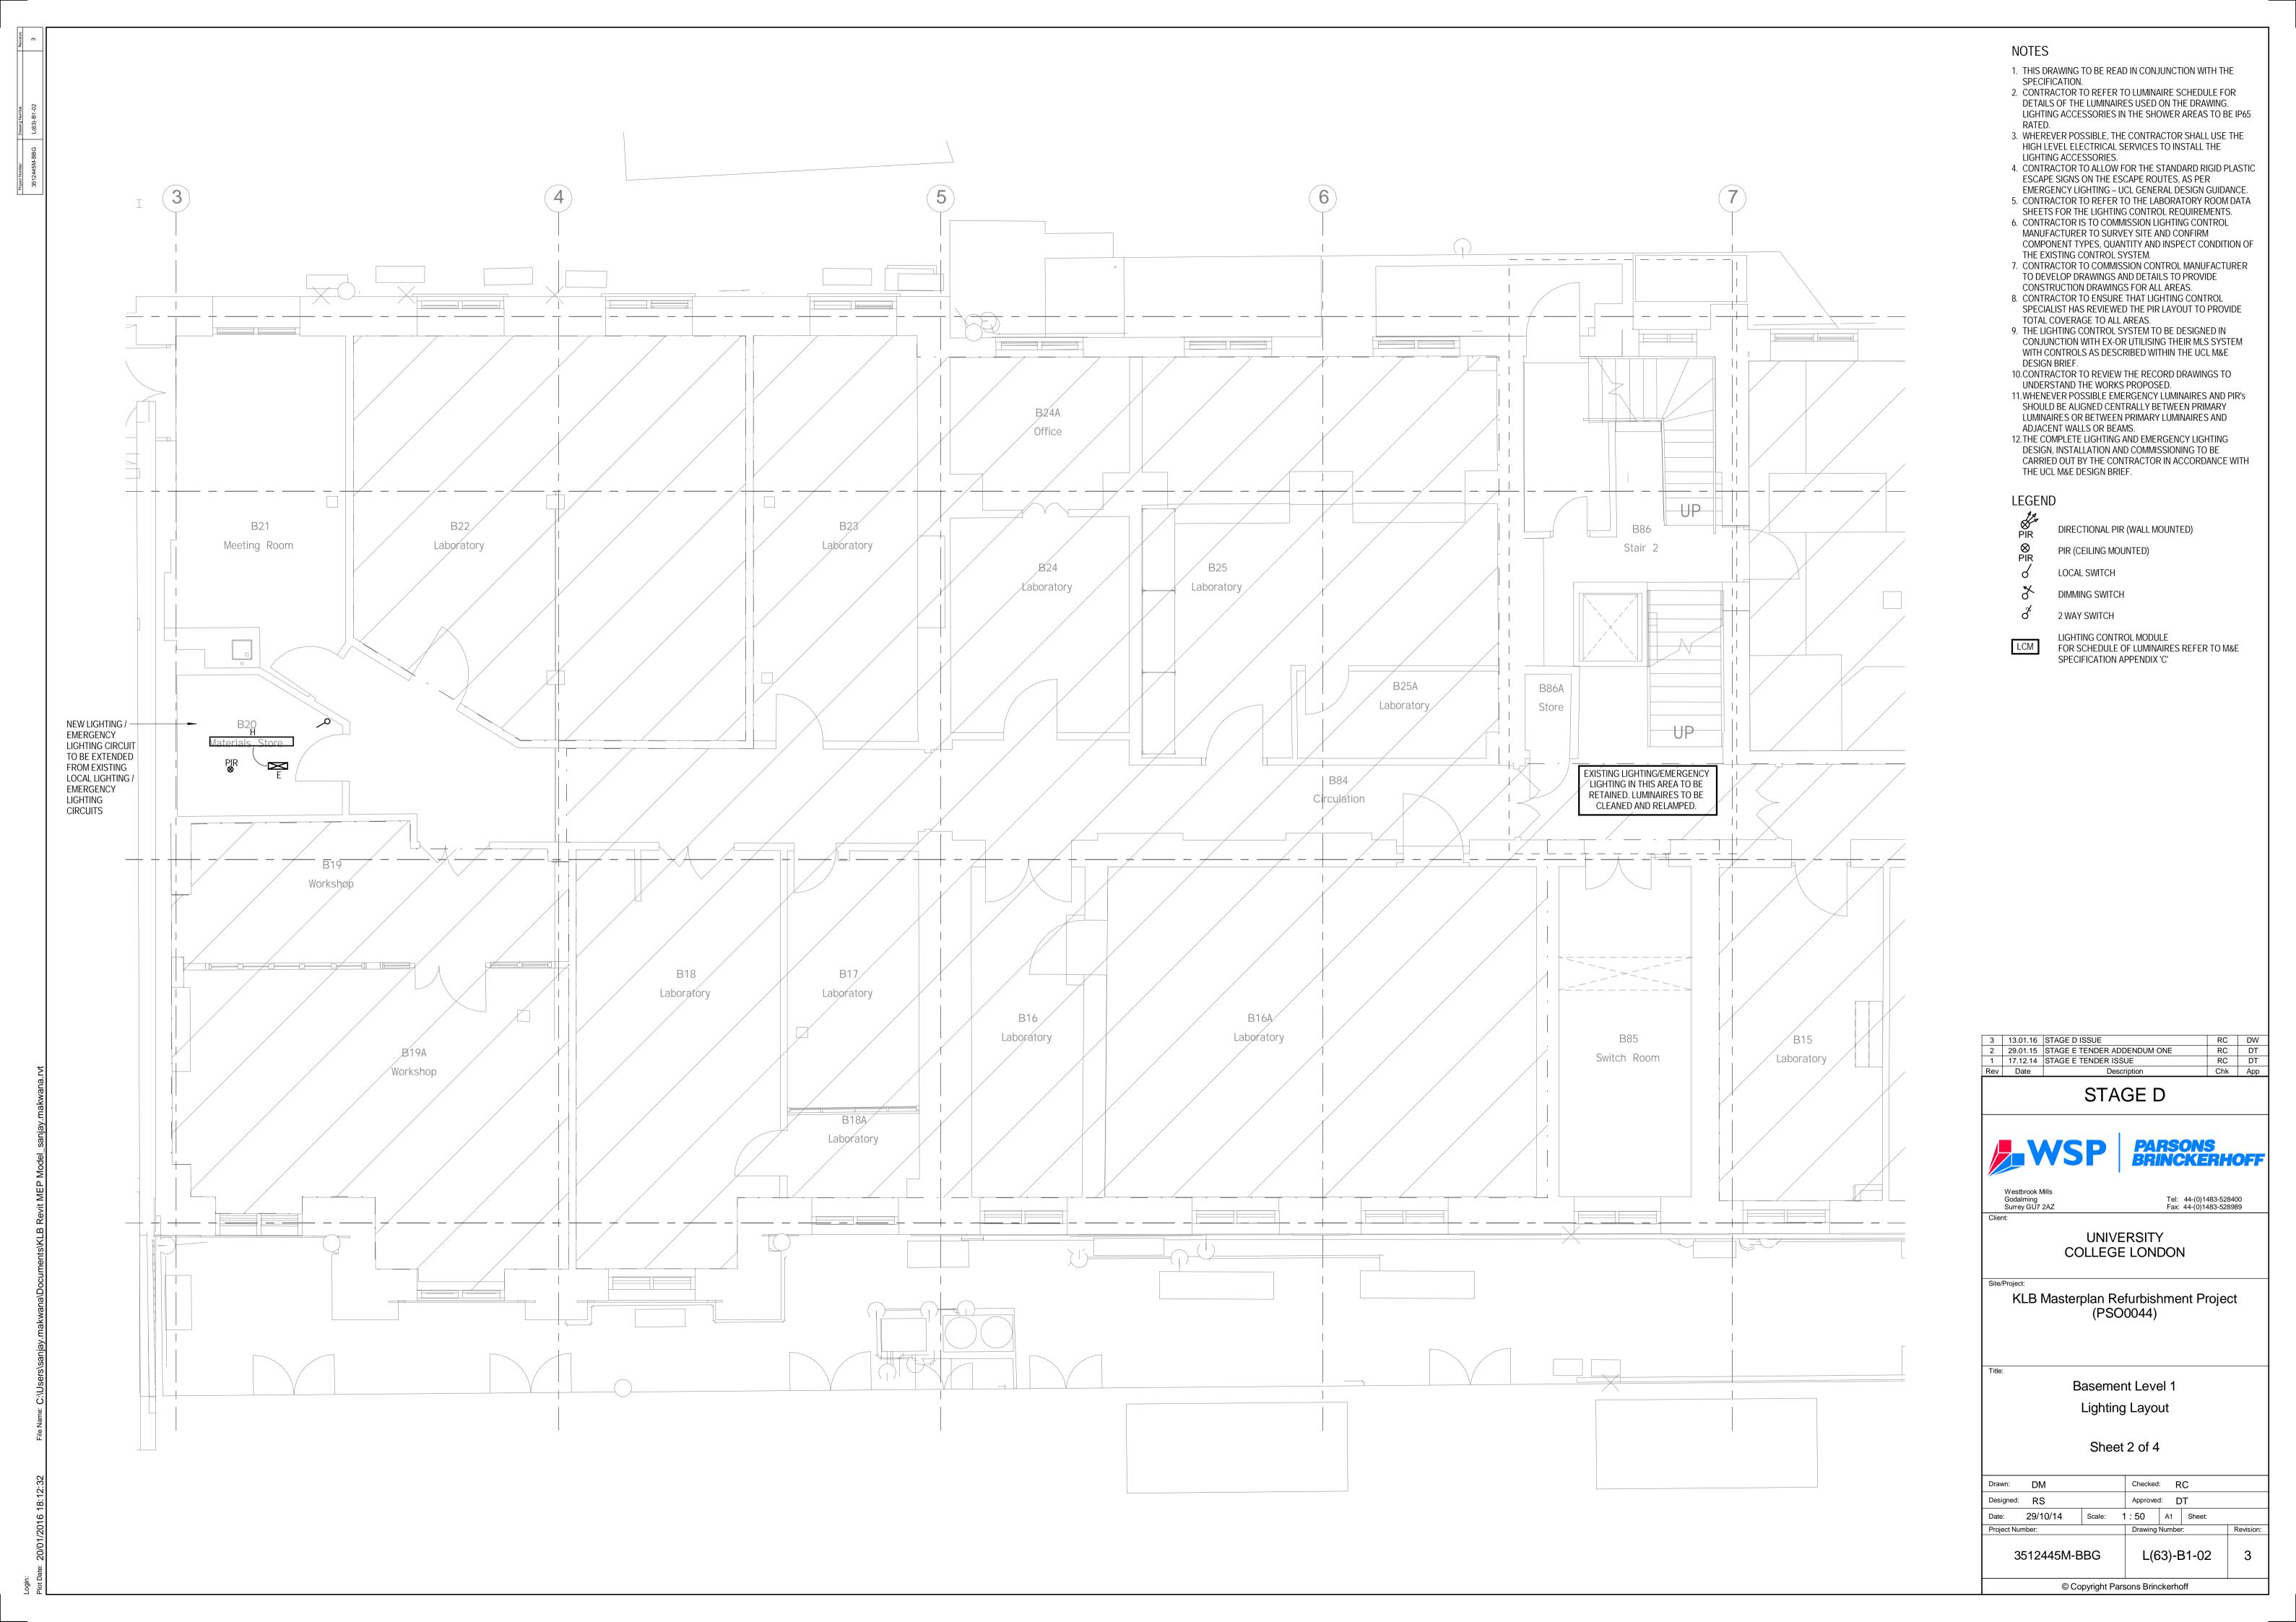
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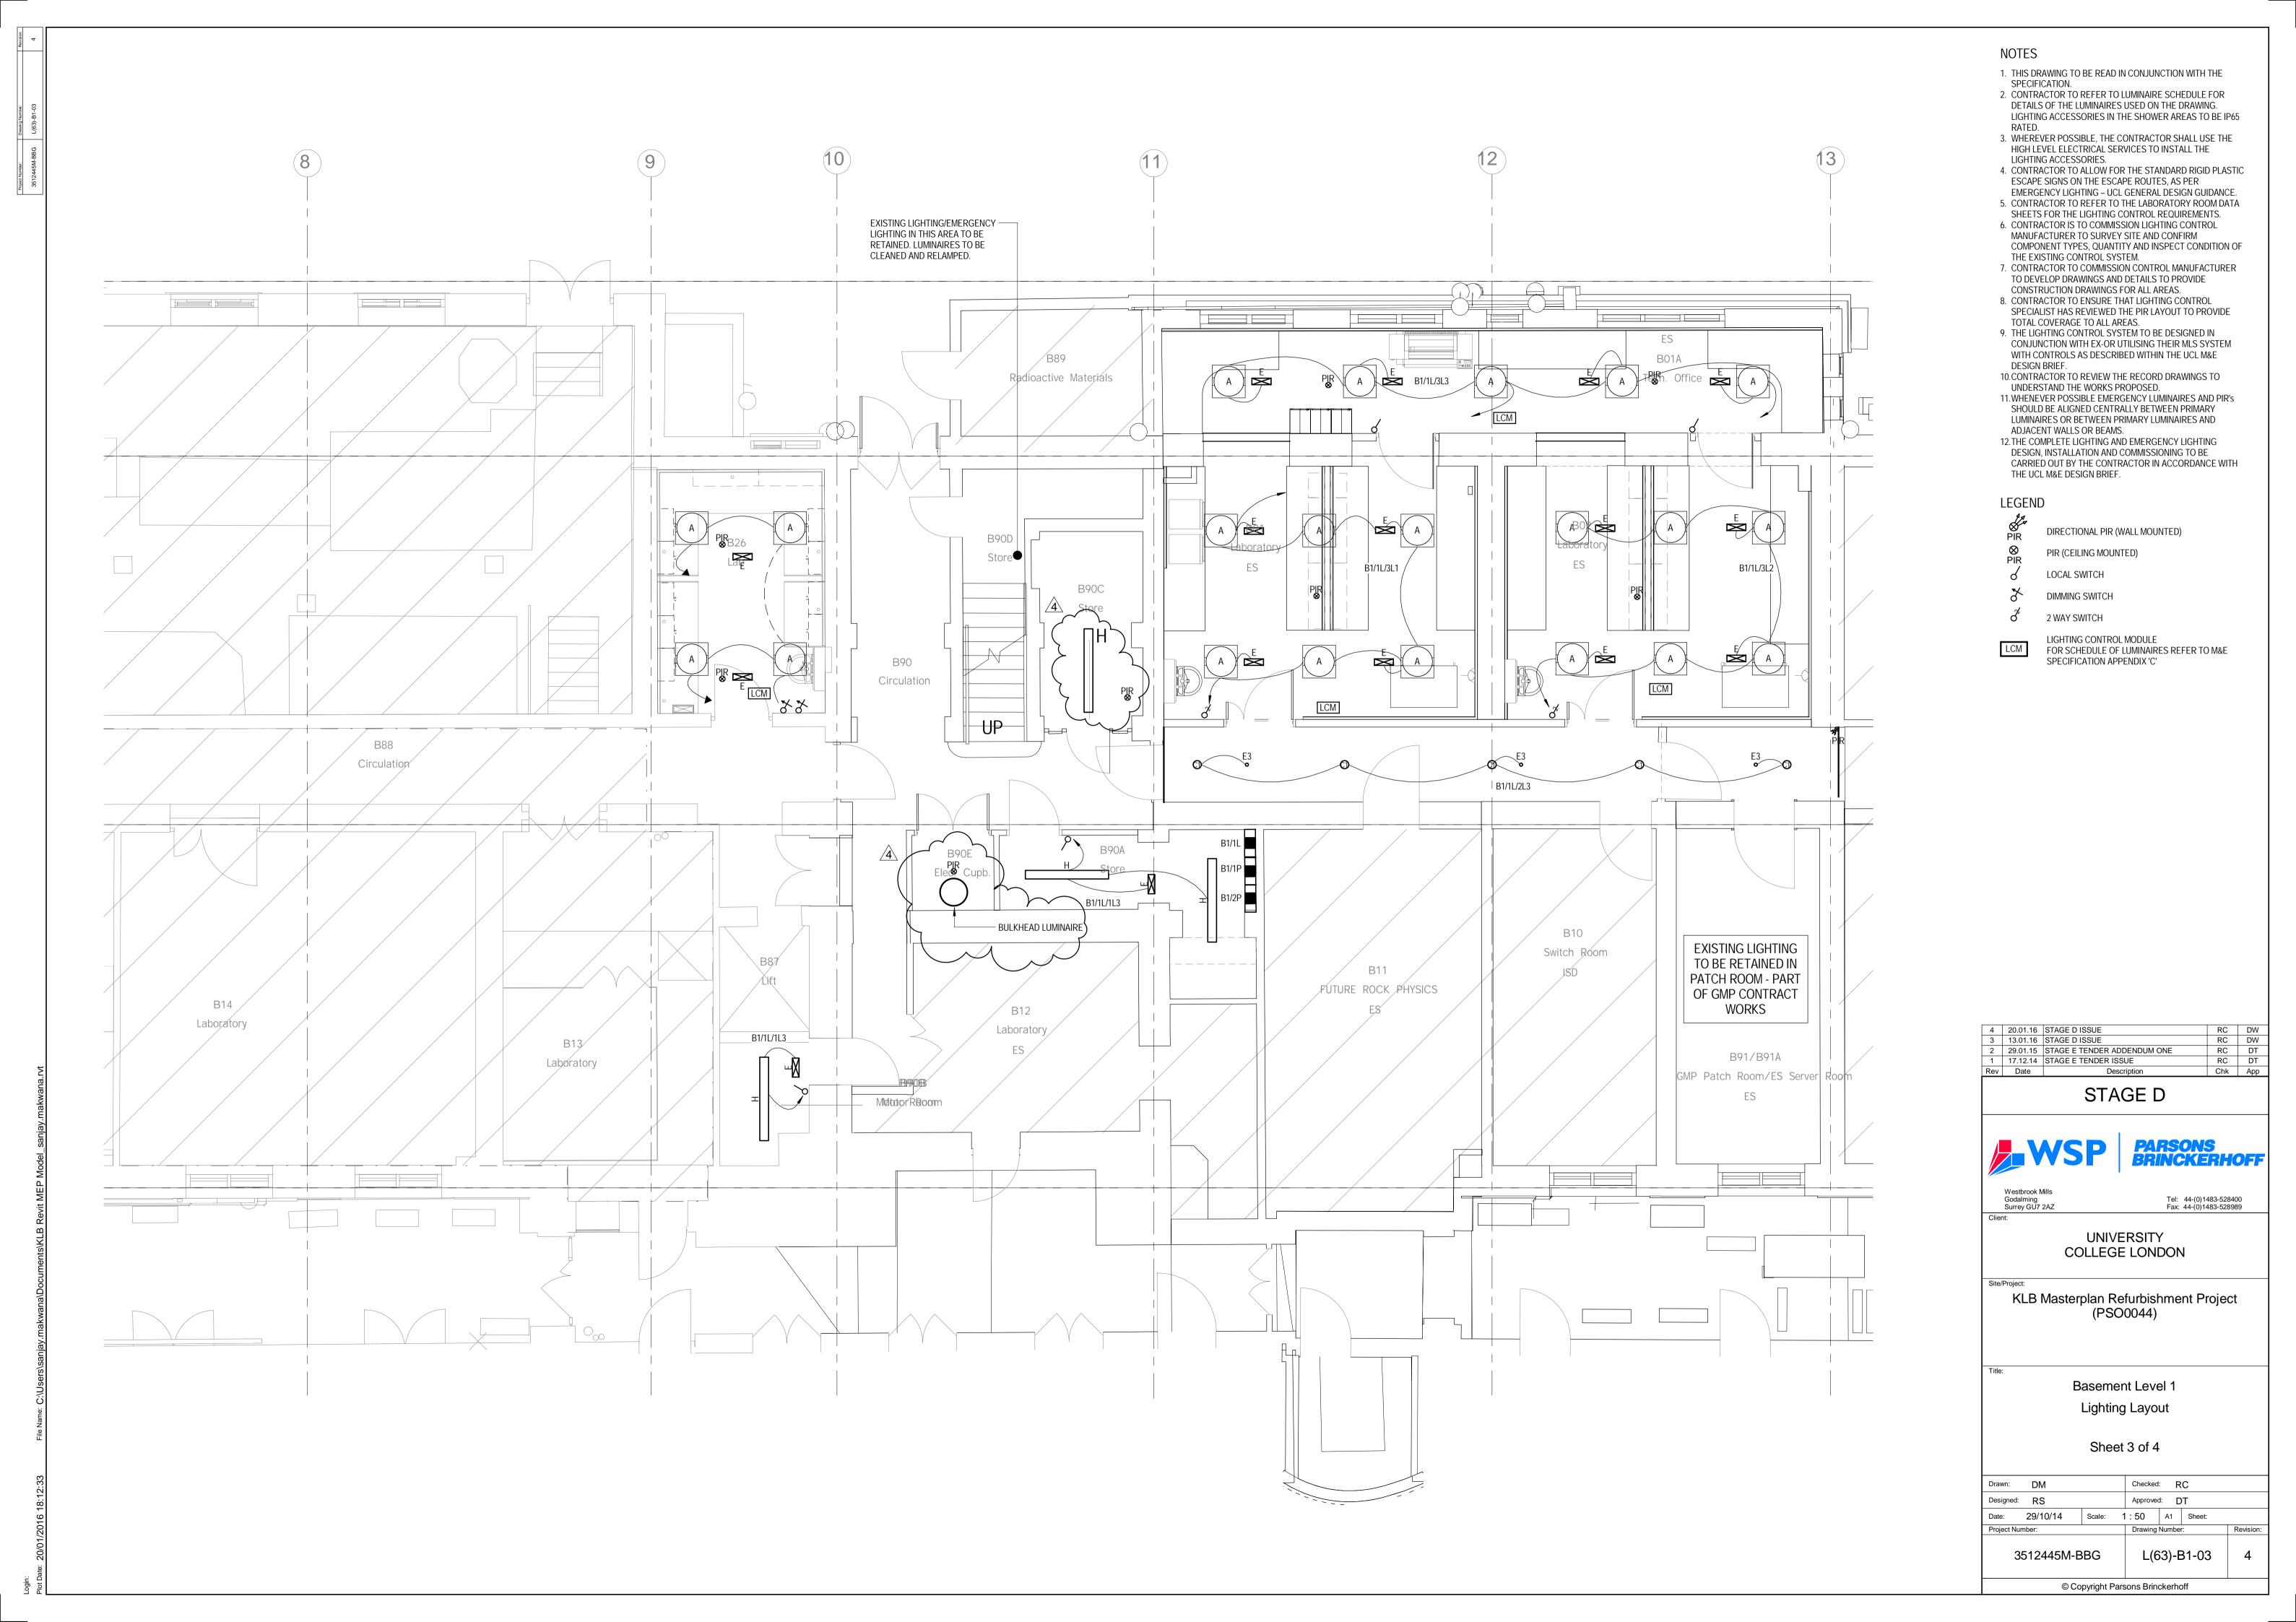
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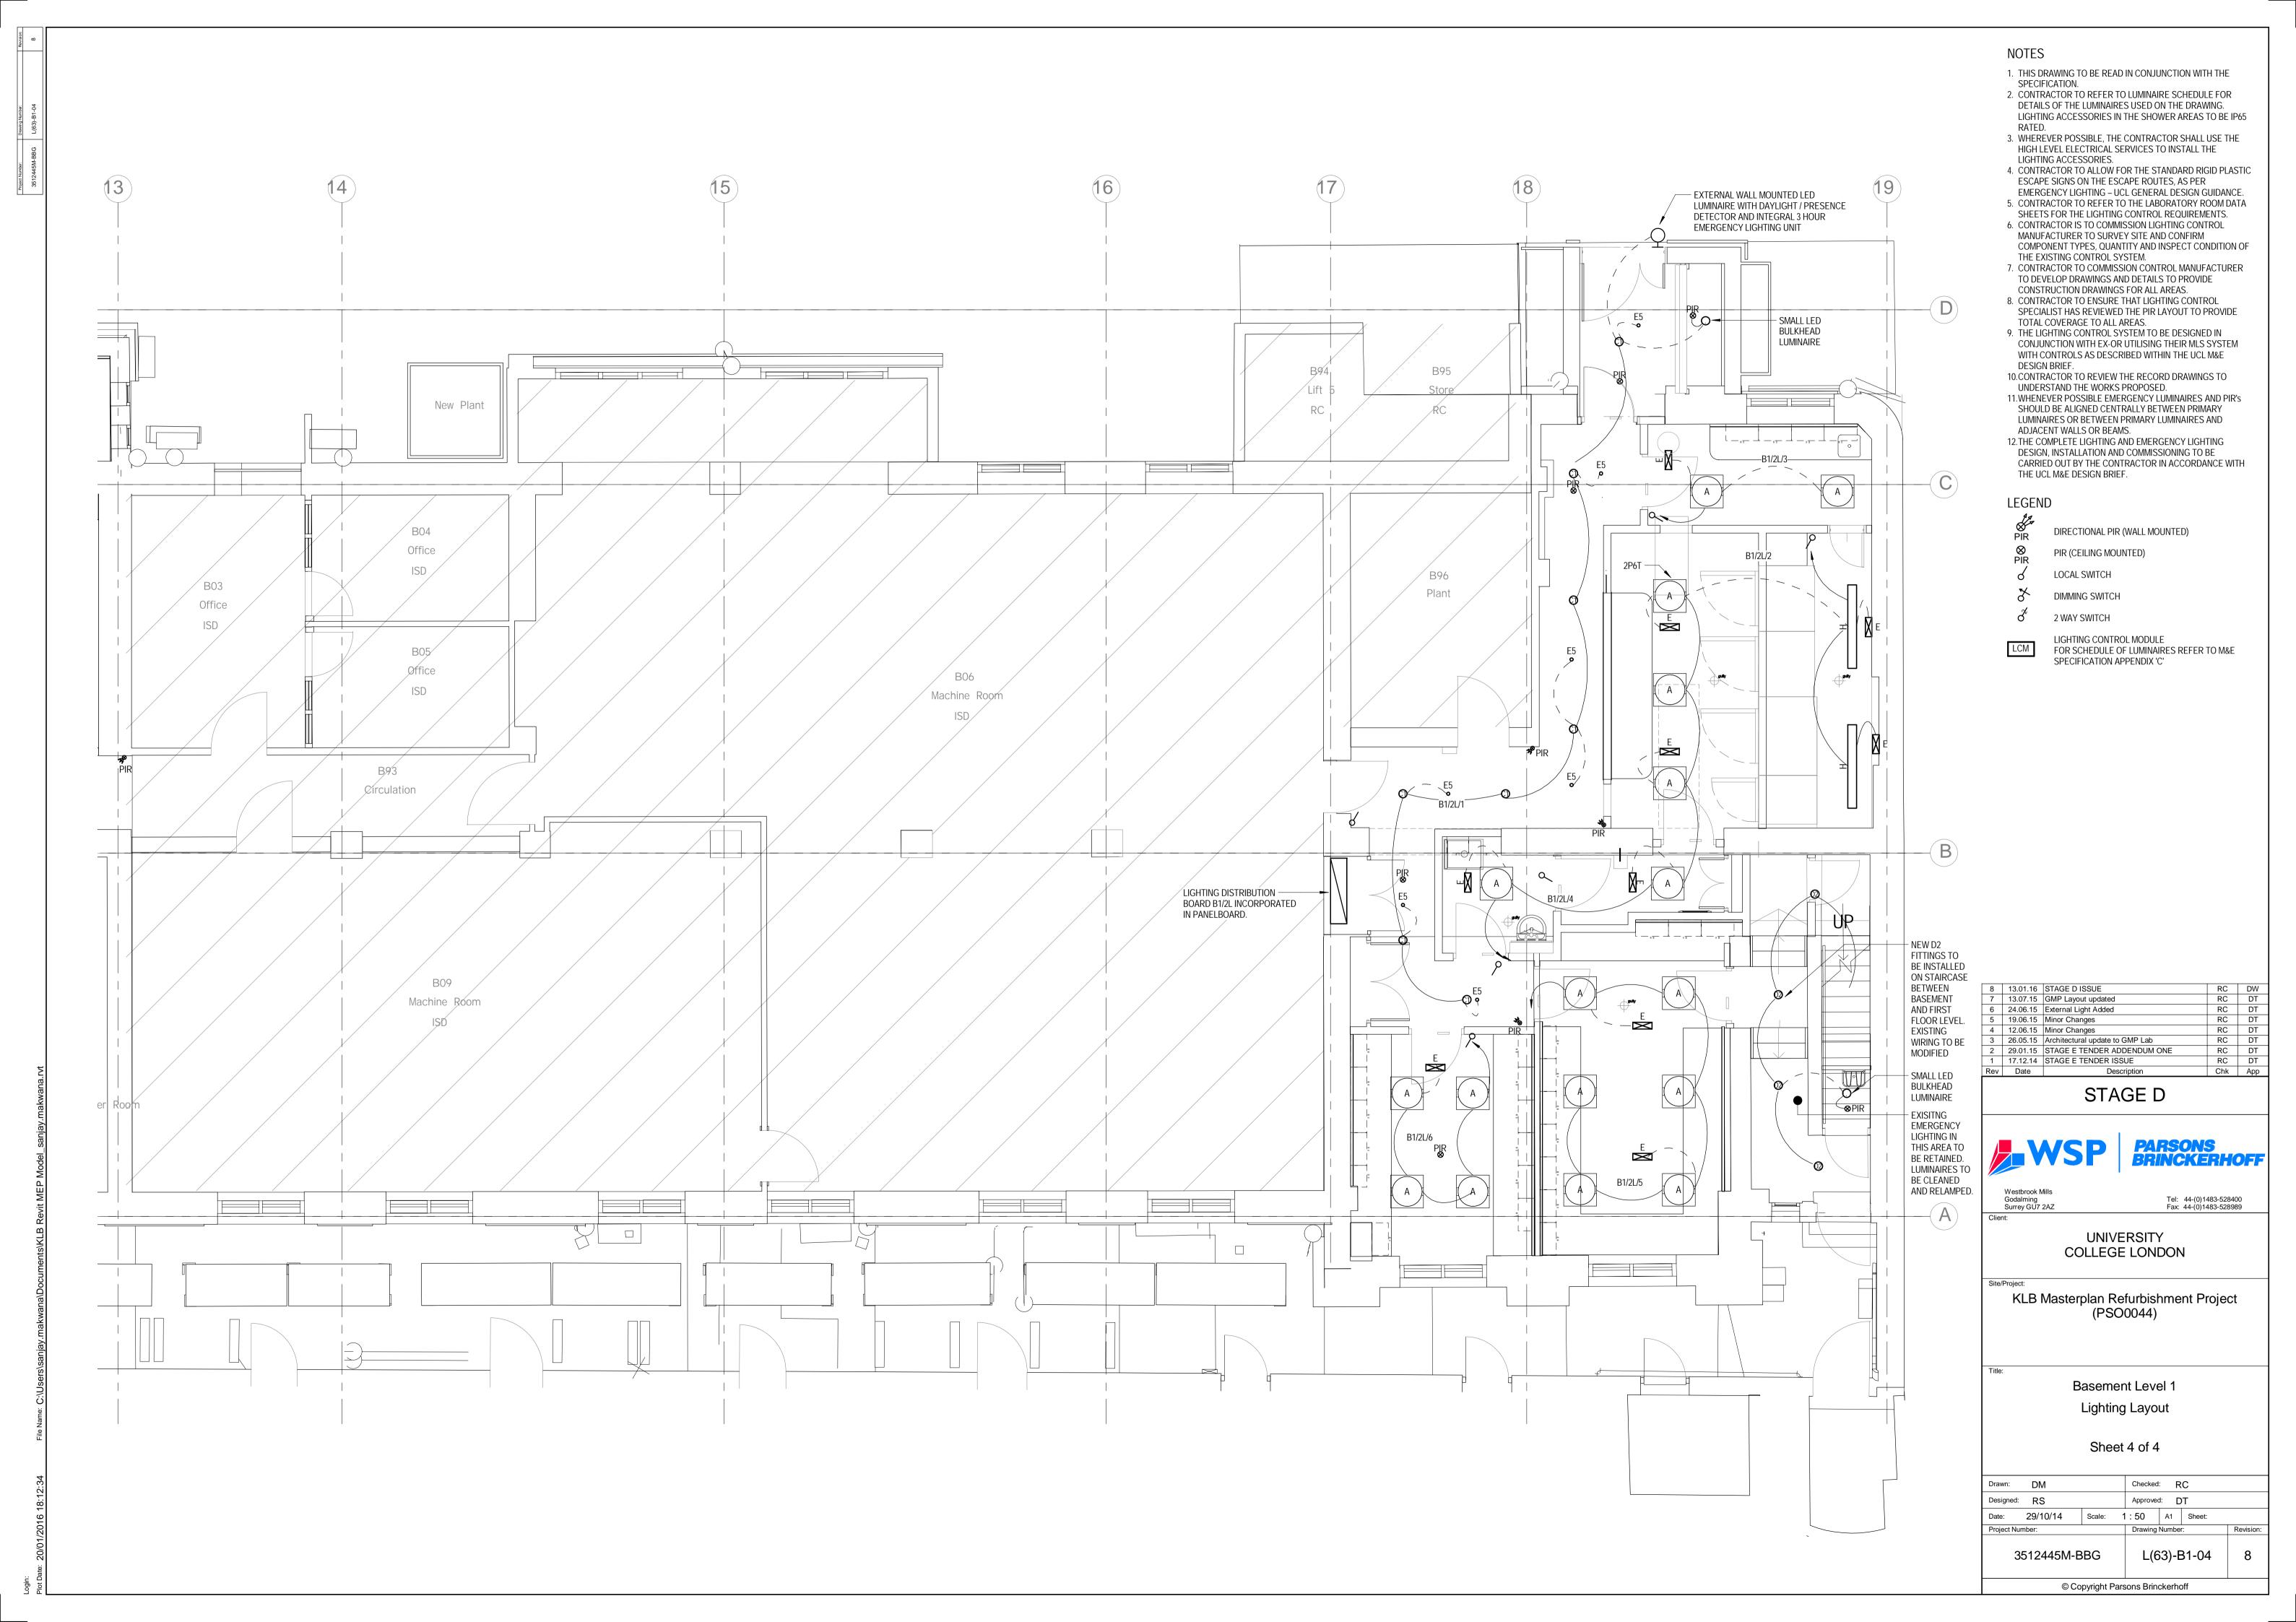
> Third Floor Lighting Layout

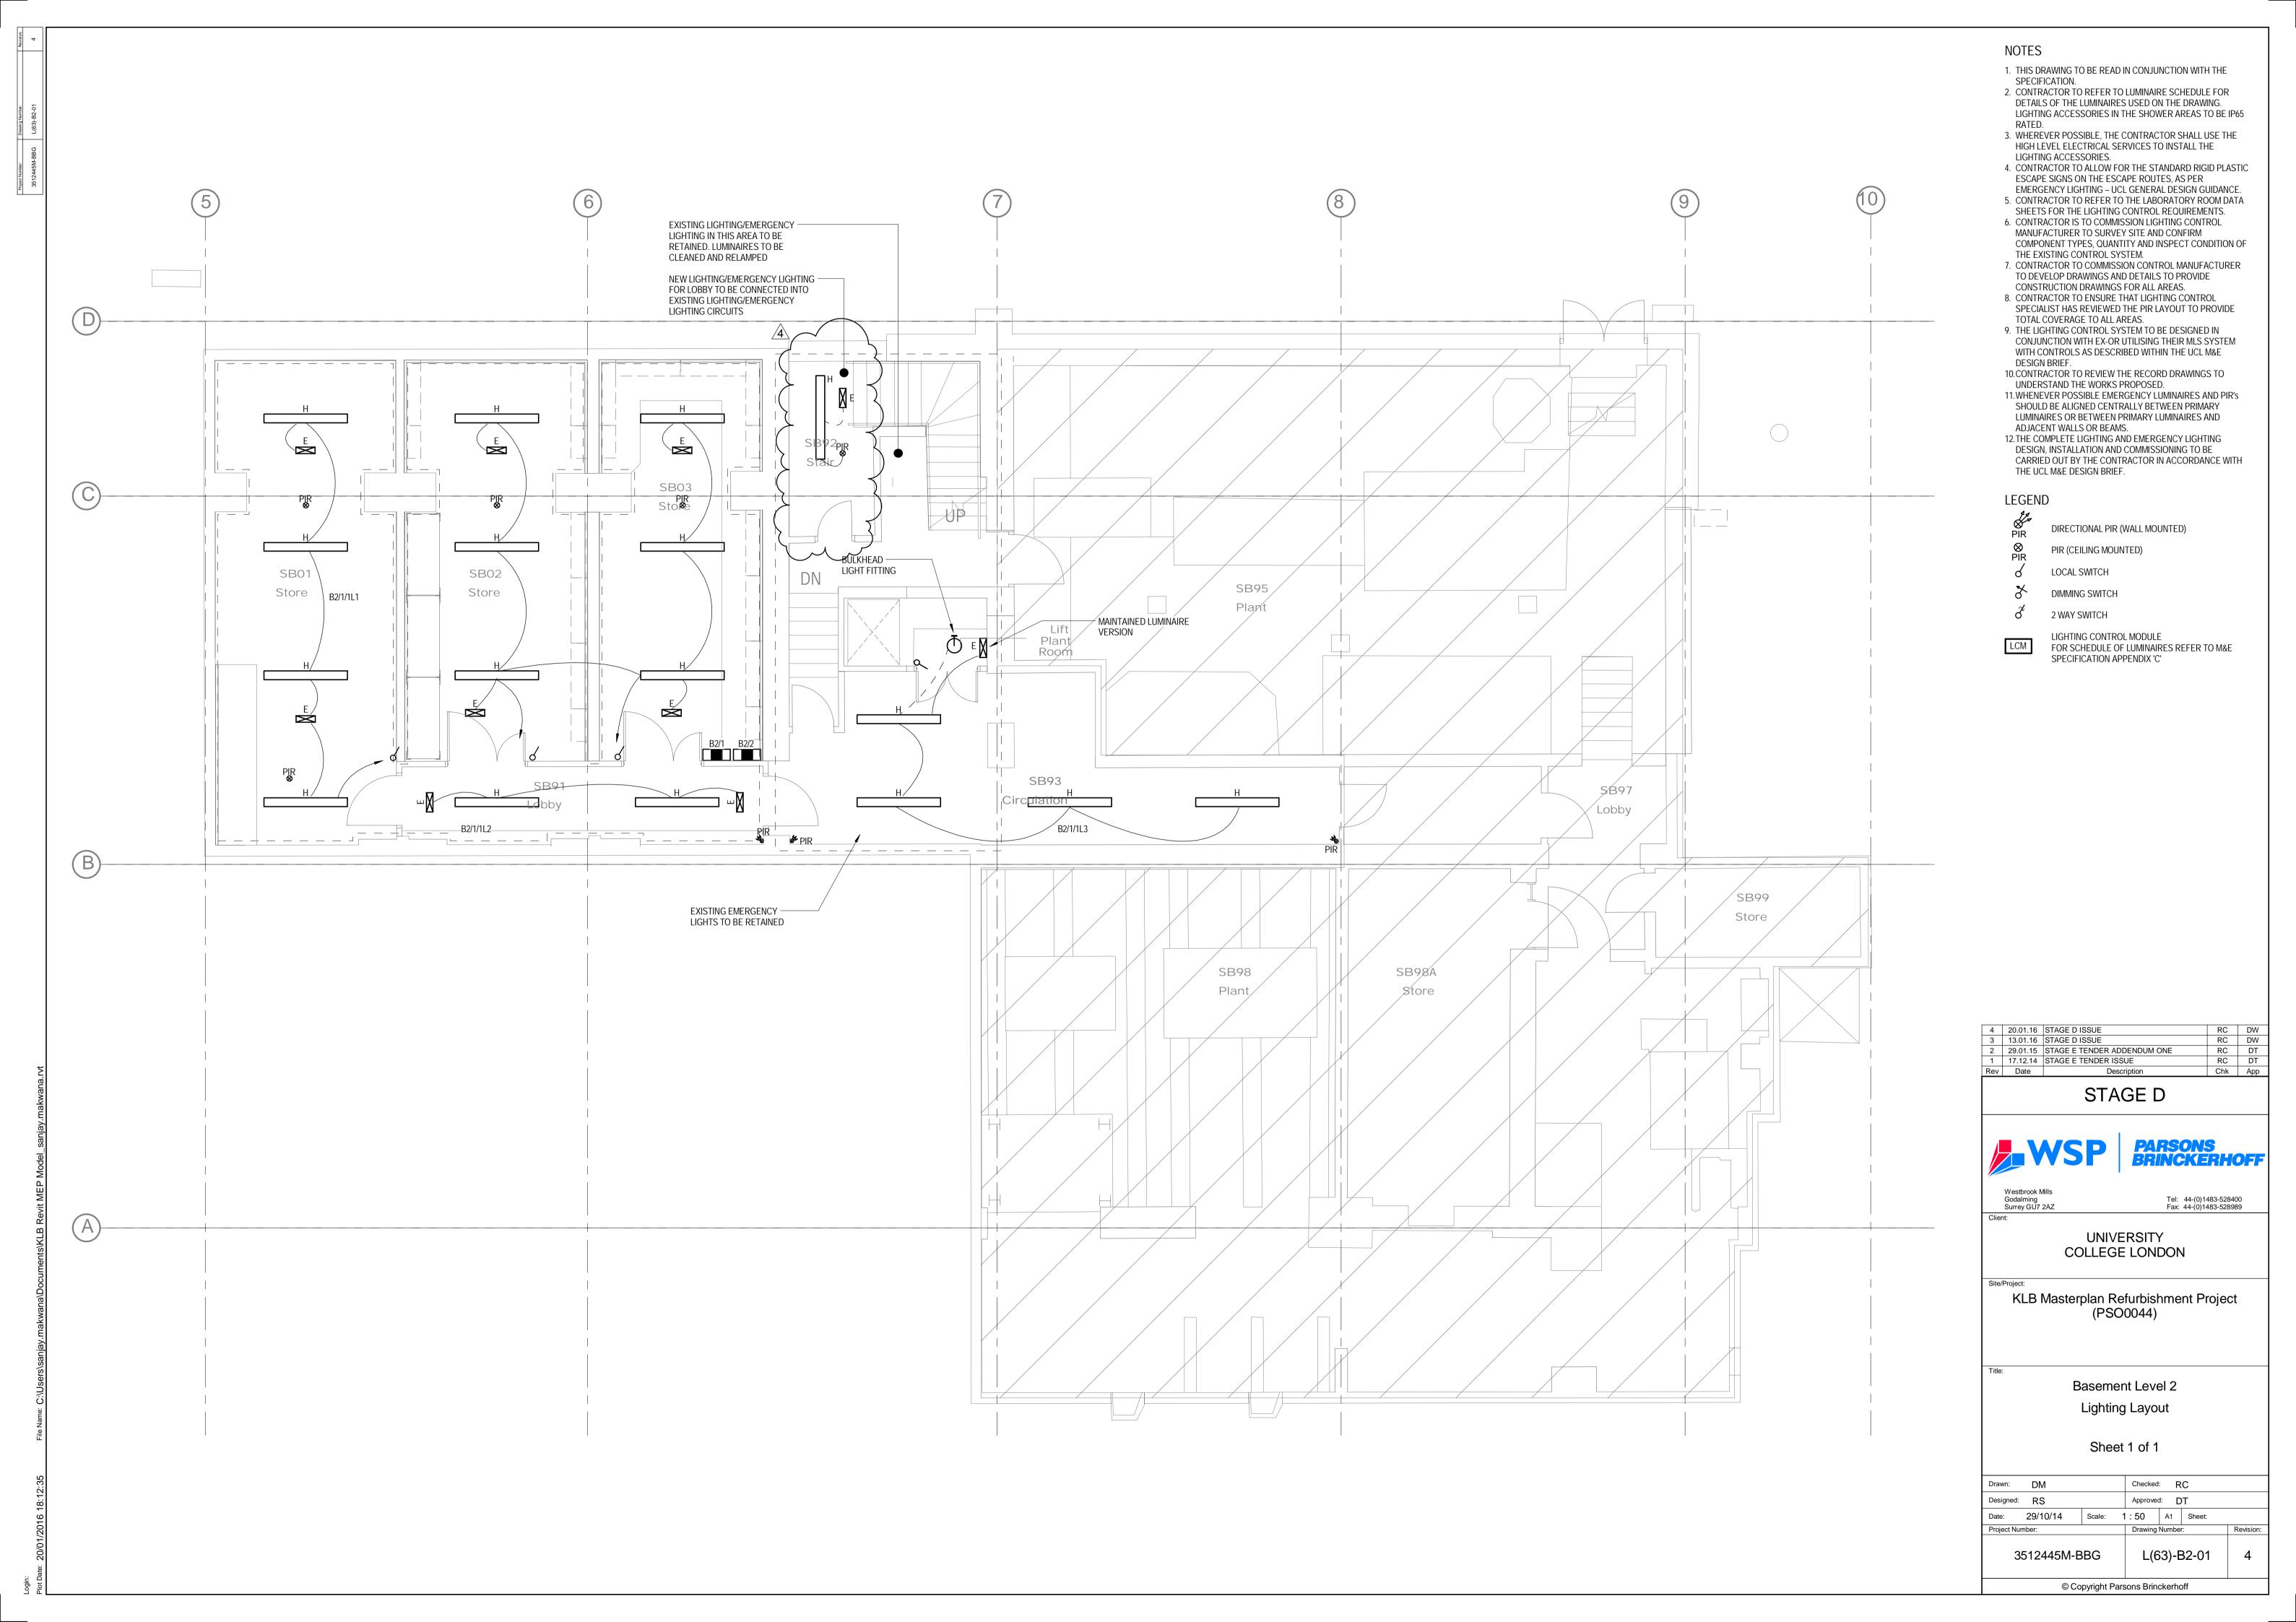
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- 1. 'E' DENOTES EXISTING FIRE ALARM DEVICE TO REMAIN. HOWEVER DEVICE MAY NEED TO BE DISCONNECTED AND REMOVED AND THEN RECONNECTED AS REQUIRED.
- 2. FIRE ALARM SYSTEM TO BE INTERFACED WITH:-
- REFUGE SYSTEMS DDA SYSTEMS

SPECIFICATION.

- DOOR HOLD OPEN DEVICES DOOR ACCESS SYSTEMS
- MECHANICAL PLANT OTHER SYSTEMS AS REQUIRED.
- ALL FIRE ALARM INTERFACES TO BE DESIGNED AND INSTALLED IN ACCORDANCE WITH UCL FIRE TECHNICAL NOTE
- 3. DRAWINGS TO BE READ IN CONJUNCTION WITH SERVICES
- 4. BUILDING DETECTION ZONES TO REMAIN AS EXISTING.
- 5. ALARM ZONING TO BE CONFIRMED.
- GENERAL INSTALLATION REQUIREMENTS TO BE IN ACCORDANCE WITH UCL FIRE TECHNICAL NOTE 054.
- 7. FIRE ALARM REQUIREMENTS IN TEA POINT/KITCHEN AREAS TO BE IN ACCORDANCE WITH UCL FIRE TECHNICAL NOTE 105.
- 8. * DENOTES DETECTOR TO BE MULTI-SENSOR TYPE AS DEFINED IN UCL TECHNICAL NOTE 054.
- 9. IN LABS SOUNDER LEVELS TO BE REDUCED OR DELAYED TO AVOID ACCIDENTS.

LEGEND

MANUAL CALL POINT

OPTICAL SMOKE DETECTOR

OPTICAL SMOKE SOUNDER

SMOKE VENT DETECTOR

HEAT DETECTOR

XENON BEACON

SOUNDER

FIRE ALARM INTERFACE

HEAT SOUNDER

4	20.01.16	STAGE D ISSUE	RC	DW
3	13.01.16	STAGE D ISSUE	RC	DW
2	29.01.15	STAGE E TENDER ADDENDUM ONE	RC	DT
1	17.12.14	STAGE E TENDER ISSUE	RC	DT
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Westbrook Mills Godalming Surrey GU7 2AZ



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KLB Masterplan Refurbishment Project (PSO0044)

Ground Floor Fire Alarm

Sheet 1 of 2

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- 'E' DENOTES EXISTING FIRE ALARM DEVICE TO REMAIN.
 HOWEVER DEVICE MAY NEED TO BE DISCONNECTED AND
 REMOVED AND THEN RECONNECTED AS REQUIRED.
- 2. FIRE ALARM SYSTEM TO BE INTERFACED WITH:-
- LIFTS
- REFUGE SYSTEMS
- DDA SYSTEMSDOOR HOLD OPEN DEVICES
- DOOR ACCESS SYSTEMSMECHANICAL PLANTOTHER SYSTEMS AS REQUIRED.
- ALL FIRE ALARM INTERFACES TO BE DESIGNED AND INSTALLED IN ACCORDANCE WITH UCL FIRE TECHNICAL NOTE
- 3. DRAWINGS TO BE READ IN CONJUNCTION WITH SERVICES SPECIFICATION.
- 4. BUILDING DETECTION ZONES TO REMAIN AS EXISTING.
- 5. ALARM ZONING TO BE CONFIRMED.
- 6. GENERAL INSTALLATION REQUIREMENTS TO BE IN ACCORDANCE WITH UCL FIRE TECHNICAL NOTE 054.
- 7. FIRE ALARM REQUIREMENTS IN TEA POINT/KITCHEN AREAS TO BE IN ACCORDANCE WITH UCL FIRE TECHNICAL
- NOTE 105.

 8. * DENOTES DETECTOR TO BE MULTI-SENSOR TYPE AS
- DEFINED IN UCL TECHNICAL NOTE 054.
- 9. IN LABS SOUNDER LEVELS TO BE REDUCED OR DELAYED TO AVOID ACCIDENTS.

LEGEND

MANUAL CALL POINT

OPTICAL SMOKE DETECTOR

OPTICAL SMOKE SOUNDER

OF THE SMOKE SOUNDER

SMOKE VENT DETECTOR

(Ht) HEAT DETECTOR

HEAT SOUNDER

XENON BEACON

SOUNDER

FAI FIRE ALARM INTERFACE

 3
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STAGE D

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WSP PARS

Westbrook Mills Godalming

Godalming Tel: 44-(0)1483-528400 Surrey GU7 2AZ Fax: 44-(0)1483-528989

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KLB Masterplan Refurbishment Project (PSO0044)

Ground Floor

Fire Alarm

Sheet 2 of 2

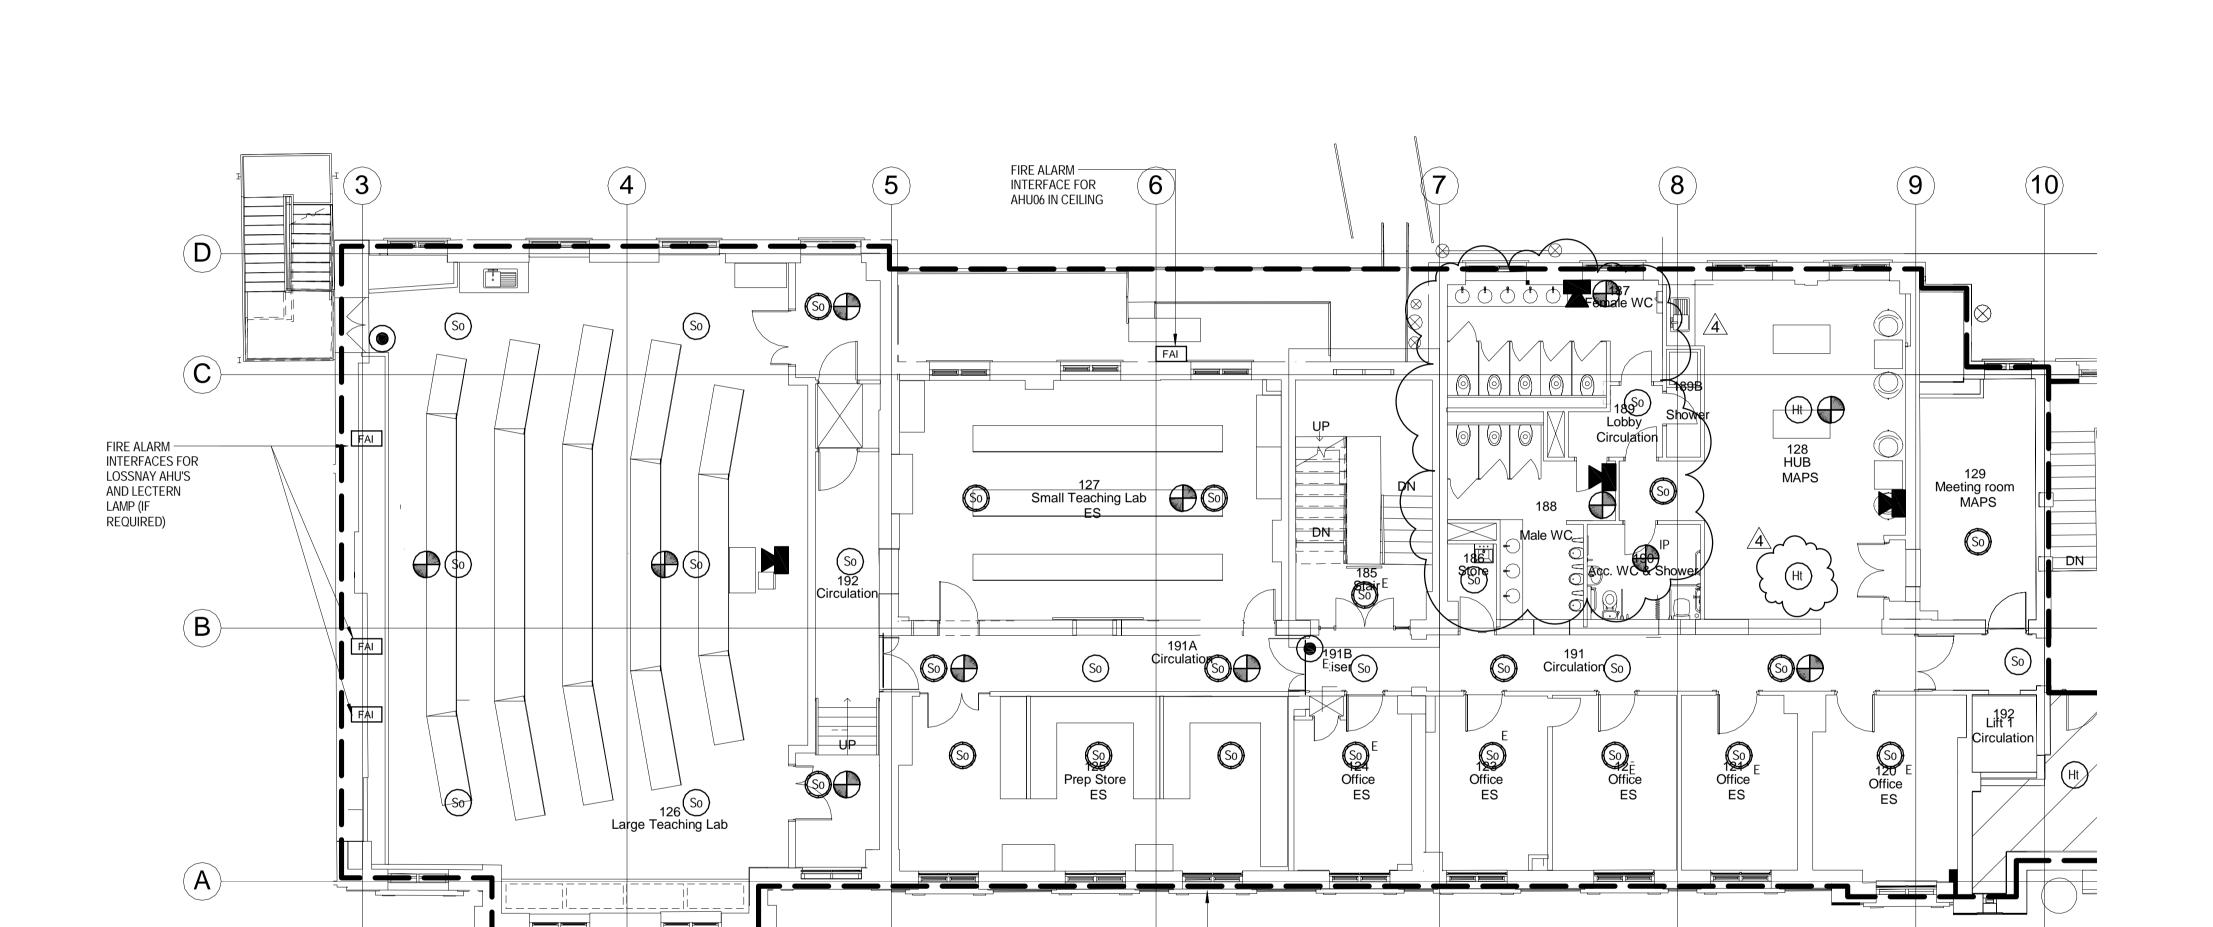
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- EXISTING FIRE ALARM SYSTEM IN THIS AREA TO BE MODIFIED TO SUIT NEW LAYOUT

NOTES

- 'E' DENOTES EXISTING FIRE ALARM DEVICE TO REMAIN. HOWEVER DEVICE MAY NEED TO BE DISCONNECTED AND REMOVED AND THEN RECONNECTED AS REQUIRED.
- 2. FIRE ALARM SYSTEM TO BE INTERFACED WITH:-
- REFUGE SYSTEMS
- DDA SYSTEMS
- DOOR HOLD OPEN DEVICES
- DOOR ACCESS SYSTEMS MECHANICAL PLANT
- OTHER SYSTEMS AS REQUIRED.
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LEGEND

MANUAL CALL POINT

OPTICAL SMOKE DETECTOR

OPTICAL SMOKE SOUNDER

SMOKE VENT DETECTOR

HEAT DETECTOR

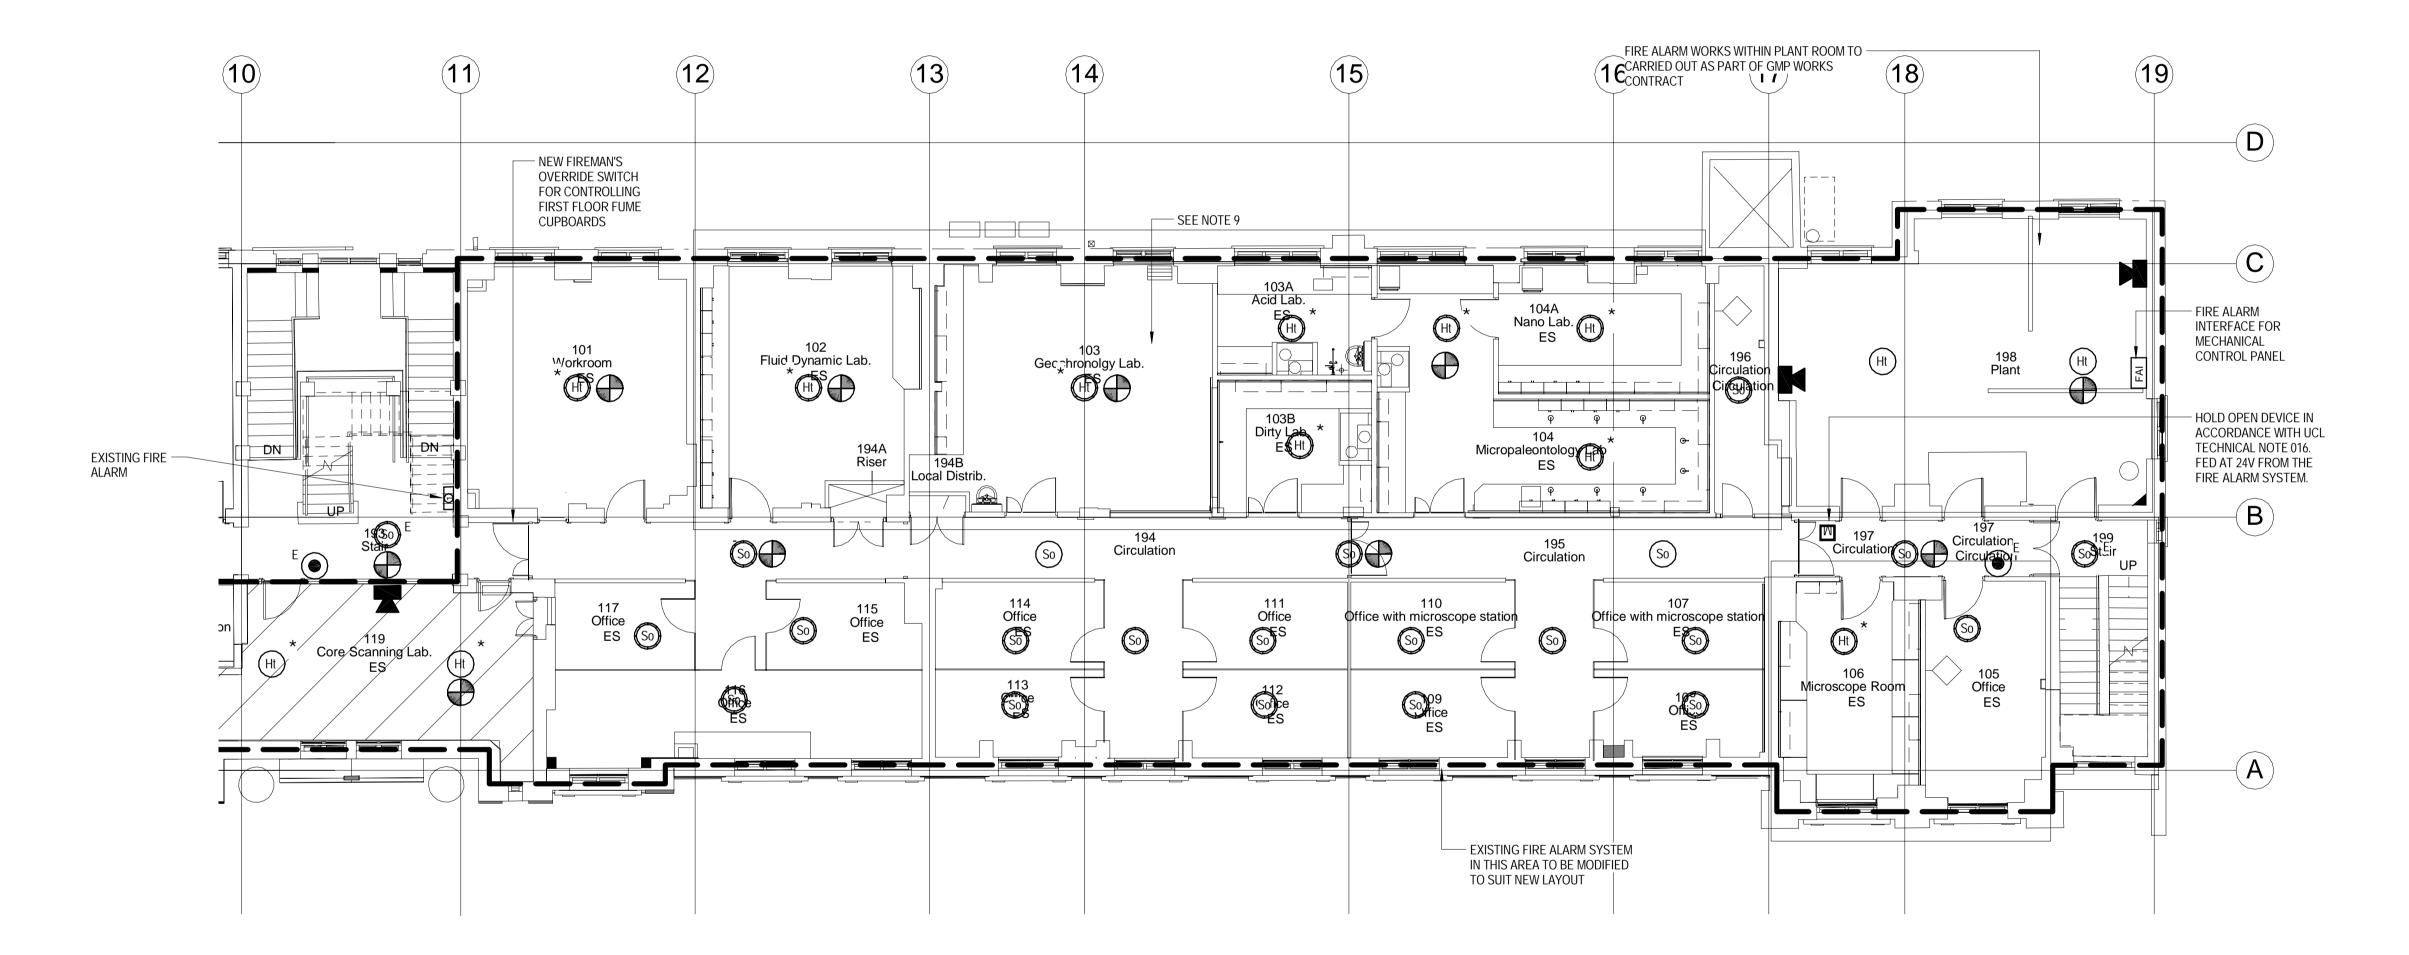
HEAT SOUNDER

XENON BEACON

SOUNDER

FIRE ALARM INTERFACE

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- 1. 'E' DENOTES EXISTING FIRE ALARM DEVICE TO REMAIN. HOWEVER DEVICE MAY NEED TO BE DISCONNECTED AND REMOVED AND THEN RECONNECTED AS REQUIRED.
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- DDA SYSTEMS
- DOOR HOLD OPEN DEVICES DOOR ACCESS SYSTEMS
- MECHANICAL PLANT OTHER SYSTEMS AS REQUIRED.
- ALL FIRE ALARM INTERFACES TO BE DESIGNED AND INSTALLED IN ACCORDANCE WITH UCL FIRE TECHNICAL NOTE
- 3. DRAWINGS TO BE READ IN CONJUNCTION WITH SERVICES
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LEGEND

MANUAL CALL POINT

OPTICAL SMOKE DETECTOR

OPTICAL SMOKE SOUNDER

SMOKE VENT DETECTOR

HEAT DETECTOR

HEAT SOUNDER

XENON BEACON

SOUNDER

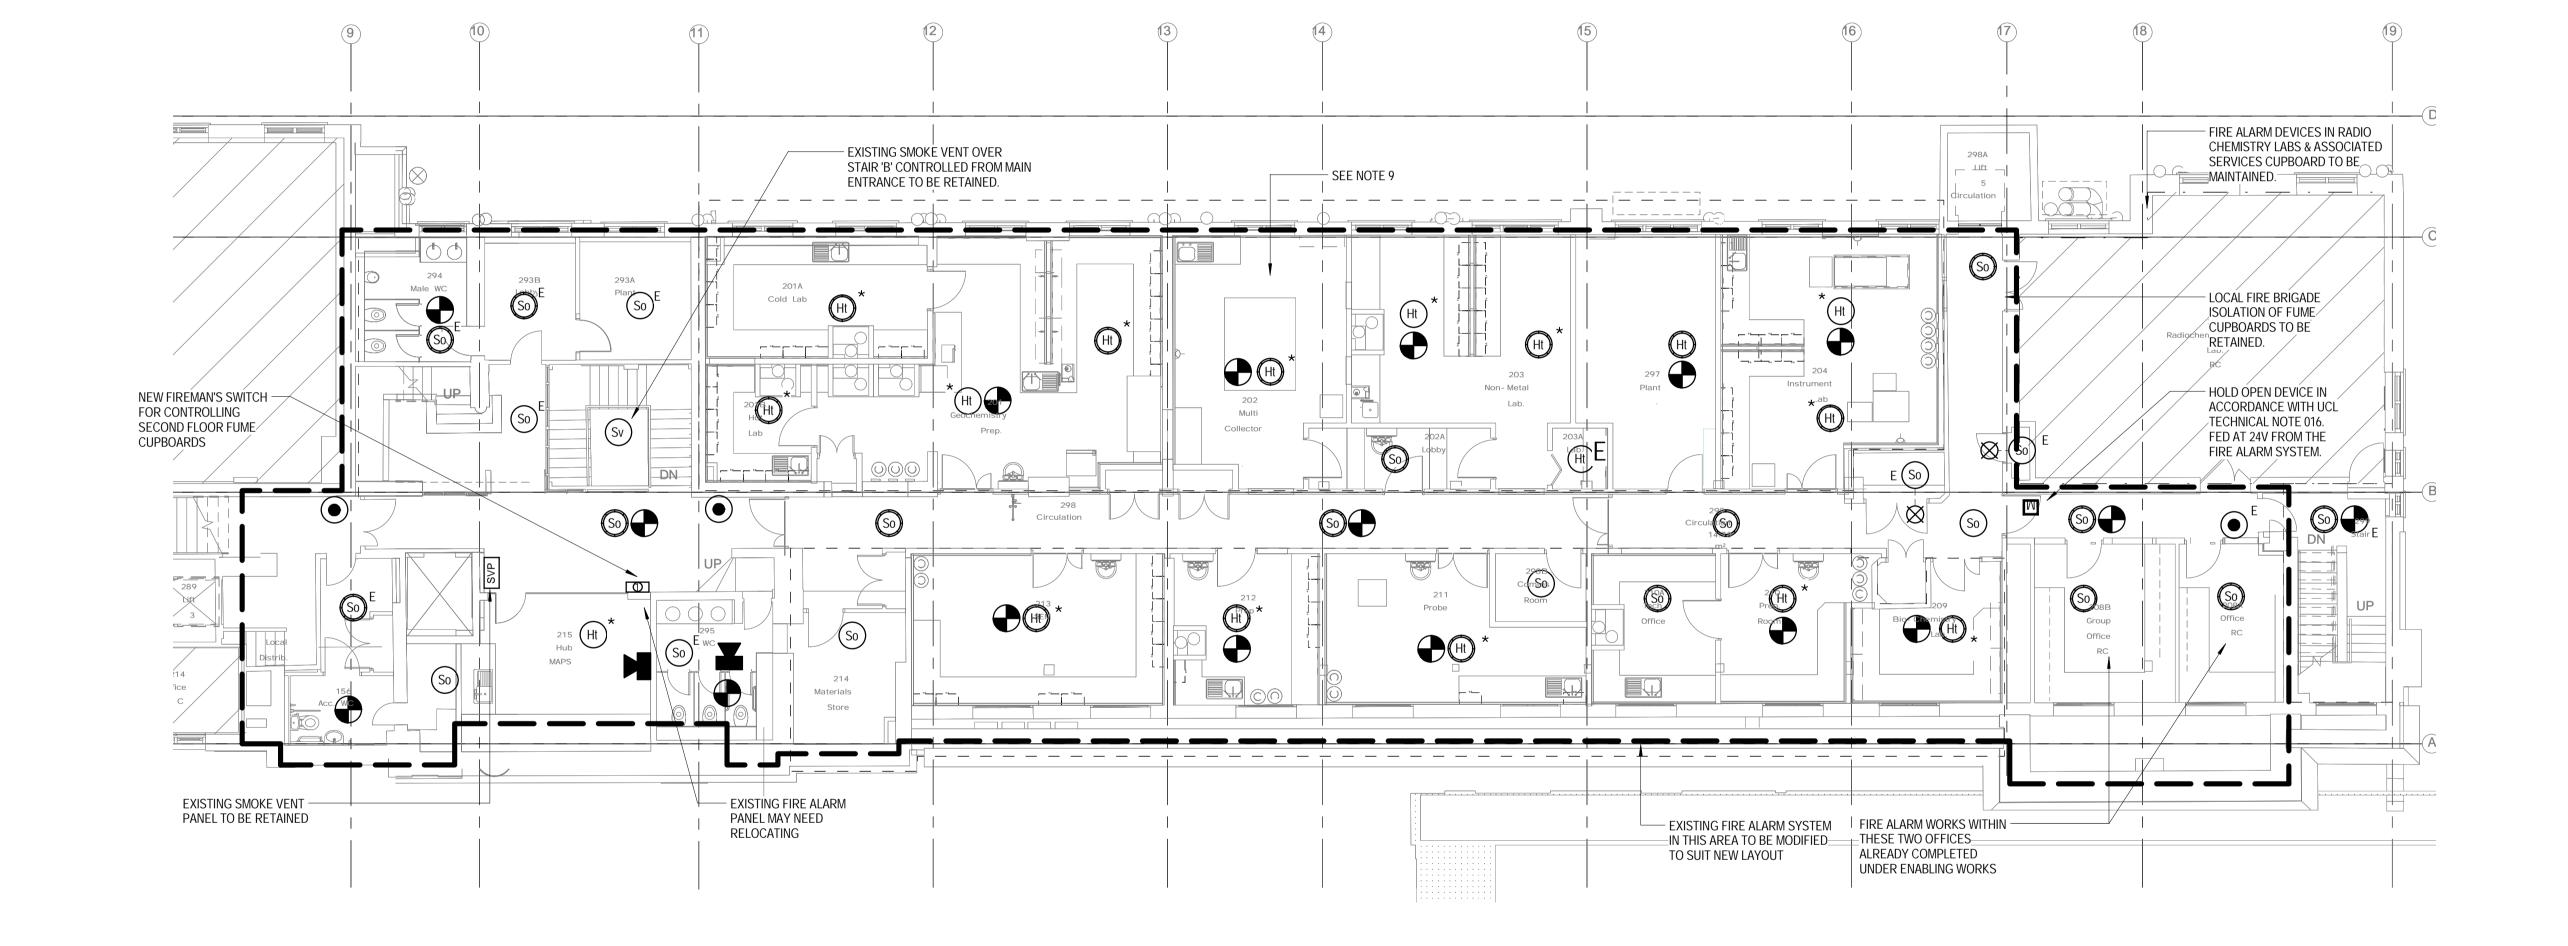
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FIRE ALARM INTERFACE

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- 6. GENERAL INSTALLATION REQUIREMENTS TO BE IN ACCORDANCE WITH UCL FIRE TECHNICAL NOTE 054.
- FIRE ALARM REQUIREMENTS IN TEA POINT/KITCHEN AREAS TO BE IN ACCORDANCE WITH UCL FIRE TECHNICAL NOTE 105.
- 8. * DENOTES DETECTOR TO BE MULTI-SENSOR TYPE AS DEFINED IN UCL TECHNICAL NOTE 054.
- 9. IN LABS SOUNDER LEVELS TO BE REDUCED OR DELAYED TO AVOID ACCIDENTS.

LEGEND

MANUAL CALL POINT

OPTICAL SMOKE DETECTOR

(So) OPTICAL SMOKE SOUNDER

(Sv) SMOKE VENT DETECTOR

Ht HEAT DETECTOR

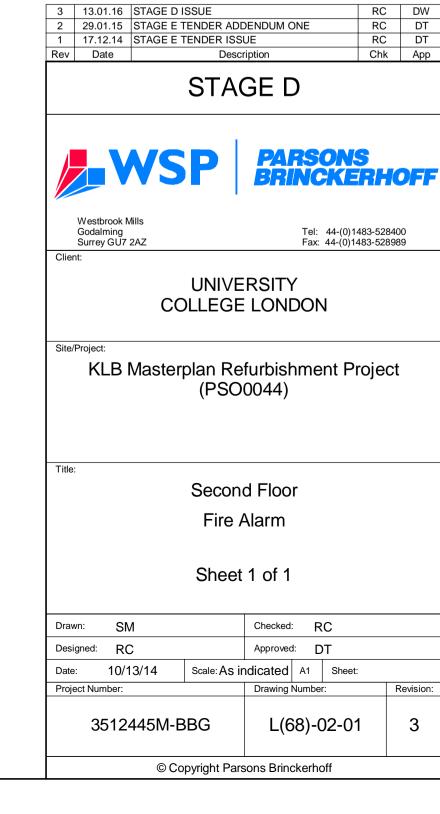
(Ht) HEAT SOUNDER

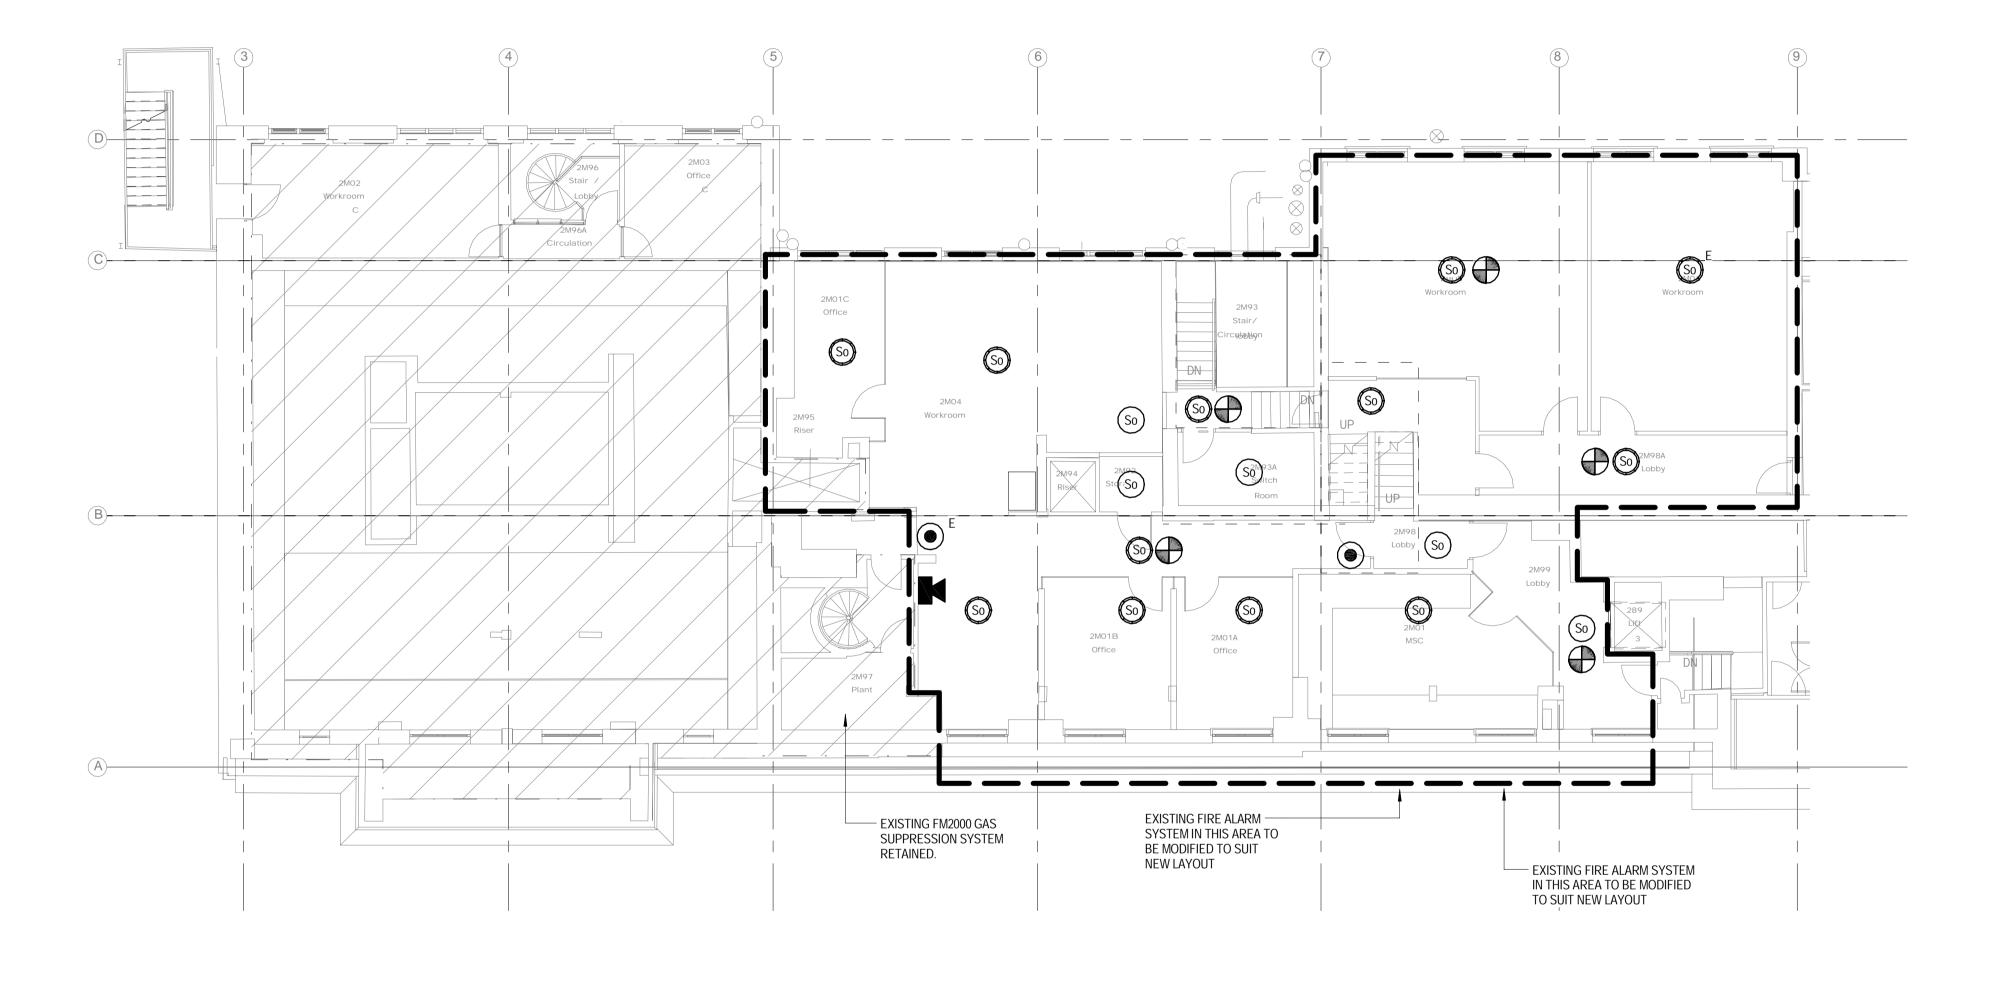
VENON PEACON

XENON BEACON

SOUNDER

FAI FIRE ALARM INTERFACE





- 'E' DENOTES EXISTING FIRE ALARM DEVICE TO REMAIN. HOWEVER DEVICE MAY NEED TO BE DISCONNECTED AND REMOVED AND THEN RECONNECTED AS REQUIRED.
- 2. FIRE ALARM SYSTEM TO BE INTERFACED WITH:-
- REFUGE SYSTEMS
- DDA SYSTEMS
 DOOR HOLD OPEN DEVICES
 DOOR ACCESS SYSTEMS
- MECHANICAL PLANT OTHER SYSTEMS AS REQUIRED.
- ALL FIRE ALARM INTERFACES TO BE DESIGNED AND INSTALLED IN ACCORDANCE WITH UCL FIRE TECHNICAL NOTE
- 3. DRAWINGS TO BE READ IN CONJUNCTION WITH SERVICES SPECIFICATION.
- 4. BUILDING DETECTION ZONES TO REMAIN AS EXISTING.
- 5. ALARM ZONING TO BE CONFIRMED.
- GENERAL INSTALLATION REQUIREMENTS TO BE IN ACCORDANCE WITH UCL FIRE TECHNICAL NOTE 054.
- 7. FIRE ALARM REQUIREMENTS IN TEA POINT/KITCHEN AREAS TO BE IN ACCORDANCE WITH UCL FIRE TECHNICAL
- 8. * DENOTES DETECTOR TO BE MULTI-SENSOR TYPE AS DEFINED IN UCL TECHNICAL NOTE 054.
- 9. IN LABS SOUNDER LEVELS TO BE REDUCED OR DELAYED TO AVOID ACCIDENTS.

LEGEND

NOTE 105.

MANUAL CALL POINT

OPTICAL SMOKE DETECTOR

OPTICAL SMOKE SOUNDER

SMOKE VENT DETECTOR

HEAT DETECTOR

HEAT SOUNDER

XENON BEACON

SOUNDER

FIRE ALARM INTERFACE

3	13.01.16	STAGE D	ISSUE				RC	DW
2	29.01.15		TENDER ADI	DENDUM C	ONE		RC	DT
1	17.12.14	STAGE E	TENDER ISS	UE			RC	DT
Rev	Date		Desc	ription			Chk	App
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Draw Design	vn: SN gned: R(:: 10/ ect Number:	Seco	ond Floo Fire A	or Mez	zani Rd: D A1	C T		

- 'E' DENOTES EXISTING FIRE ALARM DEVICE TO REMAIN.
 HOWEVER DEVICE MAY NEED TO BE DISCONNECTED AND REMOVED AND THEN RECONNECTED AS REQUIRED.
- 2. FIRE ALARM SYSTEM TO BE INTERFACED WITH:-
- REFUGE SYSTEMS
- DDA SYSTEMS
 DOOR HOLD OPEN DEVICES
 DOOR ACCESS SYSTEMS
- MECHANICAL PLANT

OTHER SYSTEMS AS REQUIRED.

- ALL FIRE ALARM INTERFACES TO BE DESIGNED AND INSTALLED IN ACCORDANCE WITH UCL FIRE TECHNICAL NOTE
- 3. DRAWINGS TO BE READ IN CONJUNCTION WITH SERVICES
- SPECIFICATION. 4. BUILDING DETECTION ZONES TO REMAIN AS EXISTING.
- 5. ALARM ZONING TO BE CONFIRMED.
- 6. GENERAL INSTALLATION REQUIREMENTS TO BE IN ACCORDANCE WITH UCL FIRE TECHNICAL NOTE 054.
- 7. FIRE ALARM REQUIREMENTS IN TEA POINT/KITCHEN AREAS TO BE IN ACCORDANCE WITH UCL FIRE TECHNICAL
- NOTE 105. 8. * - DENOTES DETECTOR TO BE MULTI-SENSOR TYPE AS
- 9. IN LABS SOUNDER LEVELS TO BE REDUCED OR DELAYED TO AVOID ACCIDENTS.

DEFINED IN UCL TECHNICAL NOTE 054.

LEGEND

MANUAL CALL POINT

OPTICAL SMOKE DETECTOR

OPTICAL SMOKE SOUNDER

SMOKE VENT DETECTOR

HEAT DETECTOR

HEAT SOUNDER

XENON BEACON

SOUNDER

FIRE ALARM INTERFACE

Rev	Date	Description	Chk	App
1	17.12.14	STAGE E TENDER ISSUE	RC	DT
2	29.01.15	STAGE E TENDER ADDENDUM ONE	RC	DT
3	13.01.16	STAGE D ISSUE	RC	DW
4	20.01.16	STAGE D ISSUE	RC	DW

STAGE D



UNIVERSITY COLLEGE LONDON

KLB Masterplan Refurbishment Project (PSO0044)

Third Floor Fire Alarm

Sheet 1 of 1

Drawn: SM		Checked	: R	C	
Designed: RC		Approved	d: D	Т	
Date: 10/13/14	Scale: As ir	ndicated	A1	Sheet:	
Project Number:		Drawing	Numbe	r:	Revision:
3512445M-B	BG	L(6	8)-(03-01	4

- 1. 'E' DENOTES EXISTING FIRE ALARM DEVICE TO REMAIN. HOWEVER DEVICE MAY NEED TO BE DISCONNECTED AND REMOVED AND THEN RECONNECTED AS REQUIRED.
- 2. FIRE ALARM SYSTEM TO BE INTERFACED WITH:-
- REFUGE SYSTEMS
- DDA SYSTEMS
- DOOR HOLD OPEN DEVICES DOOR ACCESS SYSTEMS
- MECHANICAL PLANT OTHER SYSTEMS AS REQUIRED.
- ALL FIRE ALARM INTERFACES TO BE DESIGNED AND INSTALLED IN ACCORDANCE WITH UCL FIRE TECHNICAL NOTE
- 3. DRAWINGS TO BE READ IN CONJUNCTION WITH SERVICES
- SPECIFICATION. 4. BUILDING DETECTION ZONES TO REMAIN AS EXISTING.
- 5. ALARM ZONING TO BE CONFIRMED.
- 6. GENERAL INSTALLATION REQUIREMENTS TO BE IN
- ACCORDANCE WITH UCL FIRE TECHNICAL NOTE 054.
- 7. FIRE ALARM REQUIREMENTS IN TEA POINT/KITCHEN AREAS TO BE IN ACCORDANCE WITH UCL FIRE TECHNICAL
- 8. * DENOTES DETECTOR TO BE MULTI-SENSOR TYPE AS DEFINED IN UCL TECHNICAL NOTE 054.
- 9. IN LABS SOUNDER LEVELS TO BE REDUCED OR DELAYED TO AVOID ACCIDENTS.

LEGEND

MANUAL CALL POINT

OPTICAL SMOKE DETECTOR

OPTICAL SMOKE SOUNDER

SMOKE VENT DETECTOR

HEAT DETECTOR

HEAT SOUNDER

XENON BEACON

SOUNDER

FIRE ALARM INTERFACE

6	13.01.16	STAGE D ISSUE	RC	DW
5	13.07.15	GMP Layout updated	RC	DT
4	12.06.15	Minor Changes	RC	DT
3	26.05.15	Architectural update to GMP Lab	RC	DT
2	29.01.15	STAGE E TENDER ADDENDUM ONE	RC	DT
1	17.12.14	STAGE E TENDER ISSUE	RC	DT
Rev	Date	Description	Chk	App

STAGE D

Westbrook Mills Tel: 44-(0)1483-528400 Fax: 44-(0)1483-528989 Godalming Surrey GU7 2AZ

> UNIVERSITY COLLEGE LONDON

KLB Masterplan Refurbishment Project (PSO0044)

Basement Level 1 Fire Alarm

Sheet 1 of 1

Checked: RC Designed: RC Approved: DT 10/13/14 | Scale: As indicated A1 | Sheet: Project Number: Drawing Number:

L(68)-B1-01 3512445M-BBG

- 'E' DENOTES EXISTING FIRE ALARM DEVICE TO REMAIN.
 HOWEVER DEVICE MAY NEED TO BE DISCONNECTED AND
 REMOVED AND THEN RECONNECTED AS REQUIRED.
- 2. FIRE ALARM SYSTEM TO BE INTERFACED WITH:-
- LIFTS
 DEFINE GYETE
- REFUGE SYSTEMS
- DDA SYSTEMSDOOR HOLD OPEN DEVICES
- DOOR ACCESS SYSTEMSMECHANICAL PLANT
- MECHANICAL PLANTOTHER SYSTEMS AS REQUIRED.
- ALL FIRE ALARM INTERFACES TO BE DESIGNED AND INSTALLED IN ACCORDANCE WITH UCL FIRE TECHNICAL NOTE
- 3. DRAWINGS TO BE READ IN CONJUNCTION WITH SERVICES SPECIFICATION.
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- 8. * DENOTES DETECTOR TO BE MULTI-SENSOR TYPE AS DEFINED IN UCL TECHNICAL NOTE 054.
- 9. IN LABS SOUNDER LEVELS TO BE REDUCED OR DELAYED

LEGEND

MANUAL CALL POINT

TO AVOID ACCIDENTS.

OPTICAL SMOKE DETECTOR

OPTICAL SMOKE SOUNDER

SMOKE VENT DETECTOR

HEAT DETECTOR

(Ht) HEAT SOUNDER

XENON BEACON

SOUNDER

SOUNDER

FIRE ALARM INTERFACE

 3
 13.01.16
 STAGE D ISSUE
 RC
 DW

 2
 29.01.15
 STAGE E TENDER ADDENDUM ONE
 RC
 DT

 1
 17.12.14
 STAGE E TENDER ISSUE
 RC
 DT

 Rev
 Date
 Description
 Chk
 App

WCD

Westbrook Mills
Godalming
Tel: 44-(0)1483-528400
Surrey GU7 2AZ
Fax: 44-(0)1483-528989

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KLB Masterplan Refurbishment Project (PSO0044)

Basement Level 2
Fire Alarm

Sheet 1 of 1

Drawn: SM Checked: RC

Designed: RC Approved: DT

Date: 10/13/14 Scale: As indicated A1 Sheet:

Project Number: Drawing Number: Rev

3512445M-BBG L(68)-B2-01
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