



Tree number 3 plotted by eye.


Basement Floor & Ground Floor Plan based on Perkins+Will UK Limited project/drawing numbers 325424/A-04-B1&A-04-00 Rev A.

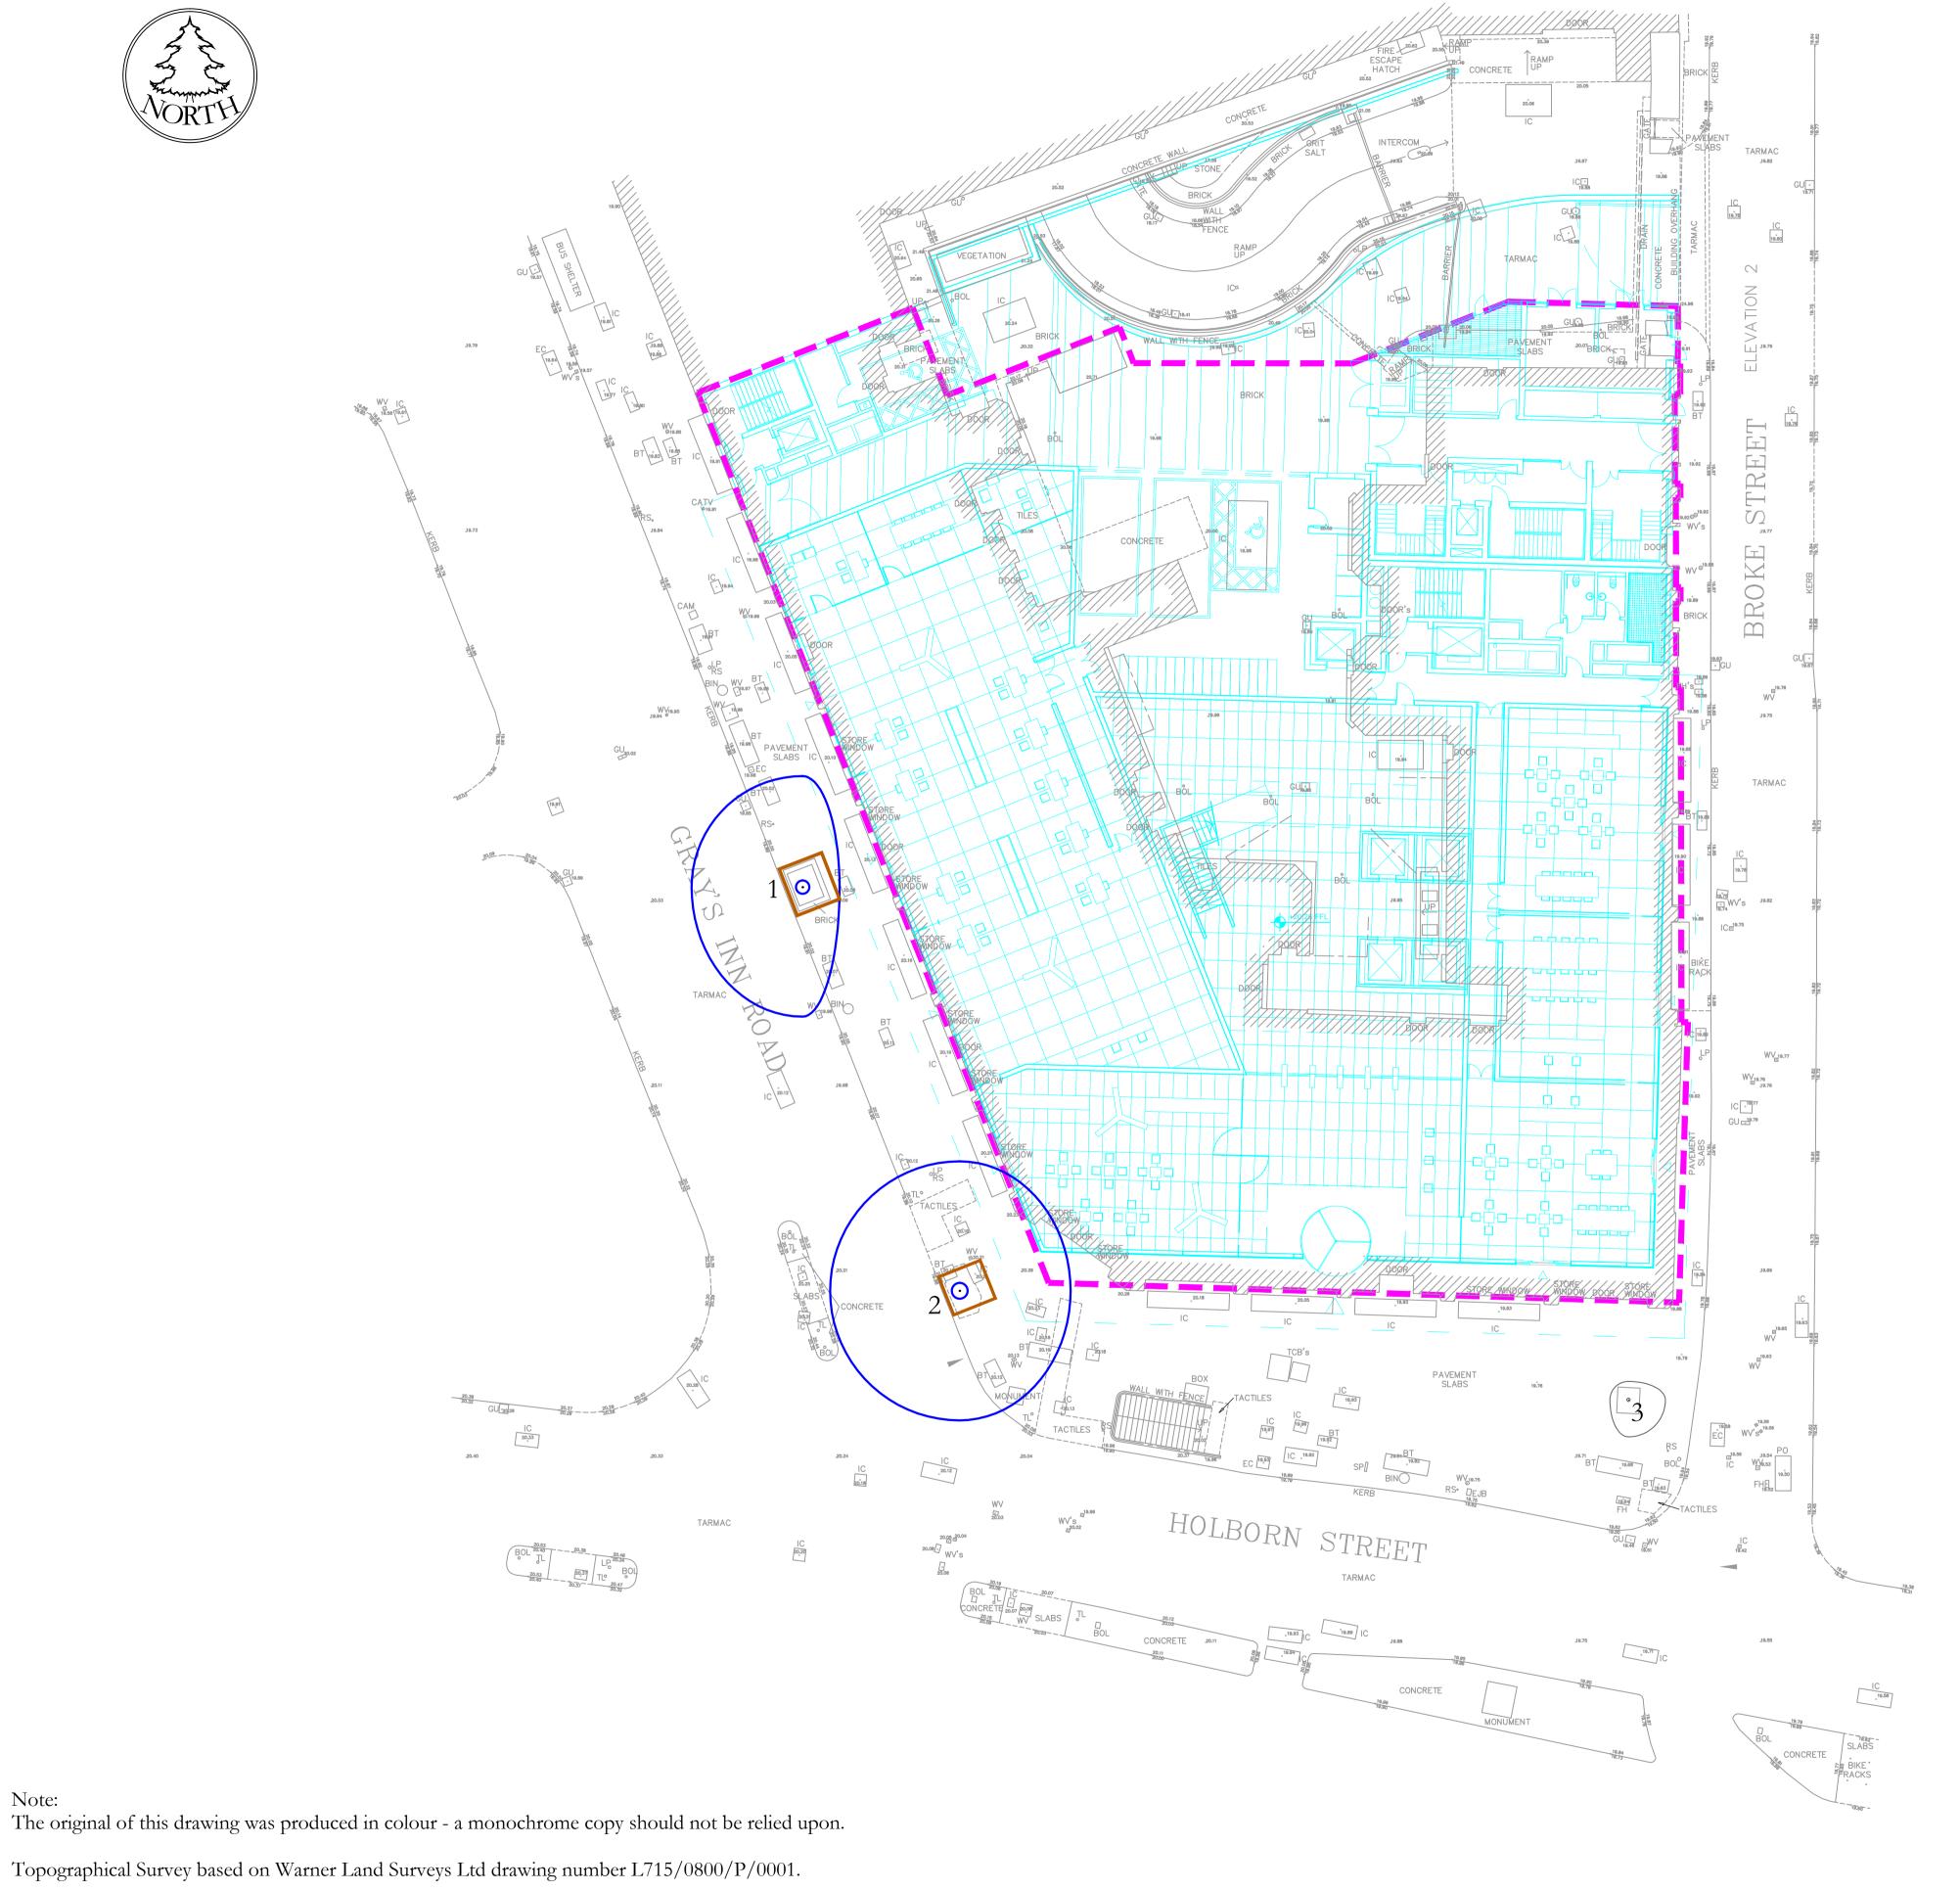

													SUR	RVEY	OF	TREES	AT 1	50 H	OLBOI	RN , LONDON			
								Stem diameters (cm)								l g			5,0			29	
No.		Ht	Branch Spread (m)				tem		2-5 stems				More than 5 stems		H ∪ .	first branc direction	ss pount)	grading	r grading remaining tion (yrs)	Condition	/T. W. J DG 2000	ction radii m)	protection area sq.m
Tree	Species	(m)	N	Е	S	W	Single S	Stem 1	Stem 2	Stem 3	Stem 4	Stem 5	Mean dia	No. stems	Height o	t of t	Age	Category	Estimated	Physiological / Structural	Tree Works to BS 3998	80 Root protecti	Root prote
1	London plane	15	6	2	7	6	72								5	5NW	Е	B1	>20	Established street tree but crown development compromised on eastern side.	Cut back to provide 2m clearance from proposed dwelling.	8.64	2:
2	London plane	15	7	6	7	7	84								5	5NW	Е	B1	>20	Established street tree but crown development compromised on eastern side.	Cut back to provide 2m clearance from proposed dwelling.	10.08	31
3	Rowan	5	1	2	2	1		16	5	4	5				1.2	1.2SE	S	C1	>10	Multi-stemmed tree. Crown dieback.	Suggest the tree is replaced.	2.15	1

	C1	>10	Multi-stemr	ned tree. Crown dieback.	Suggest the tree is replaced.	2.15	15							
				Key to Scheo	dule of Trees									
C	Column Heading			Key to Schedule of Trees Explanation										
	Tree No.			Unique number corresponding	with number on plan									
	ecies			English names	F									
-	[t (m)			Height in metres										
		Spread		Crown radius in metres to cardinal points of the compass										
	em D	-		All measurements conform to										
				Single stem - Stem diameter in	centimetres measured at 1.5m above gro	und level.								
				Multi-stemmed tree with 2 to 5 stems - Diameter of each stem										
				Multi-stemmed tree with more than 5 stems - Average stem diameter and number of stems										
Height of crown clearance			clearance	Height in metres between the ground and underside of canopy										
Height of first major				Height from ground level to base of first major branch and the										
Branch and direction				approximate direction of growth										
	grow													
A	bbrev	iations as	suffix to	Suffix 'e' denotes an estimated	dimension									
	a dimension			Suffix 'av' denotes an average dimension										
Age Class				Age Class definitions:										
	0			Y = Young										
				S = Semi-mature										
				E = Early mature										
				M = Mature										
				O = Over mature										
C	atego	ry grading	g and	Summary of BS 5837: 2012 cat	egorisation:									
		ted remai		•										
	Contribution (yrs)			1. Trees unsuitable for retention	n:									
			,	U = those in such a condition	on that they cannot realistically be retain	ed as living tree	es in							
				the context of the current land										
				2. Trees to be considered for re	etention:									
					uality (substantial contribution >40 yrs)									
				B1, 2 or $3 = \text{trees of moder}$	rate quality (significant contribution >20	yrs)								
					nality (but adequate, ie >10 yrs or young	trees -								
				until new planting can be establ										
Estimated remaining contribution				Useful estimated remaining cor	ntribution of the tree or tree group									
-														
Condition				Brief description including physiological and structural defects										
Т	ree W	orks		Works required to be undertaked defect encountered during the	en to the trees to facilitate the constructi survey	on of remediate	e a							
R	oot Pı	rotection	Radius	Radius of minimum root prote-	ction area in metres calculated from sect	ion 4.6 and Ann	nex D							
R	oot Pı	rotection	Area	Total area of minimum root pr	otection area extrapolated from root pro	tection radius								

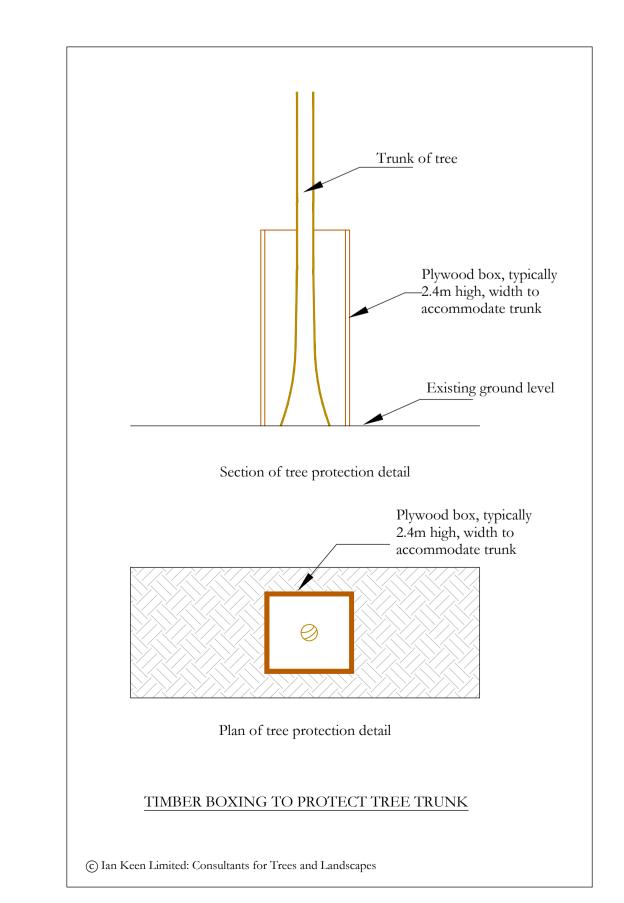

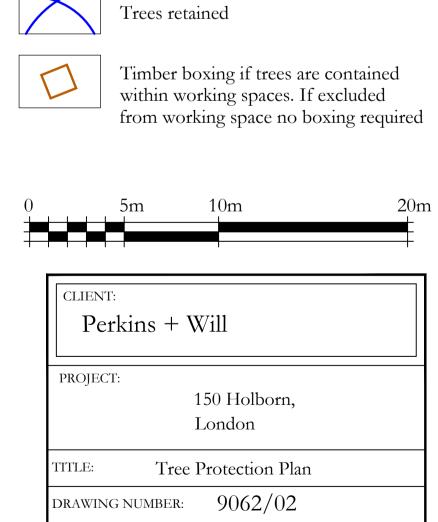

STATUS:

Existing site features

Proposed ground floor

Proposed basement

SCALE: 1:200 @ A1 DATE: Dec 2015 CHECKED BY: JTK DRAWN BY: ML Do not scale from this drawing: All dimensions to be checked on site The copyright of this document resides with

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For Information

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