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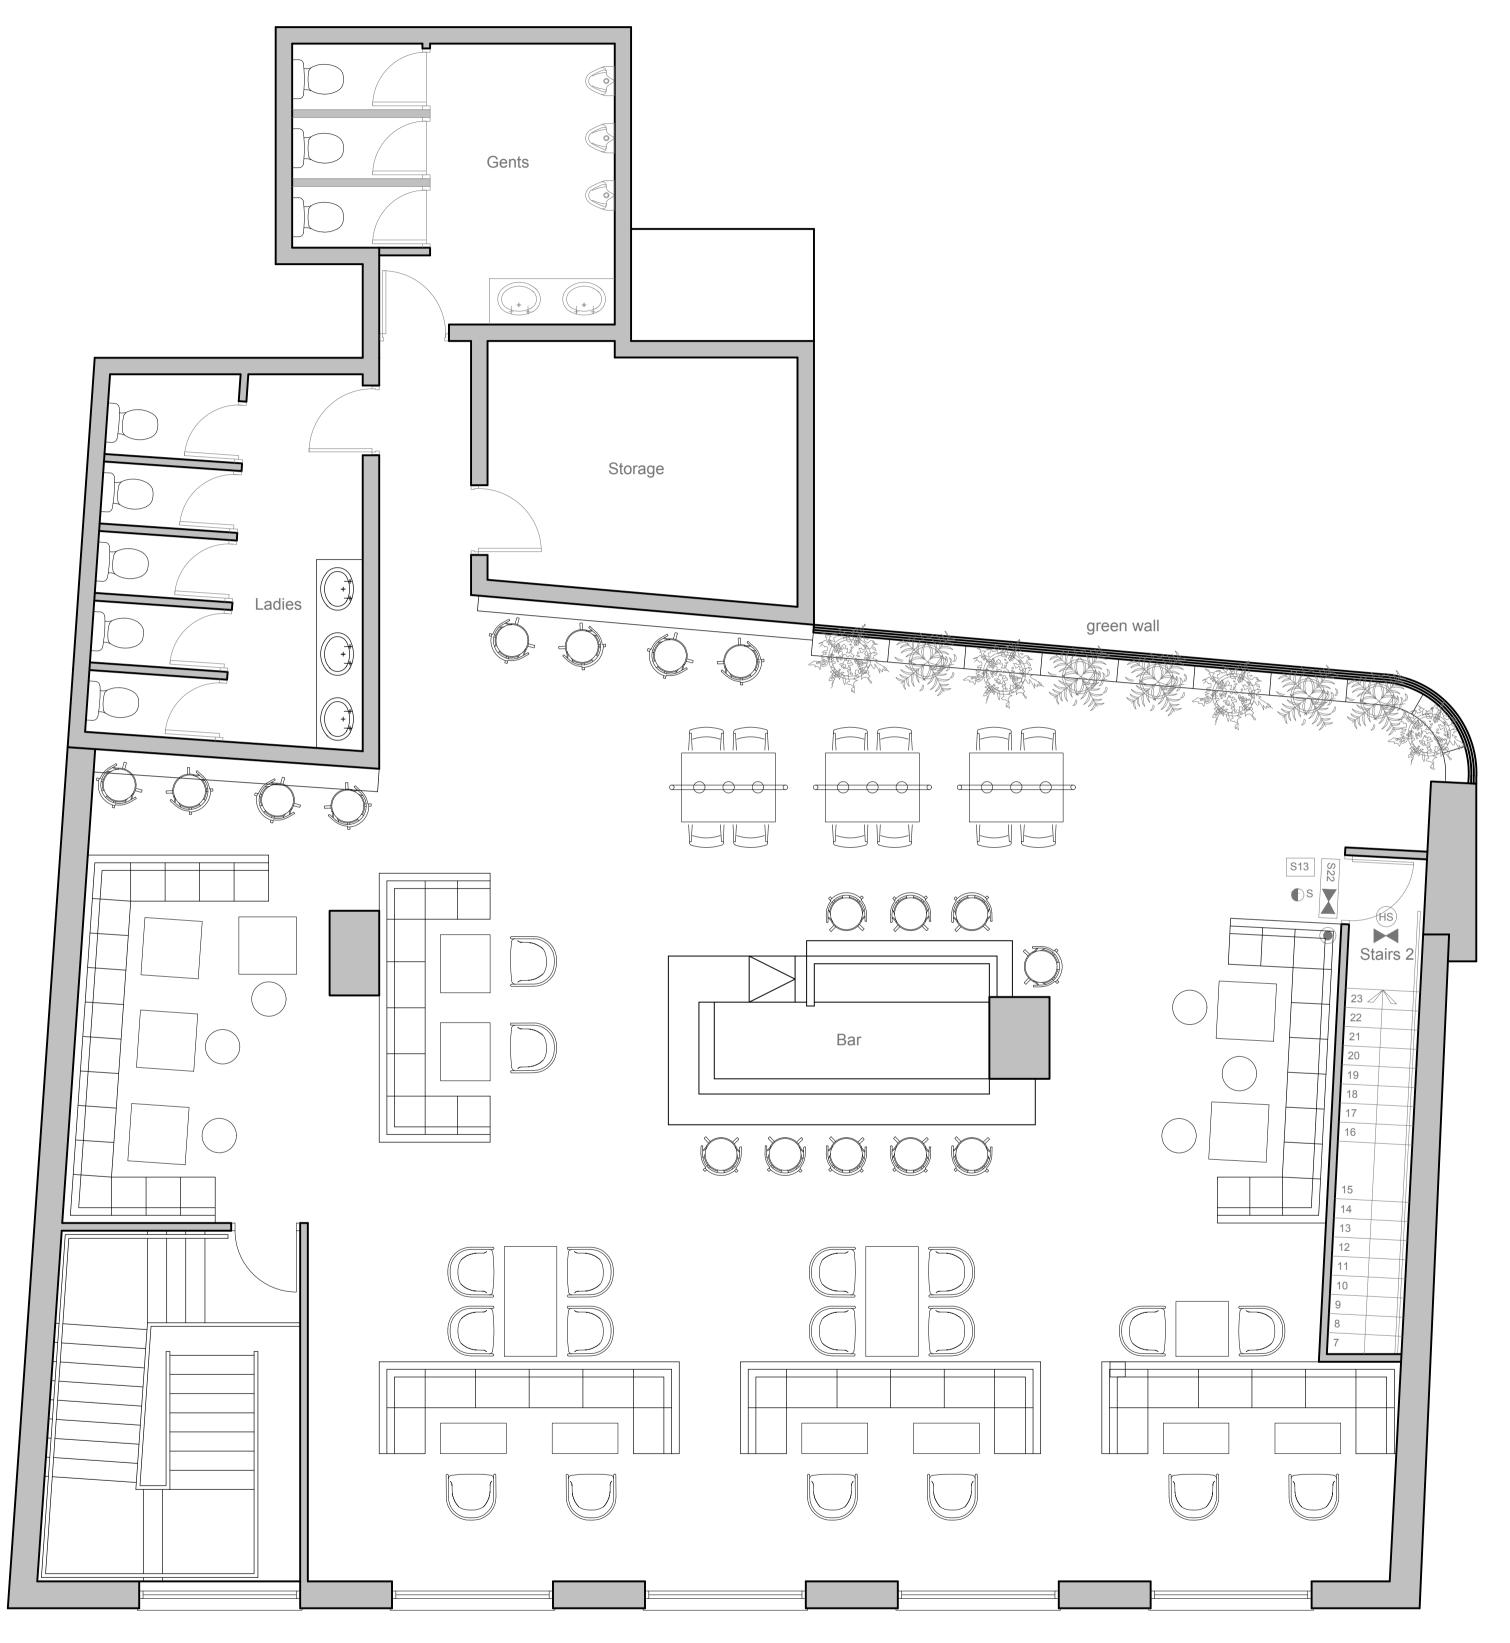
Brian Mannion

Brondes Age 328 Kilburn High Rd London NW6 2QN

Ground Floor General Arrangement

1:50 Drawn by SH Job No. 1677 Revisions Description

1677-02



Proposed First Floor Plan

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General Notes

All Tibbatts Design Ltd drawings to be read in conjunction with other Architectural, Structural/Civil Engineering, Mechanical & Electrical Consultants and all other specialist Contractor/Suppliers drawings for the External Envelope, Fit-out areas and associated external works.

The Principal Contractor or his appointed Specialist Sub Contractors are to familiarize themselves, where appropriate, with the site and measure all areas affecting their works. All dimensions and levels to be checked on site by Contractor prior to the commencement of work or the manufacture of any off site components or artifacts. Where dimensions are shown these are subject to final verification by the Contractor or appointed Sub Contractor. Any dimensional discrepancies or non availability of selected materials must be notified immediately in writing to the appropriate Designer. All dimensions to be recorded in millimeters unless specifically stated otherwise. All works are to be carried out by recommended/competent installation Contractors to Manufacturers instructions/recommendations. All materials & workmanship are to comply with British Standards and E.E.C. codes current at the commencement of the works. Contractor is to ensure that all the works are in compliance with BS, EHO., Building Control, Fire Authority and all other Statutory requirements where applicable.

Standard Notes applicable to development

All works to comply with the following statutory requirements

Building Regulations
Fire Precautions Act
BS8290 Suspended Ceiling installations
BS6206 Glazing
All other relevant BS and Codes of Practice at the time of installation.
Finishes to be robust and good quality throughout.
Structural Design/calculations to be prepared by approved appointed Specialist Consultant.
Mechanical/Electrical services Designs/calculations to be prepared by approved appointed Specialist Consultant.
Surface spread of flame rating to all internal finishes - walls/ceilings to comply to BS476
Laminate SSF to be class O finish on class O mdf substrate.
Fire characteristics for furniture, fabrics & floor finishes to be submitted independently for approval.
Upholstered seating to be fireproofed to BS582 Part 2 (1992). Filling, where applicable, should be in combustion modified heat resistant foam and all usage should be marked on appropriate items.
Doors/door sets to comply with specified fire resistances. All fire resistant doors to be defined and tested to show compliance with BS476 Part 2 (1987) and other relevant parts of BS476.
Door construction to be of a type that furnes emitted by the material under low fire load are of minimal toxidity.
Door fire protection ironmongery shall comply with the requirements of BS476 and be fully certified.
Safety glass and manifestation - glazing to be toughened/laminated and kite marked in accordance with current relevant BS

Design Safety Guidelines

Timber to be certified as being from a sustainable source.

All materials/finishes to be robust, easily cleaned & maintained.

No micro fibrous materials to be used.

Formaldehyde to be avoided in materials which can emit toxic or irritants under general usage.

Refrigerants and Ozone depleting materials including those containing CFC's are to be avoided.

Timber is to be treated to minimize migrate attack, loss of structural strength from sunlight, fire, insect, vermin or moisture.

Treatment to be fully compilant with non poisonous & health affecting requirements.

All paints and solvents should wherever possible be workshop applied.

Water based products should be specified if applicable.

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Birmingham London
Suite 214, Fort Dunlop
Birmingham B24 9FD London E15 2JS


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Brondes Age 328 Kilburn High Rd London NW6 2QN Drawing Title

First Floor General Arrangement

20.01.16 Scale 1:50 Job No. 1677

Drawing Number 1677-03

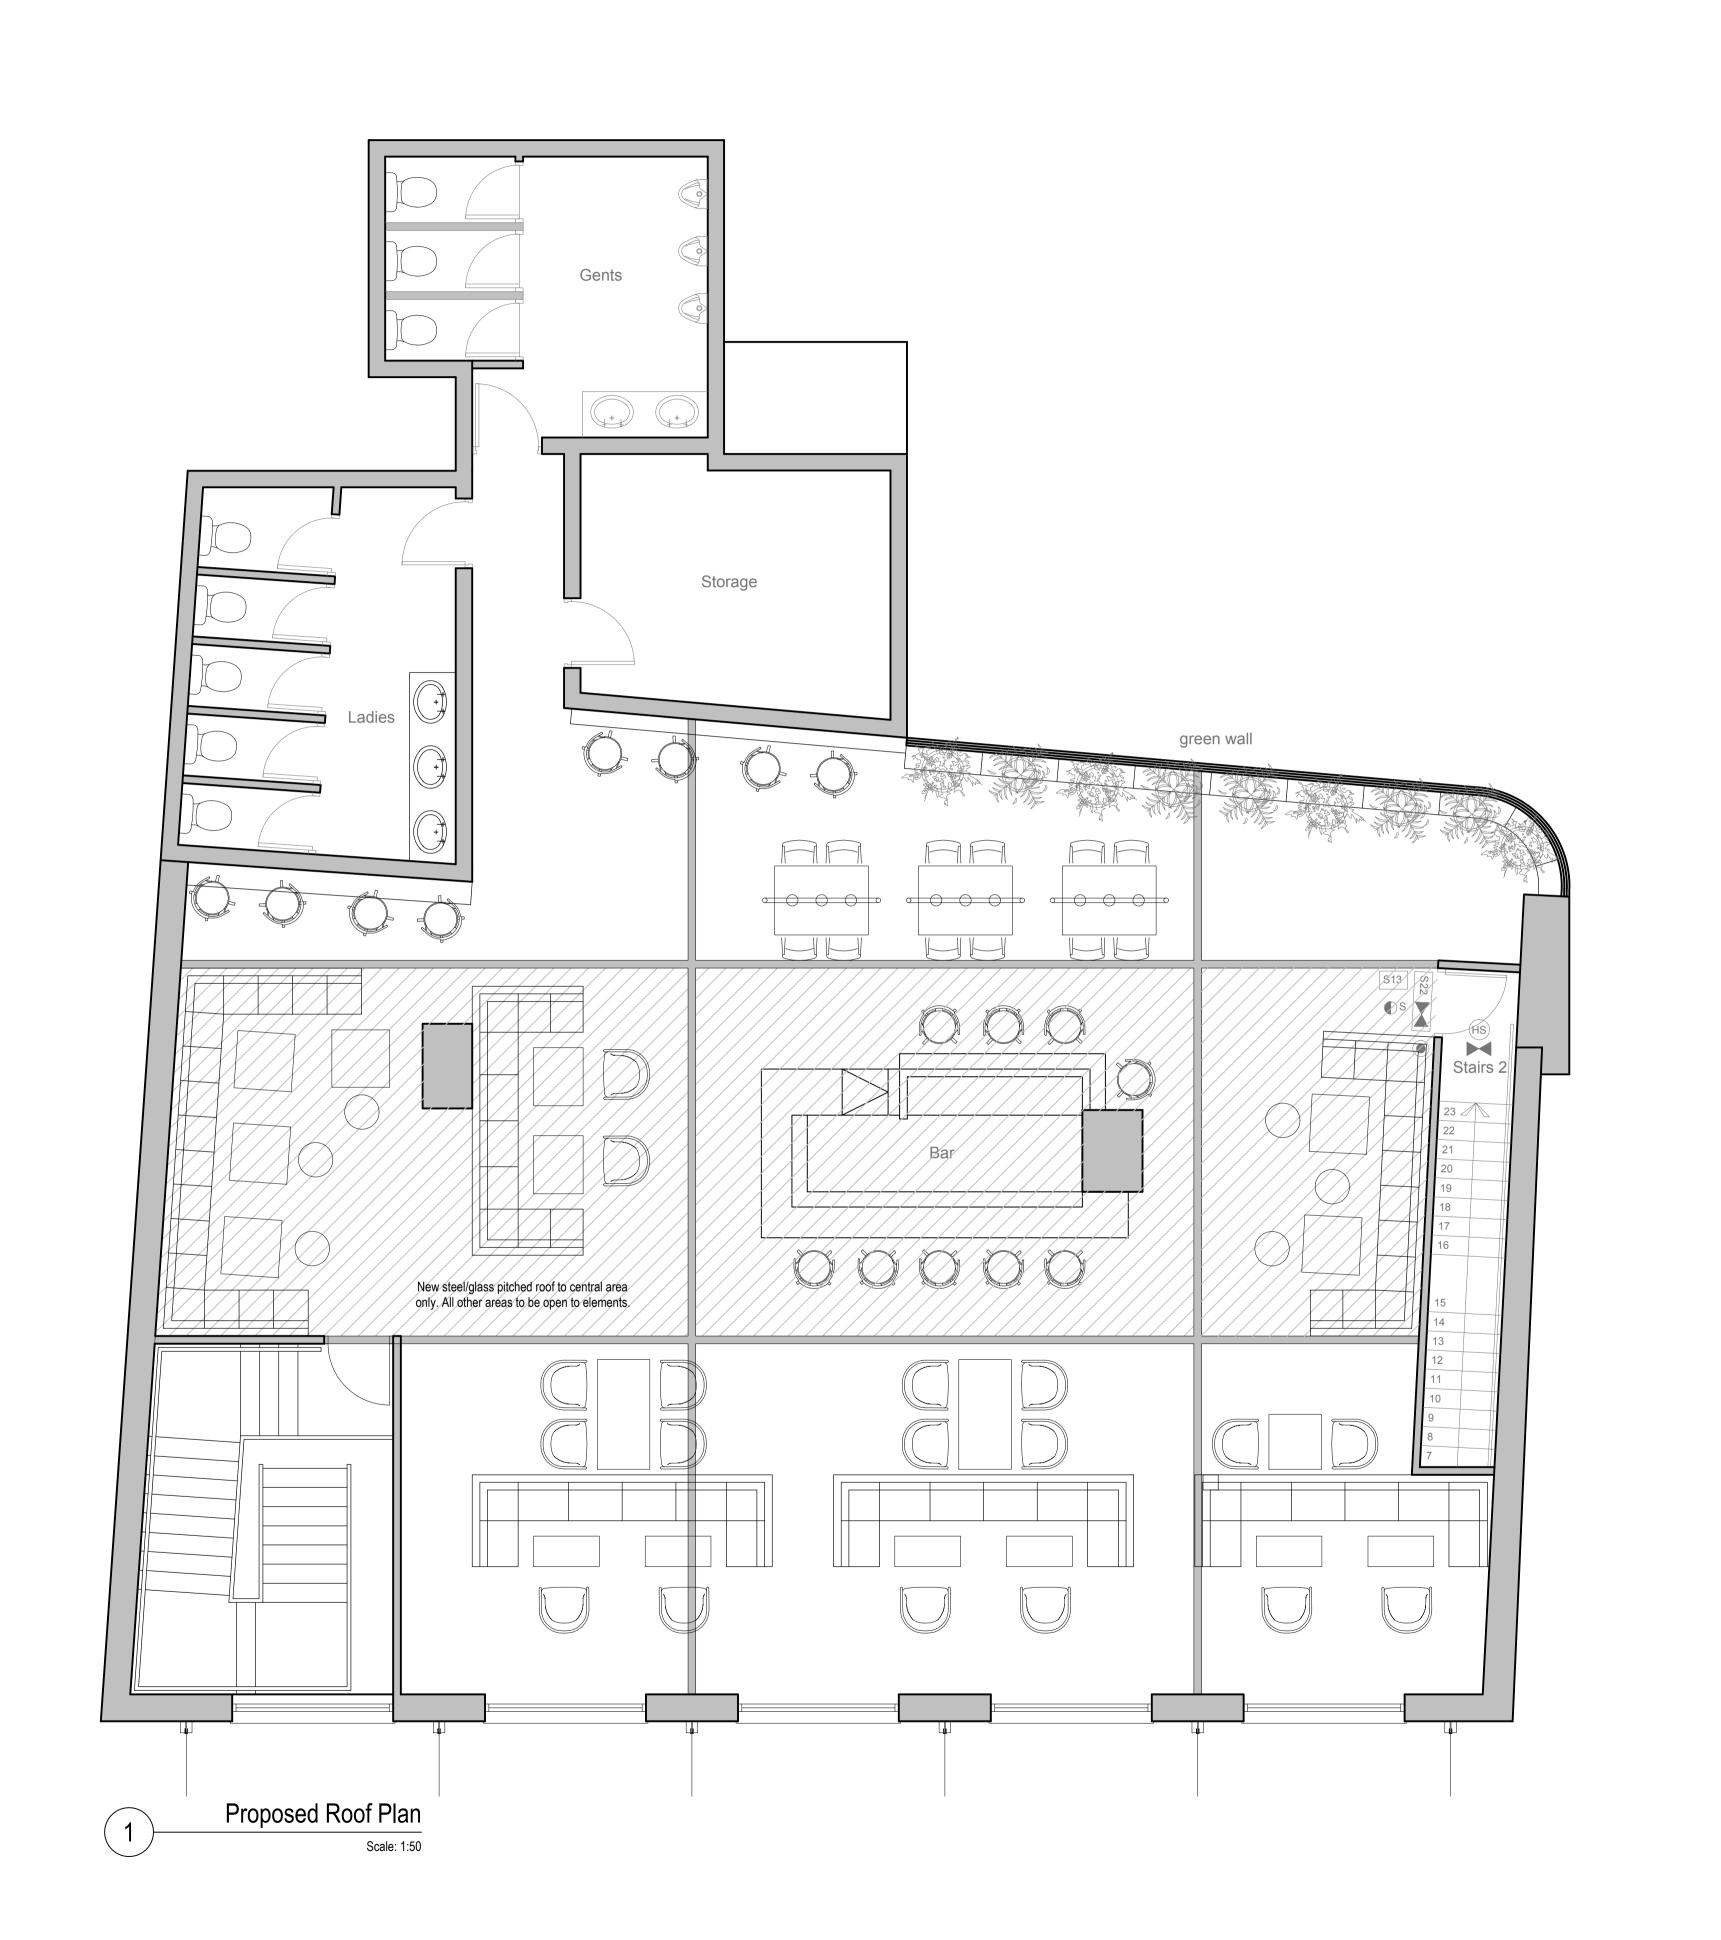

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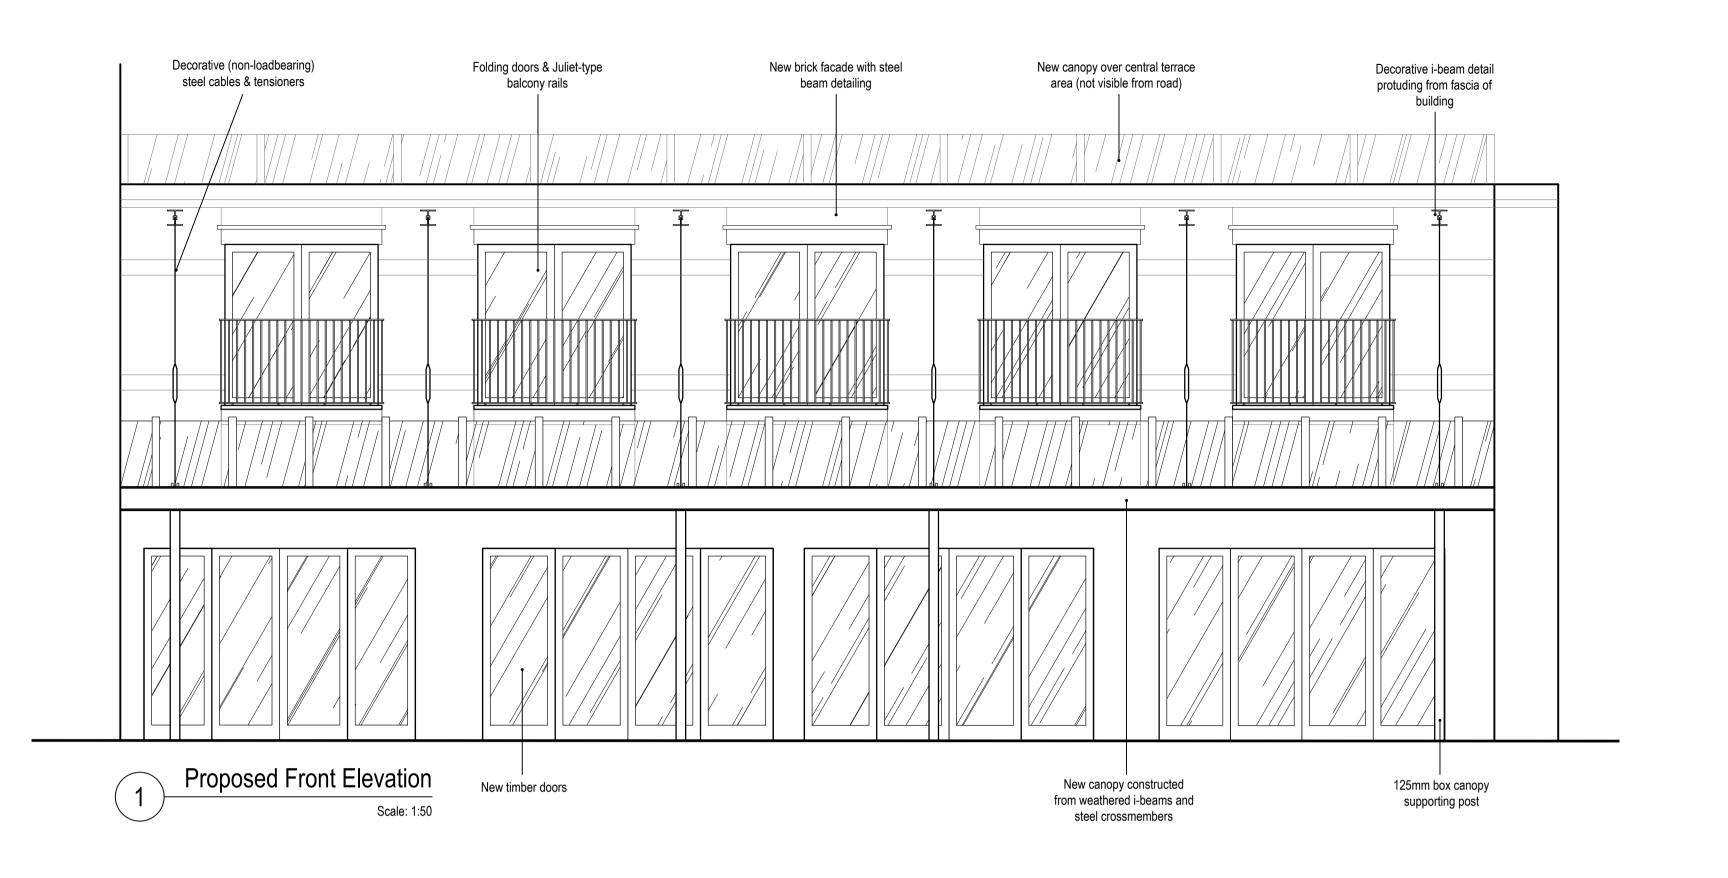
Brian Mannion


Brondes Age 328 Kilburn High Rd London NW6 2QN


Roof Structural Plan

20.01.16 1:50 Job No. 1677

Drawing Number 1677-04



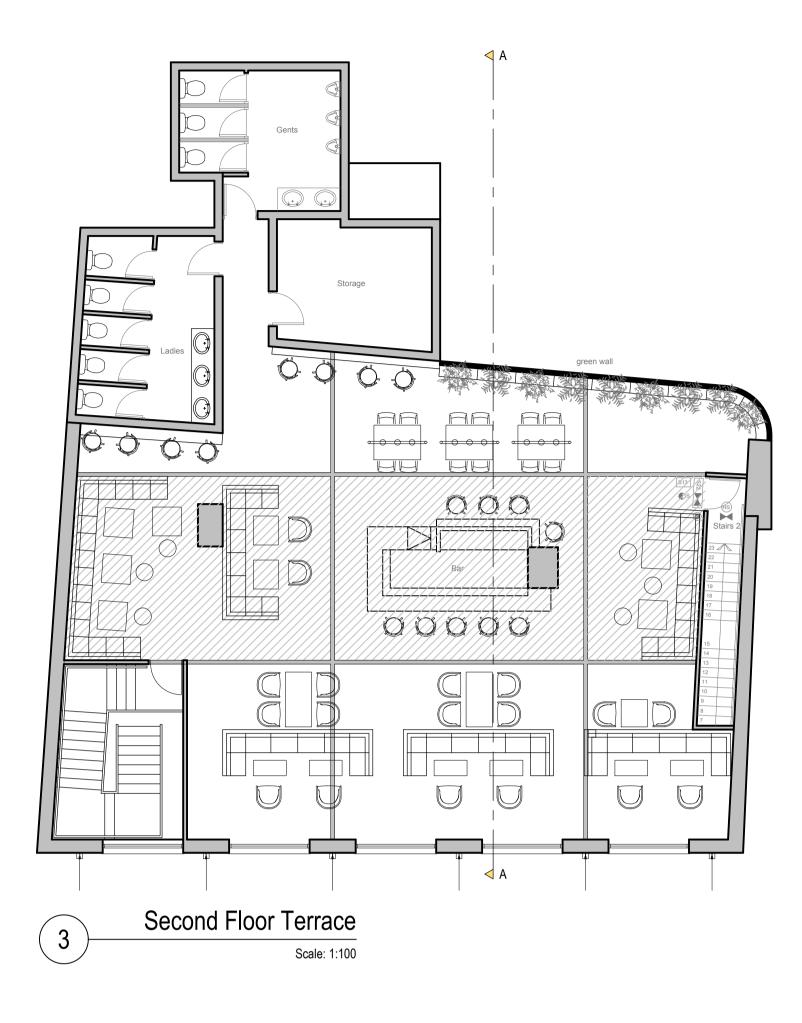

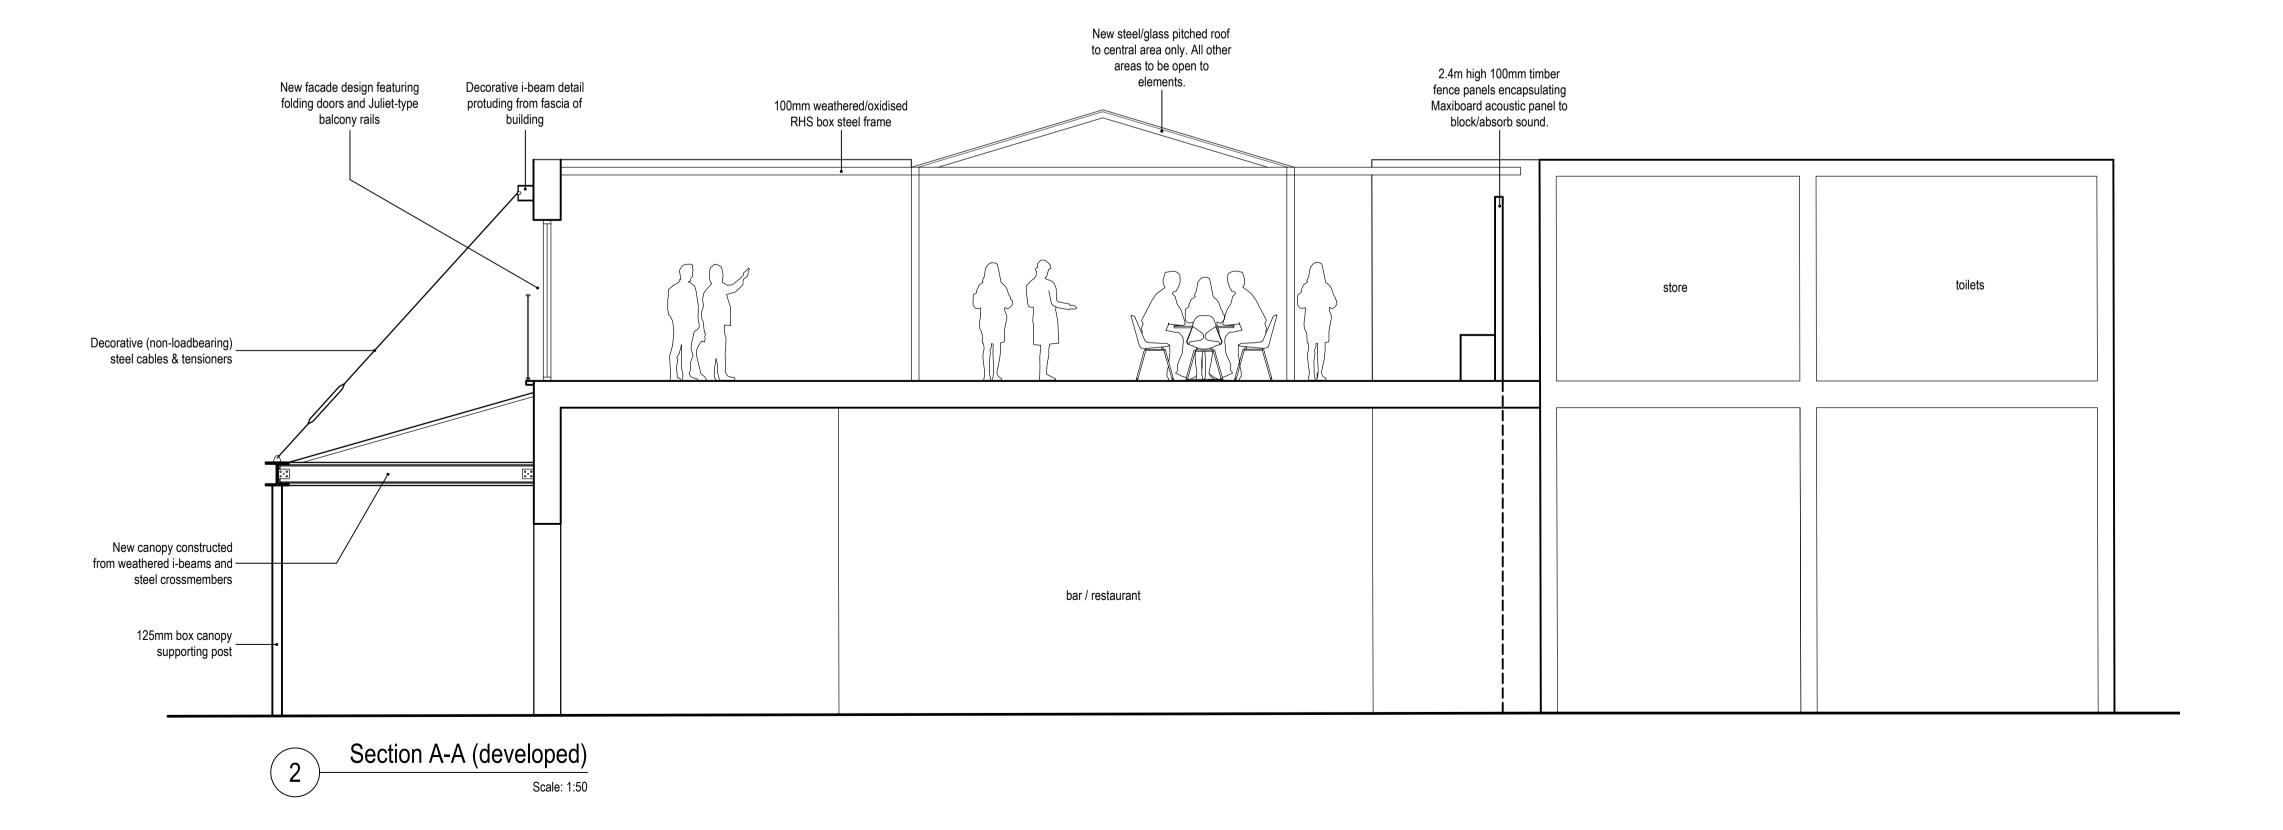

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 Door construction to be of a type that fumes emitted by the material under low fire load are of minimal toxidity.
 Door fire protection ironmongery shall comply with the requirements of BS476 and be fully certified.
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Birmingham
Suite 214, Fort Dunlop
Birmingham B24 9FD
London
42 Warton Road
London E15 2JS T: +44 (0) 121 747 1111 T: +44 (0) 20 8519 4294 E: info@tibbatts.com
W: www.tibbattsabel.com
W: www.tibbattsabel.com

Brian Mannion

Brondes Age 328 Kilburn High Rd London NW6 2QN Drawing Title

Proposed Elevations

20.01.16 Scale 1:50 Job No. 1677 Revisions Description

EXTERNAL FACADE

