



Under stairs cupboard

Radiator cover

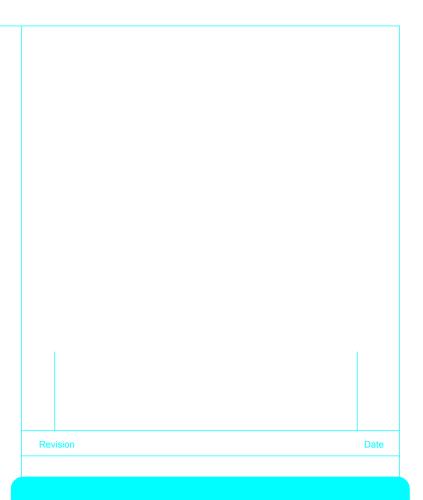


# Building survey legend[9.99]Finished floor level to survey datumC[9.99]Ceiling level to survey datumC(9.99)Ceiling height from finished floorB[9.99]Beam level to survey datumB(9.99)Beam soffit height from finished floorD[9.99]Door head level to survey datumD(9.99)Door head height from finished floorS[9.99]Window sill level to survey datumS(9.99)Window sill height from finished floorH[9.99]Window head height from finished floorH[9.99]Window head level to survey datumH(9.99)Window head height from finished floorA[9.99][9.99]Arch max & min levels to survey datumA(9.99)(9.99)Arch max & min heights from finished floor

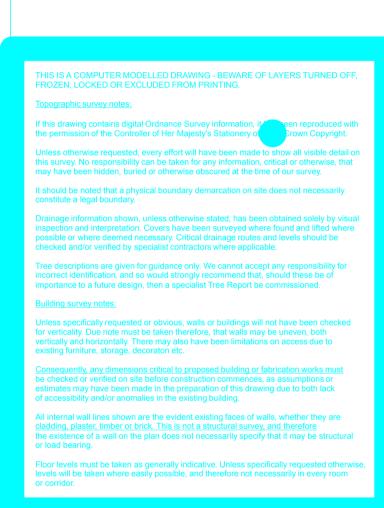


# Levels related to OSBM situated on wall at junction of Shoot Up Hill and Walm Lane, value 52.818m


Project: The Mulberry House School, Minster Road, LONDON NW2	
<sup>Client:</sup> The Mulberry House Sh	าออไ
Drawing title:	
Floor plans - sheet 1 of	3
Ground floor plan	
Scale:	Date:
1:50	May 2015
Drawing Number:	Revision:
2655/1	
Michael Godfrey S	urveys Ltd.
Land and measured bu	ilding surveys
17 Woodgate Way South, Eastfield Industrial Cerr Maple House, High Street, Potters Bar, Cavell House, Stannard Place, St. Crispins	, Hertfordshire, EN6 5BS
Tel: 01592 Fax: 01592	

Mob: 07802 501641 www.michaelgodfreysurveys.com

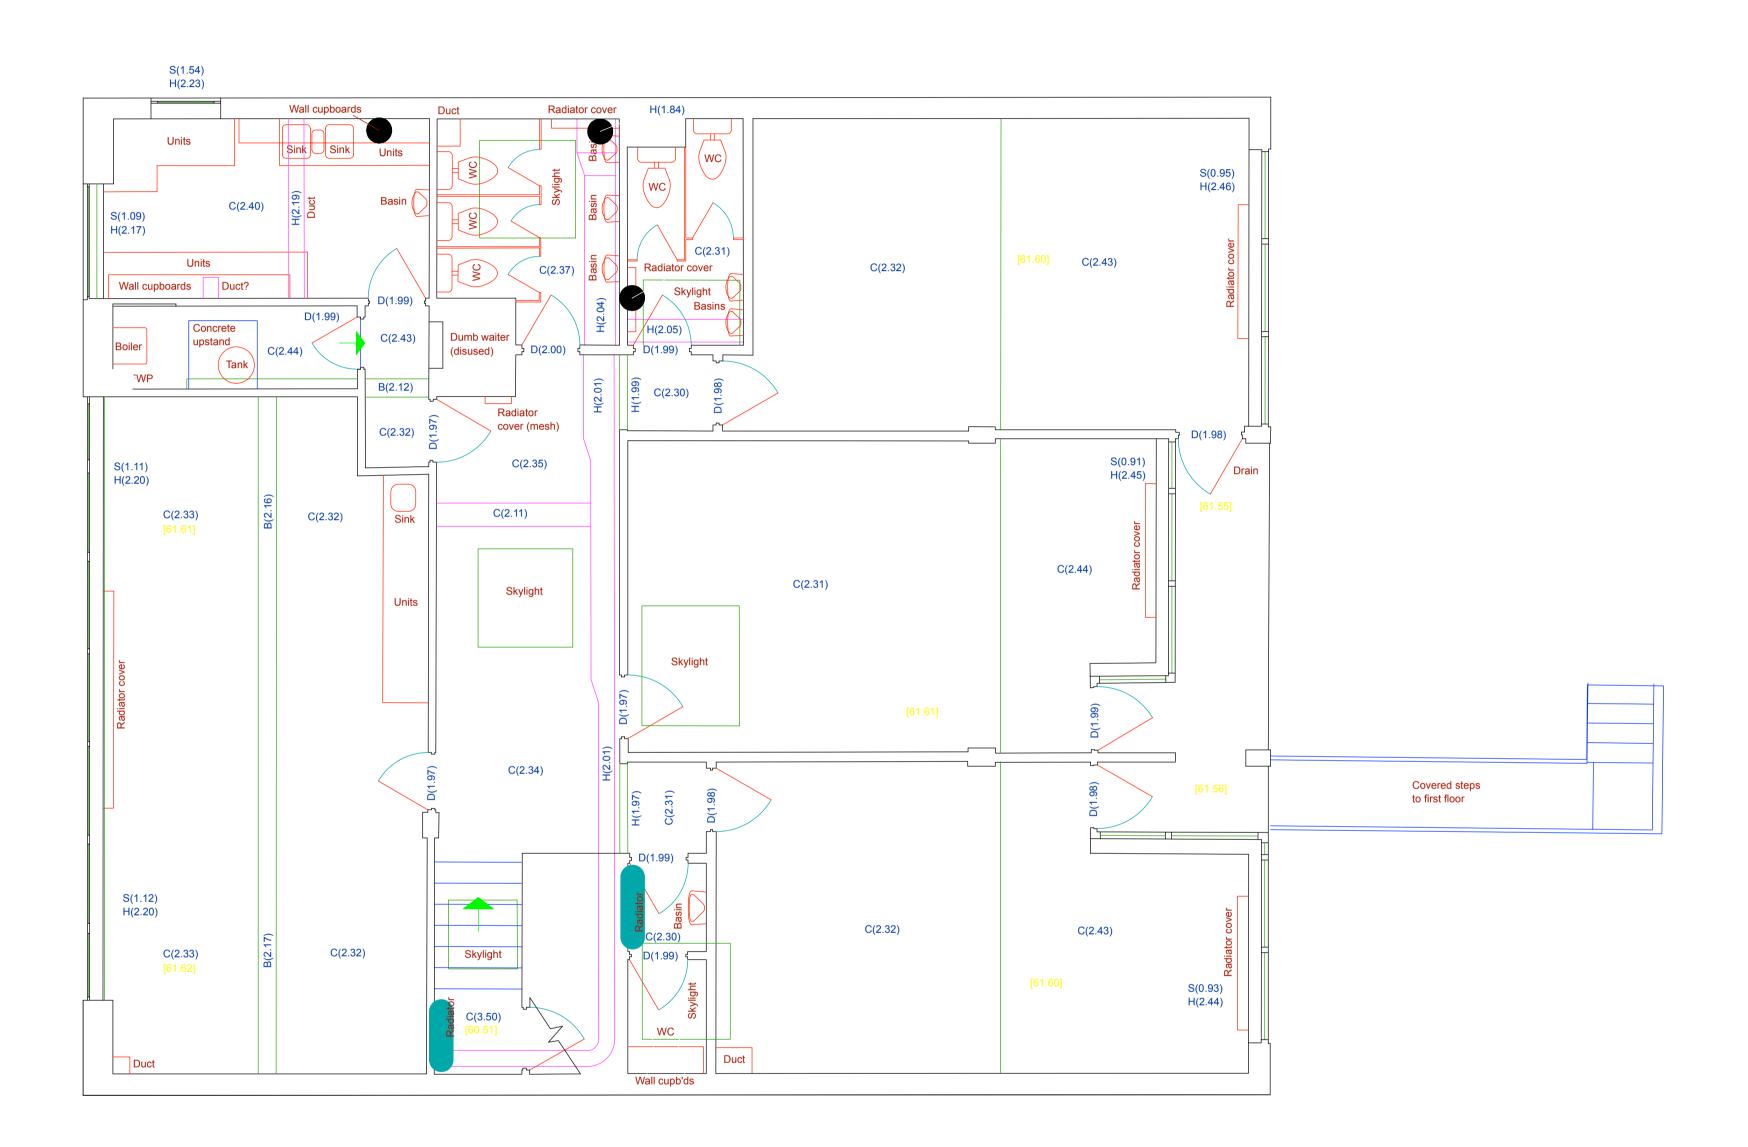

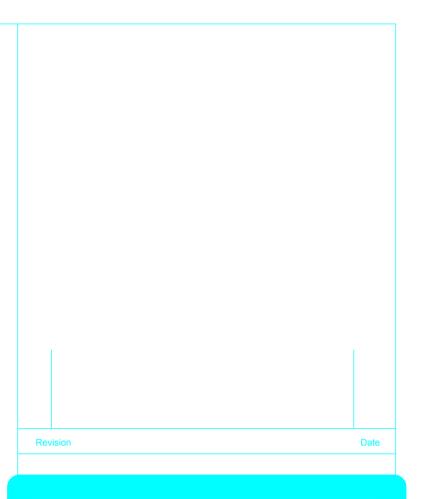

# Building survey legend[9.99]Finished floor level to survey datumC[9.99]Ceiling level to survey datumC(9.99)Ceiling height from finished floorB[9.99]Beam level to survey datumB(9.99)Beam soffit height from finished floorD[9.99]Door head level to survey datumD(9.99)Door head height from finished floorS[9.99]Window sill level to survey datumS(9.99)Window sill height from finished floorH[9.99]Window head level to survey datumH(9.99)Window head height from finished floorA[9.99][9.99]Arch max & min levels to survey datumA(9.99)(9.99)Arch max & min heights from finished floor

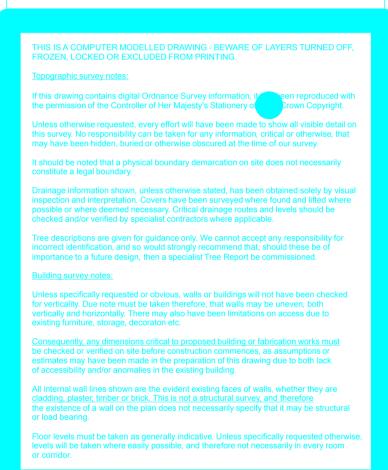



# Levels related to OSBM situated on wall at junction of Shoot Up Hill and Walm Lane, value 52.818m

# The Mulberry House School, Minster Road, LONDON NW2 Client: The Mulberry House Shool rawing title: Floor plans - sheet 2 of 3 First floor plan Date: Scale: 1:50 May 2015 Drawing Number: Revision: 2655/2 Michael Godfrey Surveys Ltd. Land and measured building surveys aple House, High Street, Potters Bar, Hertfordshire, EN6 5BS House, Stannard Place, St. Crispins Road, Norwich, NR3 1YE

Tel: 01592 770007 Fax: 01592 779193 Mob: 07802 501641

www.michaelgodfreysurveys.com

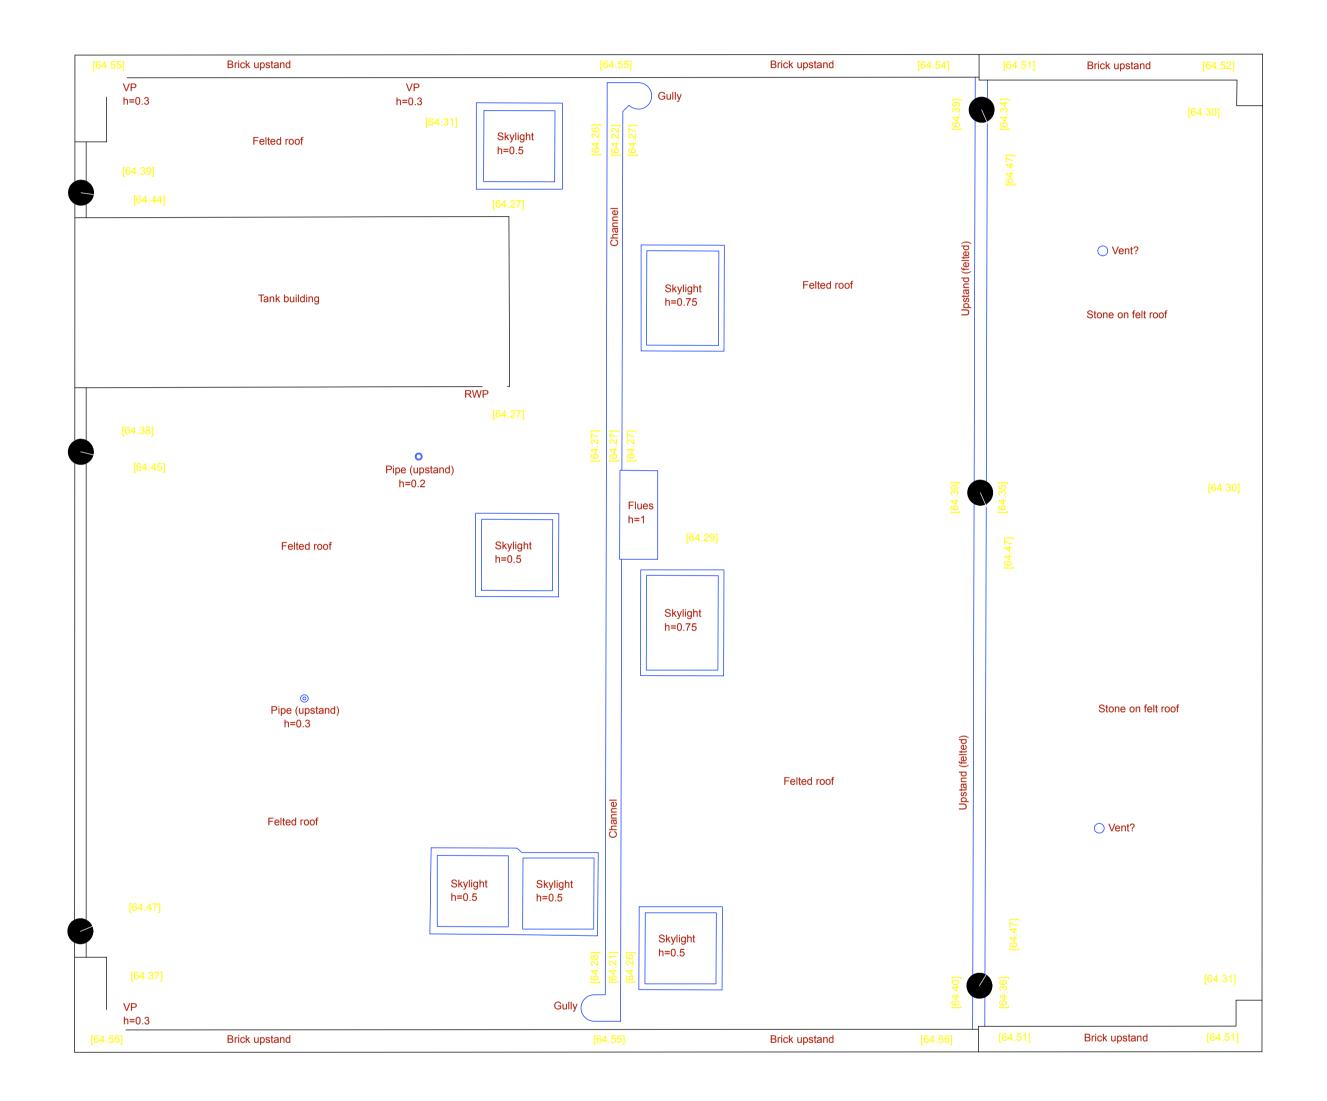

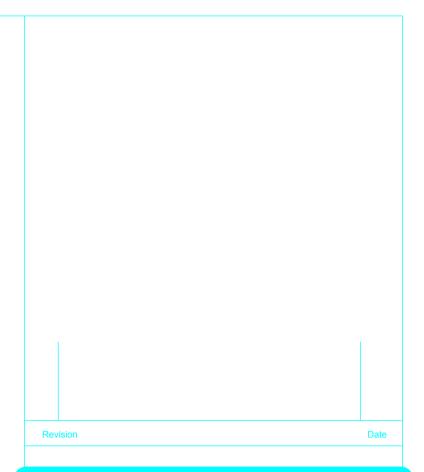

## ding survey legend C(9.99) Ceiling height from finished floor B(9.99) Beam soffit height from finished floor D(9.99) Door head height from finished floor S(9.99) Window sill height from finished floor H(9.99) Window head height from finished floor A(9.99)(9.99) Arch max & min heights from finished floor

# Levels related to OSBM situated on wall at junction of Shoot Up Hill and Walm Lane, value 52.818m

# Project: The Mulberry House School, Minster Road, LONDON NW2

Client: The Mulberry House Shool

Drawing title:

Floor plans - sheet 3 of 3 Roof plan

Scale: 1:50

Date: May 2015


Drawing Number:


2655/3

Revision:


Michael Godfrey Surveys Ltd.

Land and measured building surveys Maple House, High Street, Potters Bar, Hertfordshire, EN6 5BS ell House, Stannard Place, St. Crispins Road, Norwich, NR3 1YE

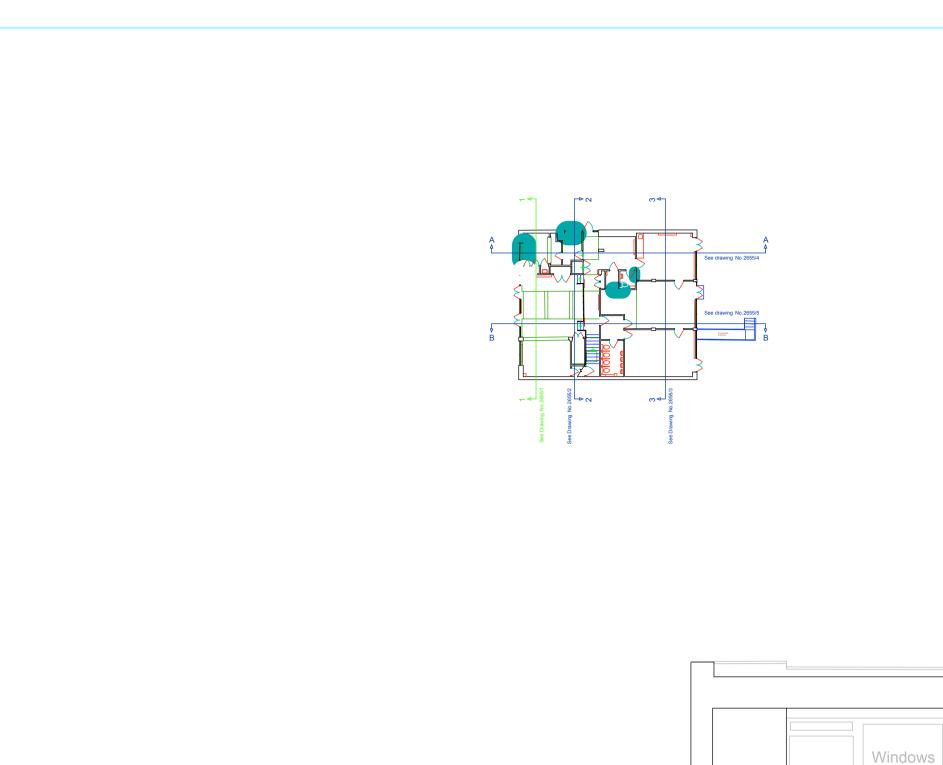

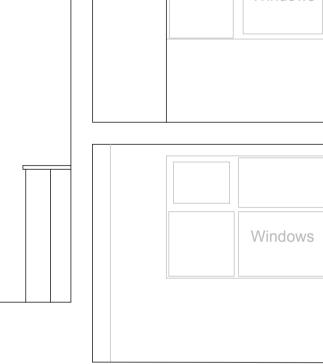



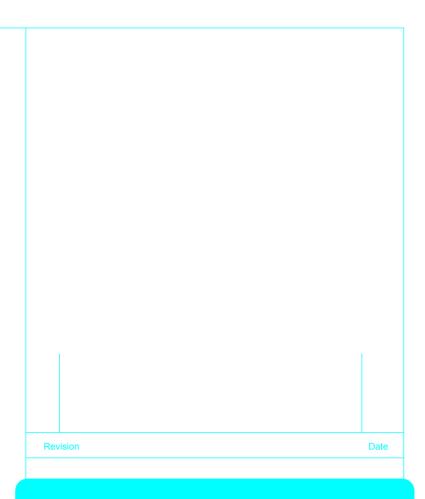

## ding survey legend C[9.99]Ceiling level to survey datumC(9.99)Ceiling height from finished floor B(9.99) Beam soffit height from finished floor D(9.99) Door head height from finished floor S(9.99) Window sill height from finished floor H(9.99) Window head height from finished floor A(9.99)(9.99) Arch max & min heights from finished floor

THIS IS A COMPUTER MODELLED DRAWING - BEWARE OF LAYERS TURNED OFI FROZEN, LOCKED OR EXCLUDED FROM PRINTING.	ŝ,
Topographic survey notes:	
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Unless otherwise requested, every effort will have been made to show all visible detail on this survey. No responsibility can be taken for any information, critical or otherwise, that may have been hidden, buried or otherwise obscured at the time of our survey.	
It should be noted that a physical boundary demarcation on site does not necessarily	

# Levels related to OSBM situated on wall at junction of Shoot Up Hill and Walm Lane, value 52.818m

# Project: The Mulberry House School, Minster Road, LONDON NW2

Client: The Mulberry House Shool

Drawing title:

Sections - sheet 1 of 5 Section 1-1

Scale: 1:50

Drawing Number: 2655/21


June 2015


Revision:


Date:


Michael Godfrey Surveys Ltd. Land and measured building surveys 17 Woodgate Way South, Eastfield Industrial Centre, Glenrothes, Fife, KY7 4PF Maple House, High Street, Potters Bar, Hertfordshire, EN6 5BS Cavell House, Stannard Place, St. Crispins Road, Norwich, NR3 1YE

Tel: 01592 770007 Fax: 01592 779193 Mob: 07802 501641

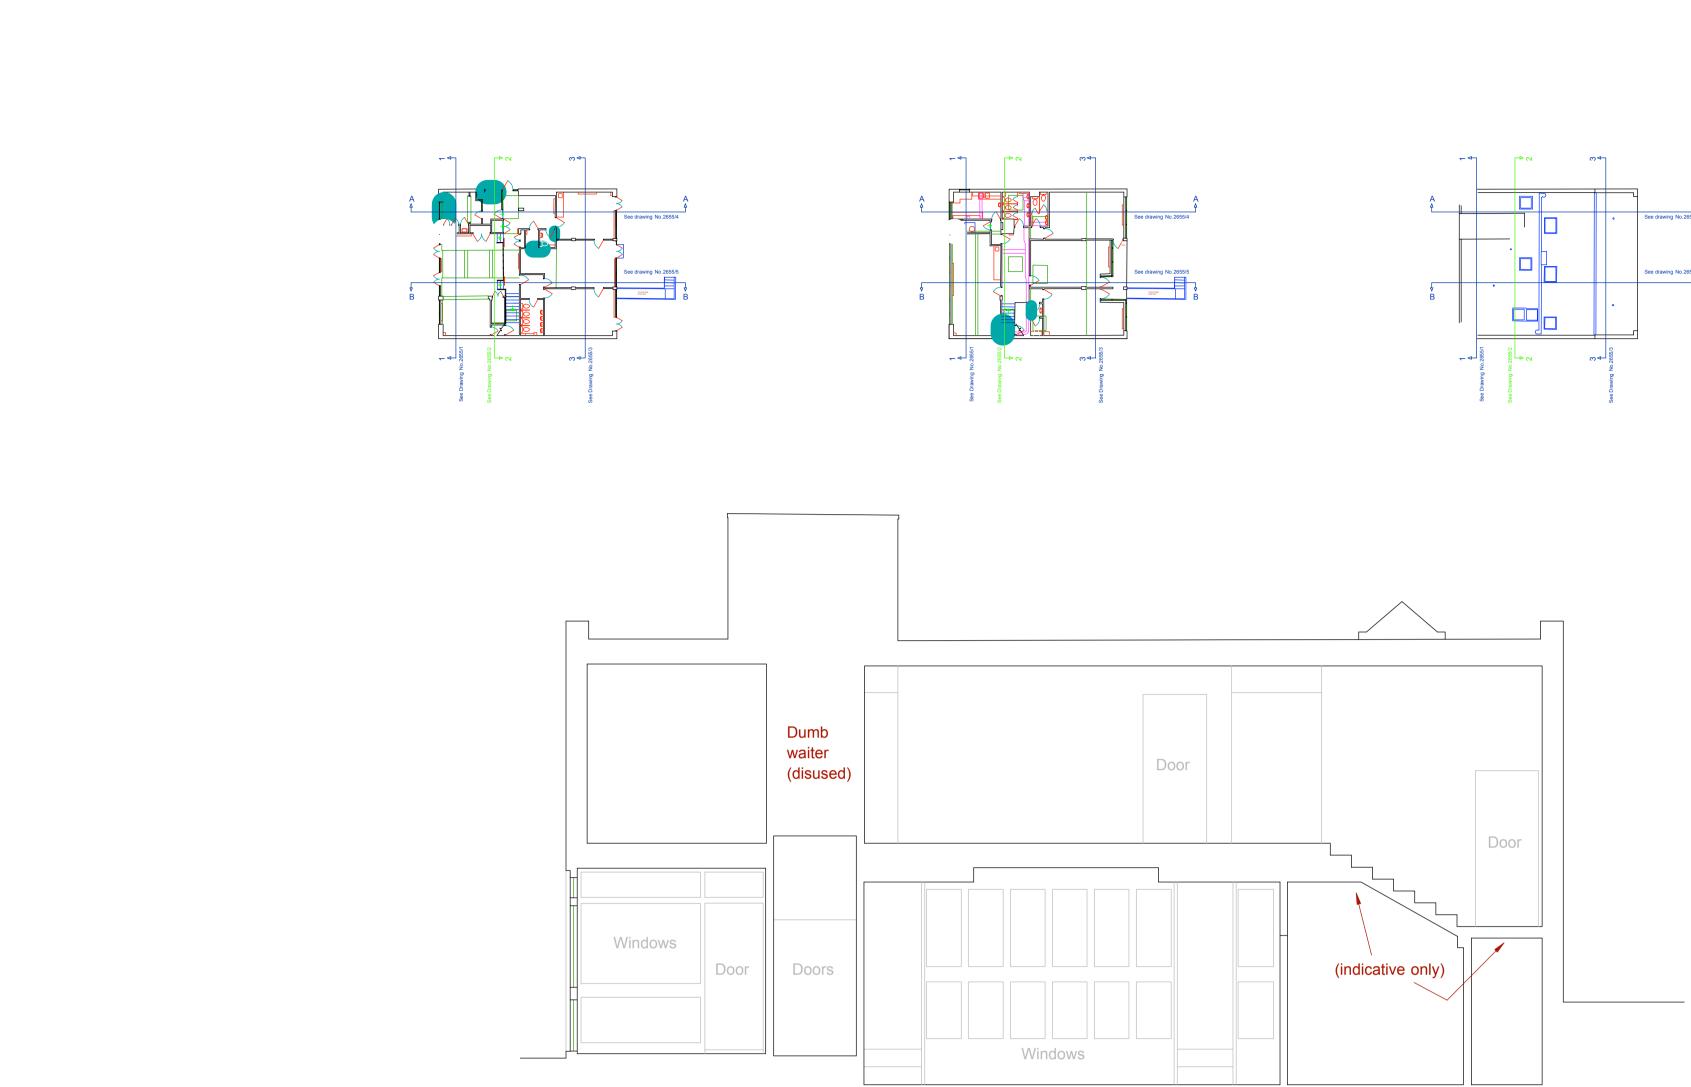

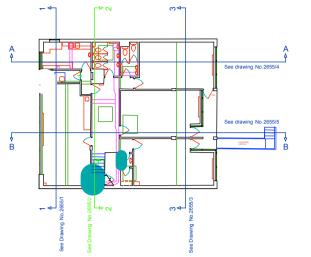

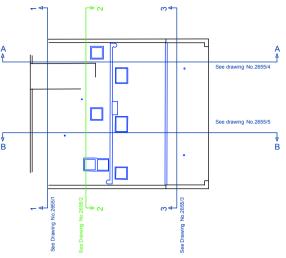

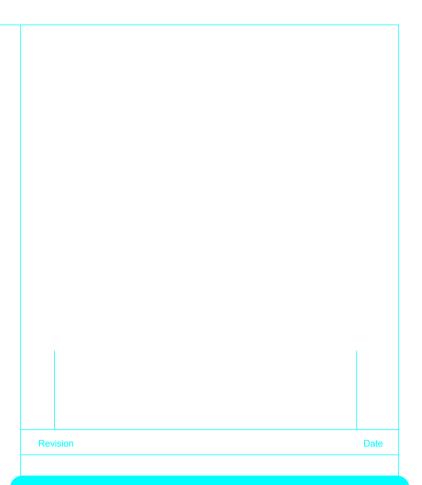

### ig survey legend

C(9.99)	Ceiling height from finished floor
B[9.99]	Beam level to survey datum
B(9.99)	Beam soffit height from finished floor
D(9.99)	Door head height from finished floor
S[9.99]	Window sill level to survey datum
S(9.99)	Window sill height from finished floor
H(9.99)	Window head height from finished floor
A(9.99)(9.99)	Arch max & min heights from finished floor

ue to both lack g building.

# Levels related to OSBM situated on wall at junction of Shoot Up Hill and Walm Lane, value 52.818m

# Project: The Mulberry House School, Minster Road, LONDON NW2

Client: The Mulberry House Shool

Drawing title:

Sections - sheet 2 of 5 Section 2-2

### Scale: 1:50

June 2015

Drawing Number: 2655/22

Date:

Revision:


Michael Godfrey Surveys Ltd. Land and measured building surveys


gate Way South, Eastfield Industrial Centre, Glenrothes, Fife, KY7 4PF Maple House, High Street, Potters Bar, Hertfordshire, EN6 5BS vell House, Stannard Place, St. Crispins Road, Norwich, NR3 1YE










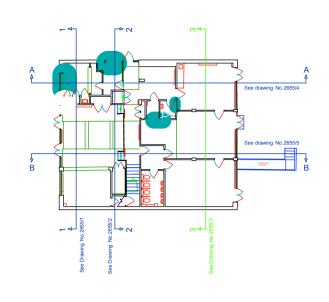

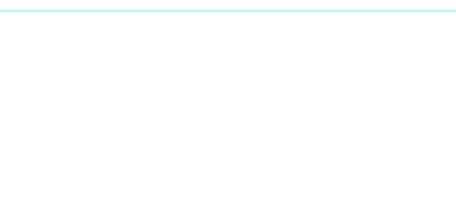

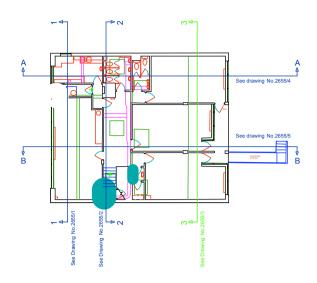

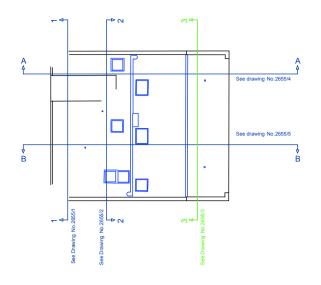

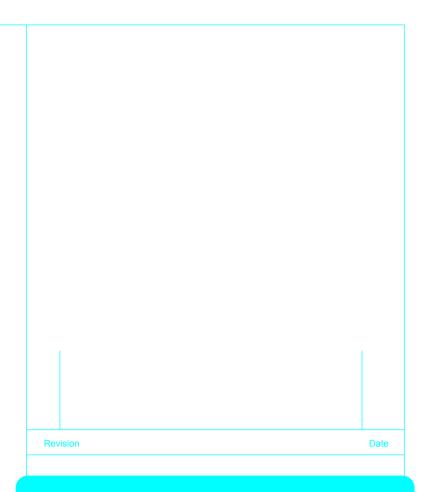

C(9.99)	Ceiling height from finished floor
B(9.99)	Beam soffit height from finished floor
D(9.99)	Door head height from finished floor
S(9.99)	Window sill height from finished floor
H(9.99)	Window head height from finished floor
A(9.99)(9.99)	Arch max & min heights from finished floor
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vion commences, as assumptions or vion of this drawing due to both lack building.

# Levels related to OSBM situated on wall at junction of Shoot Up Hill and Walm Lane, value 52.818m

# Project: The Mulberry House School, Minster Road, LONDON NW2

Client: The Mulberry House Shool

Drawing title:

Sections - sheet 3 of 5 Section 3-3

1:50

Scale:

June 2015

Revision:

Date:

Drawing Number: 2655/23


# Michael Godfrey Surveys Ltd. Land and measured building surveys


odgate Way South, Eastfield Industrial Centre, Glenrothes, Fife, KY7 4PF Maple House, High Street, Potters Bar, Hertfordshire, EN6 5BS Cavell House, Stannard Place, St. Crispins Road, Norwich, NR3 1YE


Tel: 01592 770007 Fax: 01592 779193 Mob: 07802 501641


michaelgodfreysurveys.com




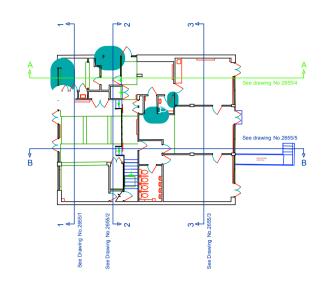

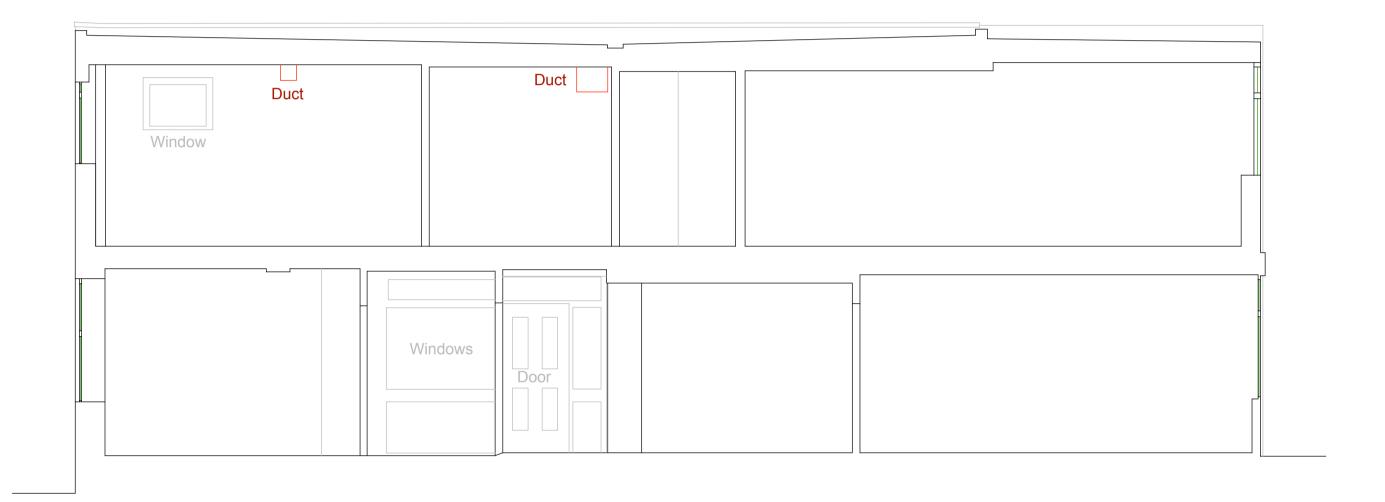

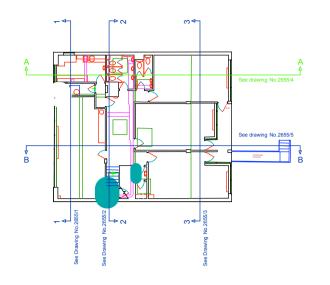

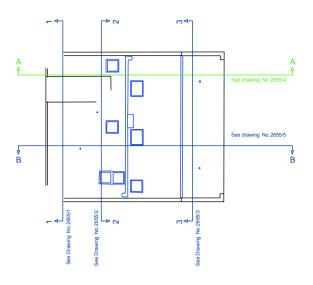

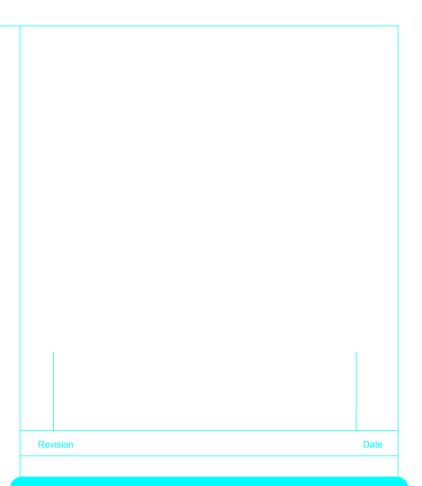

### ng survey legend

C(9.99)	Ceiling height from finished floor
B(9.99)	Beam soffit height from finished floor
D(9.99)	Door head height from finished floor
S(9.99)	Window sill height from finished floor
H(9.99)	Window head height from finished floor
A(9.99)(9.99)	Arch max & min heights from finished floor

e to both lack

# Levels related to OSBM situated on wall at junction of Shoot Up Hill and Walm Lane, value 52.818m

# Project: The Mulberry House School, Minster Road, LONDON NW2

Client: The Mulberry House Shool

Drawing title:

Sections - sheet 4 of 5 Section A-A

Scale:

1:50


Date:


June 2015

Drawing Number: 2655/24

Revision:


Michael Godfrey Surveys Ltd. Land and measured building surveys ate Way South, Eastfield Industrial Centre, Glenrothes, Fife, KY7 4PF Maple House, High Street, Potters Bar, Hertfordshire, EN6 5BS xell House, Stannard Place, St. Crispins Road, Norwich, NR3 1YE

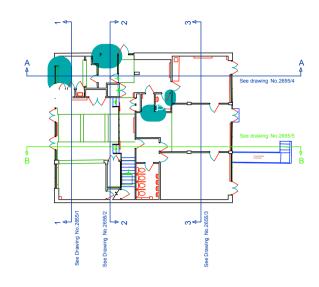


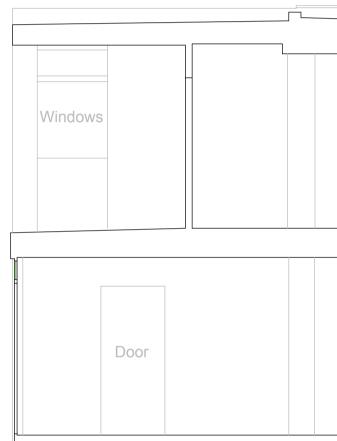


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# 



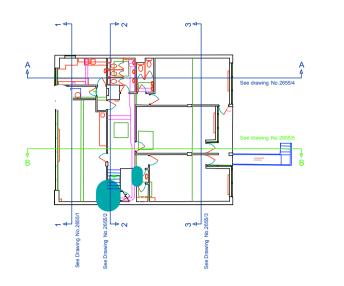

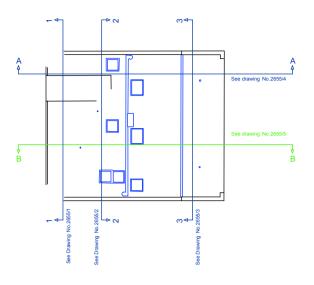	Duct	
Door	Door	

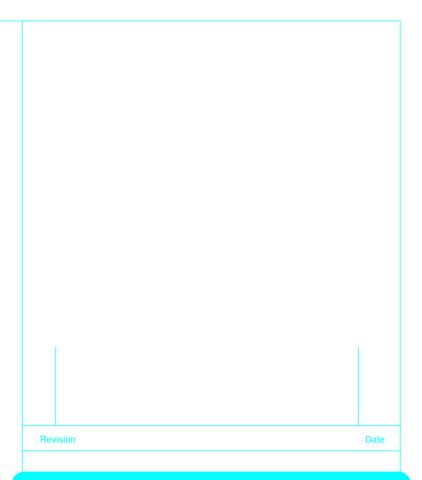

# <u>ding survey legend</u> C(9.99) Ceiling height from finished floor B(9.99) Beam soffit height from finished floor D(9.99) Door head height from finished floor S(9.99) Window sill height from finished floor H(9.99) Window head height from finished floor A(9.99)(9.99) Arch max & min heights from finished floor

s, as assumptions or wing due to both lack

# Levels related to OSBM situated on wall at junction of Shoot Up Hill and Walm Lane, value 52.818m

# roject: Project: The Mulberry House School, Minster Road, LONDON NW2

The Mulberry House Shool

wing title:

Sections - sheet 5 of 5 Section B-B

cale: 1:50

Date: June 2015


Drawing Number: 2655/25

Revision:

Michael Godfrey Surveys Ltd. Land and measured building surveys

lgate Way South, Eastfield Industrial Centre, Glenrothes, Fife, KY7 4PF Maple House, High Street, Potters Bar, Hertfordshire, EN6 5BS avell House, Stannard Place, St. Crispins Road, Norwich, NR3 1YE



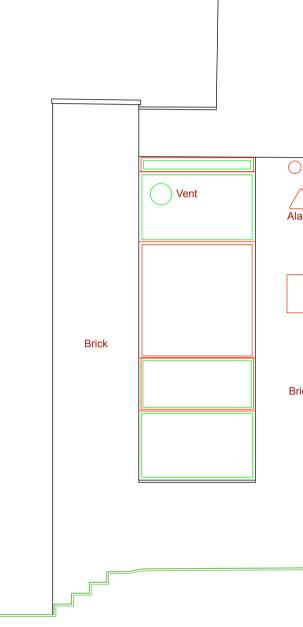

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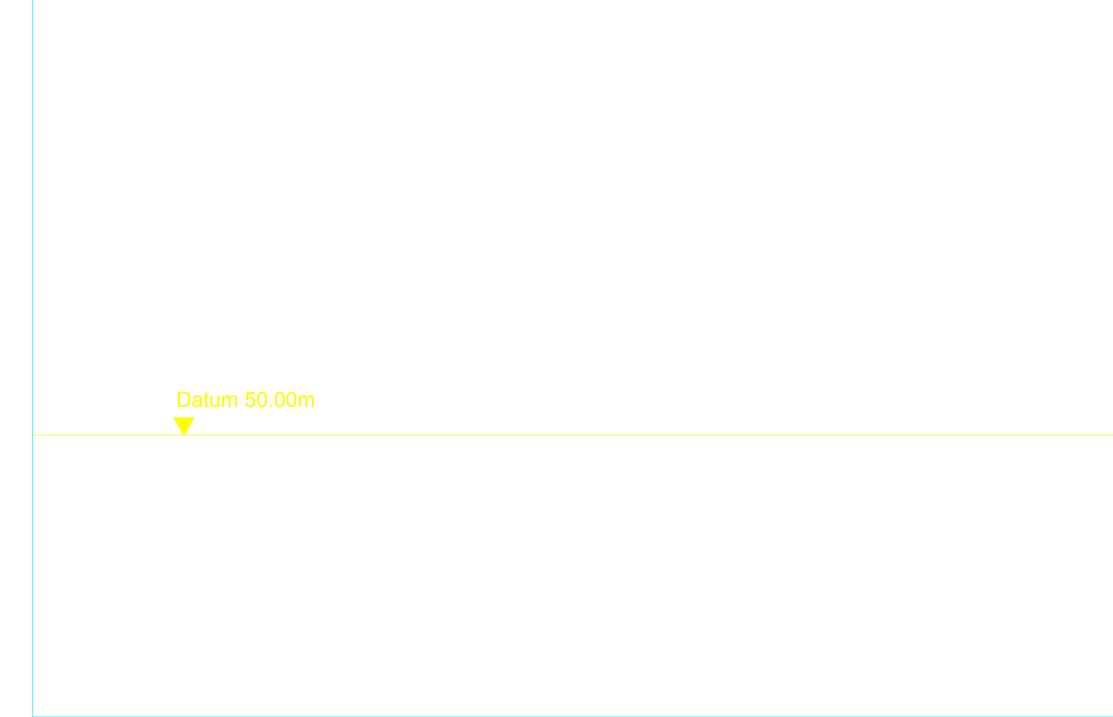
Datum 50.00m


Front (SW) elevation

Datun


Flue						
Alarm						
Vent	Light	Light			Brick	
Brick						
			1	Brick		
Gas pipe						
					\	

	Building survey legend
	[9.99]Finished floor level to survey datumC[9.99]Ceiling level to survey datumC(9.99)Ceiling height from finished floorB[9.99]Beam soffit height from finished floorD[9.99]Door head level to survey datumD(9.99)Door head level to survey datumD(9.99)Door head level to survey datumS(9.99)Window sill level to survey datumS(9.99)Window sill level to survey datumH[9.99]Window head level to survey datumH(9.99)Window head level to survey datumH(9.99)Window head height from finished floorA[9.99][9.99]Arch max & min levels to survey datumA(9.99)(9.99)Arch max & min heights from finished floor
	THIS IS A COMPUTER MODELLED DRAWING - BEWARE OF LAYERS TURNED OFF, FROZEN, LOCKED OR EXCLUDED FROM PRINTING. <u>Topographic survey notes:</u> If this drawing contains digital Ordnance Survey information, it has been reproduced with the permission of the Controller of Her Majesty's Stationery office Crown Copyright.
	<ul> <li>Unless otherwise requested, every effort will have been made to show all visible detail on this survey. No responsibility can be taken for any information, critical or otherwise, that may have been hidden, buried or otherwise obscured at the time of our survey.</li> <li>It should be noted that a physical boundary demarcation on site does not necessarily constitute a legal boundary.</li> <li>Drainage information shown, unless otherwise stated, has been obtained solely by visual inspection and interpretation. Covers have been surveyed where found and lifted where possible or where deemed necessary. Critical drainage routes and levels should be checked and/or verified by specialist contractors where applicable.</li> <li>Tree descriptions are given for guidance only. We cannot accept any responsibility for incorrect identification, and so would strongly recommend that, should these be of importance to a future design, then a specialist Tree Report be commissioned.</li> </ul>
	Building survey notes:         Unless specifically requested or obvious, walls or buildings will not have been checked for verticality. Due note must be taken therefore, that walls may be uneven, both vertically and horizontally. There may also have been limitations on access due to existing furniture, storage, decoraton etc.         Consequently, any dimensions critical to proposed building or fabrication works must be checked or verified on site before construction commences, as assumptions or estimates may have been made in the preparation of this drawing due to both lack of accessibility and/or anomalies in the existing building.         All internal wall lines shown are the evident existing faces of walls, whether they are cladding, plaster, timber or brick. This is not a structural survey, and therefore
	the existence of a wall on the plan does not necessarily specify that it may be structural or load bearing. Floor levels must be taken as generally indicative. Unless specifically requested otherwise, levels will be taken where easily possible, and therefore not necessarily in every room or corridor.
	Levels related to OSBM situated on wall at junction of Shoot Up Hill and Walm Lane, value 52.818m Project: The Mulberry House School,
	Minster Road, LONDON NW2 Client: The Mulberry House Shool Drawing title: External elevations - sheet 1 of 4
0.00m	Front (SW) elevation       Scale:     Date:       1:50     June 2015
	Drawing Number: Revision: 2655/11
	Michael Godfrey Surveys Ltd. Land and measured building surveys17 Voodgate Way South, Eastfield Industrial Centre, Glenrothes, Fife, KY7 4PF Maple House, High Street, Potters Bar, Hertfordshire, EN6 5BS Cavell House, Stannard Place, St. Crispins Road, Norwich, NR3 1YEMichael Godfrey SurveysMichael Street, Potters Bar, Hertfordshire, EN6 5BS Cavell House, Stannard Place, St. Crispins Road, Norwich, NR3 1YEMichael Street, Potters Bar, Hertfordshire, EN6 5BS Cavell House, Stannard Place, St. Crispins Road, Norwich, NR3 1YEMichael Street, Potters Bar, Hertfordshire, EN6 5BS Cavell House, Stannard Place, St. Crispins Road, Norwich, NR3 1YEMichael Street, Potters Bar, Hertfordshire, EN6 5BS Cavell House, Stannard Place, St. Crispins Road, Norwich, NR3 1YEMichael Street, Potters Bar, Hertfordshire, EN6 5BS Cavell House, Stannard Place, St. Crispins Road, Norwich, NR3 1YEMichael Street, Potters Bar, Hertfordshire, EN6 5BS Cavell House, Stannard Place, St. Crispins Road, Norwich, NR3 1YEMichael Street, Potters Bar, Hertfordshire, EN6 5BS Cavell House, Stannard Place, St. Crispins Road, Norwich, NR3 1YEMichael Street, Potters Bar, Hertfordshire, EN6 5BS Cavell House, Stannard Place, St. Crispins Road, Norwich, NR3 1YEMichael Street, Potters Bar, Hertfordshire, EN6 5BS Cavell House, Stannard Place, St. Crispins Road, Norwich, NR3 1YEMichael Street, Potters Bar, Hertfordshire, EN6 5BS Cavell House, Stannard House, St. Crispins Road, Norwich, NR3 1YEMichael Street, Potters Bar, Hertfordshire, EN6 5BS Cavell House, St. Crispins Road, Norwich, NR3 1YEMichael Street, Potters Bar, Hertfordshire, EN6 5BS Cavell House, St. Crispins Road, Norwich, NR3 1YEMichael Street, Potters Bar, Hertford



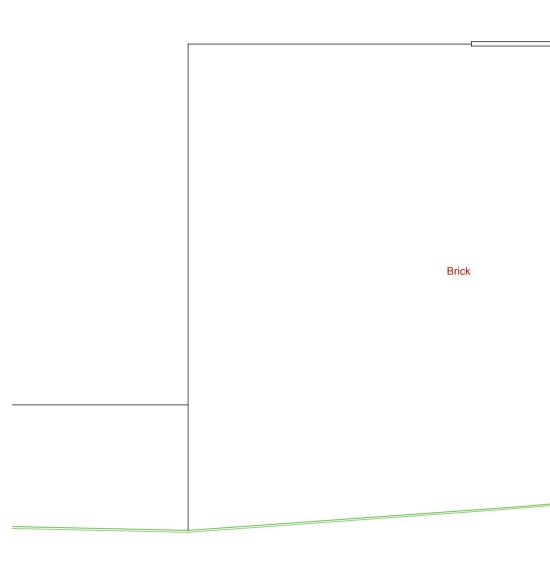



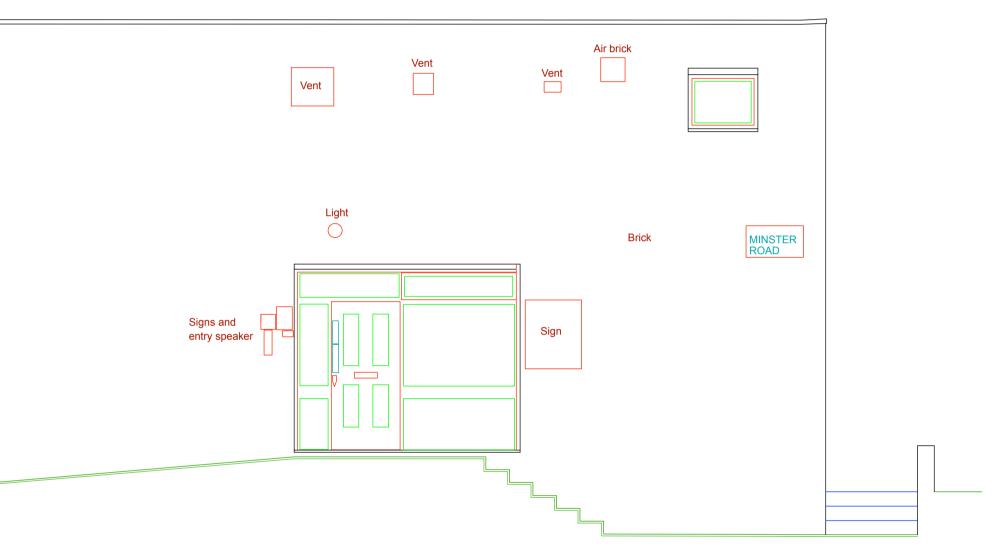

Building	survey	leaend

C(9.99)	Ceiling height from finished floor
B(9.99)	Beam soffit height from finished floor
D(9.99)	Door head height from finished floor
S(9.99)	Window sill height from finished floor
H(9.99)	Window head height from finished floor
A(9.99)(9.99)	Arch max & min heights from finished floor

Consequently, any dimensions critical to proposed building or fabrication works must be checked or verified on site before construction commences, as assumptions or estimates may have been made in the preparation of this drawing due to both lack of accessibility and/or anomalies in the existing building. All internal wall lines shown are the evident existing faces of walls, whether they are cladding, plaster, timber or brick. This is not a structural survey, and therefore the existence of a wall on the plan does not necessarily specify that it may be structural or load bearing. Floor levels must be taken as generally indicative. Unless specifically requested otherwise, levels will be taken where easily possible, and therefore not necessarily in every room or corridor.

Levels related to OSBM situated on wall at junction of Shoot Up Hill and Walm Lane, value 52.818m

Project: The Mulberry House School, Minster Road, LONDON NW2

Client: The Mulberry House Shool

Drawing title:

Scale: **1:50** 

External elevations - sheet 2 of 4 Side (NW) elevation

Date: June 2015

2655/12

Drawing Number:


Revision:

Michael Godfrey Surveys Ltd. Land and measured building surveys 17 Woodgate Way South, Eastfield Industrial Centre, Glenrothes, Fife, KY7 4PF Maple House, High Street, Potters Bar, Hertfordshire, EN6 5BS Cavell House, Stannard Place, St. Crispins Road, Norwich, NR3 1YE

Tel: 01592 770007 Fax: 01592 779193 Mob: 07802 501641


www.michaelgodfreysurveys.com

Datum 50.00m

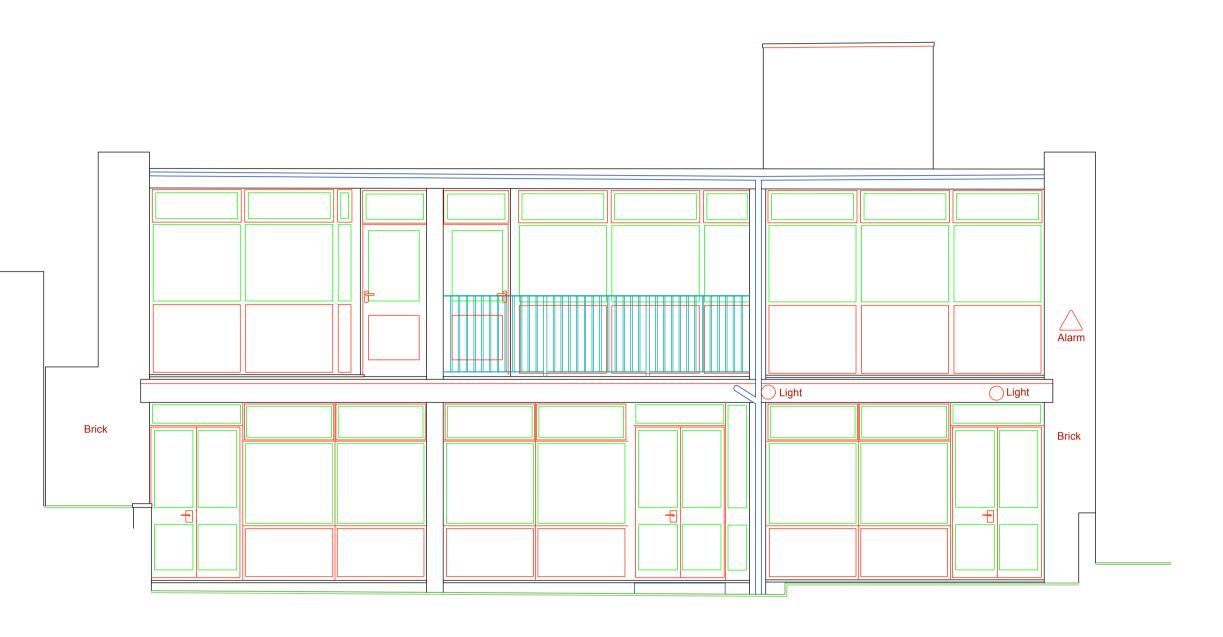

Rear (NE) elevation

<u>Building survey leg</u> [9.99] C[9.99]	gend Finished floor level to survey datum Ceiling level to survey datum
C(9.99) <mark>B[9.99]</mark> B(9.99)	Ceiling height from finished floor Beam level to survey datum Beam soffit height from finished floor
D[9.99] D(9.99) S[9.99]	Door head level to survey datum Door head height from finished floor Window sill level to survey datum
S(9.99) H[9.99] H(9.99)	Window sill height from finished floor Window head level to survey datum Window head height from finished floor
A[9.99][9.99] A(9.99)(9.99)	Arch max & min levels to survey datum Arch max & min heights from finished floor
	ER MODELLED DRAWING - BEWARE OF LAYERS TURNED OFF,
Topographic survey r	
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this survey. No respo may have been hidde	nsibility can be taken for any information, critical or otherwise, that en, buried or otherwise obscured at the time of our survey. at a physical boundary demarcation on site does not necessarily
constitute a legal bou Drainage information	
possible or where de checked and/or verifi	emed necessary. Critical drainage routes and levels should be ied by specialist contractors where applicable.
incorrect identificatio	given for guidance only. We cannot accept any responsibility for n, and so would strongly recommend that, should these be of e design, then a specialist Tree Report be commissioned.
for verticality. Due no	equested or obvious, walls or buildings will not have been checked te must be taken therefore, that walls may be uneven, both
existing furniture, sto <u>Consequently, any di</u>	imensions critical to proposed building or fabrication works must
estimates may have of accessibility and/o	d on site before construction commences, as assumptions or been made in the preparation of this drawing due to both lack r anomalies in the existing building.
cladding, plaster, tim	shown are the evident existing faces of walls, whether they are ber or brick. This is not a structural survey, and therefore all on the plan does not necessarily specify that it may be structural
	taken as generally indicative. Unless specifically requested otherwise, where easily possible, and therefore not necessarily in every room
	related to OSBM situated on wall at junction of
	Jp Hill and Walm Lane, value 52.818m
	erry House School, bad, LONDON NW2
The Mulbe Minster Ro	<ul> <li>A second sec second second sec</li></ul>
The Mulbe Minster Ro	oad, LONDON NW2
The Mulbe Minster Ro <sup>Client:</sup> The Mulbe	oad, LONDON NW2
The Mulbe Minster Ro <sup>Client:</sup> The Mulbe	erry House Shool
The Mulbe Minster Ro <sup>Client:</sup> The Mulbe Drawing title: External el	erry House Shool
The Mulbe Minster Ro <sup>Client:</sup> The Mulbe Drawing title: External el Rear (NE)	erry House Shool levations - sheet 3 of 4 elevation
The Mulbe Minster Ro Client: The Mulbe Drawing title: External el Rear (NE) Scale:	erry House Shool levations - sheet 3 of 4 elevation
The Mulbe Minster Ro Client: The Mulbe Drawing title: External el Rear (NE) Scale: 1:50 Drawing Number: 2655/13	erry House Shool levations - sheet 3 of 4 elevation Date: June 2015

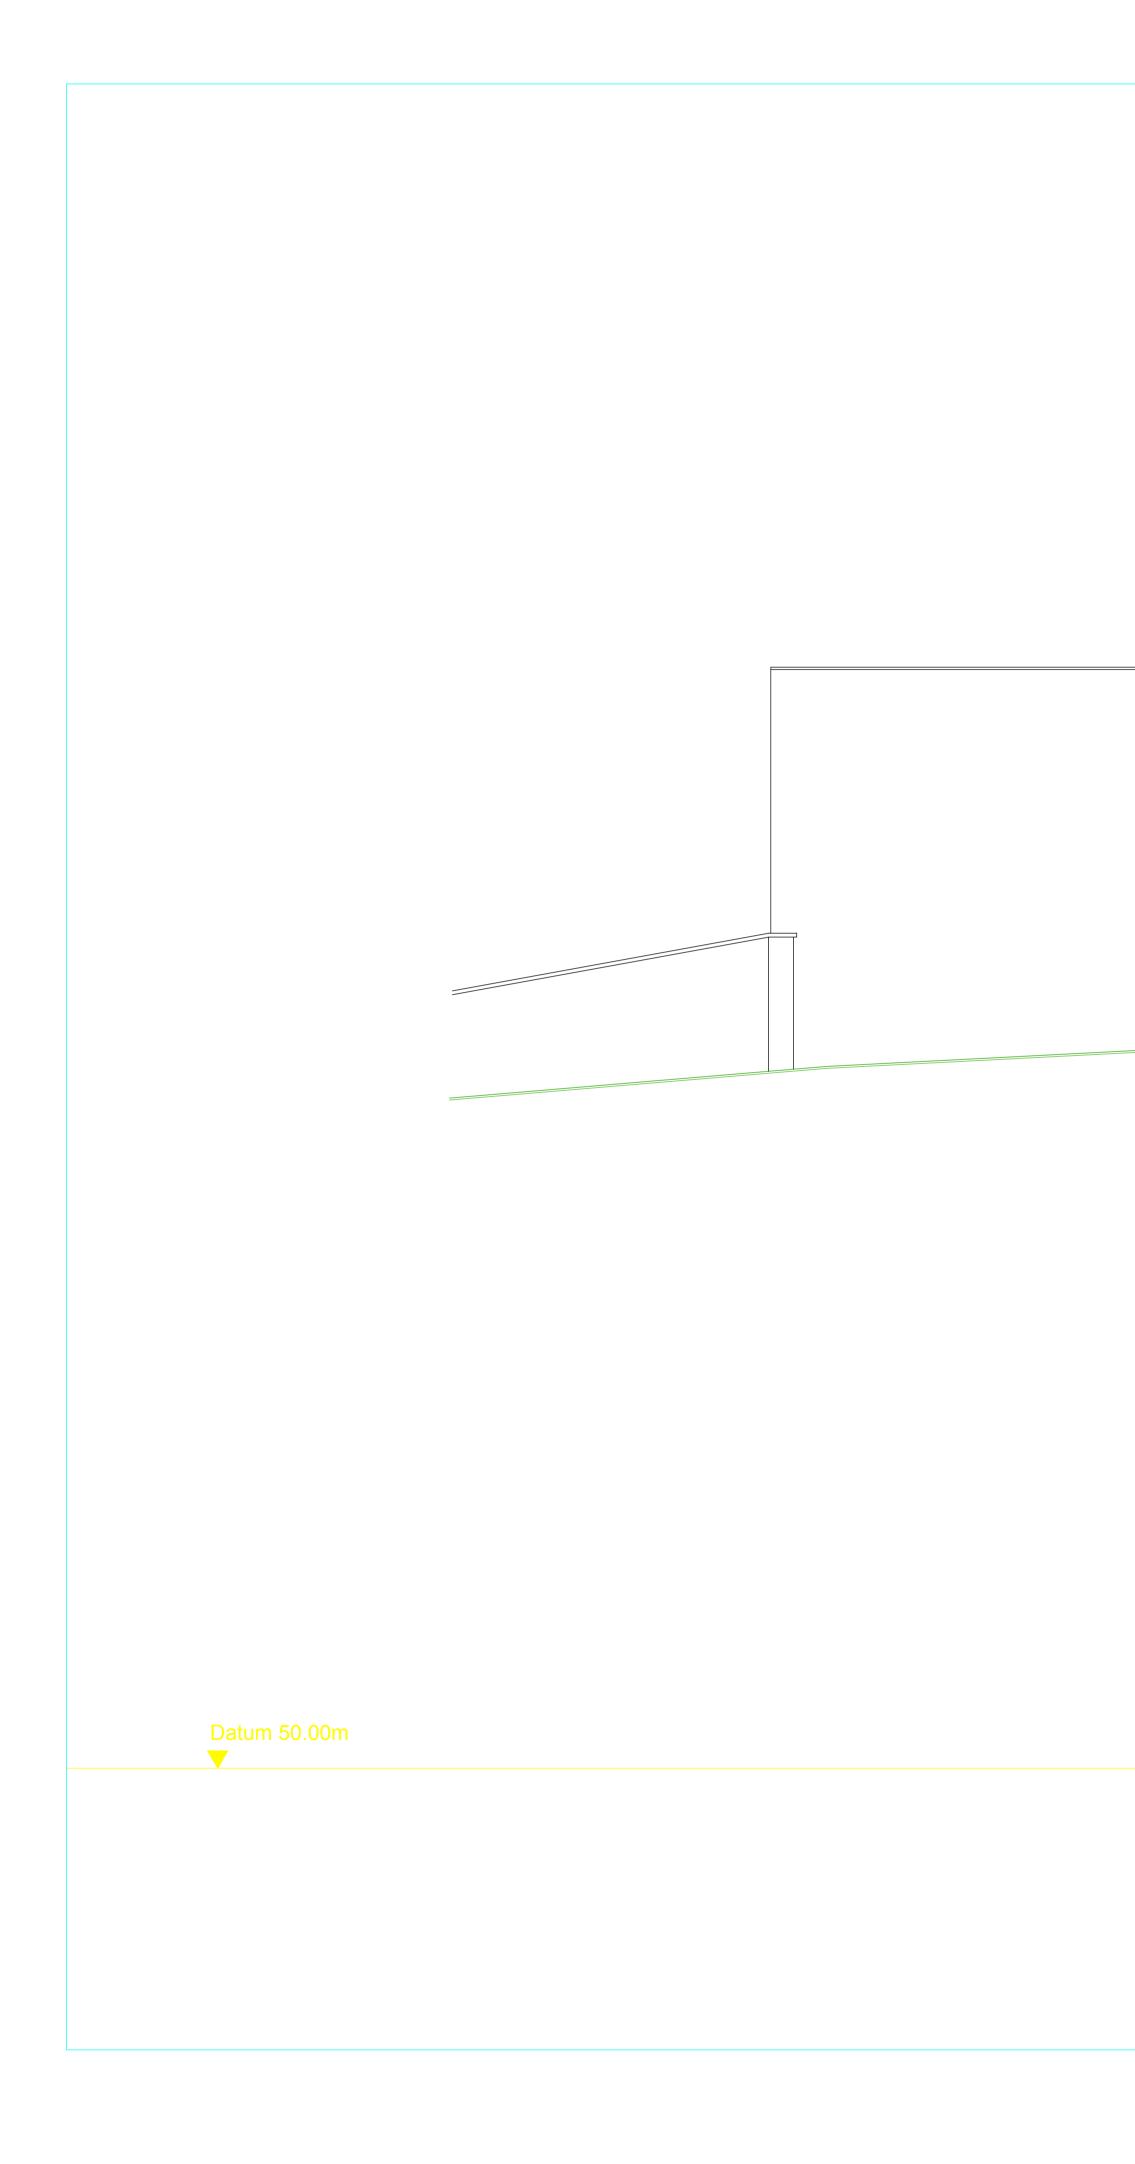

Brick

### Building survey legend

C(9.99)	Ceiling height from finished floor
B(9.99)	Beam soffit height from finished floor
D(9.99)	Door head height from finished floor
S[9.99]	Window sill level to survey datum
S(9.99)	Window sill height from finished floor
H(9.99)	Window head height from finished floor
A(9.99)(9.99)	Arch max & min heights from finished floor

### THIS IS A COMPUTER MODELLED DRAWING - BEWARE FROZEN, LOCKED OR EXCLUDED FROM PRINTING. Topographic survey notes:

Unless otherwise requested, every effort will have been made to show all visible this survey. No responsibility can be taken for any information, critical or otherwise may have been hidden, buried or otherwise obscured at the time of our survey. It should be noted that a physical boundary demarca constitute a legal boundary. Drainage information shown, unless otherwise state nspection and interpretation. Covers have been sur possible or where deemed necessary. Critical draina checked and/or verified by specialist contractors who

portance to a future desig Building survey notes:

Unless specifically requested or obvious, walls or bu for verticality. Due note must be taken therefore, tha vertically and horizontally. There may also have bee existing furniture, storage, decoraton etc. Consequently, any dimensions critical to proposed building or fabrication works must be checked or verified on site before construction commences, as assumptions or estimates may have been made in the preparation of this drawing due to both lack of accessibility and/or anomalies in the existing building.
All internal wall lines shown are the evident existing faces of walls, whether they are cladding, plaster, timber or brick. This is not a structural survey, and therefore the existence of a wall on the plan does not necessarily specify that it may be structural or load bearing.
Floor levels must be taken as generally indicative. Unless specifically requested otherwise, levels will be taken where easily possible, and therefore not necessarily in every room or corridor.

Levels related to OSBM situated on wall at junction of Shoot Up Hill and Walm Lane, value 52.818m

Project: The Mulberry House School, Minster Road, LONDON NW2

Client: The Mulberry House Shool

Drawing title:

Scale: 1:50

External elevations - sheet 4 of 4 Side (SE) elevation

Date: June 2015

Revision:

Drawing Number: 2655/14

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