

Slot type trickle vents achieving 4000sqmm per vent (2500EA)

Please Note: Arrow points to position of handle (T/H Shown)

Please Note: All dimensions shown are approximate and subject to our site survey

Drawing No. 001

Client: Hutton Construction Ltd Site Address: 59-61 Oak Grove Camden NW 2 3 LR | Detail | Elevation A Window/Door Schedule | | Scale | 1:50 @ A3 | Works Order No. 4742

Pindar Road, Hoddesdon,

SAPA Dualframe SI thermal break aluminium Tilt before Turn windows & Residential doors Dualcolour Polyester powder coated RAL 7016 Grey Ext / RAL 9910 White Int 75mm direct fix outer frame with pressed aluminium sub cills

Tilt before Turn open in sashes with multi point locking systems to windows with silver handles High security multi point locking systems to residential doors with silver lever/lever handles to suit SBD requirements

Trickle vents achieving 4000sqmm (2500EA) airflow per vent silver finish Double glazed Soft Coat Low E units as shown on schedule

Due to the nature of Tilt'n' Turns it is not possible to have additional concealed restrictors.

Glazing Key:

1 4/20/4 Clear Toughened Soft Coat Low E Units

(2) 6.4/18/4 Clear Toughened Soft Coat Low E / Clear Laminated Units

Surface mounted restrictors can be fitted but these can only be fitted onto a mullion and not onto a frame section as the majority of the frame section is covered by the dry lining and therefore there is not sufficient frame left to mount the restrictor onto

The turn motion is meant purely for cleaning purposes only and not for venting which is what the tilt position is for.

When the handle is in the locked position the handle will only move to the tilt position and not to the turn position for child safety

Slot type trickle vents achieving 4000sqmm per vent (2500EA)

Please Note: Arrow points to position of handle (T/H Shown)

Please Note: All dimensions shown are approximate and subject to our site survey


Client:	Hutton Construction Ltd	Detail Elevation B Window/		
Site Address:	59-61 Oak Grove Camden NW 2 3LR	Scale 1:50 @ A3 Drawing No. 002	Works Order No. 4742 Date: 05/02/15	Pindar Road, Hoddesdon,

W09-02-05 1735 3

→ 155mm cill

W06-01-05

1023

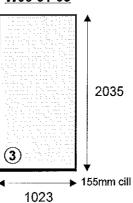

Door By Others

SAPA Dualframe SI thermal break aluminium Tilt before Turn windows & Residential doors Dualcolour Polyester powder coated RAL 7016 Grey Ext / RAL 9910 White Int 75mm direct fix outer frame with pressed aluminium sub cills Tilt before Turn open in sashes with multi point locking systems to windows with silver handles High security multi point locking systems to residential doors with silver lever/lever handles to suit SBD requirements Trickle vents achieving 4000sqmm (2500EA) airflow per vent silver finish Double glazed Soft Coat Low E units as shown on schedule

Due to the nature of Tilt'n' Turns it is not possible to have additional concealed restrictors.


Glazing Key:

- (1) 4/20/4 Clear Toughened Soft Coat Low E Units
- (2) 6.4/18/4 Clear Toughened Soft Coat Low E / Clear Laminated Units

(3) 6.4/18/4 Stippolyte Toughened Soft Coat Low E / Clear Laminated Units Surface mounted restrictors can be fitted but these can only be fitted onto a mullion and not onto a frame section

The turn motion is meant purely for cleaning purposes only and not for venting which is what the tilt position is for. When the handle is in the locked position the handle will only move to the tilt position and not to the turn position for child safety

as the majority of the frame section is covered by the dry lining and therefore there is not sufficient frame left to mount the

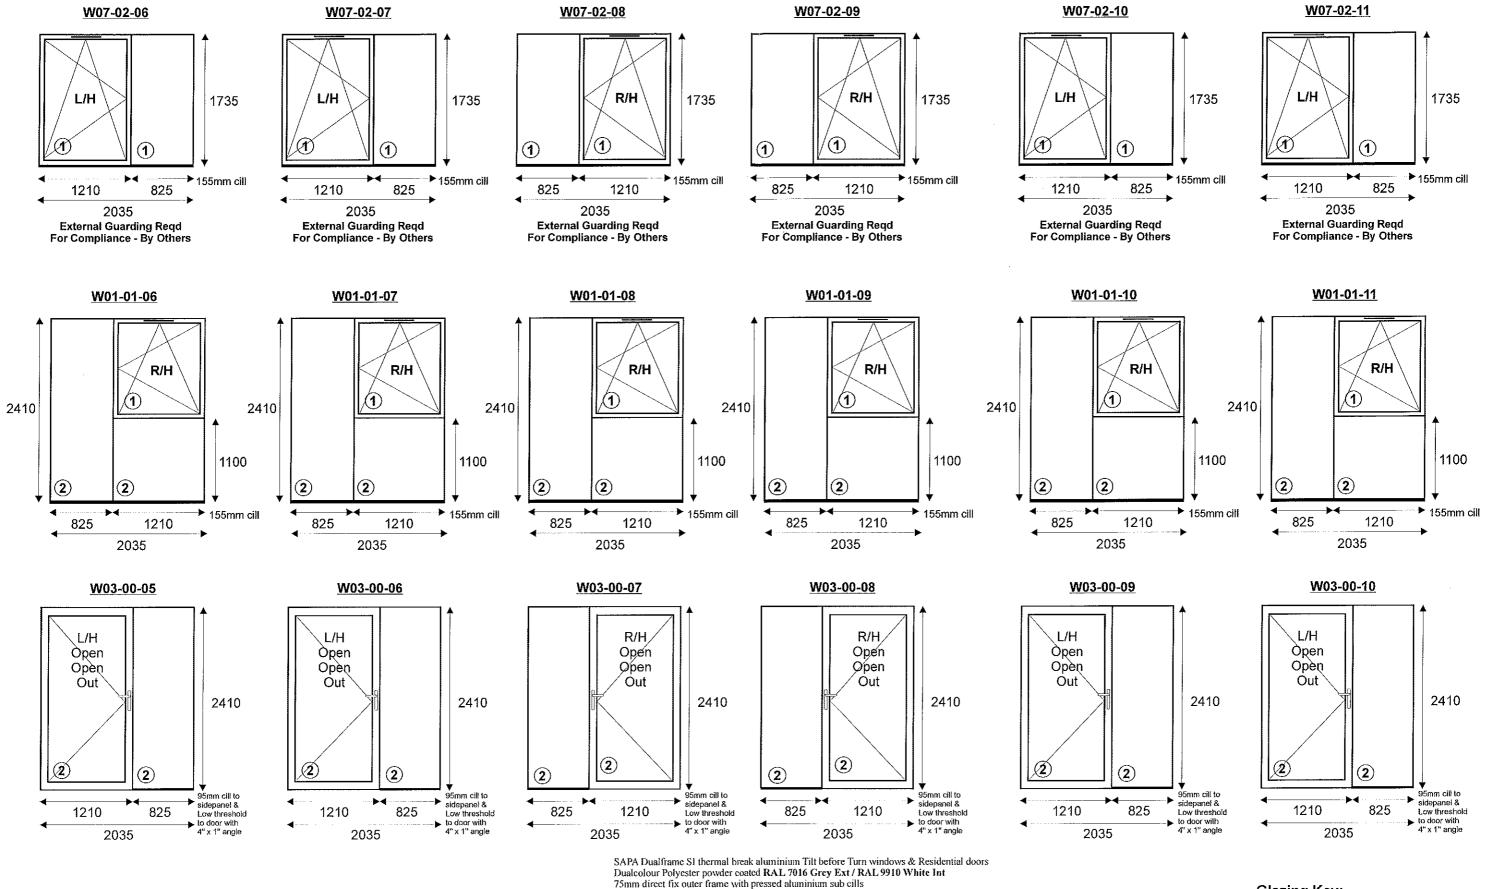

Slot type trickle vents achieving 4000sqmm per vent (2500EA)

Please Note: Arrow points to position of handle (T/H Shown)

Please Note: All dimensions shown are approximate and subject to our site survey

Hutton Construction Ltd Petail : Elevation C Window/Door Schedul Client: Site Address: 59-61 Oak Grove Scale 1:50 @ A3 Camden NW 2 3LR Drawing No. 003

Works Order No. 4742 Date: 05/02/15

Pindar Road, Hoddesdon,

Due to the nature of Tilt'n' Turns it is not possible to have additional concealed restrictors.

Trickle vents achieving 4000sqmm (2500EA) airflow per vent silver finish

Double glazed Soft Coat Low E units as shown on schedule

Tilt before Turn open in sashes with multi point locking systems to windows with silver handles

Glazing Key:


(1) 4/20/4 Clear Toughened Soft Coat Low E Units


6.4/18/4 Clear Toughened Soft Coat Low E / Clear Laminated Units


Surface mounted restrictors can be fitted but these can only be fitted onto a mullion and not onto a frame section as the majority of the frame section is covered by the dry lining and therefore there is not sufficient frame left to mount the


High security multi point locking systems to residential doors with silver lever/lever handles to suit SBD requirements

The turn motion is meant purely for cleaning purposes only and not for venting which is what the tilt position is for. When the handle is in the locked position the handle will only move to the tilt position and not to the turn position for child safety

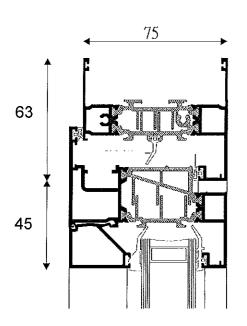

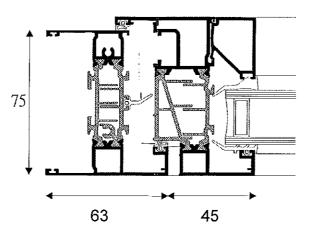

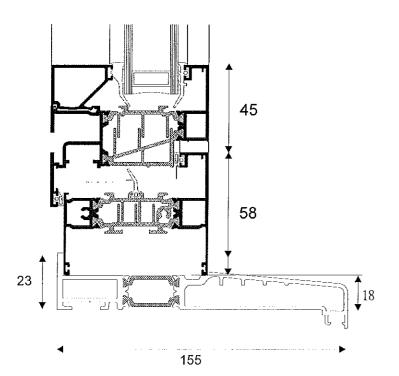

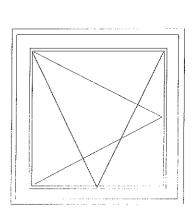

45

63

Client:							
Site Address:							

Hutton Construction Ltd 59-61 Oak Grove Camden NW 2 3LR
 Detail
 Typical Window Sections

 Scale
 1:50 @ A3
 Works Order No. 4742

 Drawing No. 004
 Date: 05/02/15

Pindar Road, Hoddesdon,

