APPENDIX A

Site Plans and Exploratory Hole Logs

Key to Exploratory Hole Logs

General

All soil & rock descriptions in general accordance with BS5930:1999+A2:2010, BS EN ISO 14688 & BS EN ISO 14689 The Geology Code only entered where positive identification of the sampled strata has been made

Sampling

ES Environmental Sample (taken in appropriate sampling container)

D Disturbed Sample B Bulk Sample

LB Large Bulk for Earthworks testing

C Core Sample

U Undisturbed Sample (number of blows indicated in results column)

SPTLS SPT Liner Sampler
P Piston Sample
W Water Sample

Insitu Tests

SPT Standard Penetration Test in accordance with BS EN ISO 22476-3:2005+A1:2011 SPT (C) Cone Penetration Test in accordance with BS EN ISO 22476-3:2005+A1:2011

PT Penetration Test - STL documented equivalent SPT N Value

PPT Perth Penetration Test – STL in house documented method (N Value)
UCS (____) Unconfined Compressive Strength measure by hand penetrometer (kN/m²)

IVN Hand Vane (kPa)

PID Photo Ionisation Detector Results (ppm)

MEXE Mexecone CBR Result

Drilling Records

Depth to standing water level

Depth to water strike

TCR Total Core Recovery (%)
SCR Solid Core Recovery (%)
RQD Rock Quality Index (%)

FI Fracture Index

• •							
Backfill Symbo	<u>ls</u>	Pipe Symb	<u>ols</u>	Principal S	oil Types	Principal Roc	k Types
Arisings		Plain Pipe		Topsoil		Mudstone/Claystone	
Concrete	٠,٥,	Slotted Pipe	Ħ	Made Ground		Siltstone	$\begin{array}{c} \times \times \times \\ \times \times \times \end{array}$
Blacktop	***	Filter Tip		Clay		Sandstone	• • •
Bentonite Seal	1365			Silt	$\times \times$	Limestone	
Bentomice Sear				Sand		Chalk	
Gravel Filter	, , , ,			Gravel			
Sand Filter				Peat	316 6 36		

S	out	hern Te	esting	ST (Consu	lt≡	9	Start - I	End D	ate		Pro	oject ID	: Н	lole Typ	e:	WS:	L
www.s	outhernte	esting.co.uk tel:0134			ult.co.uk tel:016)	18/0	2/201				12147		WS		Sheet 1	
Project	Nam	165 - 4 NW3)	67 Finch	nley Road	d (Londo	n	Rema	rks:		Co	o-ordi	nates	:		Level:		Logge HC	r:
Locatio	n:	Londor	n NW3				1. Hole	dry up	on cor	nplet	tion.							
Client:		A Gova	ni															
Well	Water Strikes			I nsitu Testir Res	ults	Level (m AOD)	Thickness (m)	Legend	(m b	gl)	Floor	r tile	Stra	atum De	escription	n		
		0.25 0.50 0.50 0.50 0.75 1.00 1.00 1.25 1.50 1.75 2.00 2.00 2.25 2.50 2.75 3.00 3.00 3.25 3.50 3.75 4.00 4.00 4.50 4.75 5.00 5.00 5.25 5.50 5.75 6.00 6.00		UCS(kPa	a)=150.0 a)=170.0 a)=210.0 a)=290.0 a)=280.0 a)=280.0 a)=220.0 a)=240.0 a)=240.0 a)=260.0 a)=310.0 a)=390.0 a)=390.0 a)=390.0 a)=390.0 a)=390.0 a)=390.0 a)=390.0 a)=390.0 a)=390.0 a)=390.0 a)=390.0 a)=390.0		(8.93) (0.12) (0.10)		0.0 0.0 0.1 0.2	6666	Dark fragn Firm brick Firm orang cryst	high to stiff ge bro als	o very hi ey browr elenite cu	with who cktop Itly sand fragmer Irength, Itly with out Itly sand	f membinole brickly CLAY, whits. MAD pale brock pale br	with free GRO own mood of the second of the	equent UND ttled elenite	1 - 2 - 3 - 3 - 3 - 3 - 3 - 3 - 3 - 3 - 3
																		7 -
Н	lole Det	tails	Casing	Details		Water	Strike (m b	gl)		Read	dings (m	bgl)		Sta	nding/Chi	selling (r	n bgl)	
Depth (m	bgl)	Dia. (mm)	epth (m bgl)	Dia. (mm)	Date	Dep	th Casi	ng Se	aled	Rose t	o: Tim	ie (min)	From	То	Time		Remarks	

Soi	uthe	ern Testing	ST Consi	ult≡		Start -	End Date:	Project ID:	Machine Type:	TP1
www.south	erntesting.		www.stconsult.co.uk tel:0			18/	02/2015	J12147	Hand Dug	Sheet 1 of
Project N	ame:	465 - 467 Finchle NW3)	ey Road (Lond	don	Rema	arks:	Co-ord	inates:	Level (m AOD):	Logger: SM/HC
Location:		London NW3					pon completion.			SIVI/TIC
Client:		A Govani				1				
Depth (m)	Type	nd Insitu Testing Results		kness m)	egend	Depth (m bgl)		Stratum Des	scription	
0.2	D		(0.	23)		0.23	brick concret GROUND). Pale brown, i	e and organic fr	h frequent fragme agments (MADE with occasional br	
1.0	D			20)		0.90	Firm, pale br	own, CLAY.		
						1.10		Pit terminated	at 1.10m.	
P	it Dim	ension (m)			Pit Sta	ability:			Water Strikes:	
Width		0.53	1. Pit sides					1. Hole dry upo	on completion.	
Length		0.62								
Depth		1.10								

Soi	uthe	ern Testing	ST Co	nsult		Start -	- End Date:	Project ID:	Machine Type:	TP2
				uk tel:01604 50002		18/	02/2015	J12147	Hand Dug	Sheet 1 of 1
Project N	ame:	465 - 467 Finchle	y Road (I	ondon	D		Co-ord	inates:	Level (m AOD):	Logger:
		NW3)			Rema		pon completion.			SM
Location:		London NW3			1.110	ne ary a	por completion.			
Client:		A Govani								
Sa	amples a	nd Insitu Testing	Level	Thickness	ogond	Depth		Ctratum Dag	ariation	
Depth (m)	Туре	Results	(m AOD)	(111)	egend	(m bgl)		Stratum Des	сприоп	
				(0:0 1)		0.03	Tile and scree Black CONCR			
				(0.10)		0.04			h fragments of br	ick,
				(2.44)		0.14	blacktop and		rominat briok from	
				(0.11)			(MADE GROU		requent brick frag	gments
				-		0.25	Firm, pale br			
				=		-				
				-	===					
				(0.52)						
				(0.02)						
				-						
				E		-				
						0.77		Pit terminated	 at 0.77m.	
										1
										2
								T		
P	it Dim	ension (m)			Pit St	ability:			Water Strikes:	
Width	n:	0.43	1. Pit si	des stable.				1. Hole dry upo	n completion.	
Length	n:	0.54								
Depth	1:	0.77								


= Soi	ıthe	ern Testing	ST Co	nsult		Start -	End Date:	Project ID:	Machine Type:	TP3	
				.uk tel:01604 500020		18/	02/2015	J12147	Hand Dug	Sheet 1 c	of 1
Project Na		465 - 467 Finchley					Co-ordi		Level (m AOD):	Logger	
Project Na	ame:	NW3)			Rema					SM/H0	
Location:		London NW3					ug by others. pon completion.				
Client:		A Govani									
	1	nd Insitu Testing	Level	Thickness L	egend	Depth		Stratum Des	cription		
Depth (m) 0.6	НР		(m AOD)	(0.48)	egend	0.48 0.75	Firm to stiff, h		tht brown, CLAY		1-
											-
											2 -
Pi	it Dim	ension (m)			Pit Sta	ability:			Water Strikes:		
Width		0.40	1. Pit si	ides stable.				1. Hole dry upo			
Length		0.40		0.00101				,,			
Depth		0.40	-								
Depth	ı.	0.75									


Sou	ıthe	rn Testing	ST Co	nsult			- End Date:	Project ID:	Machine Type:	TP4	
		465 - 467 Finchley		uk tel:01604 5000)20	18/	02/2015 Co-ordi	J12147	Hand Dug Level (m AOD):	Sheet 1 o	
Project Na	ame:	NW3)			Rema			nutes.	Level (III AOD).	SM/H	
Location:		London NW3					ug by others. pon completion.				
Client:		A Govani			2.110		r completion.				I
Depth (m)	Type	Results	Level (m AOD)	Thickness (m)	Legend	Depth (m bgl)		Stratum Des	scription		
0.6	HP	UCS(kPa)=190		(1.10)		1.63	Firm to stiff, h	th occasional to	ale brown mottled frequent selenite patches/lenses a	2,	1
	٠.				D': 0:	L:::··			Water Co. "		
		ension (m)				ability:			Water Strikes:		
Width		0.97	1. Pit si	des stable	·.			1. Hole dry upo	on completion.		
Length		1.04									
Depth	:	1.63									

Sou	uthe	ern Testing	ST Co	nsult		Start	- End Date:	Project ID:	Machine Type:	TP5
				o.uk tel:01604 50002		18/	02/2015	J12147	Hand Dug	Sheet 1 of 1
Project Na	ame:	465 - 467 Finchle	y Road (London			Co-ordi	inates:	Level (m AOD):	Logger:
		NW3)			Rema		 pon completion.			SM
Location:		London NW3			1. 110	nc ary a	ipon completion.			
Client:		A Govani								
	mples a	nd Insitu Testing	Level	Thickness	_egend	Depth		Stratum Des	cription	
Depth (m)	Туре	Results	(m AOD)	(111)	Talkier	(m bgl)	Tile and scree			
				(0 : 07)		0.03	Black CONCR			
				(0.12)		0.04			frequent fragme	nts of
				: : : : : : : : : : : : : : : : : : :	*******	0.16	brick, blackto		occasional to frequ	uent
				(0.10)				nts (MADE GRO		uent
						0.26	Firm, pale bro	own, CLAY.		
0.5	D			(0.54)						-
				(0.54)						
					===					
						0.80				
						0.60		Pit terminated	at 0.80m.	
										1 -
										-
										2-
		ension (m)				ability:			Water Strikes:	
Width		0.44	1. Pit s	ides stable.				1. Hole dry upo	n completion.	
Length	ո։	0.60								
Depth	ı:	0.80								

Soi	uthe	ern Testing	ST Co	nsult		Start -	End Date:	Project ID:	Machine Type:	TP6
				uk tel:01604 50002		18/	02/2015	J12147	Hand Dug	Sheet 1 of 1
Project N	ame:	465 - 467 Finchle	y Road (London	Rema	arke:	Co-ordi	inates:	Level (m AOD):	Logger:
		NW3)					pon completion.			HC
Location:		London NW3				,	p			
Client:		A Govani								
		nd Insitu Testing	Level	Thickness	egend	Depth		Stratum Des	cription	
Depth (m)	Туре	Results	(m AOD)	(m) (0.02)		(m bgl)	√ Floor tile and			
						0.02			ent bricks, brick	
				(0.21)			fragments an	d blacktop		
				<u> </u>	XXXXXX	0.23	Dark grov bro	yun candu CLAV	with frequent br	ick
				(0.47)				id blacktop (MA		ick
				(0.17)			J		•	
0.4	D				<u> </u>	0.40	Firm, pale bro	our CLAV		
				(0.15)			Firm, pale bro	own CLAY		
				(0.13)						-
						0.55		Pit terminated	at 0.55m.	
										1 -
										,
										2
								T		
P	it Dim	ension (m)			Pit Sta	ability:			Water Strikes:	
Width	ı:	0.40	1. Pit s	ides stable.		_		1. Hole dry upo	on completion.	
Length	1:	0.50								
Depth	ı:	0.55								

So	uthe	ern Testing	ST Consult	Start - End Date:		Project ID:	Machine Type:	TP7	
			ww.stconsult.co.uk tel:01604 500020		18/	02/2015	J12147	Hand Dug	Sheet 1 of 1
Project N	ame:	465 - 467 Finchley	/ Road (London	Rema	rke.	Co-ord	inates:	Level (m AOD):	Logger:
Location:		NW3) London NW3 A Govani		1. Pit l	hand d	l ug by others. pon completion.			SM/HC
		nd Insitu Testing			- I	<u> </u>			
Depth (m)	Type		(III AOD) (III)	egend.	Depth (m bgl)		Stratum Des	scription	
0.2 0.5	HP D	UCS(kPa)=180		egend		Weak, black, brick and bla Firm to stiff,	ete Screed. , damp proof m CONCRETE, wit cktop.	embrane. h frequent fragme ght brown, CLAY, v	
									2
_	:			D'' C'	1. •1••				
		nension (m)	4 50 11	Pit Sta	bility:			Water Strikes:	
Width		0.60	1. Pit sides stable.				1. Hole dry upo	on completion.	
Length		0.50	_						
Depth	1:	0.60							

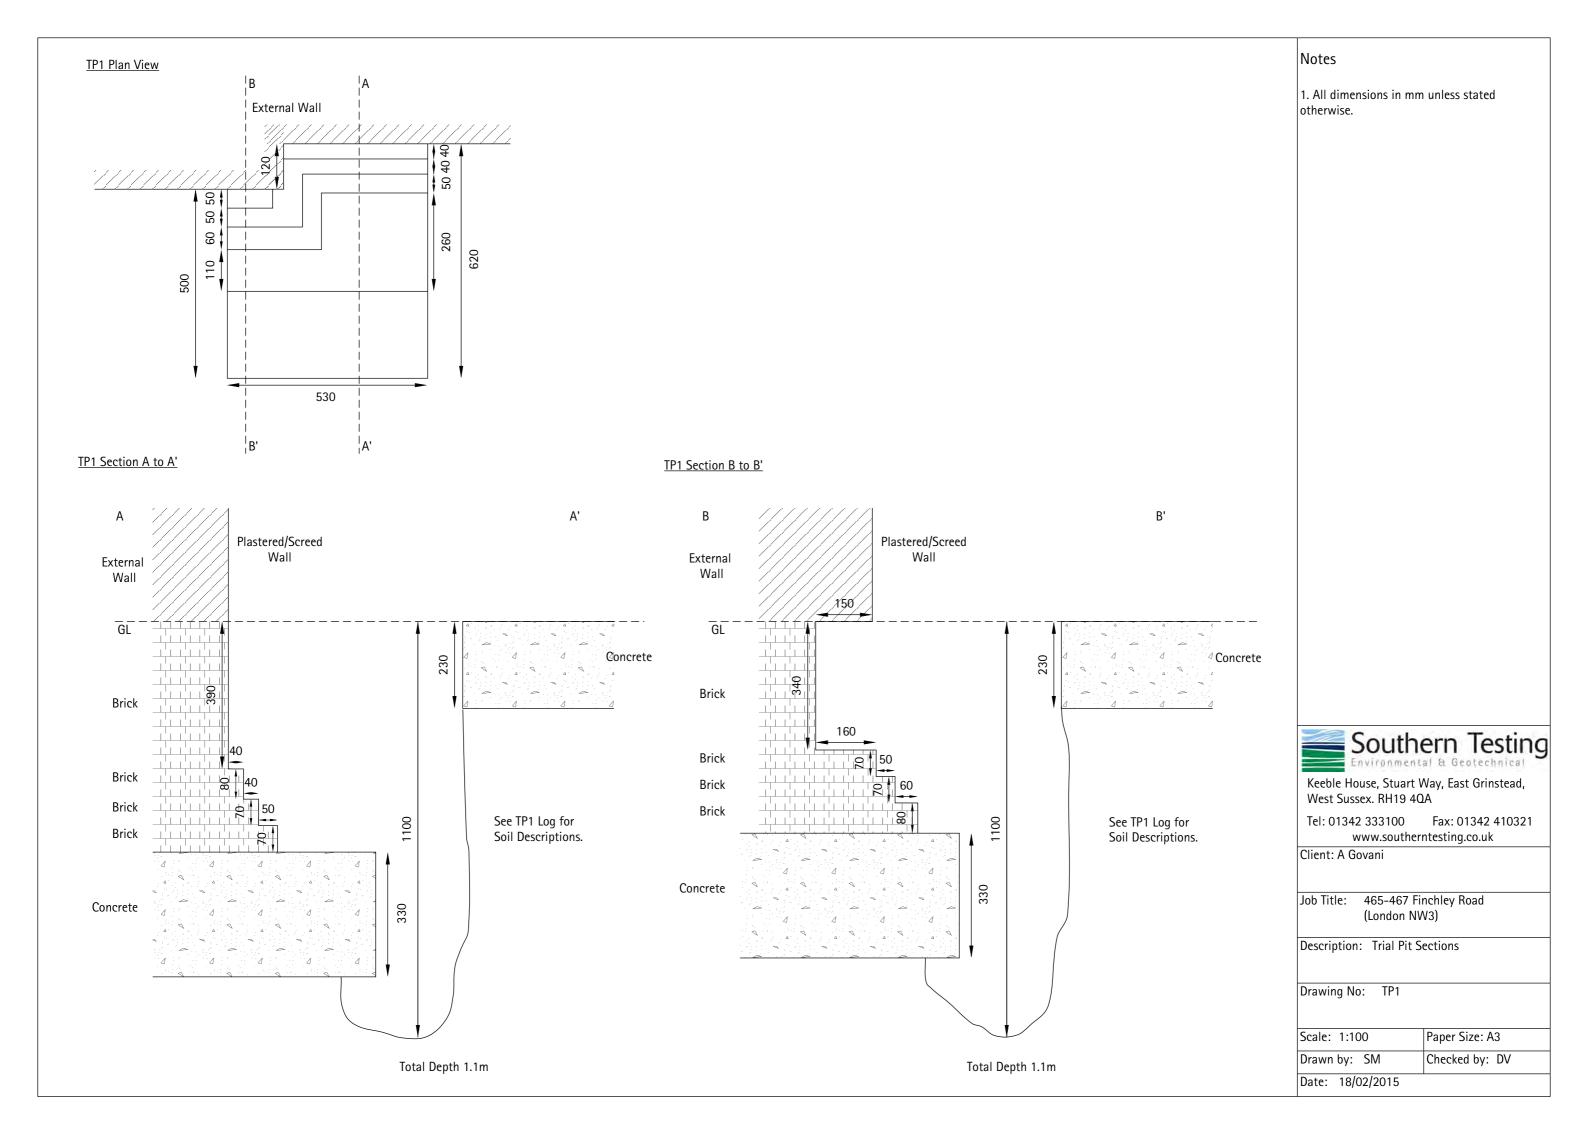


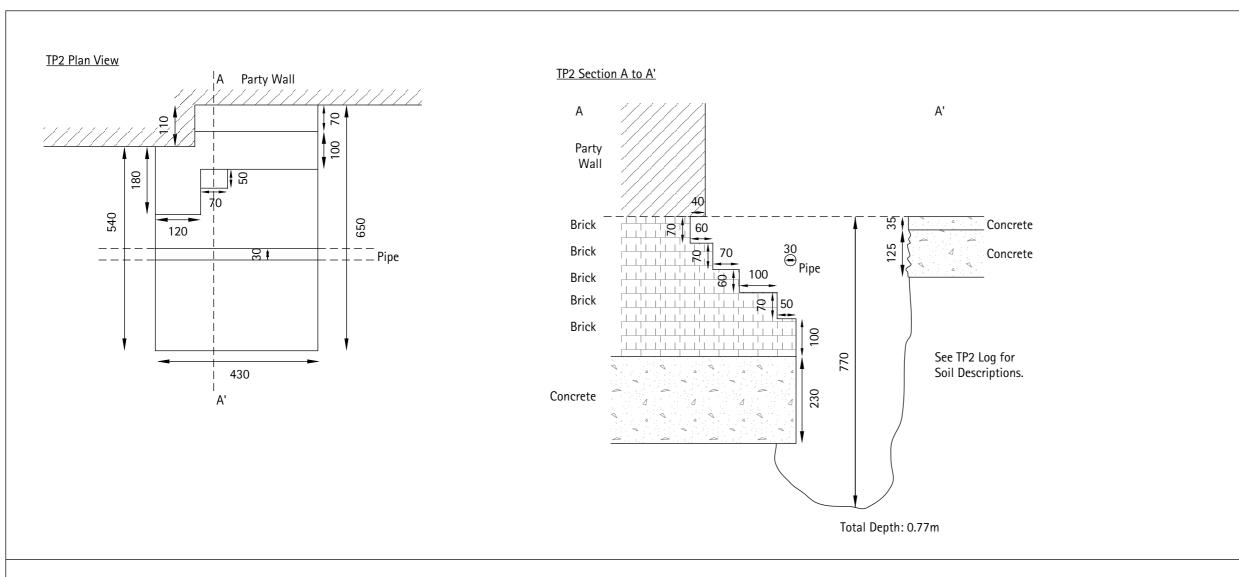



Notes

1. All dimensions in mm unless stated otherwise.

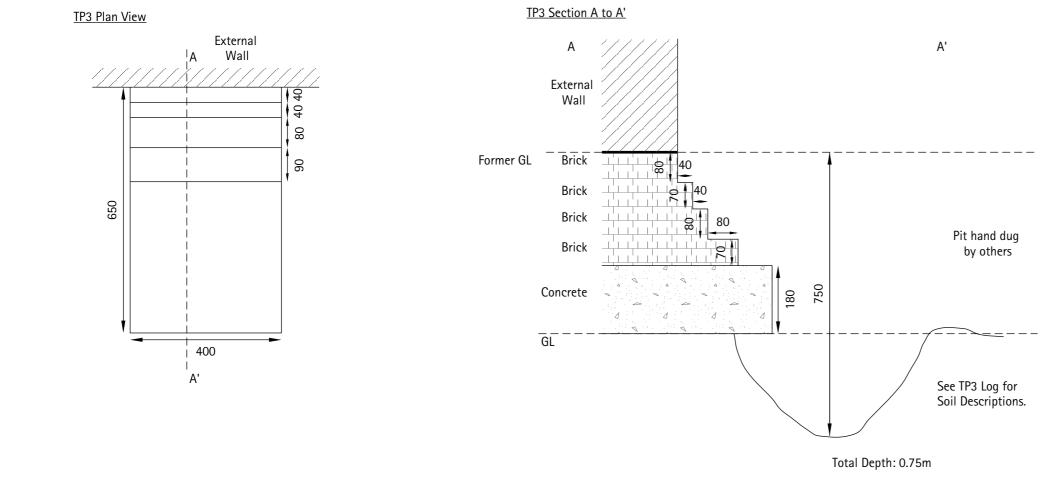



Keeble House, Stuart Way, East Grinstead, West Sussex. RH19 4QA

Tel: 01342 333100 Fax: 01342 410321 www.southerntesting.co.uk

Client: A Govani

ob Title: 465-467 Finchley Road (London NW3)


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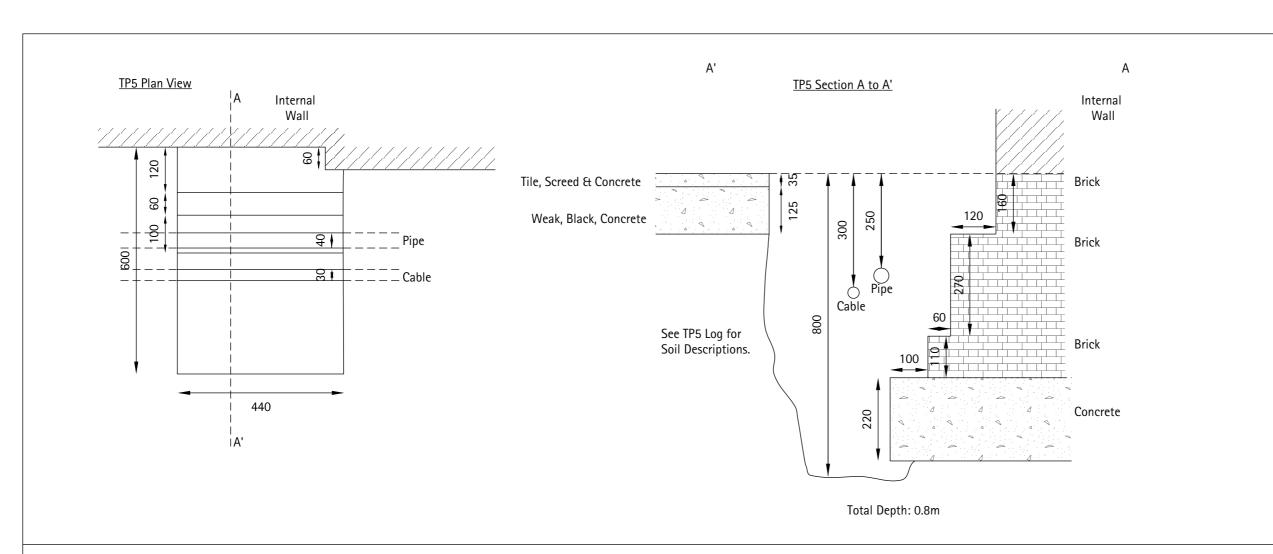
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Scale: 1:100 Paper Size: A3

Drawn by: SM Checked by: DV


Date: 18/02/2015




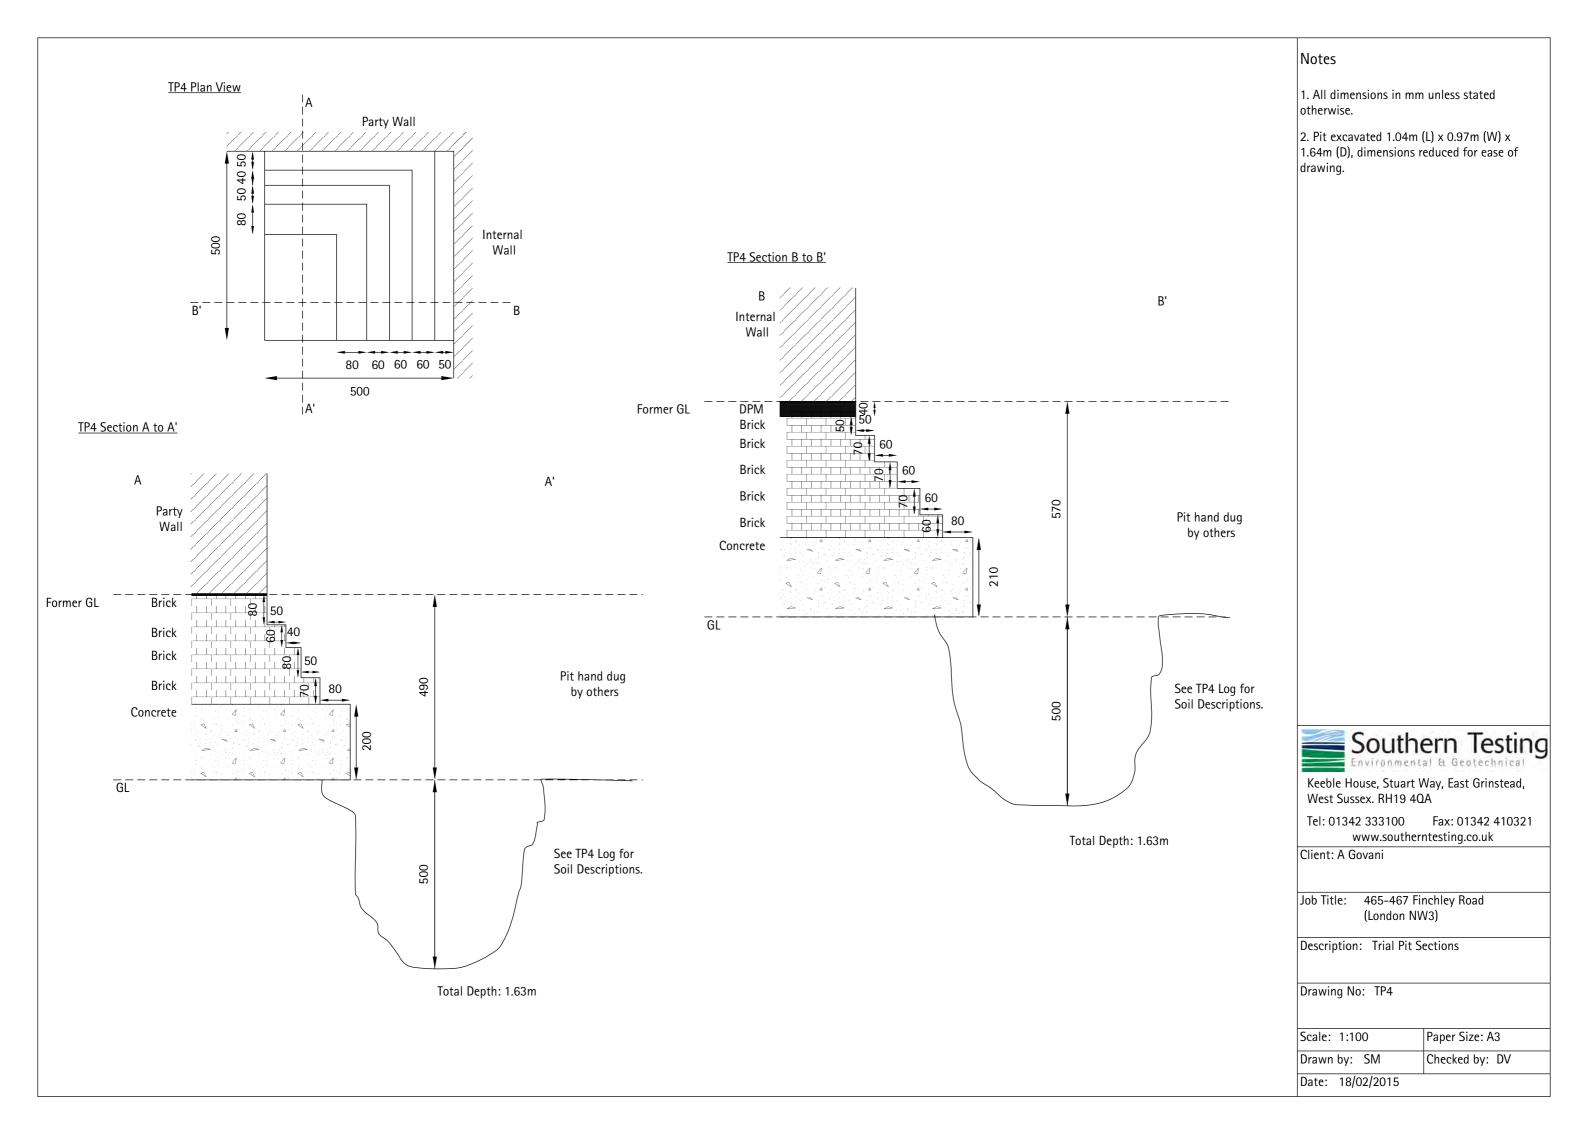

Notes

1. All dimensions in mm unless stated otherwise.

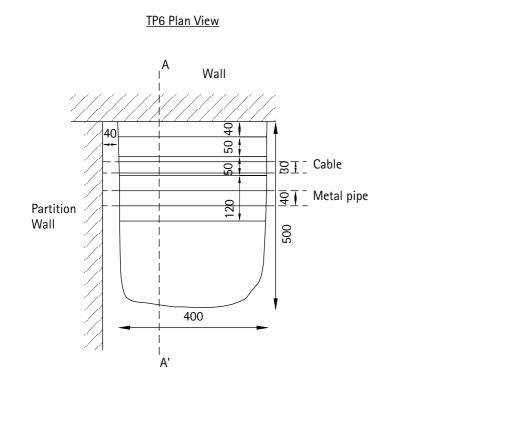

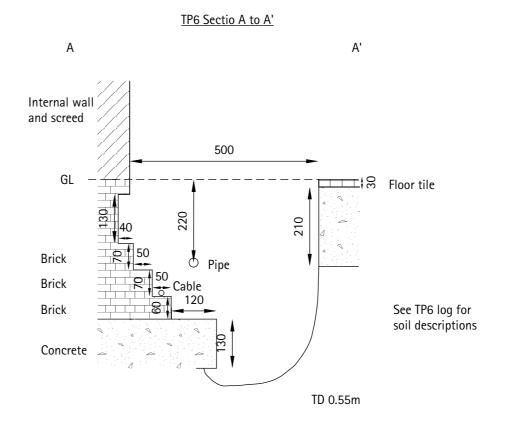



Keeble House, Stuart Way, East Grinstead, West Sussex. RH19 4QA

Tel: 01342 333100 Fax: 01342 410321 www.southerntesting.co.uk

Client: A Govani


Job Title: 465-467 Finchley Road (London NW3)


Description: Trial Pit Sections

Drawing No: TP5 & TP6


Scale: 1:100	Paper Size: A3
Drawn by: SM	Checked by: DV
D + 40/00/0045	

Date: 18/02/2015

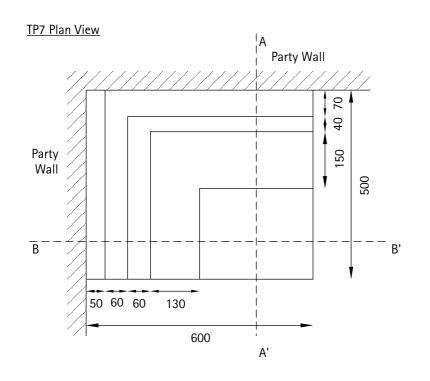

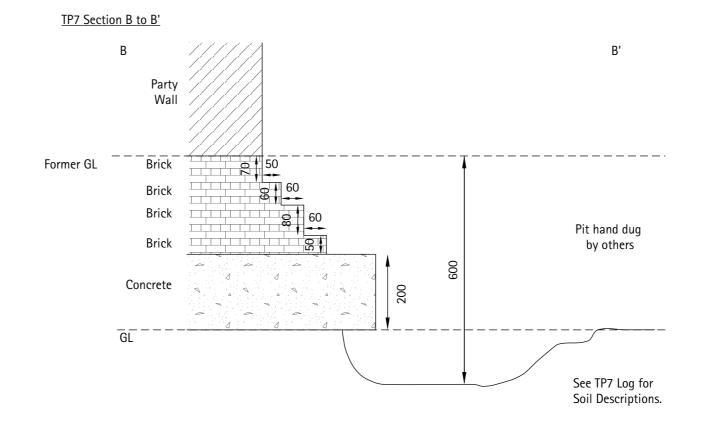

TP7 Section A to A'

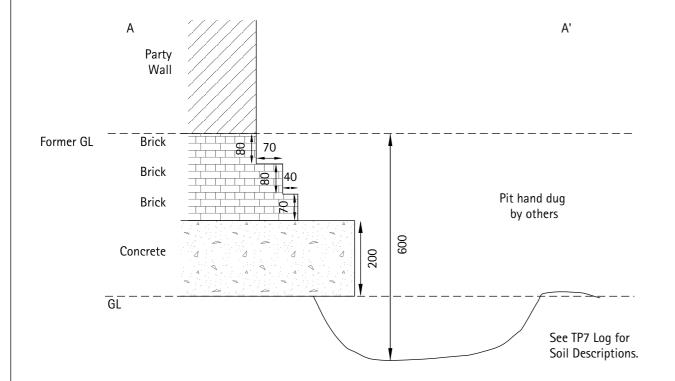

Notes

1. All dimensions in mm unless stated otherwise.



Keeble House, Stuart Way, East Grinstead, West Sussex. RH19 4QA

Tel: 01342 333100 Fax: 01342 410321 www.southerntesting.co.uk

Client: A Govani

Job Title: 465-467 Finchley Road (London NW3)

Description: Trial Pit Sections

Drawing No: TP7

Scale: 1:100 Paper Size: A3

Drawn by: SM Checked by: DV

Date: 18/02/2015

J12147 465-467 Finchley Road (London NW3)







J12147 465-467 Finchley Road (London NW3)





APPENDIX B

Field Sampling and in-situ Test Methods & Results

Field Sampling and in-situ Test Methods

Disturbed Samples

Disturbed samples were taken from the trial holes at intervals and stored in sealed glass jars and polythene bags, as appropriate.


Hand Penetrometer Test

The hand penetrometer consists of a spring loaded and calibrated plunger which is forced into the soil. A reading of unconfined compression strength (equal to twice cohesion) is given on a calibrated scale. In common with other hand methods of strength assessment (eg. the shear vane) it does not give an accurate indication of bearing capacity in stiff or fissured soils, because of the small test area. The figures are used for strength classification according to the table below.

Hand Penetrometer Value (kPa)	Undrained Shear Strength cu (kPa)	Undrained Shear Strength of Clays
Less than 20	Less than 10	Extremely Low
20 to 40	10 to 20	Very Low
40 to 80	20 to 40	Low
80 to 150	40 to 75	Medium
150 to 300	75 to 150	High
300 to 600	150 to 300	Very High
More than 600	More than 300	Extremely High

APPENDIX C

Geotechnical Laboratory Test References & Results

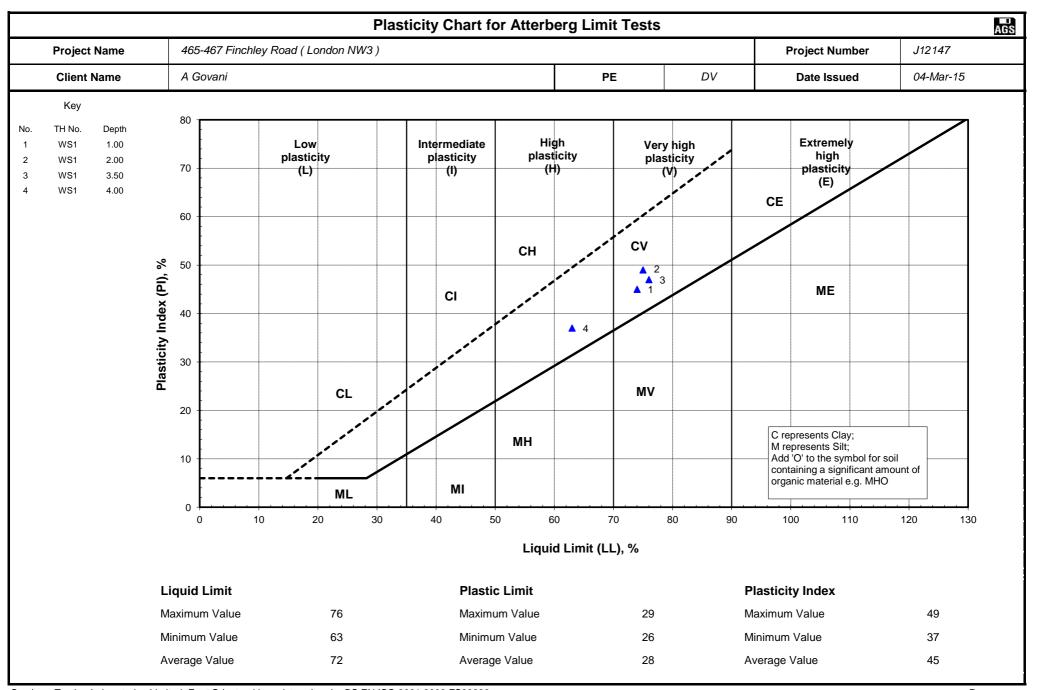

Southern Testing ST Consult To BS1377-2:1990(2003) cl.3.2, 3.3, 4.2, 4.3										
Project N	Name	465-467 F	inchley Road (London NW3)				Project	Number	J12147	
Clier	nt	A Govani			PE	DV	Date I	ssued	04-Mar-15	
		Sample Type	Visual Description	Comments	Natural MC %	Liquid Limit	Plastic Limit	Plasticity Index	Classi- fication	Passing 425 micro %
WS1	1.00	D	Stiff very high strength light brown CLAY.		30	74	29	45	CV	100
WS1	2.00	D	Light brown CLAY.		32	75	26	49	CV	100
WS1	3.50	3.50 D Very stiff very high strength light brown CLAY.			31	76	29	47	CV	100
WS1	WS1 4.00 D Stiff high strength mid brown slightly sandy C selenite crystals.		Stiff high strength mid brown slightly sandy CLAY with frequent selenite crystals.		30	63	26	37	СН	100

Southern Testing Laboratories Limited, East Grinstead is registered under BS EN ISO 9001:2008 BSI ref: FS29280

Jun 13



Scientific Analysis Laboratories Ltd Certificate of Analysis

3 Crittall Drive Springwood Industrial Estate Braintree Essex CM7 2RT

Tel: 01376 560120 Fax: 01376 552923

Scientific Analysis Laboratories is a limited company registered in England and Wales (No 2514788) whose address is at Hadfield House, Hadfield Street, Manchester M16 9FE

Report Number: 458895-1

Date of Report: 05-Mar-2015

Customer: Southern Testing Laboratories

Keeble House Stuart Way East Grinstead West Sussex RH19 4QA

Customer Contact: Mr David Vooght

Customer Job Reference: J12147 Customer Purchase Order: J12147_1

Customer Site Reference: 465-467 Finchley Road (London NW3)

Date Job Received at SAL: 26-Feb-2015
Date Analysis Started: 26-Feb-2015
Date Analysis Completed: 05-Mar-2015

The results reported relate to samples received in the laboratory

Opinions and interpretations expressed herein are outside the scope of UKAS accreditation

This report should not be reproduced except in full without the written approval of the laboratory

Tests covered by this certificate were conducted in accordance with SAL SOPs

All results have been reviewed in accordance with QP22





Report checked and authorised by : Miss Claire Brown Customer Service Manager Issued by : Miss Claire Brown Customer Service Manager SAL Reference: 458895

Project Site: 465-467 Finchley Road (London NW3)

Customer Reference: J12147

Soil Analysed as Soil

Miscellaneous

l .									
	SA	458895 001	458895 002	458895 003	458895 004	458895 005			
	ner Sampl	TP1 @ 0.50m	TP1 @ 1.00m	WS1 @ 0.25m	WS1 @ 1.50m	WS1 @ 3.00m			
	18-FEB-2015	18-FEB-2015	18-FEB-2015	18-FEB-2015	18-FEB-2015				
		Clay	Clay	Clay	Clay	Clay			
Determinand	Method	Test Sample	LOD	Units					
(Water Soluble) SO4 expressed as SO4	T242	A40	0.01	g/l	0.44	0.40	0.69	1.9	3.3
рН	T7	A40			7.6	7.5	7.7	7.9	7.9
Moisture @ 105 C	T162	AR	0.1	%	26	26	23	22	24
Retained on 2mm	T2	A40	0.1	%	<0.1	<0.1	<0.1	<0.1	<0.1

Index to symbols used in 458895-1

Value	Description				
A40	Assisted dried < 40C				
AR	As Received				
М	Analysis is MCERTS accredited				
N	Analysis is not UKAS accredited				

Notes

Retained on 2mm is removed before analysis

Method Index

Value	Description					
T7	Probe					
T242	2:1 Extraction/ICP/OES (TRL 447 T1)					
T162	Grav (1 Dec) (105 C)					
T2	Grav					

Accreditation Summary

Determinand	Method	Test Sample	LOD	Units	Symbol	SAL References
(Water Soluble) SO4 expressed as SO4	T242	A40	0.01	g/l	М	001-005
pH	T7	A40			М	001-005
Moisture @ 105 C	T162	AR	0.1	%	N	001-005
Retained on 2mm	T2	A40	0.1	%	N	001-005

APPENDIX D

Bomb Map

Colour Key References (for guidance only)

Black

Total destruction

Purple Damaged beyond repair

Dark Red Seriously damaged; doubeful if repairable

Light Red Seriously damaged, but repairable at cost

Orange General blast damage - not structural

Yellow Blast damage, minor in nature

Light Blue Clearance arcas

Light Green Clearance areas



VI flying bomb






Site: 465-467 Finchley Road STL: J12147 Fig No: A

06 March 2015 Date: Bomb Map



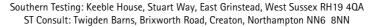




APPENDIX E

PDisp Analysis




Figure U1

SOUTHERN TESTING LABORATORIES

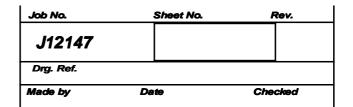




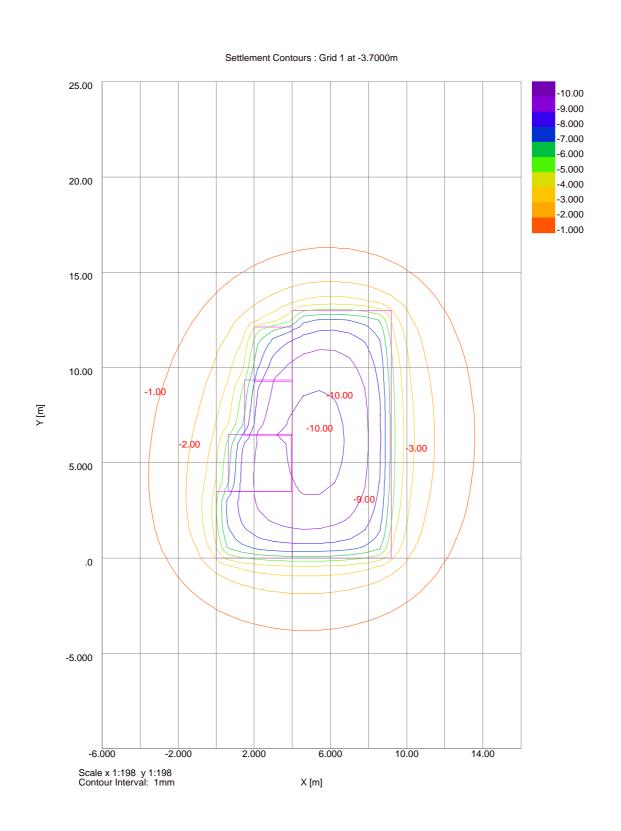



SOUTHERN TESTING LABORATORIES

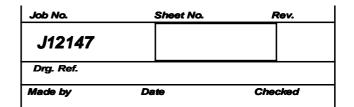

Longterm Drained Heave Figure V1

