


# **Specification Key**

1. External Walls: 1a. Red Buff textured clav brickwork. 1b. Warm-Grey mortar to brickwork and blockwork, flush pointed. 1c. Precast reconstituted stone profiled banding and balcony projections, as Blackhill Natural by cornish concrete or similar to smooth finish. 1d. Staffordshire blue brickwork base brick. 1e. Precast reconstituted stone window and balcony sills to match 1c

banding. 1f. Prefabricated brick lintels to 1st-4th floor to match 1a brickwork. 1g. Precast reco weathered). 1h. Bespoke PPC metalwork MVHR extract grilles to each unit, concealed within lintel recess. 1i. 25mm thick and 215mm deep render reveals to 1st-4th floor doors, windows, balcony walls and domestic door recesses. Colour to match 1c banding. 1j. Precast signage to domestic and communal doorways to match 1c Banding. 1k. Pre-cast reconstituted stone canopy to match 1c banding.

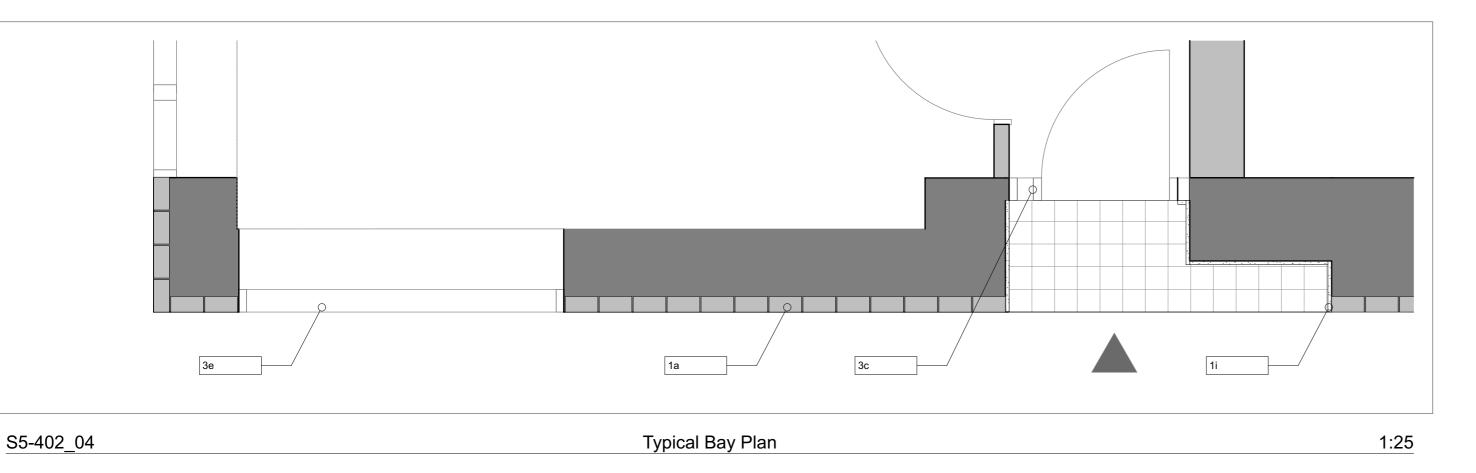

**2. Recessed Balconies** 2a. Fair faced precast concrete to balcony slab to match 1c Banding. 2b. Soffit in cementitious board/render finish to match 1c. 2c. Bespoke PPC metalwork balustrading with flat bar uprights and horizontals finished in PPC RAL 8014 Sepia brown. 2d. Concrete pavers to floor to match precast concrete. 2e. 25mm render reveals and render finish to all balcony walls, colour to match Concrete 1c.

## 3. Windows & Doors:


3a. Composite timber & aluminum windows, PPC Grey beige RAL1019 max frame size 54mm. Balcony doors/windows to be PPC Grey beige RAL 1019.
Balcony doors/windows to be PPC Grey beige (RAL 1019) coloured leaf with glazed fanlight above and rest of frame as Sepia brown RAL 8014.
Communal opening doors to match balustrading (as 2d) RAL 8014 Sepia brown and the fixed frames as PPC RAL 8014 Sepia brown. 3e. Window balustrading to match balcony balustrading (as 2d) RAL 8014 Sepia brown. 3g. Gates and railings within landscape to colour match building balustrading (RAL 8014), refer to landscape architect drawings for more details. 3e. All ground floor windows to be flush and match 3a.

4. Roofs: 4a. Green/brown roof. 4b. Roof access hatch.

**5. Rain Water:** 5a. Internal DP's within core. 5b. External DP's to rear elevation to be metal PPC RAL 8014 Sepia brown. 5c. Hopper head PPC to match 5b. 5d. PPC Sepia brown RAL 8014.





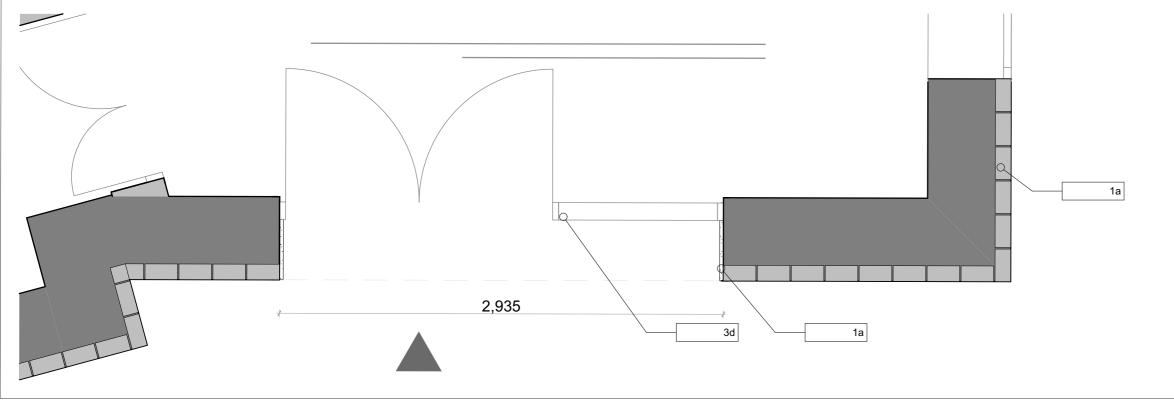



# **Specification Key**

**1. External Walls:** 1a. Red Buff textured clay brickwork. 1b. Warm-Grey mortar to brickwork and blockwork, flush pointed. 1c. Precast reconstituted stone profiled banding and balcony projections, as Blackhill Natural by cornish concrete or similar to smooth finish. 1d. Staffordshire blue brickwork base brick.
1e. Precast reconstituted stone window and balcony sills to match 1c 1f. Prefabricated brick lintels to 1st-4th floor to match 1a brickwork. 1g. Precast reconstituted stone coping to match 1c Banding (once weathered). 1h. Bespoke PPC metalwork MVHR extract grilles to each unit, concealed within lintel recess. 1i. 25mm thick and 215mm deep render reveals to 1st-4th floor doors, windows, balcony walls and domestic door recesses. Colour to match 1c banding. 1j. Precast signage to domestic and communal doorways to match 1c

S5-401 03


Communal Entrance Plan

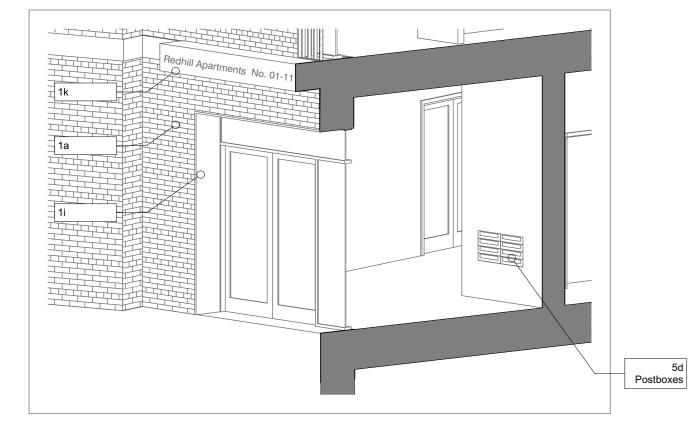

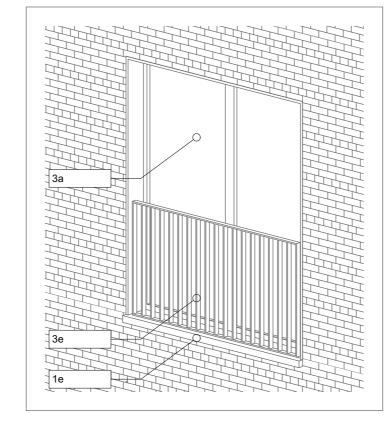

S5-401 05 Typical Large Window Axo



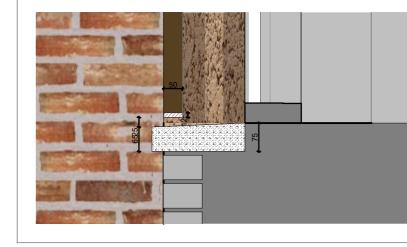

S5-401 06 Typical sill detail

### S5-401 04 Communal Entrance Axo



Banding. 1k. Pre-cast reconstituted stone canopy to match 1c banding.

### 2. Recessed Balconies

2a. Fair faced precast concrete to balcony slab to match 1c Banding. 2b. Soffit in cementitious board/render finish to match 1c. 2c. Bespoke PPC metalwork balustrading with flat bar uprights and horizontals finished in PPC RAL 8014 Sepia brown. 2d. Concrete pavers to floor to match precast concrete. 2e. 25mm render reveals and render finish to all balcony walls, colour to match Concrete 1c.

3. Windows & Doors: 3a. Composite timber & aluminum windows, PPC Grey beige RAL1019 max frame size 54mm. 3b. Balcony doors/windows to be PPC Grey beige RAL 1019. 3c. Domestic front panel doors to be PPC Grey beige (RAL 1019) coloured leaf with glazed fanlight above and rest of frame as Sepia brown RAL 8014. 3d. Communal opening doors to match balustrading (as 2d) RAL 8014 Sepia brown and the fixed frames as PPC RAL 8014 Sepia brown. 3e. Window balustrading to match balcony balustrading (as 2d) RAL 8014 Sepia brown. 3g. Gates and railings within landscape to colour match building balustrading (RAL 8014), refer to landscape architect drawings for more details. 3e. All ground floor windows to be flush and match 3a.

# 4. Roofs:

1:10

4a. Green/brown roof. 4b. Roof access hatch.

### 5. Rain Water:

5a. Internal DP's within core. 5b. External DP's to rear elevation to be metal PPC RAL 8014 Sepia brown. 5c. Hopper head PPC to match 5b. 5d. PPC Sepia brown RAL 8014.



1-3 Redhill Street

Redhill Street (North)


New Build Block


Communal Garden

	For materials and details, please refer to 1328_400 series drawings and Design & Access statement section 6, materials page.
	REV.         DATE         DESCRIPTION           In A INSTANCE AND INSTANCE AND
Existing Rothay	a 1 Naoroji Street London WC1X 0GB         t +44 (0)20 7704 6060         e office@mae-Ilp.co.uk         w mae-Ilp.co.uk         w mae-Ilp.co.uk         CLIENT         London Borough of Camden         PROJECT NAME         Regents Park Estate Infill         DRAWING NAME         DICK Collins Hall - West Elevation         STATUS         Planning         IDRAWING NO.         1328-1328-P5-304




New Build Block

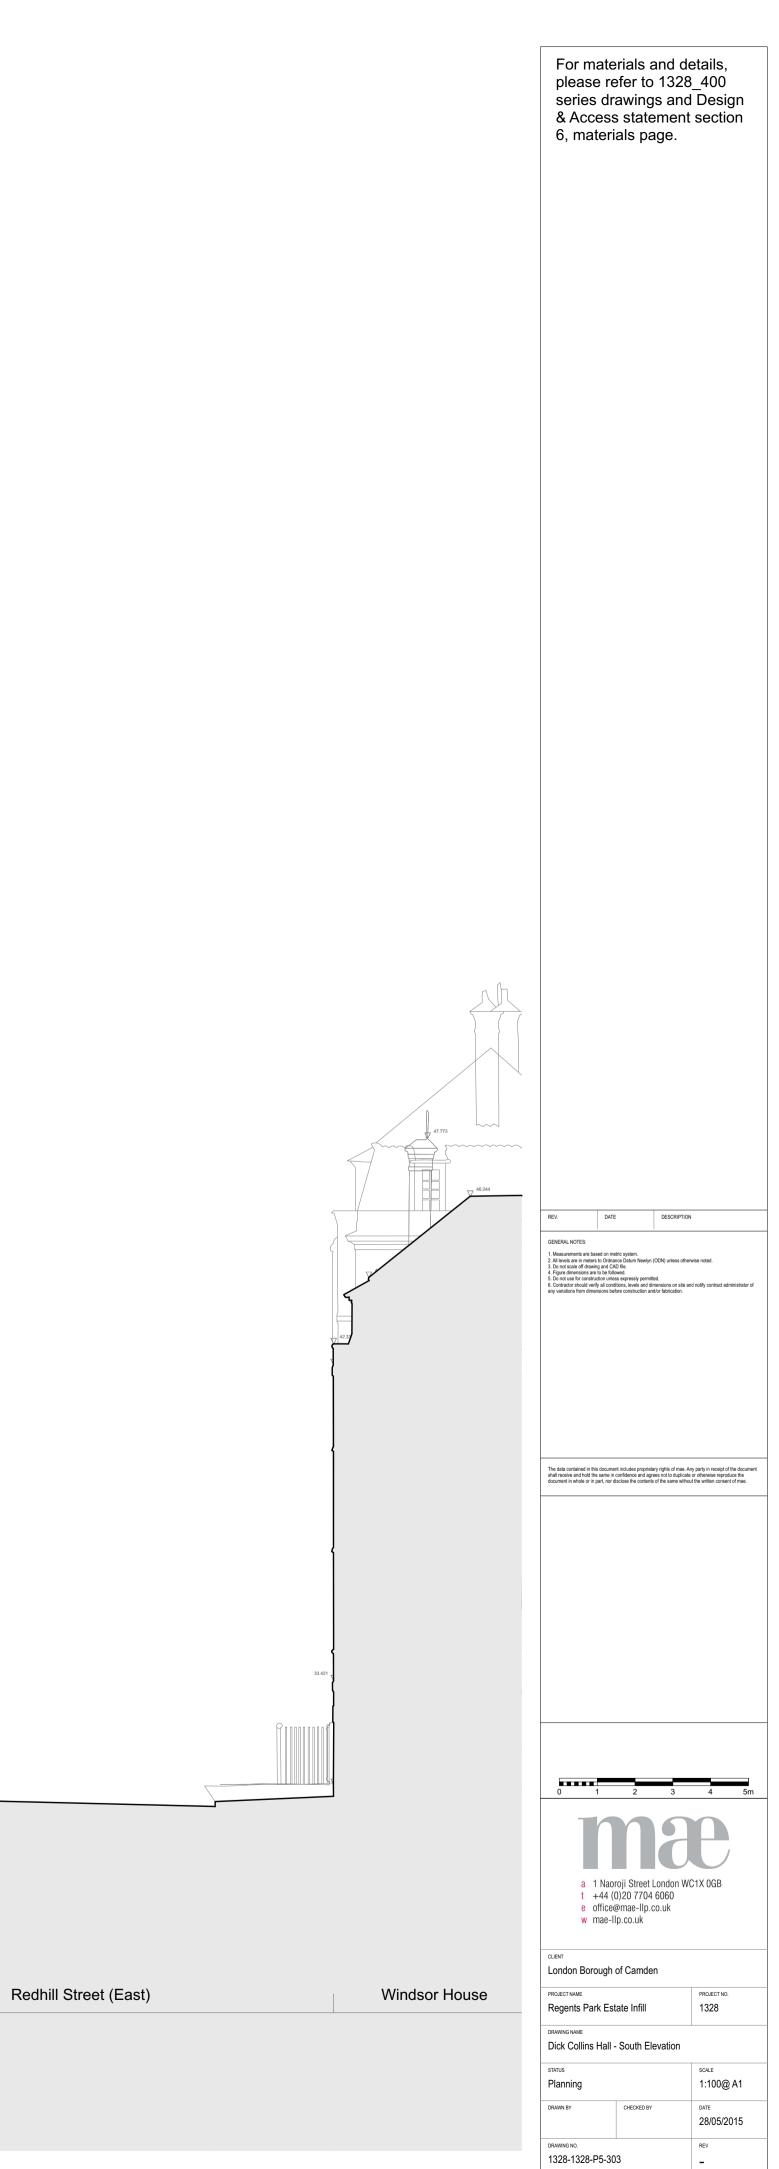


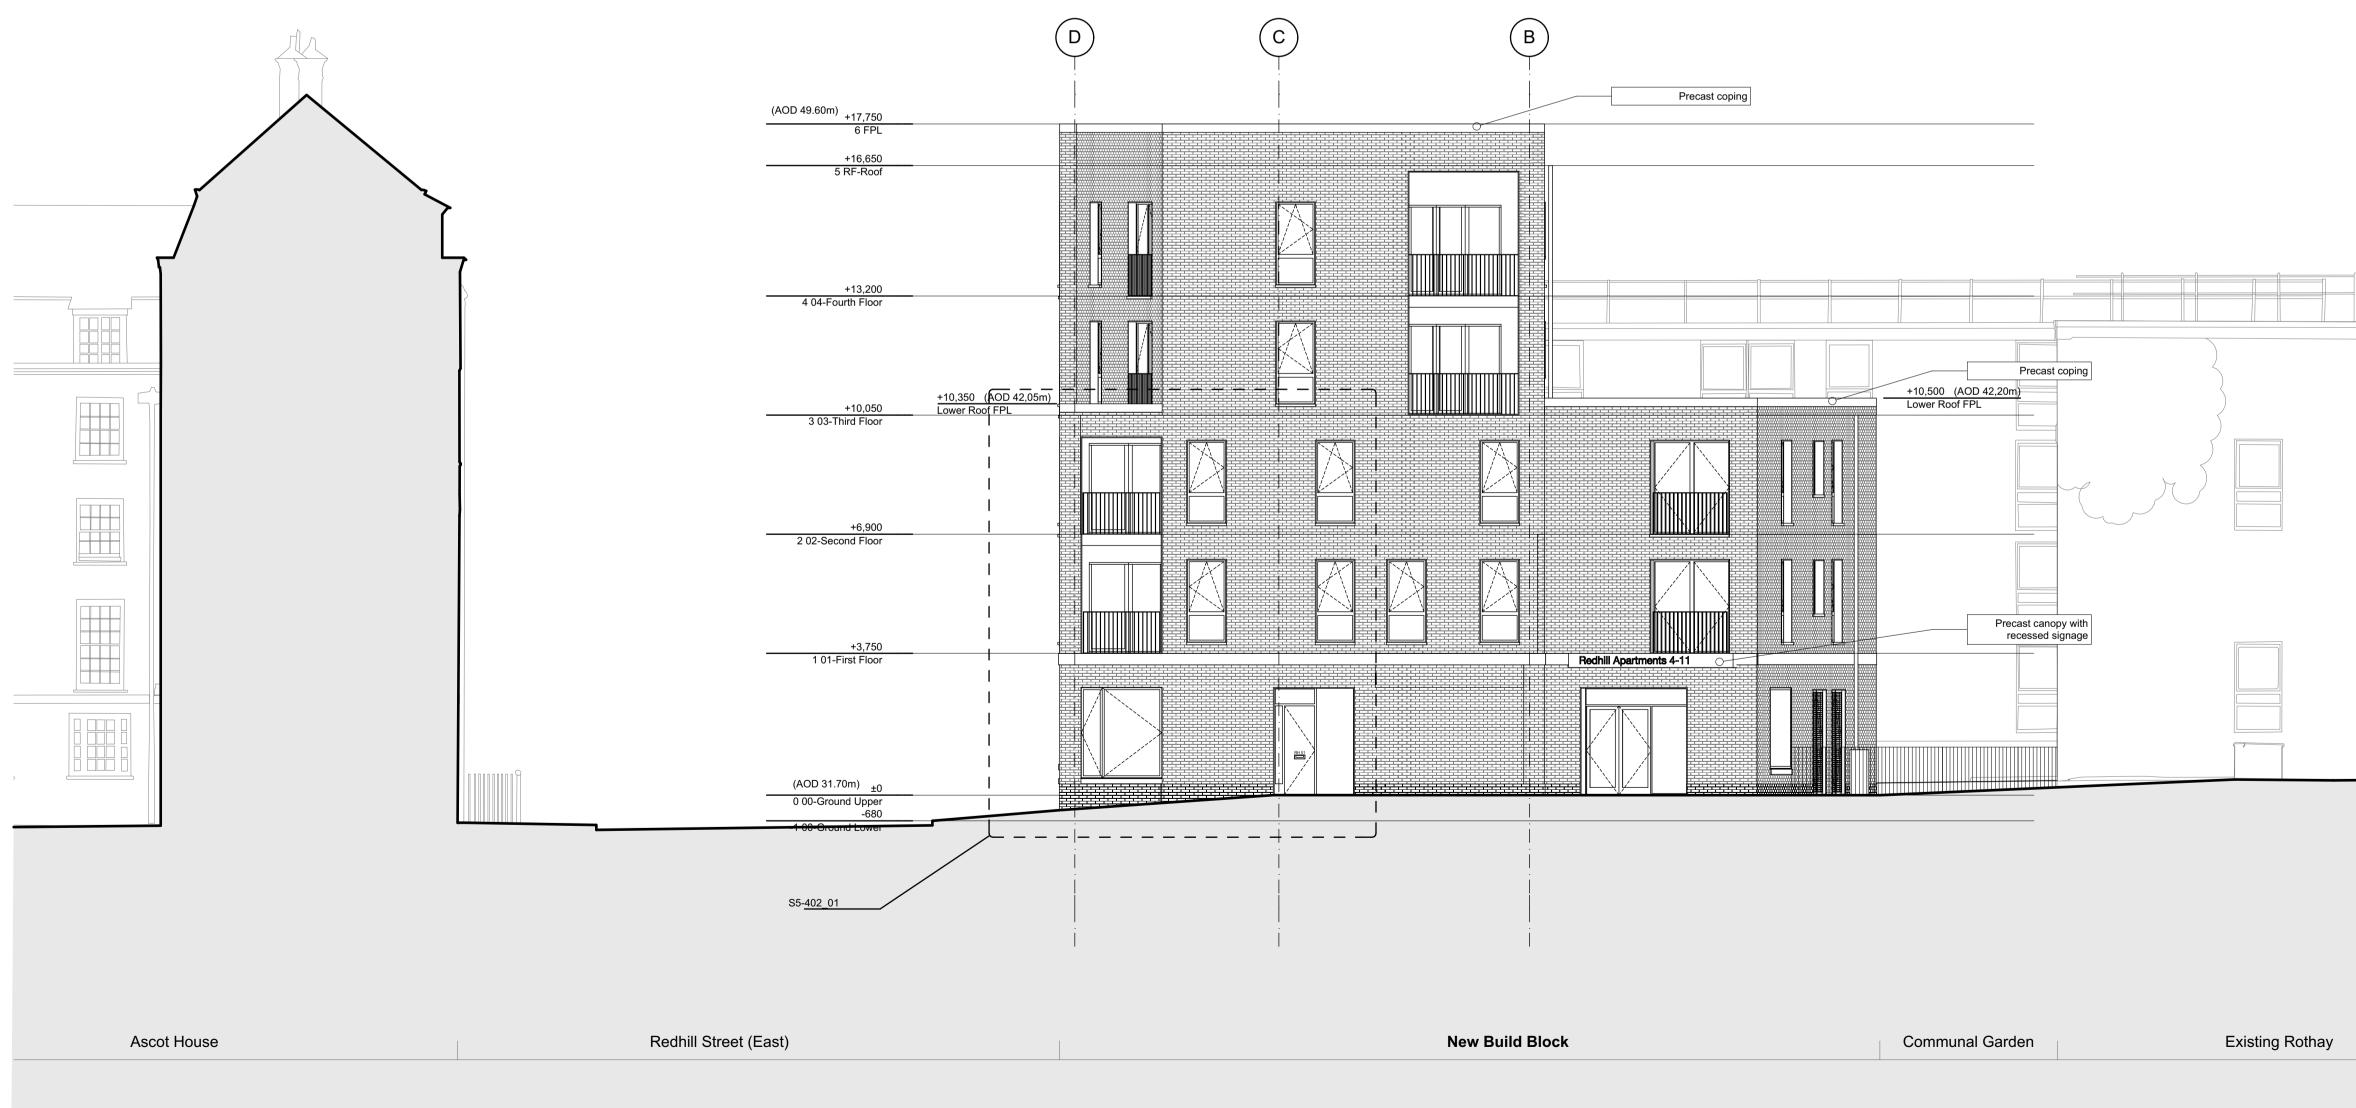

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	Measurements are based on metric system.     All levels are in meters to Orchance Datum Newlyn (ODN) unless a     Do not scale of drawing and CAD file.     Figure dimensions are to be followed.     So not use for construction unses sorpessly permitted.     Contractor should verify all conditions, levels and dimensions on s     any variations from dimensions before construction and/or fabrication	ite and notify contract administrator of n.
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	a 1 Naoroji Street London t +44 (0)20 7704 6060 e office@mae-Ilp.co.uk w mae-Ilp.co.uk	
	CLIENT London Borough of Camden	
Proposed Public Realm	PROJECT NAME Regents Park Estate Infill DRAWING NAME	PROJECT NO. 1328
	Dick Collins Hall - North Elevation	scale 1:100@ A1
	DRAWN BY CHECKED BY	DATE 28/05/2015
	DRAWING NO. 1328-1328-P5-302	REV



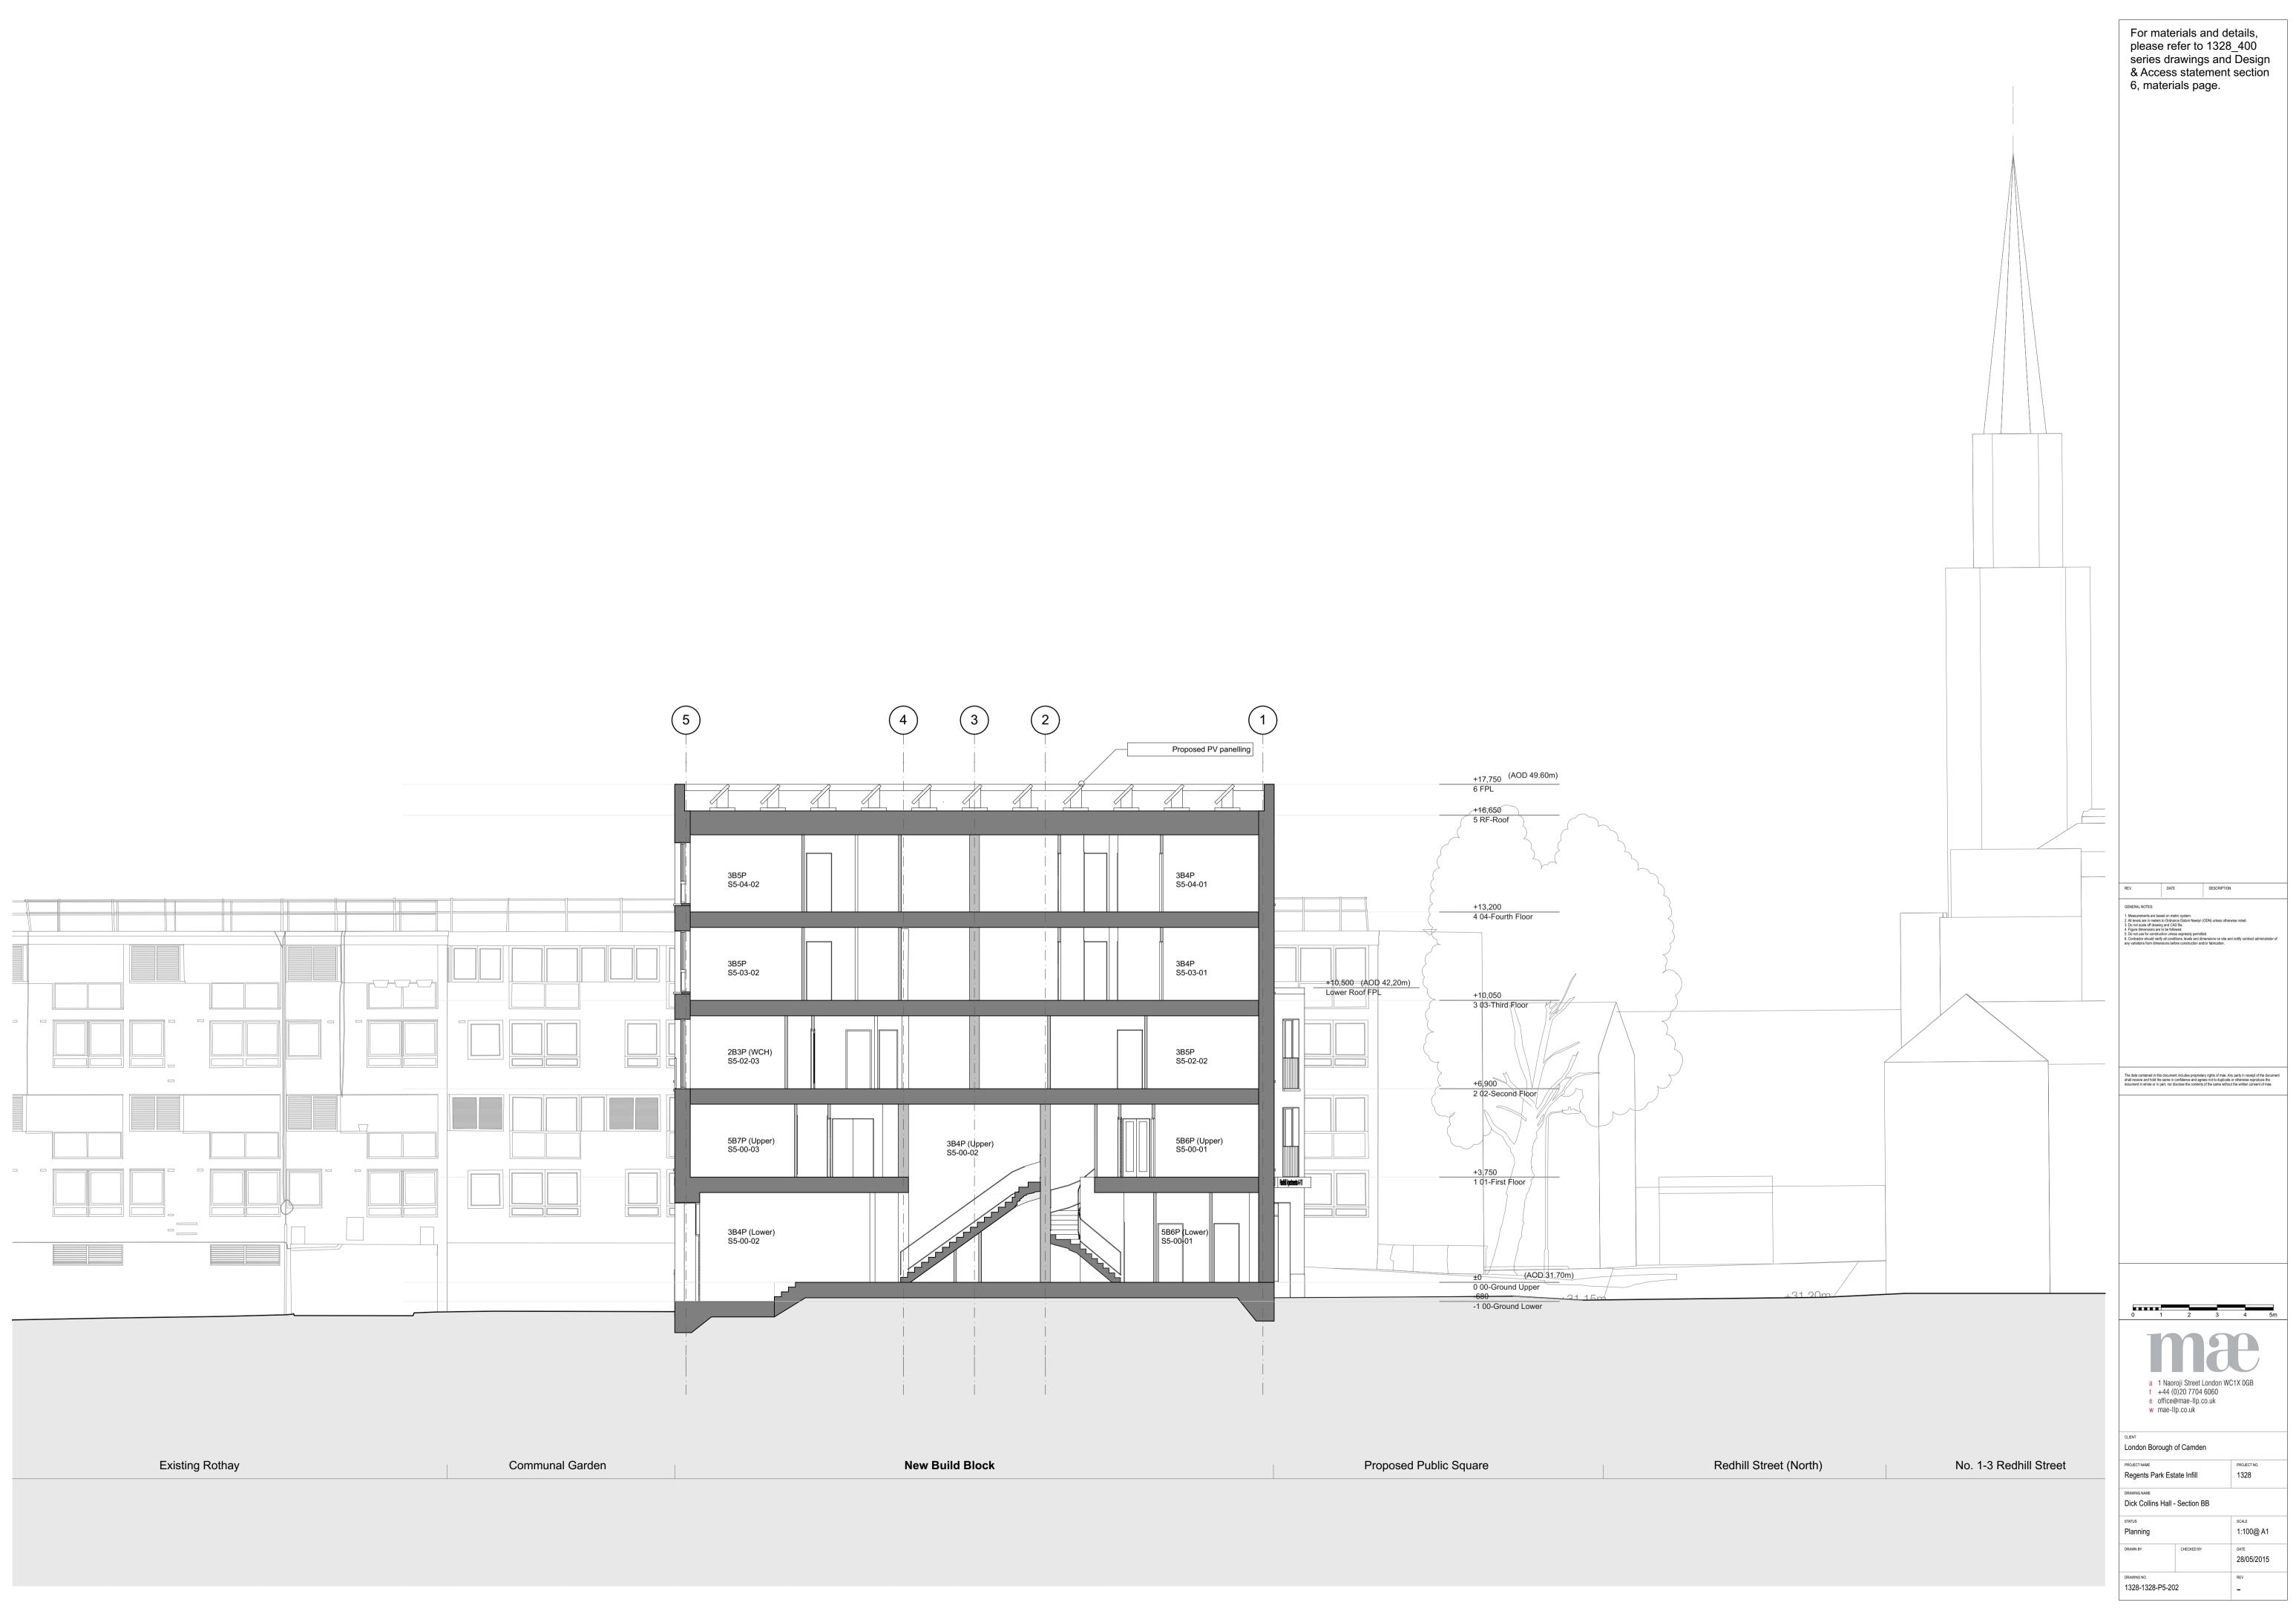

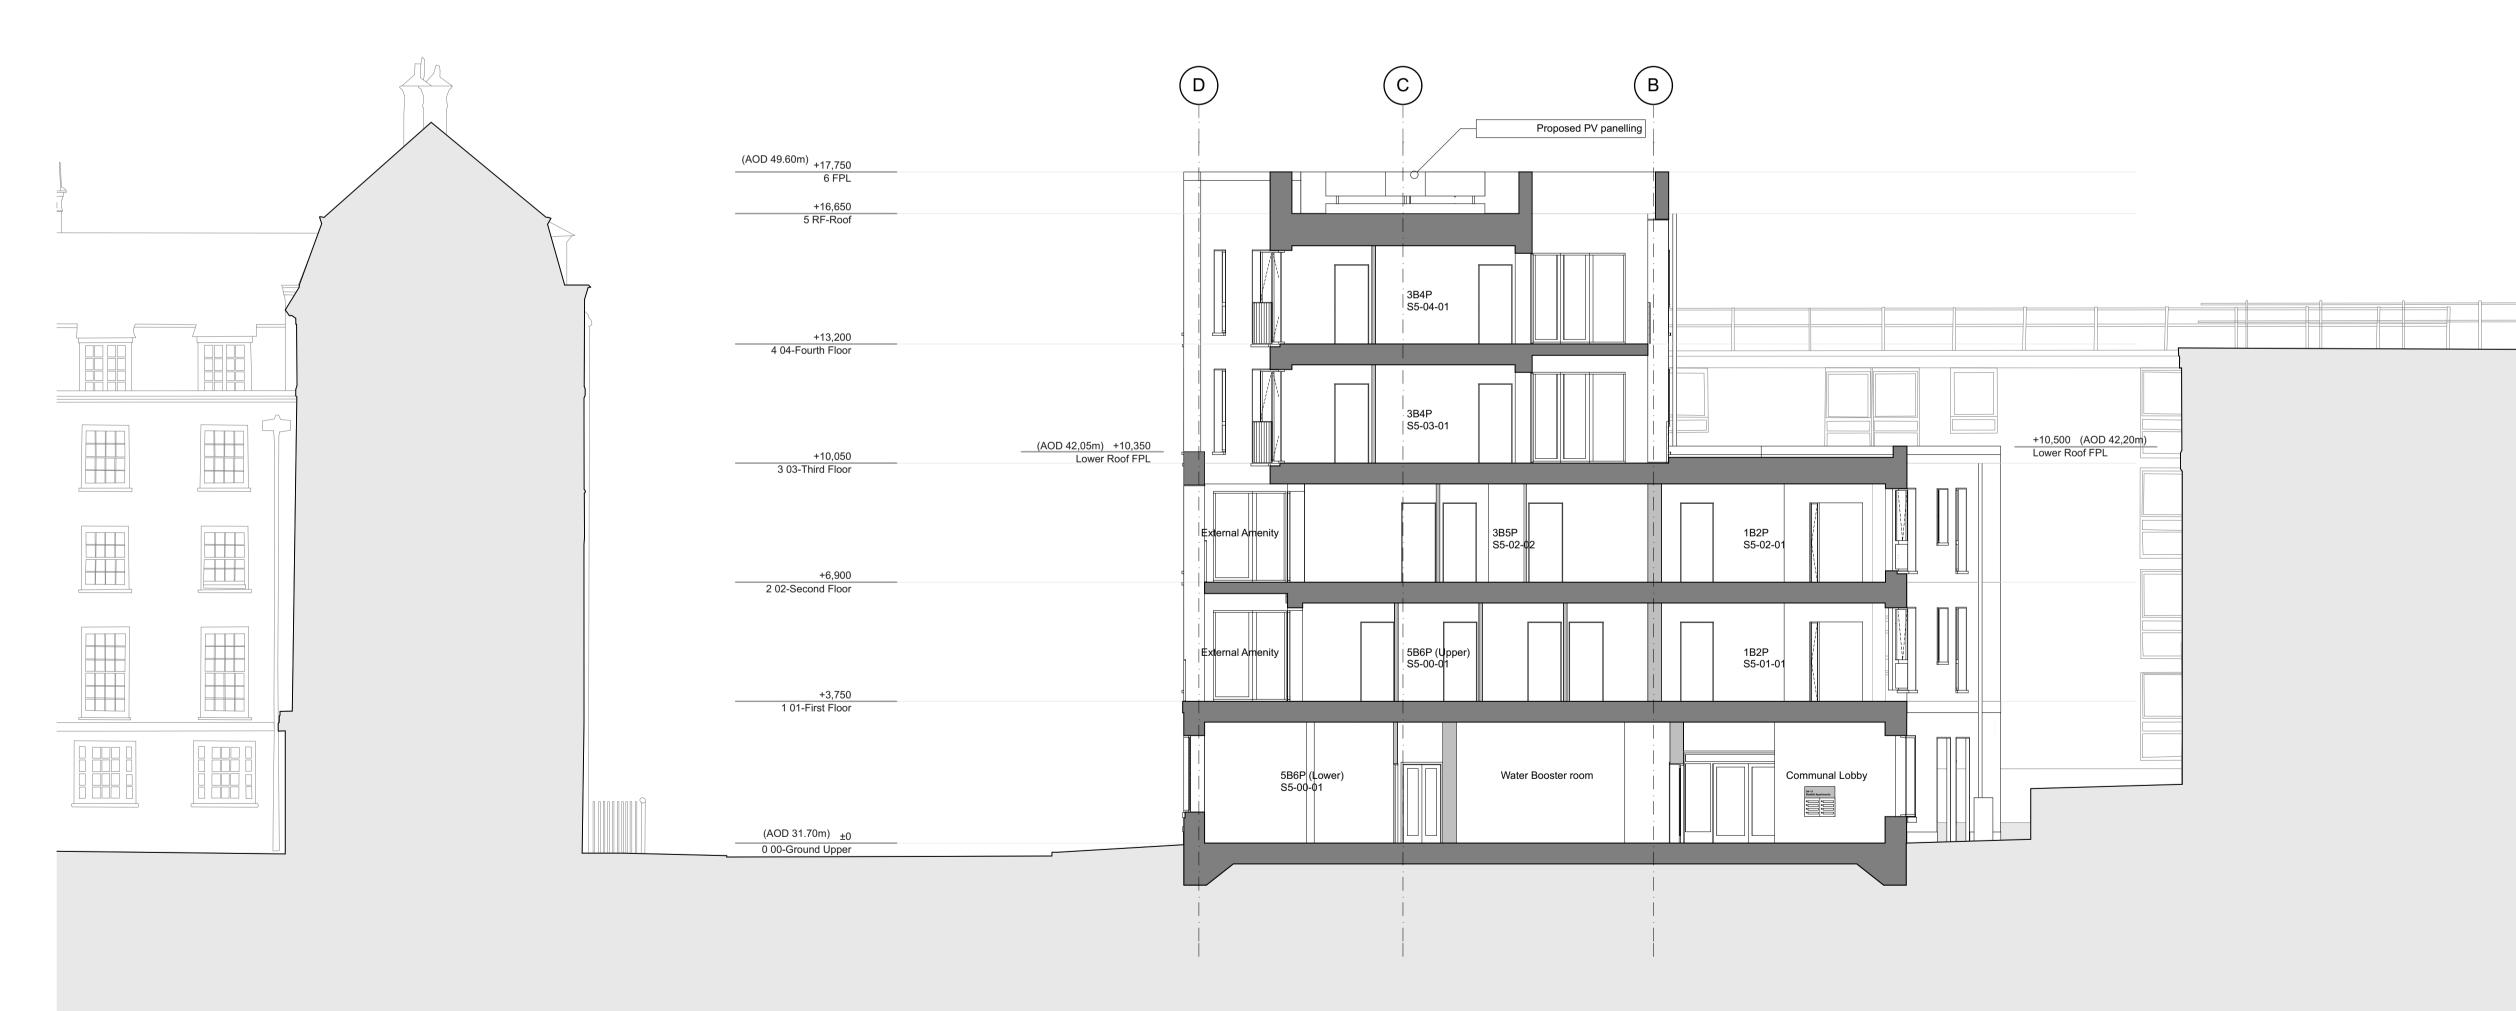

Ascot House

Redhill Street (East)

New Build Block

Communal Garden

Existing Rothay

For materials and details, please refer to 1328\_400 series drawings and Design & Access statement section 6, materials page.

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Proposed Public Realm

0 1 2 3 <u>4</u>5m 10 a 1 Naoroji Street London WC1X 0GB t +44 (0)20 7704 6060 e office@mae-Ilp.co.uk w mae-Ilp.co.uk CLIENT London Borough of Camden PROJECT NO. 1328 PROJECT NAME Regents Park Estate Infill DRAWING NAME Dick Collins Hall - Section AA scale 1:100@ A1 STATUS Planning DRAWN BY DATE 28/05/2015 CHECKED BY REV DRAWING NO. 1328-1328-P5-201 -


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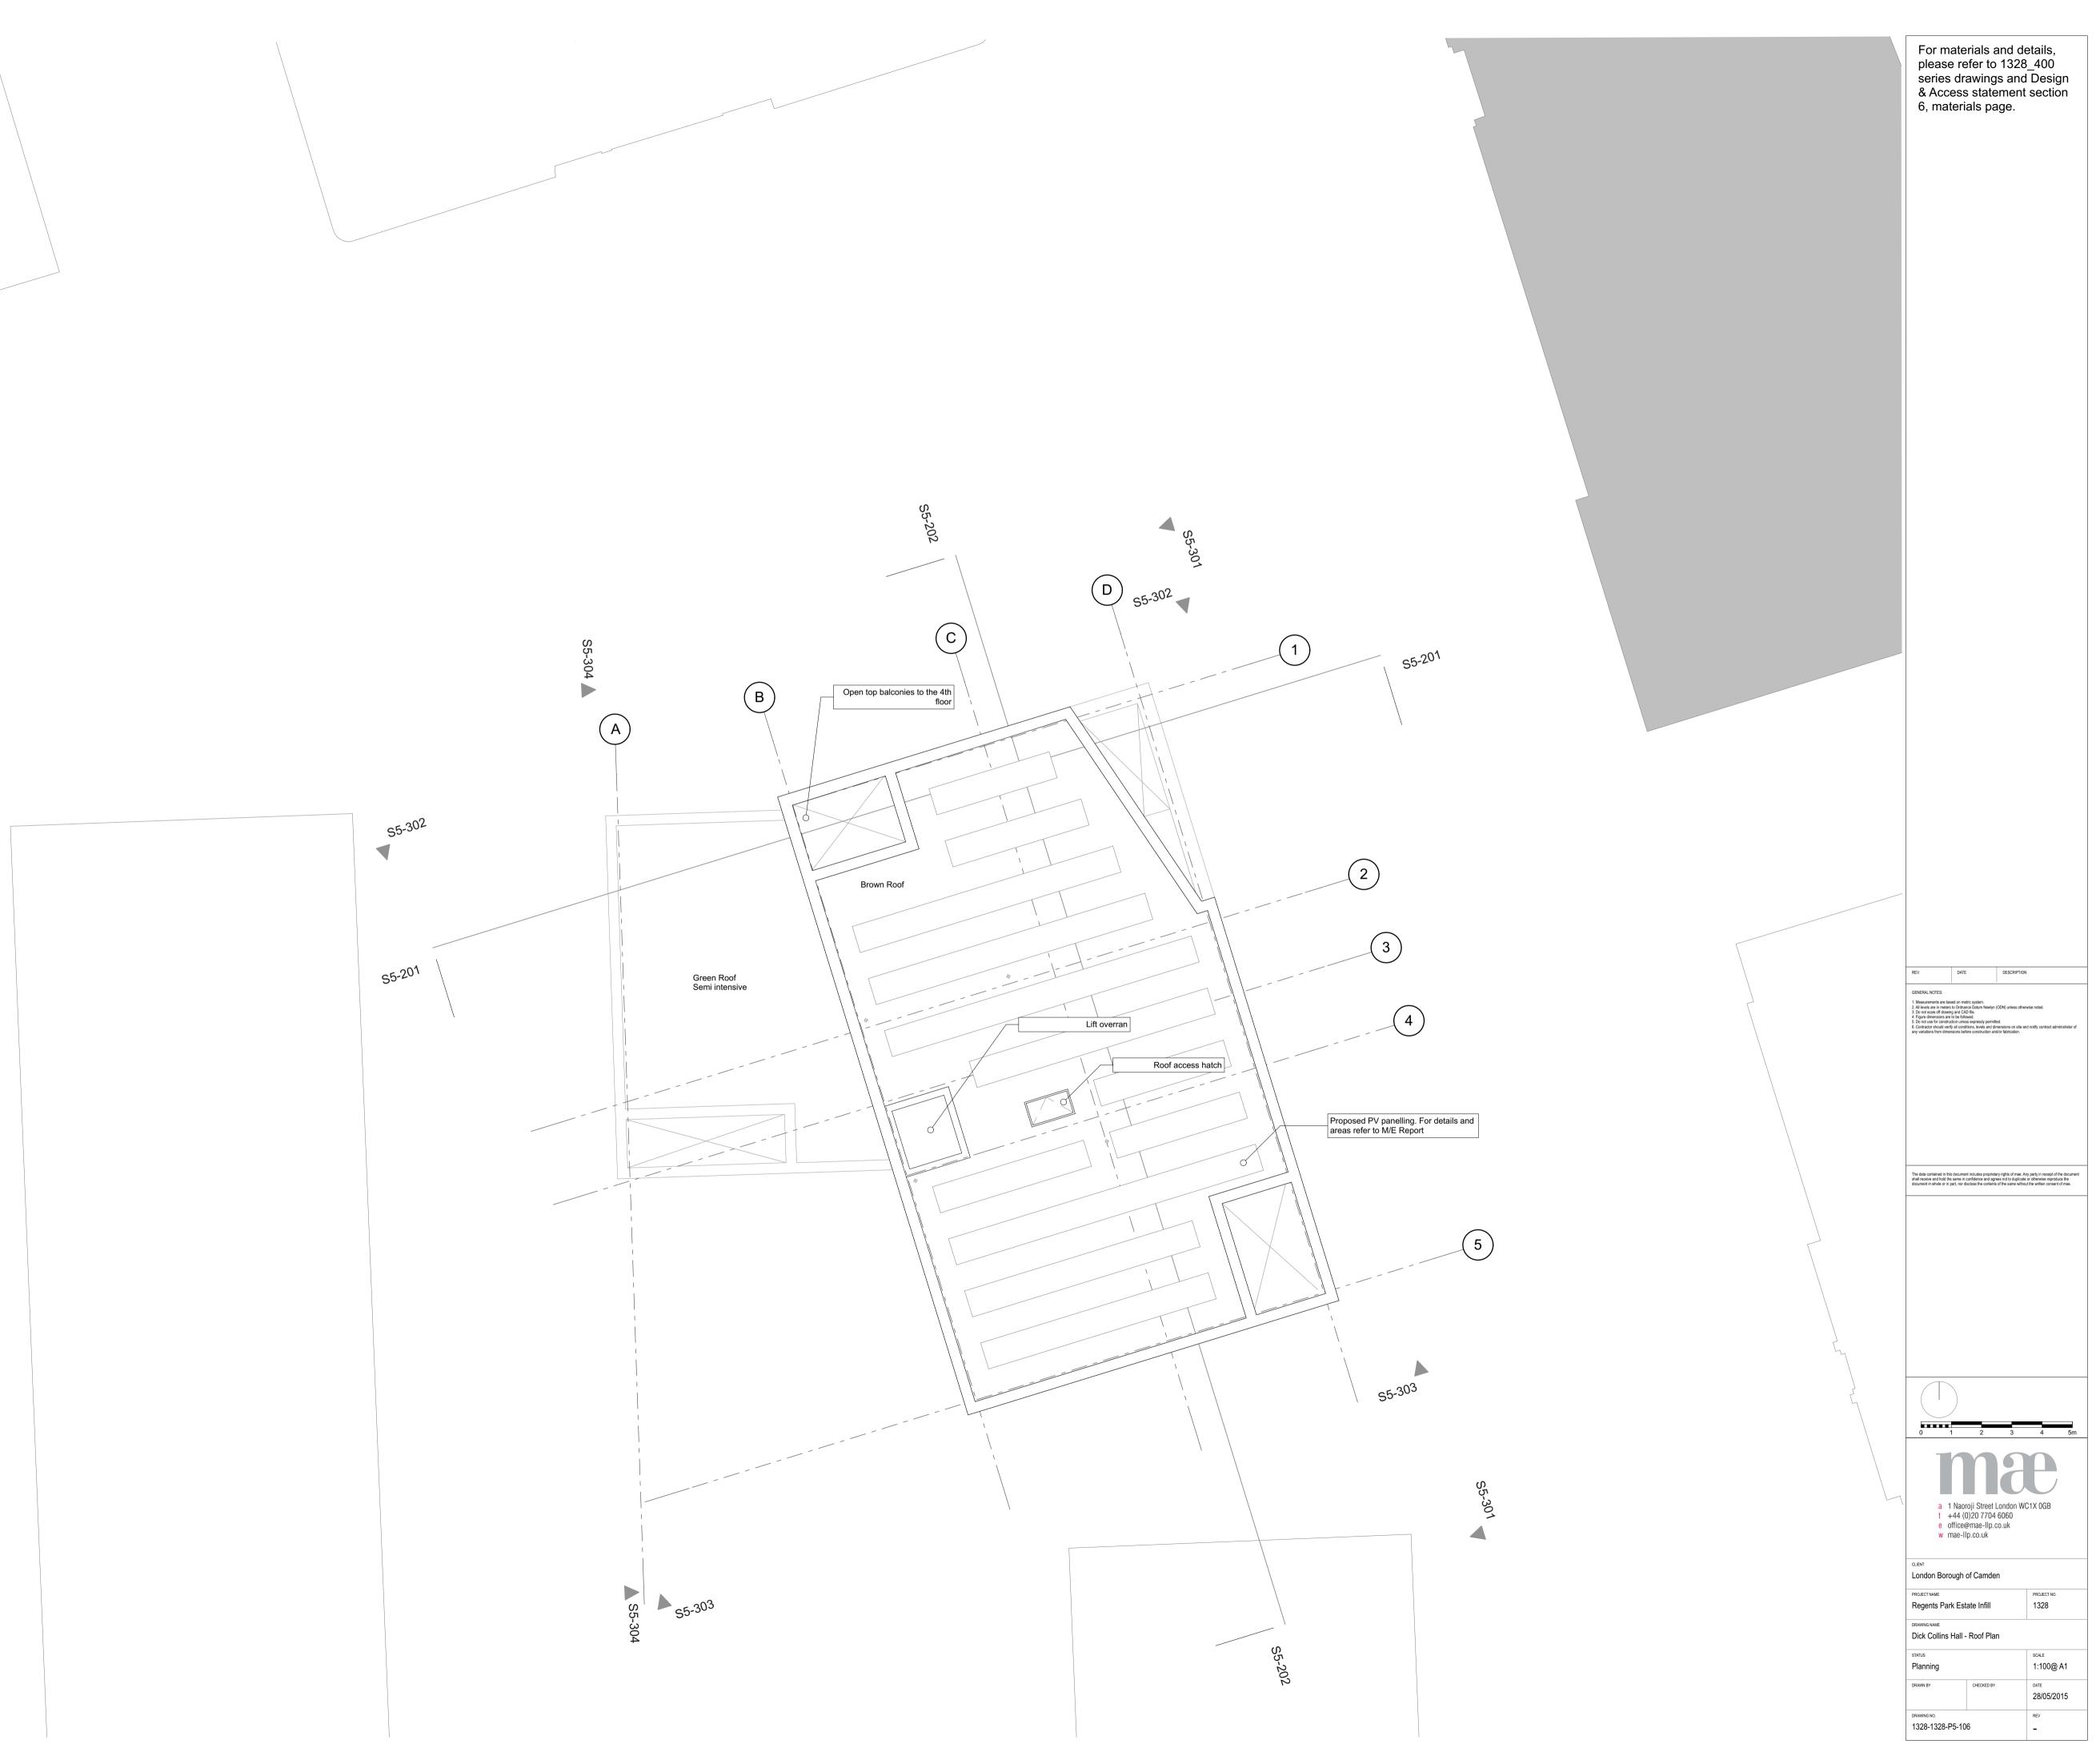
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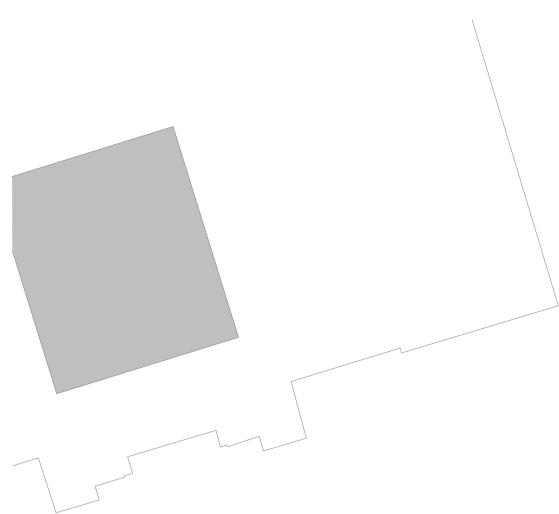
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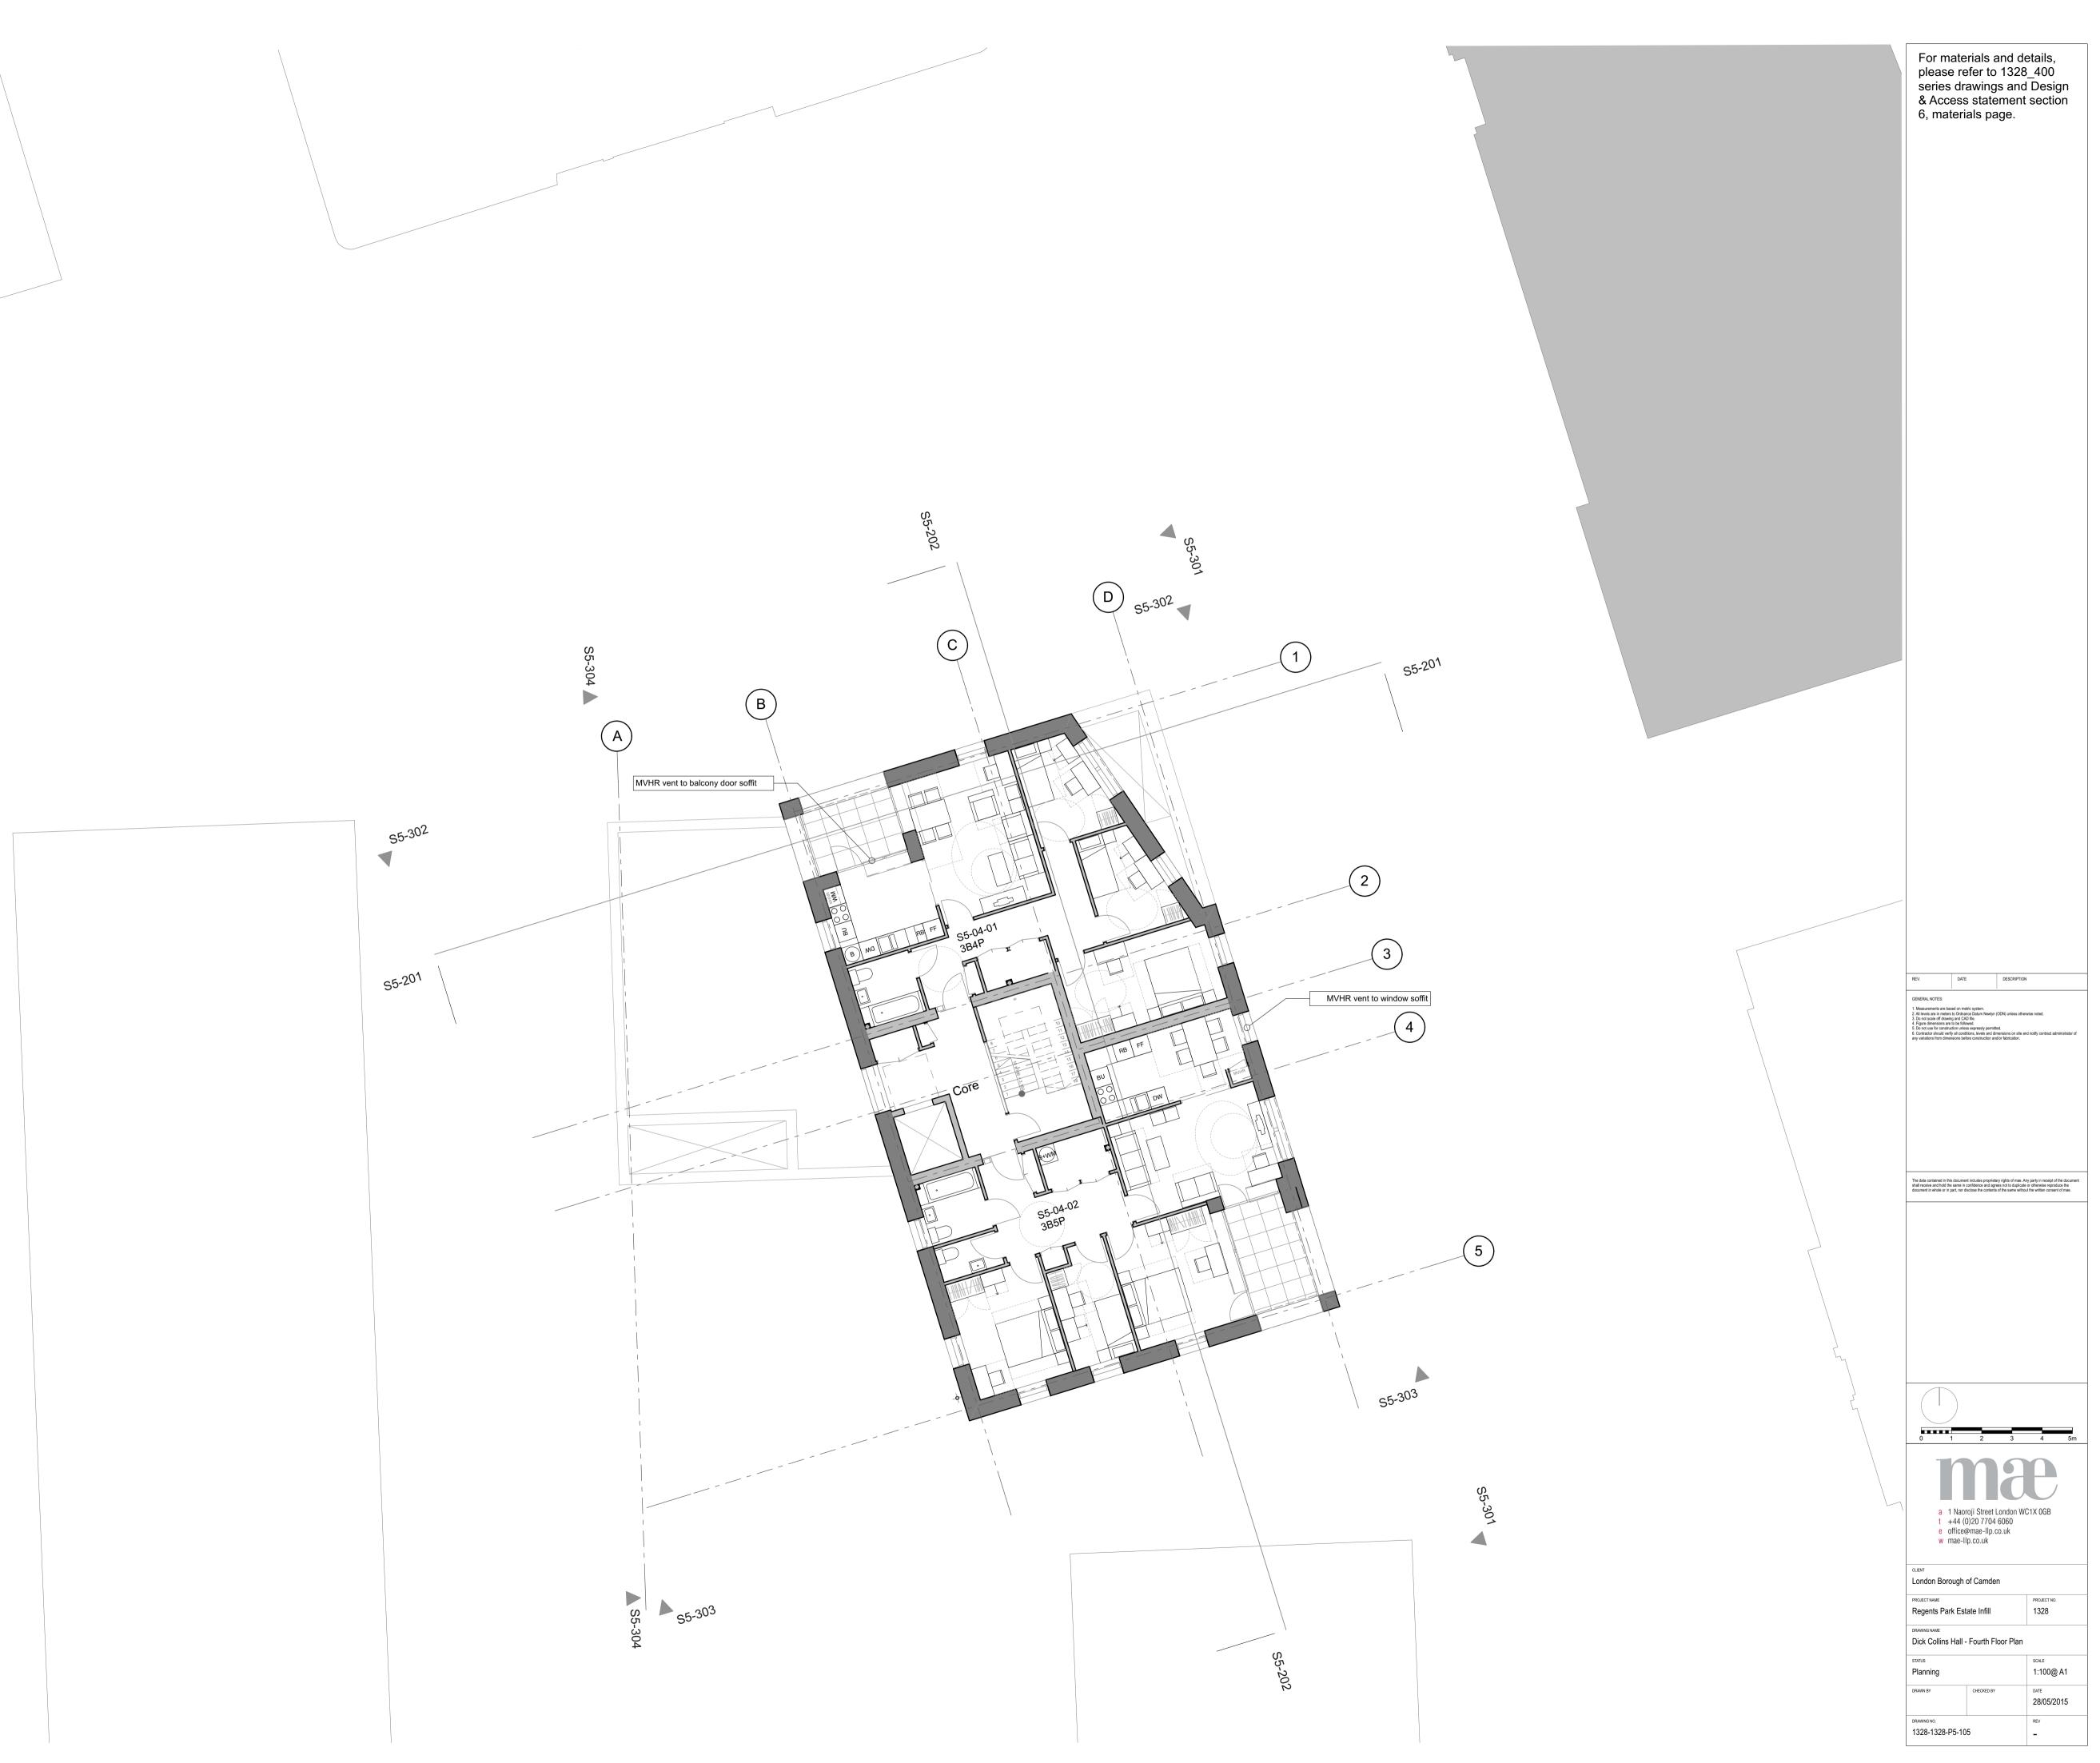
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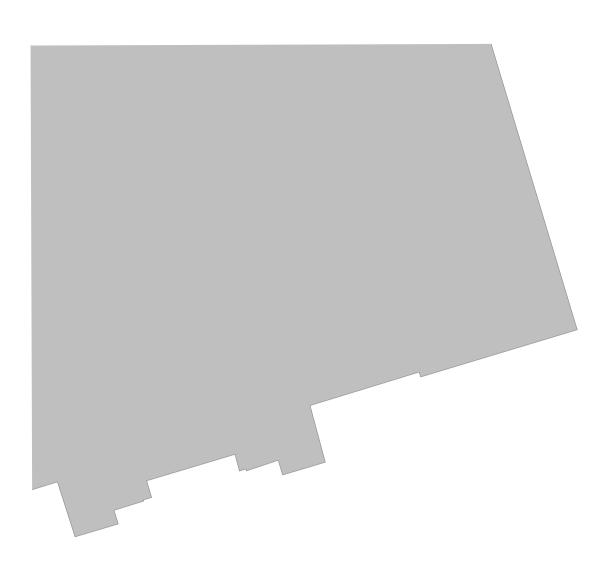
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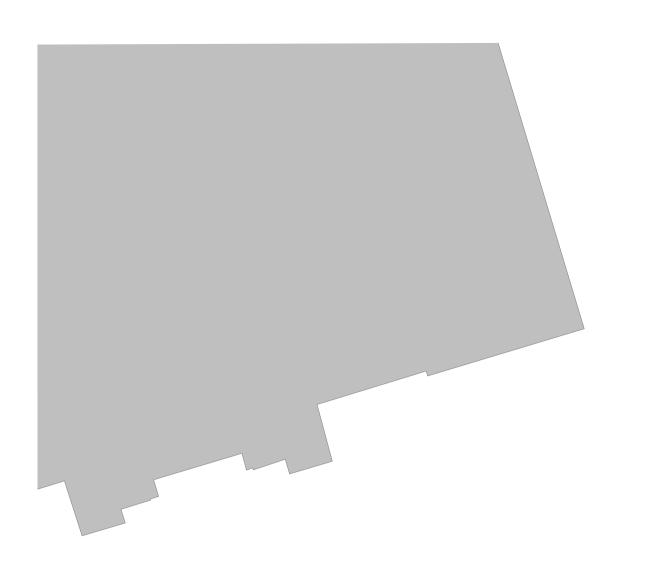







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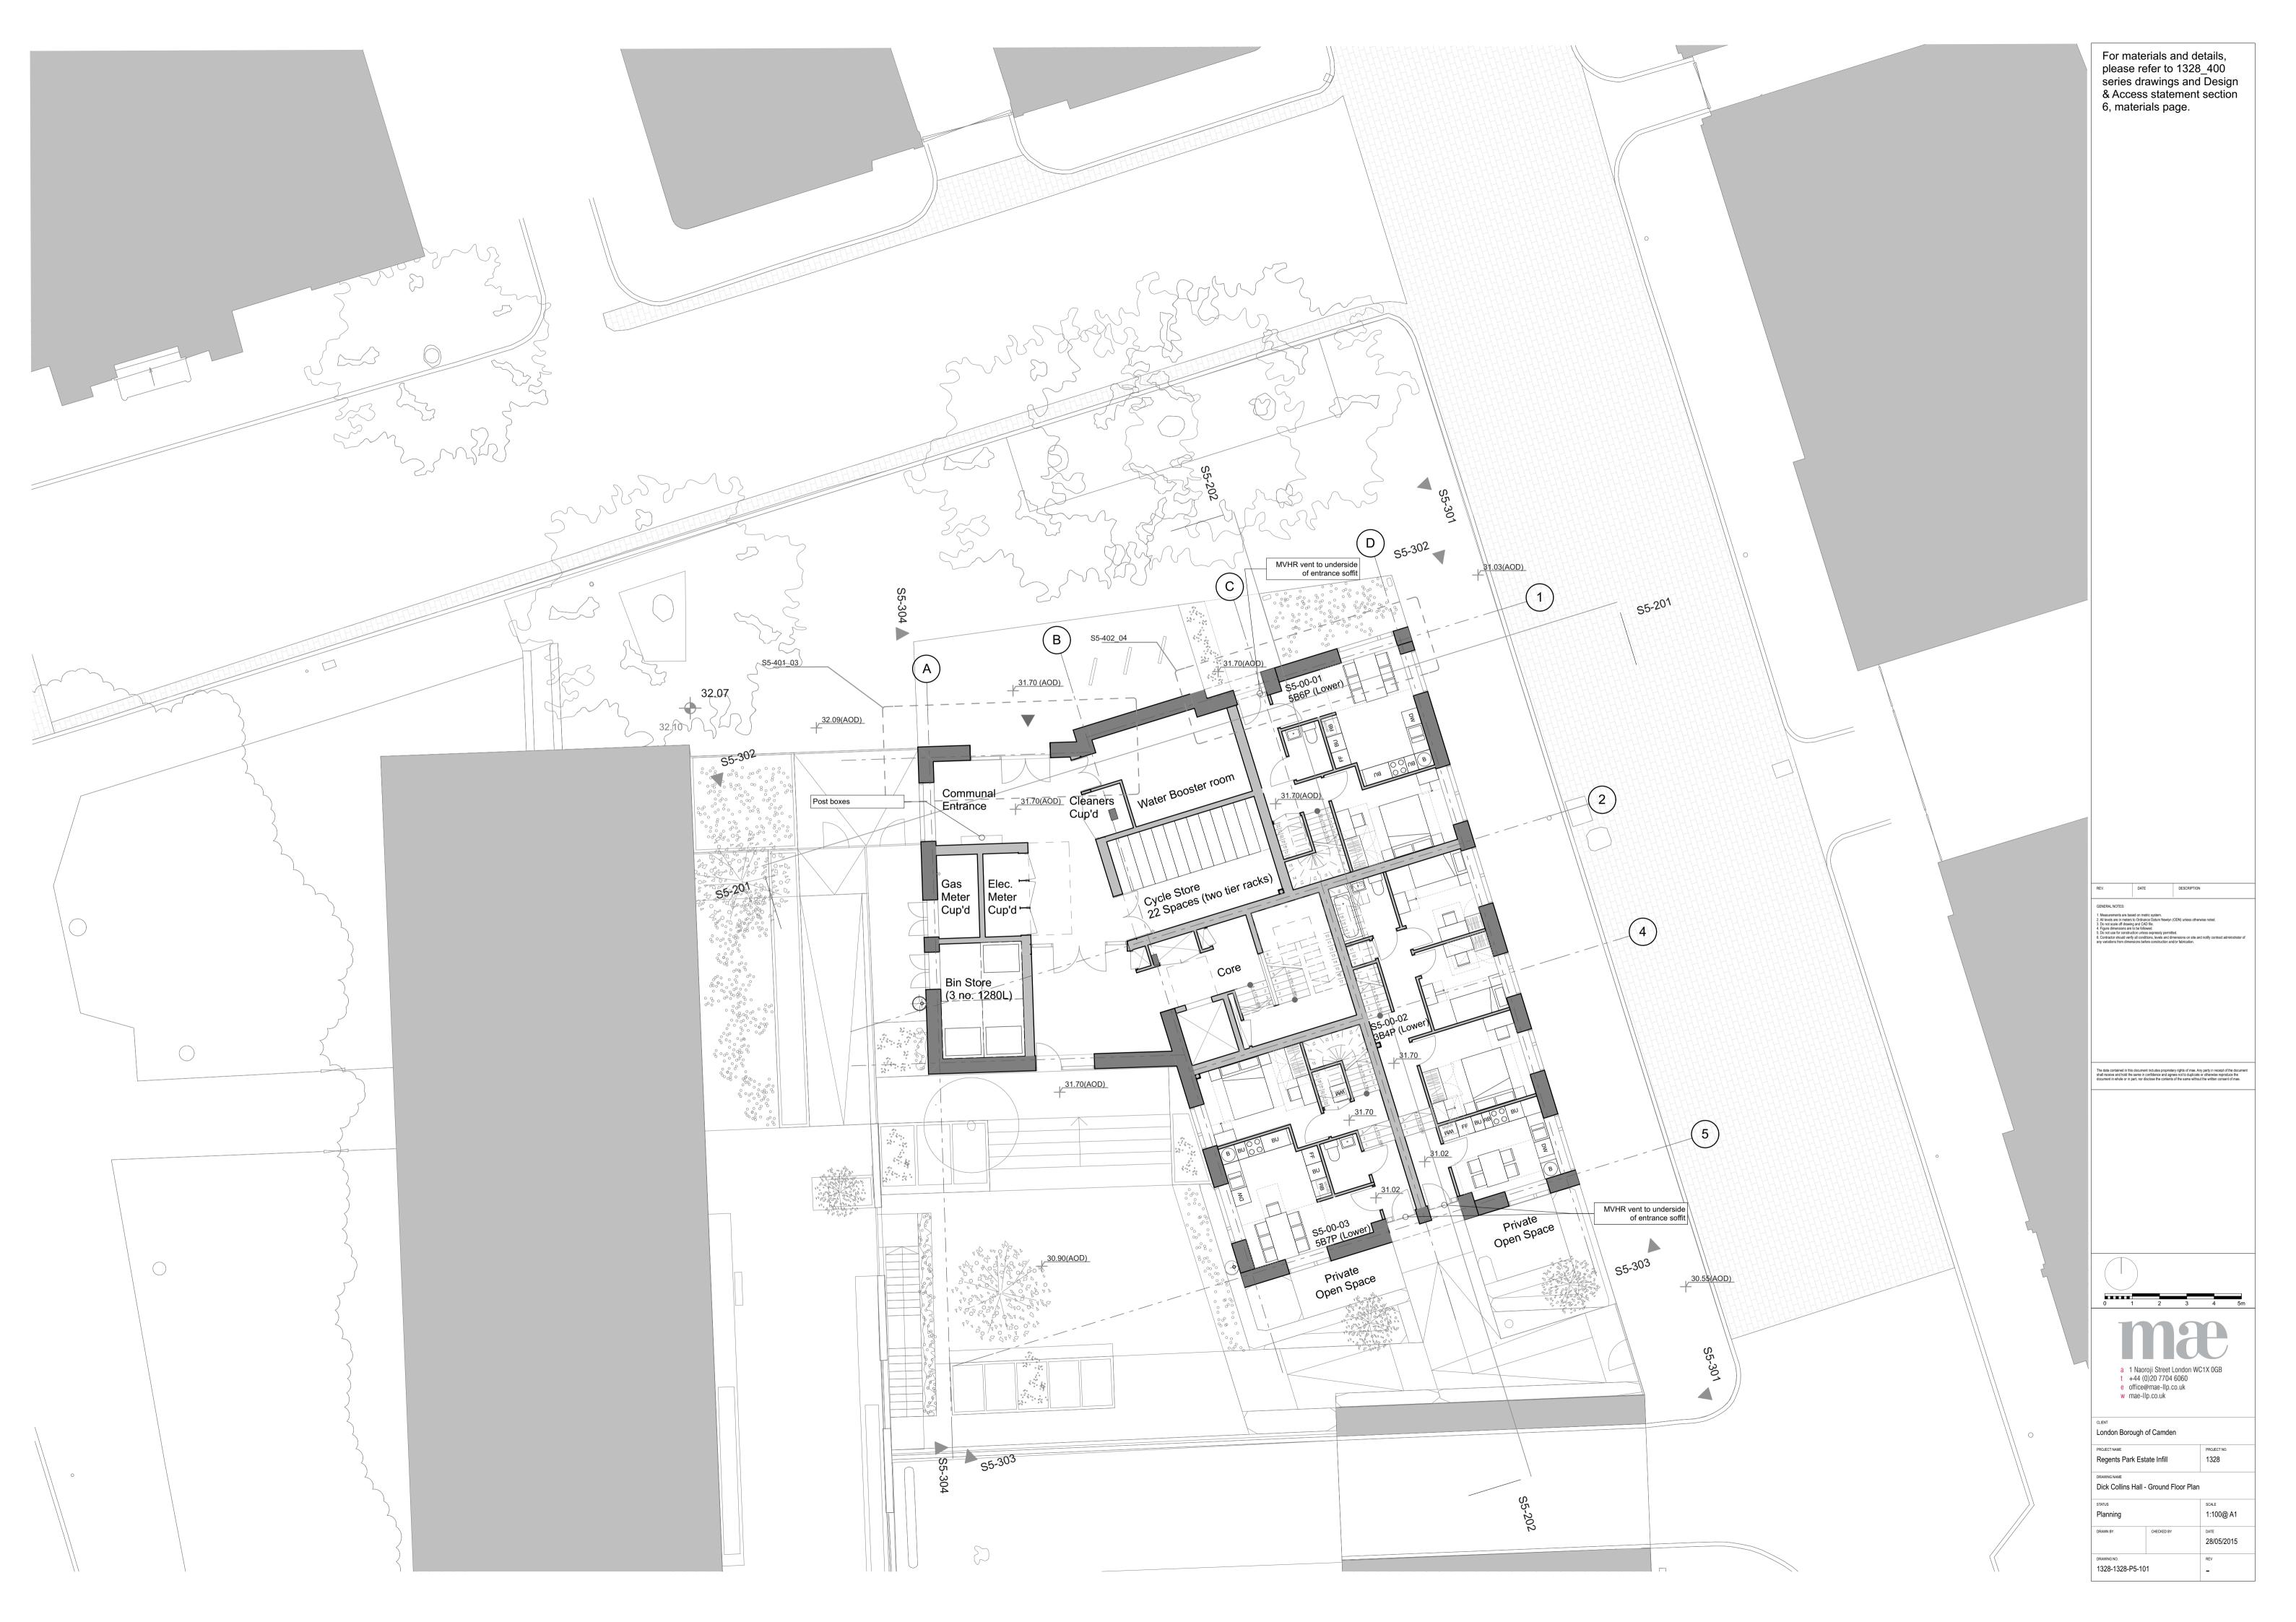
55-302 MVHR vent to window soffit 55-201




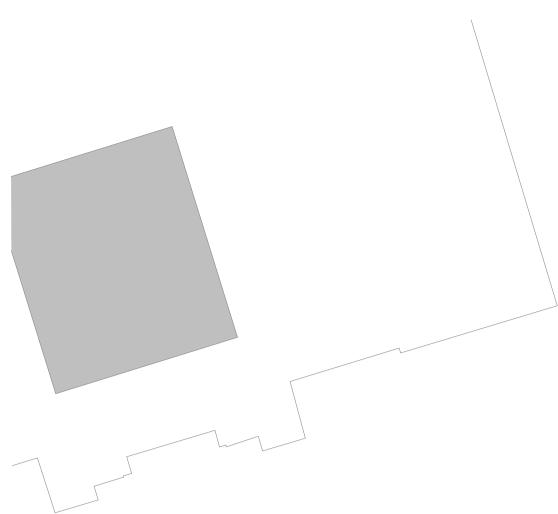

55-302 MVHR vent to window soffit \$5-201



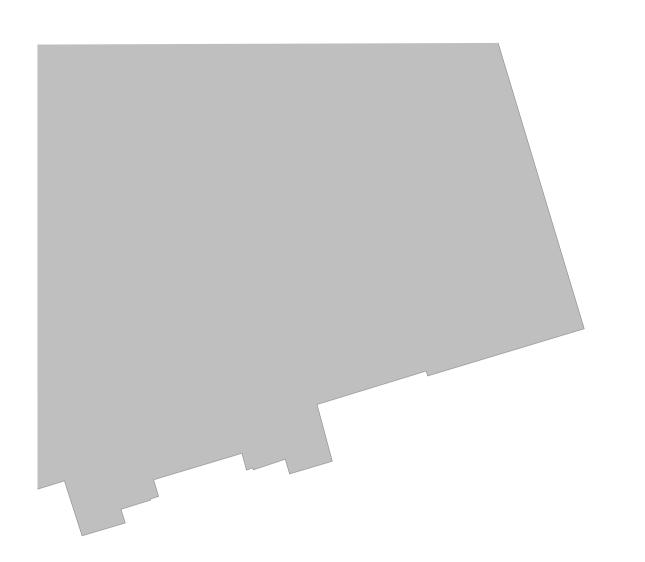

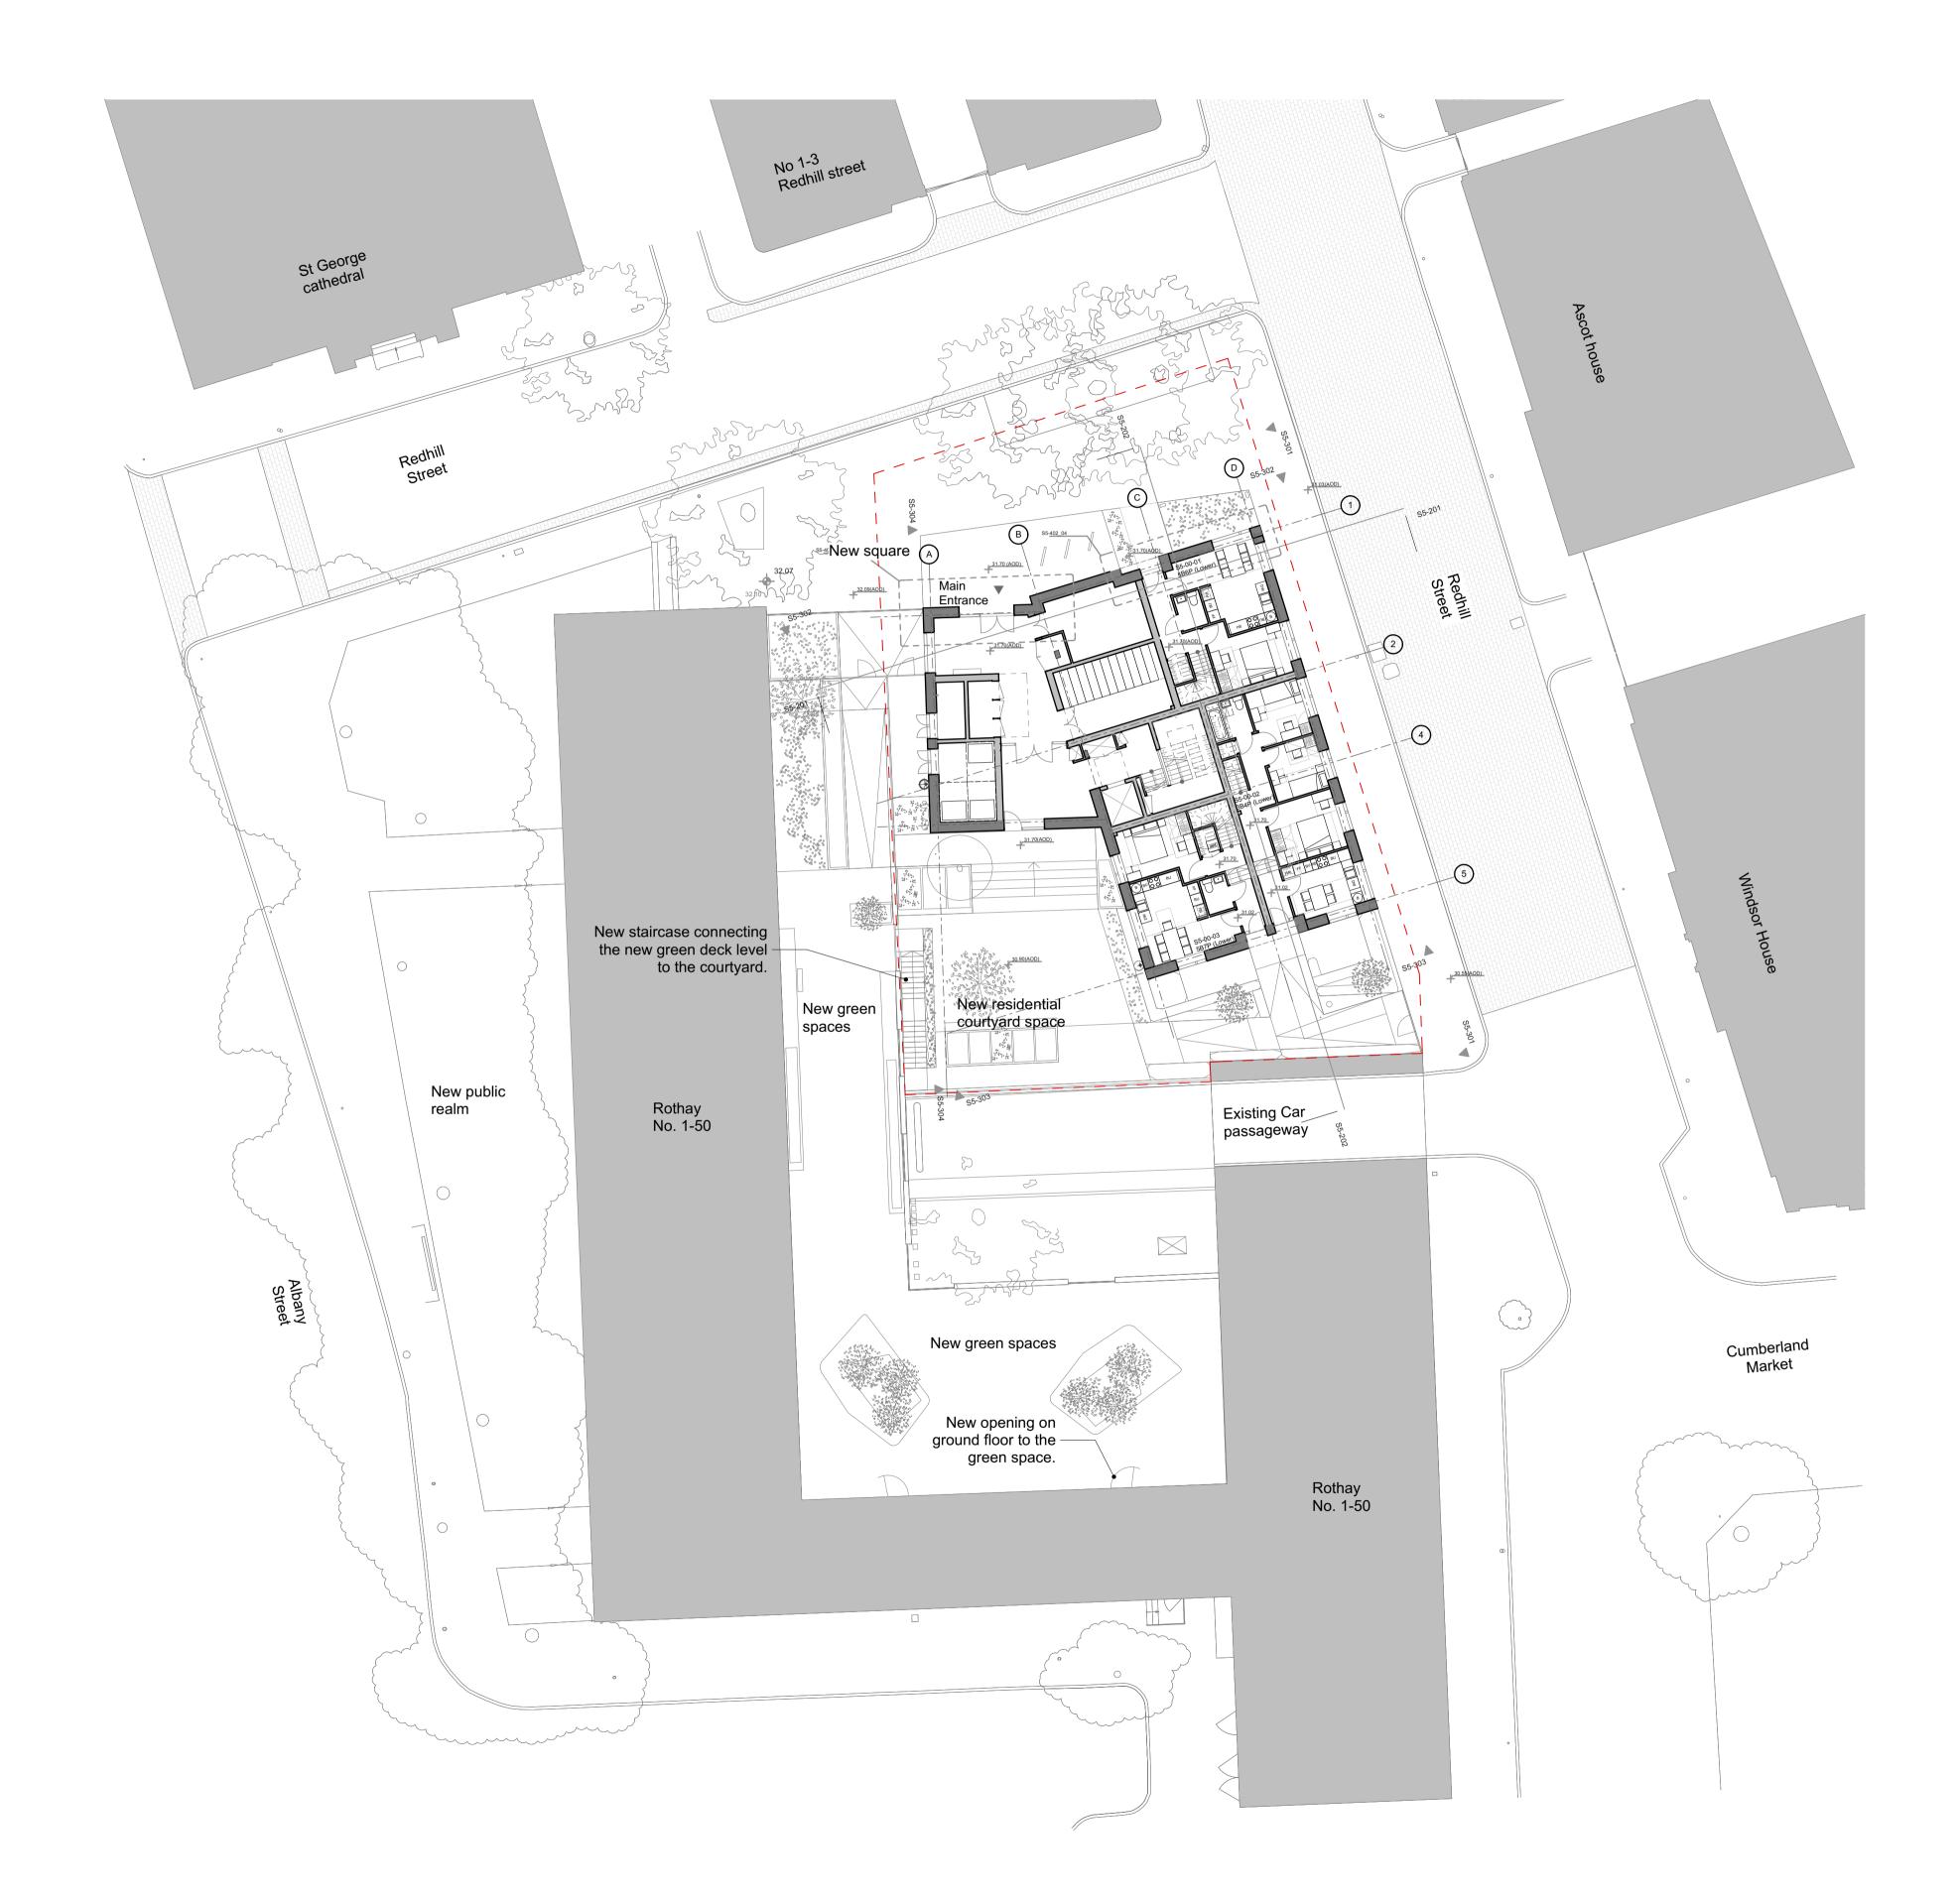

For materials and details, please refer to 1328\_400 series drawings and Design & Access statement section 6, materials page.

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t +44 (0)20 7704 6060 e office@mae-Ilp.co.uk w mae-Ilp.co.uk				
London Borough of Camden PROJECT NAME PROJECT NO.				
PROJECT NAME     PROJECT NO.       Regents Park Estate Infill     1328       DRAWING NAME     Dick Collins Hall - Site Plan				
status Planning				
	scale 1:200@ A1			
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