# REPORT

The Cock Tavern Phoenix Road London NW1

# **DAYLIGHT & SUNLIGHT**





**BROOKE VINCENT + PARTNERS** 

#### **CONTENTS OF REPORT**

		<u>Page</u>
1.	SUMMARY	1
2.	PLANNING POLICY	2
3.	METHOD OF CALCULATION	4
4.	DAYLIGHT	8
5.	SUNLIGHT	9

Appendices: 1. Location Plan, CAD Model and Architect's Drawings

- 2. Daylight and Sunlight Results Neighbouring Properties
- 3. Photograph

Drafted by:

#### Helen Anderson BArch For Brooke Vincent + Partners

email: helen.anderson@brooke-vincent.co.uk

Checked by:

John Carter FRICS For Brooke Vincent + Partners

email: john.carter@brooke-vincent.co.uk



CHARTERED BUILDING SURVEYORS, ENTERPRISE HOUSE, THE CREST, LONDON NW4 2HN www.brooke-vincent.co.uk Tel 020 8202 1013

04 July 2014

# The Cock Tavern

#### **Daylight & Sunlight**

We are instructed to report upon the daylight and sunlight aspects of this Planning Application in relation to neighbouring residential properties.

Our report is based upon the scheme drawings prepared by Mark Fairhurst Architects, survey information, photographs, plus daylight and sunlight studies.

#### 1.0 <u>SUMMARY</u>

- 1.1 This report has been drafted by reference to the Building Research Establishment (BRE) publication (2011), *"Site Layout Planning for Daylight and Sunlight. A Guide to Good Practice"* and local planning policy.
- 1.2 Our studies have confirmed that the amenity values of daylight and sunlight to neighbouring residential properties would be retained to a level that satisfies BRE criteria.
- 1.3 In summary, BRE's recommendations and criteria have been satisfied and therefore the relevant policies of Camden's Core Strategy.



Directors: John Carter FRICS David Sirman MRICS Andrew Cornick BSc(Hons) MRICS Brooke Vincent + Partners is the trading name of Brooke Vincent Limited, a company Registered in England and Wales No.6009355. Registered address as above.

# 2.0 PLANNING POLICY

# London Borough of Camden

2.1 Camden's *Local Development Framework (LDF), November 2010,* sets out the key elements of the Council's vision for the Borough through its Core Strategy, while detailing planning criteria are defined through its development policies which are detailed below:

# Core Strategy

# POLICY CS5 – Managing the impact of growth and development

The second part of this Policy confirms:

"The Council will protect the amenity of Camden's residents and those working in and visiting the Borough by:

(e) Making sure that the impact of developments on their occupiers and neighbours is fully considered."

In the explanatory notes following this Policy item 5.8 confirms: "We will expect development to avoid harmful effects on the amenity of existing and future occupiers and nearby properties or, where this is not possible, to take appropriate measures to minimise potential negative impacts."

# **Development Policies**

# POLICY DP26 – Managing the impact of development on occupiers and neighbours

"The Council will protect the quality of life of occupiers and neighbours by only granting permission for development that does not cause harm to amenity. The factors we will consider include;

- (b) Overshadowing and outlook
- (c) Sunlight, daylight and artificial light levels."

2.2 Camden's Core Strategy also makes reference to the good practice guide, which is used to compare the compatibility of the application to the stated Policy. All of the daylight matters referred to by The London Plan, are references to proposed accommodation which has not been considered in this report.

# 3. METHOD OF CALCULATION

#### **Building Research Establishment**

3.1 The calculations and considerations within this report are based upon the Building Research Establishment (BRE) publication 2011 "Site Layout Planning to Daylight and Sunlight. A Guide To Good Practice" as a means of articulating their policy. BRE confirm that the Guide does not contain mandatory requirements and in the **Introduction** provides a full explanation of its purpose:-

"The Guide is intended for building designers and their clients, consultants and planning officials."

"The advice given here is not mandatory and this document should not be seen as an instrument of planning policy."

"It aims to help rather than constrain the designer."

"Although it gives numerical guidelines these should be interpreted flexibly since natural lighting is only one of many factors in site layout design."

"In special circumstances the developer or planning authority may wish to use different target levels. For example, in an historic city centre, or in an area with high rise buildings, a higher degree of obstruction may be unavoidable if new developments are to match the height and proportions of existing buildings."

# 3.2 Modelling and Results

3.2.1 Our analysis and subsequent results are produced by the application of our specialist software on our three-dimensional model, images of which are included in Appendix
1. This is based upon survey information, supplemented by photographs, plus the architect's planning drawings also included in Appendix 1.

- 3.2.2 In this model, the neighbouring buildings are defined in green, the parts of the site building to be demolished in blue and the proposed extension development in magenta.
- 3.2.3 Within **Appendix 1** we also include window references that can again be crossreferenced to the body of our report and the results sheets.

#### 3.3 Daylight

- 3.3.1 Daylight is not specific to a particular direction, as it is received from the dome of the sky.
- 3.3.2 Reference is made in the BRE report to various methods of assessing the effect a development will have on diffused daylight.
- 3.3.3 The simplest methods are not appropriate in an urban environment, where the built form is invariably complex. Vertical Sky Component (VSC) is the calculation most readily adopted, as the principles of calculation can be established by relating the location of any particular window to the existing and proposed, built environment.
- 3.3.4 The BRE Guide states *"If any part of a new building or extension, measured in a vertical section perpendicular to a main window wall of an existing building, from the centre of the lowest window, subtends an angle of more than 25° to the horizontal, then the diffused daylighting of the existing building may be adversely affected.*

This will be the case if the Vertical Sky Component measured at the centre of an existing main window is less than 27% and less than 0.8 times its former value".

3.3.5 Where the VSC calculation has been used, BRE also seeks to consider daylight distribution within neighbouring rooms, once again defining an adverse effect as a result that is less than 0.8 the former value. Access is rarely available and we have therefore taken a reasoned approach. In this instance it was very difficult to gain access to observe the location of windows. Whilst this was achieved, typically access was not.

#### 3.4 Sunlight

#### 3.4.1 The BRE *Guide to Good Practice* confirms:

- (i) Sunlight is only relevant to neighbouring residential windows which have a view of the proposed development and face within 90° of south, i.e. south of the eastwest axis.
- (ii) If any part of a new development subtends an angle of more than 25° to the horizontal measured from the centre of the main living room window, a vertical section perpendicular to the window, then the sunlighting in the existing dwelling may be adversely affected.
- (iii) Similarly, the sunlight availability to an existing dwelling may be adversely affected if the APSH, when measured at the centre of the window are reduced by more than 4%.
- (iv) Should the loss be greater than 4%, then sunlight availability may be adversely affected if the centre of the window receives less than 25% of the annual probable sunlight hours, of which 5% of the annual total should be received between 21 September and 21 March (winter) and less than 0.8 times its former sunlight hours during either period.
- (v) Kitchens and bedrooms are less important, although care should be taken not to block too much sun.

#### 4.0 DAYLIGHT RESULTS

Neighbouring Residential Buildings

4.1 <u>North:</u>

40-151 Walker House

- 4.1.1 To the north of the site is Walker House, a block of flats. For the purpose of this report we have analysed the relevant windows facing the site.
- 4.1.2 The results confirm that in all locations, the proposed figure would not fall beneath BRE's benchmark of 27% VSC and there would be no adverse effect.
- 4.1.2 We have not sought access to these properties but it can be seen that the proposed value for daylight at the face all the windows are similar to the existing value, there can be no expectation of a significant reduction in Daylight Distribution within these rooms.
- 4.2 <u>East</u>

1-39 Walker House

- 4.2.1 Walker House is also sited to the east of the site. The VSC results in Appendix 2 confirm that the existing VSC figures are below BRE's benchmark of 27% VSC and the values in the proposed condition follow suit. BRE provides the appropriate advice, which we have reiterated in item 3.3.4 of our report. This states that an adverse effect would occur if the proposed value was not only less than 27% VSC but also less than 0.8 of the former (existing) value. This would only occur in one location (third floor W9) with the remaining results well above 0.8 and there would be no adverse effect
- 4.2.2 It is important to note that the result of 0.78 for third floor W9 can be seen from photographic evidence to be a hallway/entrance. This is a non-habitable room and BRE confirm there is no criteria to meet.

4.2.3 Again, we have not sought access to these properties but it can be seen that the proposed value for daylight at the face of nearly all the windows are similar to the existing value, there can be no expectation of a significant reduction in Daylight Distribution within these rooms.

#### 4.3 <u>South and West</u>

4.3.1 The proposed extension has a number of dormer windows within the mansard roof facing the south and west of the site. These dormer windows do not noticeably affect the obstruction of the sky dome. Residential properties within the vicinity of the site are further away from the development than those previously analysed in this report and would retain their existing view of the sky dome. Their daylight would remain unchanged.

#### 4.4 Summary

4.4.1 BRE criteria for daylight to neighbouring windows serving habitable rooms has easily been satisfied and there would be no adverse effect.

#### 5.0 SUNLIGHT RESULTS


- 5.1 Neighbouring Residential Buildings
- 5.1.1 The sunlight results are defined by the two right hand columns in **Appendix 2** and adjacent to VSC results.
- 5.1.2 All windows that face within 90 degrees of south, would retain and in most locations be well above the BRE recommended annual sunlight availability of 25% and 5% winter sunlight.

# 5.2 Summary

5.2.1 The results clearly confirm that the proposed scheme would not be the cause of an adverse effect. Sunlight availability remains fully satisfied in all locations.

**APPENDIX 1** 

LOCATION PLAN CAD MODEL ARCHITECT'S DRAWINGS

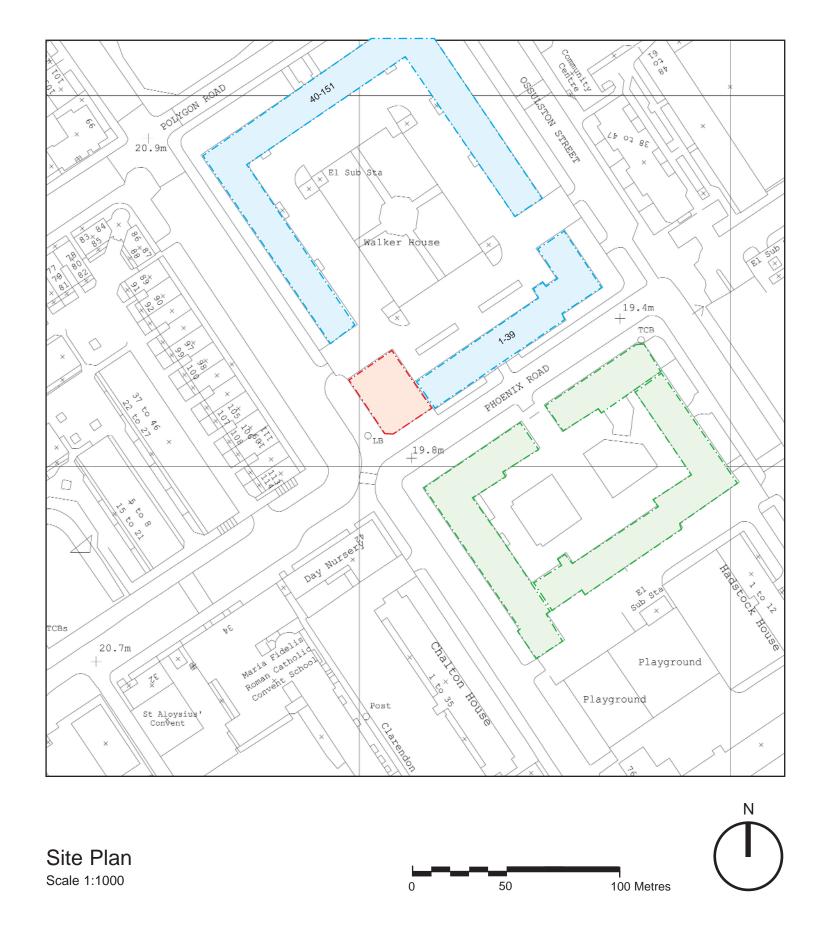






The Cock Tavern, Grade: II Reference No: 798-1-131384 Date of listing: Dec 13 1996

Walker House, Grade: II Reference No: 798-1-131384 Date of listing: Dec 13 1996

Chamberlain House, Grade: II Reference No: 798-1-131289 Date of listing: Dec 13 1996

The Cock Tavern, 23 Phoenix Road, London, NW1 1HB


> Pre-Planning Proposals Site Plan 20<sup>th</sup> July 2011

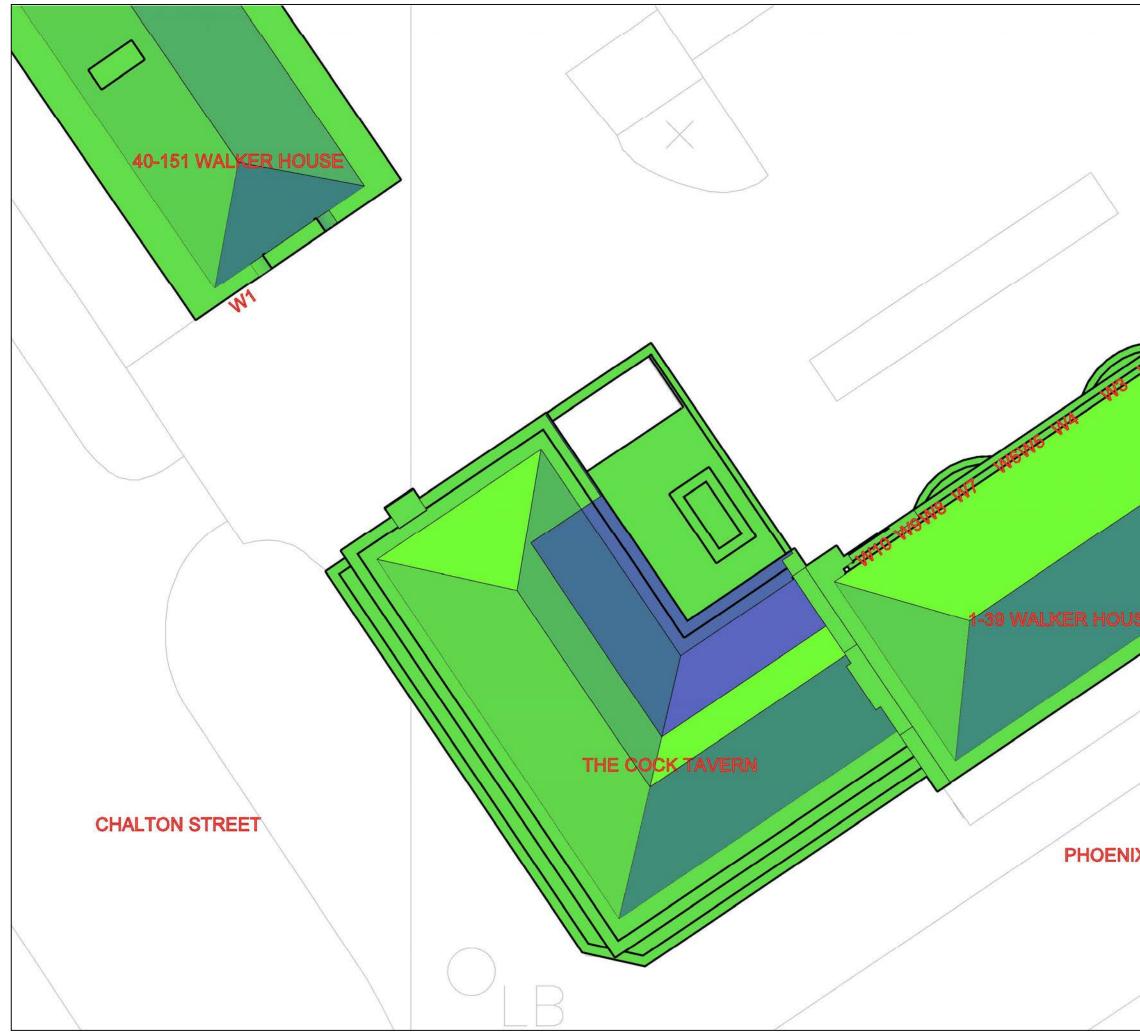


LEGEND Existing Buildings Existing Buildings to be Demolitized Proposal SOURCES OF DATA Rev. Date Description Rev. Date Description MARY AND TRANSPORT SOURCES OF DATA Rev. Date Description SOURCES OF DATA SOURCES OF D											
Existing Buildings to be Demolished Proposal  SOURCES OF DATA  SOURCES OF DATA  SOURCES OF DATA  Rev. Date Description  Rev. Date Description  Rev. Date Description  Rev. Date Description  Chartered Building Surveyors Emerge House The Constant NW4 2HW Existing Emerge House The Constant NW4 2HW Tet: 020 8202 1013 Fac: 020 8202 9488 Emerget: info@Bbrooke-vincent.co.uk  CLIENT / ARCHITECT: Mark Fairhurst Limited  PROJECT: THE COCK TAVERN NV1 1HB  REV.  CROCOD  DRAWING: Plan View Existing  PROJECT NO: 104722 DATE: 03.07.2014  DRAWING NO: REV:											
Existing Buildings to be Demolished Proposal  SOURCES OF DATA  SOURCES OF DATA  SOURCES OF DATA  Rev. Date Description  Rev. Date Description  Rev. Date Description  Rev. Date Description  Chartered Building Surveyors Emerge House The Constant NW4 2HW Existing Emerge House The Constant NW4 2HW Tet: 020 8202 1013 Fac: 020 8202 9488 Emerget: info@Bbrooke-vincent.co.uk  CLIENT / ARCHITECT: Mark Fairhurst Limited  PROJECT: THE COCK TAVERN NV1 1HB  REV.  CROCOD  DRAWING: Plan View Existing  PROJECT NO: 104722 DATE: 03.07.2014  DRAWING NO: REV:			Indicative								
SURCES OF DATA SOURCES OF DATA SOURCES OF DATA SOURCES OF DATA SOURCES OF DATA Nev. Date Description Rev. Date Description Rev. Date Description Charace Building Surveyors Energifies House Text London NNV4 2HV Text 200 8202 1013 Fax: 020 8202 9488 E-mail: info@Brooke-vincent.co.uk CLIENT / ARCHITECT: Mark Fairhurst Limited PROJECT NO: THE COCK TAVERN NV1 1HB DRAWING DRAWN: MZ PROJECT NO: TOTAT		Exis	ting Buildings								
SURCES OF DATA SURCES OF DATA SURCES OF DATA SURCES OF DATA NUMBRING NO:		Exis	ting Buildings	to be	Demolished						
Rev. Date Description Rev. Date Description Rev. Date Description Rev. Date Description Concent Subject Subjec		Prop	oosal								
Rev. Date Description Rev. Date Description Rev. Date Description Rev. Date Description Concent Subject Subjec											
Rev. Date Description Rev. Date Description Rev. Date Description Rev. Date Description Concent Subject Subjec											
Rev. Date Description Rev. Date Description Rev. Date Description Rev. Date Description Concent Subject Subjec											
Rev. Date Description Rev. Date Description Rev. Date Description Rev. Date Description Concent Subject Subjec											
Rev. Date Description Rev. Date Description Rev. Date Description Rev. Date Description Concent Subject Subjec											
Rev. Date Description Rev. Date Description Rev. Date Description Rev. Date Description Concent Subject Subjec		SOURCES	OF DATA								
Brooke Vincent & Partners         Chartered Building Surveyors         Enterprise House The Crest London NW4 2HW         Tel: 020 8202 1013         Fax: 020 8202 9488         E-mail: info@brooke-vincent.co.uk         CLIENT / ARCHITECT:         Mark Fairhurst Limited         PROJECT:         THE COCK TAVERN         NW1 1HB         DRAWING:         Plan View         Existing         DRAWN: MZ         PROJECT NO:         SCALE:       NTS         DRAWN: MZ         PROJECT NO:         ATE:       03.07.2014         DRAWING NO:       REV:		00011020									
Brooke Vincent & Partners         Chartered Building Surveyors         Enterprise House The Crest London NW4 2HW         Tel: 020 8202 1013         Fax: 020 8202 9488         E-mail: info@brooke-vincent.co.uk         CLIENT / ARCHITECT:         Mark Fairhurst Limited         PROJECT:         THE COCK TAVERN         NW1 1HB         DRAWING:         Plan View         Existing         DRAWN: MZ         PROJECT NO:         SCALE:         NTS         DATE:         03.07.2014         DRAWING NO:											
Brooke Vincent & Partners         Chartered Building Surveyors         Enterprise House The Crest London NW4 2HW         Tel: 020 8202 1013         Fax: 020 8202 9488         E-mail: info@brooke-vincent.co.uk         CLIENT / ARCHITECT:         Mark Fairhurst Limited         PROJECT:         THE COCK TAVERN         NW1 1HB         DRAWING:         Plan View         Existing         DRAWN: MZ         PROJECT NO:         SCALE:         NTS         DATE:         03.07.2014         DRAWING NO:	A PAR										
Brooke Vincent & Partners         Chartered Building Surveyors         Enterprise House The Crest London NW4 2HW         Tel: 020 8202 1013         Fax: 020 8202 9488         E-mail: info@brooke-vincent.co.uk         CLIENT / ARCHITECT:         Mark Fairhurst Limited         PROJECT:         THE COCK TAVERN         NW1 1HB         DRAWING:         Plan View         Existing         DRAWN: MZ         PROJECT NO:         SCALE:         NTS         DATE:         03.07.2014         DRAWING NO:											
Brooke Vincent & Partners         Chartered Building Surveyors         Enterprise House The Crest London NW4 2HW         Tel: 020 8202 1013         Fax: 020 8202 9488         E-mail: info@brooke-vincent.co.uk         CLIENT / ARCHITECT:         Mark Fairhurst Limited         PROJECT:         THE COCK TAVERN         NW1 1HB         DRAWING:         Plan View         Existing         DRAWN: MZ         PROJECT NO:         SCALE:         NTS         DATE:         03.07.2014         DRAWING NO:											
Chartered Building Surveyors Enterprise House The Crest London NW4 2HW Tel: 020 8202 1013 Fax: 020 8202 9488 E-mail: info@brooke-vincent.co.uk CLIENT / ARCHITECT: Mark Fairhurst Limited PROJECT: THE COCK TAVERN NW1 1HB DRAWING: Plan View Existing DRAWN: MZ DRAWN: MZ DRAWN: MZ PROJECT NO: SCALE: NTS DATE: 03.07.2014 DRAWING NO: REV:	SF /	Rev.	Date	Desc	ription						
Chartered Building Surveyors Enterprise House The Crest London NW4 2HW Tel: 020 8202 1013 Fax: 020 8202 9488 E-mail: info@brooke-vincent.co.uk CLIENT / ARCHITECT: Mark Fairhurst Limited PROJECT: THE COCK TAVERN NW1 1HB DRAWING: Plan View Existing DRAWN: MZ DRAWN: MZ DRAWN: MZ PROJECT NO: SCALE: NTS DATE: 03.07.2014 DRAWING NO: REV:		Brook	ke Vind	cen	t & Part	ners					
E-mail: info@brooke-vincent.co.uk  CLIENT / ARCHITECT: Mark Fairhurst Limited  PROJECT: THE COCK TAVERN NW1 1HB  DRAWING: Plan View Existing  DRAWN: MZ DRAWN: MZ DRAWN: MZ DRAWN: MZ DRAWN: MZ DRAWN: MZ DRAWN: 03.07.2014 DRAWING NO: REV:		Chartered E	Building Surve	yors							
CLIENT / ARCHITECT: Mark Fairhurst Limited PROJECT: THE COCK TAVERN NW1 1HB DRAWING: Plan View Existing DRAWN: MZ DRAWN: MZ DRAWN: MZ PROJECT NO: SCALE: NTS DATE: 03.07.2014 DRAWING NO: REV:											
Mark Fairhurst Limited         PROJECT:         THE COCK TAVERN         NW1 1HB         DRAWING:         Plan View         Existing         DRAWN: MZ         PROJECT NO:         ATE:       03.07.2014         DRAWING NO:       REV:	/	⊢-mail: infc	o@brooke-vin	cent.co	).uk						
PROJECT:       THE COCK TAVERN         NW1 1HB       DRAWING:         Plan View       Existing         DRAWN:       MZ         PROJECT NO:       SCALE:         NTS       10472         DRAWING NO:       REV:		CLIENT /			urst Limita	d					
THE COCK TAVERN         NW1 1HB         DRAWING:         Plan View         Existing         DRAWN: MZ         PROJECT NO:         SCALE:         NTS         DATE:         03.07.2014         DRAWING NO:				alli		u					
X ROAD       Plan View Existing         DRAWN: MZ       PROJECT NO:         SCALE: NTS       10472         DATE: 03.07.2014       DRAWING NO:		FROJECT	THE C	OC	K TAVERN	I					
X ROAD       Plan View Existing         DRAWN: MZ       PROJECT NO:         SCALE: NTS       10472         DATE: 03.07.2014       DRAWING NO:											
Existing       DRAWN: MZ     PROJECT NO:       SCALE:     NTS       DATE:     03.07.2014       DRAWING NO:     REV:		DRAWING	G:								
DRAWN: MZ PROJECT NO: SCALE: NTS 10472 DATE: 03.07.2014 DRAWING NO: REV:	X ROAD										
SCALE:         NTS         10472           DATE:         03.07.2014         REV:											
SCALE:         NTS         10472           DATE:         03.07.2014         REV:											
DATE: 03.07.2014 DRAWING NO: REV:	/										
DRAWING NO: REV:				10472							
				•		RF\/·					
	5			1		-					




	LEGEND	•									
		Indicative									
	Exis	ting Buildings	•								
	Exis	ting Buildings	to be	Demolished							
	Prop	oosal									
- ANA	SOURCES OF DATA										
APC.											
SE	Rev.	Date	Desc	ription							
	Draal										
	Chartered E	Building Surve	yors	it & Parti							
	Enterprise H			ondon NW4 2HW							
		@brooke-vin									
	CLIENT /	ARCHITEC	T:								
		Mark F	airh	urst Limite	d						
	PROJECT	THE C NW1 1HB	OCI	K TAVERN	l						
X ROAD	DRAWING	3:									
	Plan View Proposed										
		i iopose	u								
1	DEALA	M7									
	DRAWN: MZ PROJECT NO:										
/	SCALE: DATE:	03.07.2014	10472								
	DATE:				REV:						
		172-0	2		A						

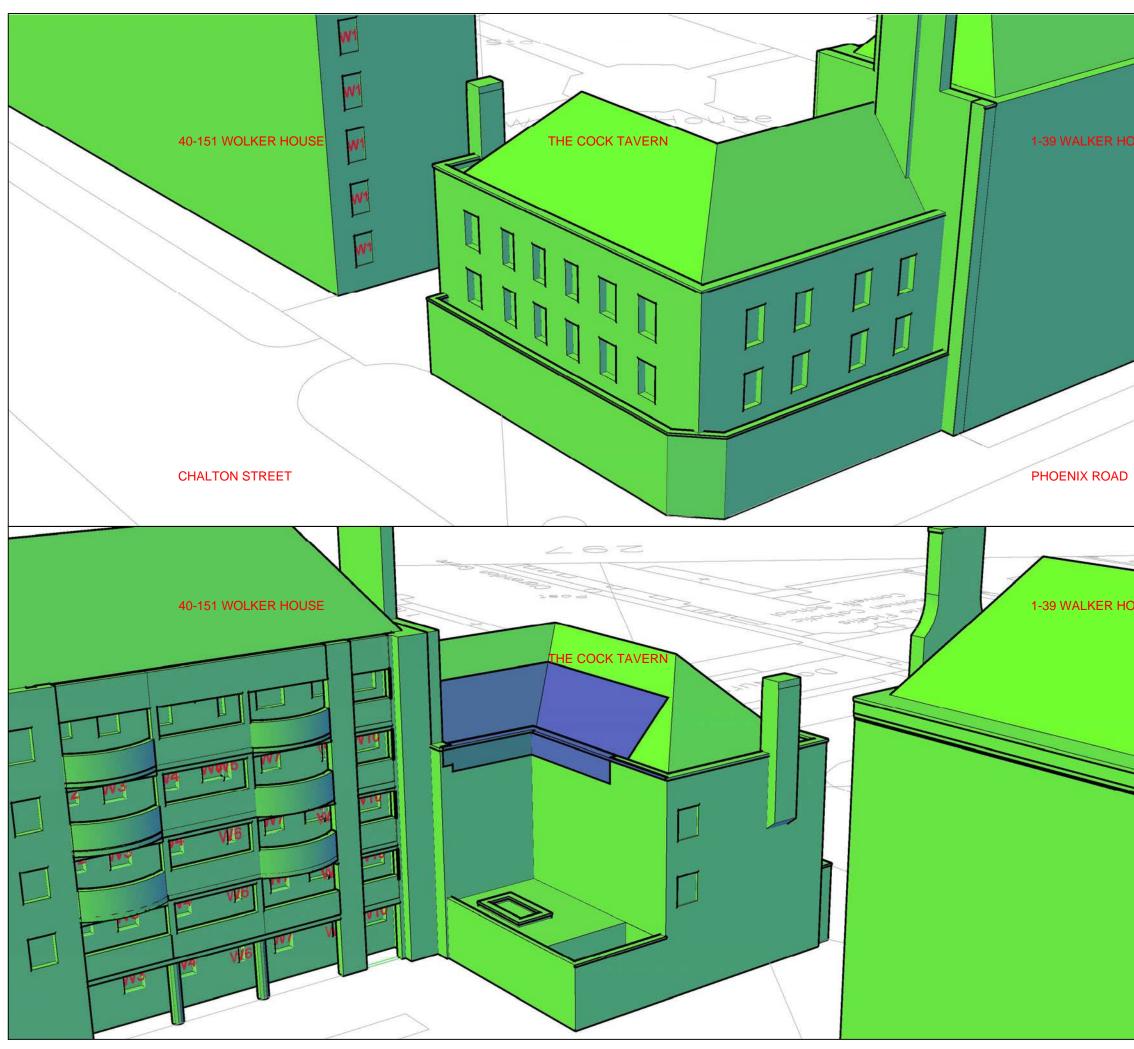


	LEGEND	Indicative							
	Exis	ting buildings							
	Exis	ting buildings	to be	demolished					
USE	Prop	oosed new bu	ildings	;					
	SOURCES	OF DATA							
/ /									
USE									
OOL	Rev.	Date	Desc	ription					
	Chartered E Enterprise F Tel: 020 82	Building Surve House The C	eyors rest Lo Fax	nt & Parti ondon NW4 2HW :: 020 8202 9488 o.uk					
	CLIENT /	ARCHITEC	T:						
		Mark F	airh	nurst Limite	ed				
	PROJECT	THE C NW1 1HB	coc	K TAVERN	N				
	DRAWING:								
	Existing View Perspective 1 and 2								
	DRAWN: MZ PROJECT NO:								
	SCALE:	NTS		104	72				
	DATE:	03.07.201	4						
	DRAWING	з NO: <b>472-С</b>	)3		REV: A				

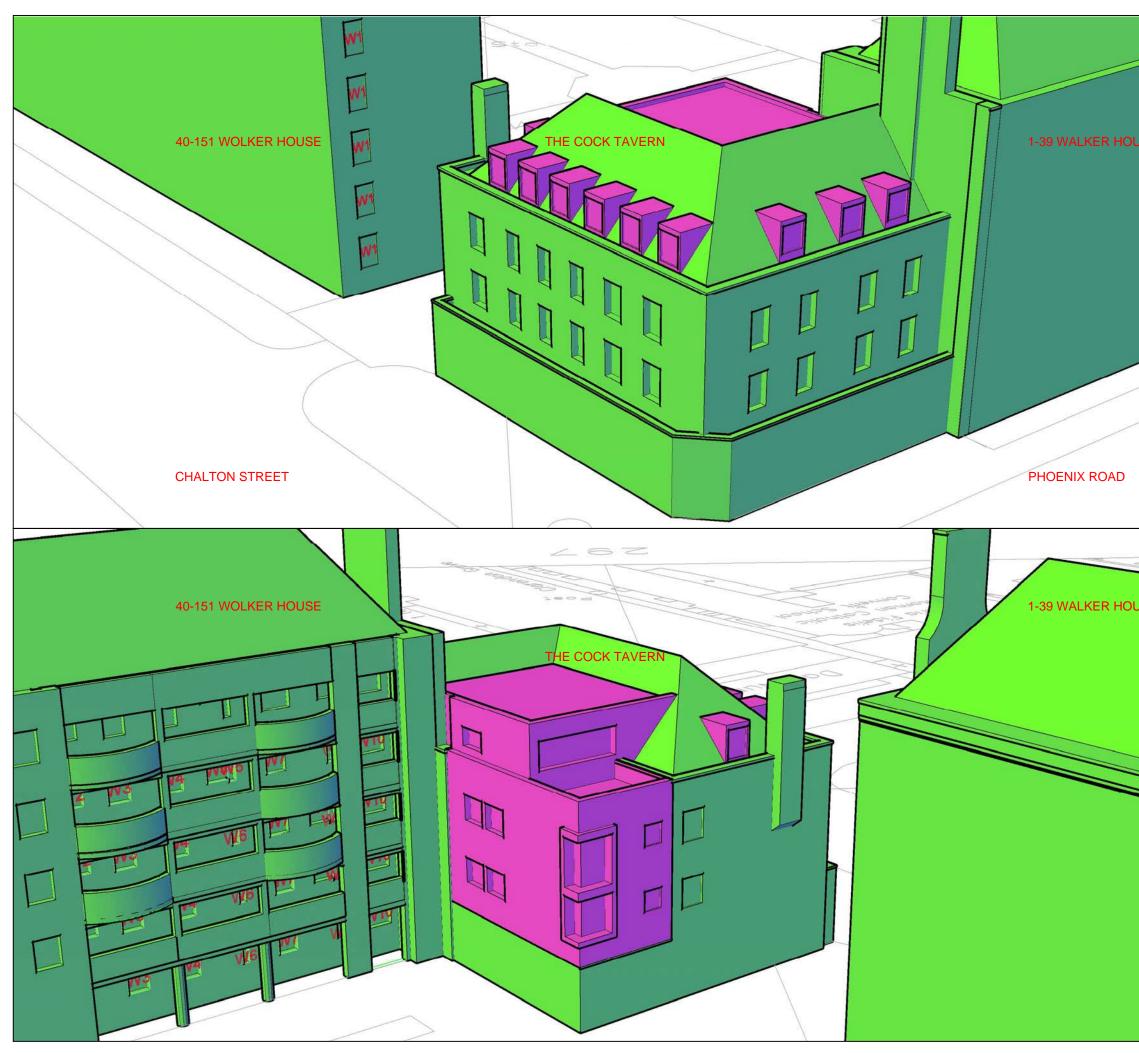


	LEGEND	Indicative						
	Exis	ting buildings						
	Exis	sting buildings	to be	demolished				
ISE	Prop	posed new bu	ildings					
	SOURCES	OF DATA						
/ /								
ISE								
.02	Rev.	Date	Desc	ription				
	Chartered E Enterprise F Tel: 020 82	Building Surve House The C	yors rest Li Fax	nt & Parti ondon NW4 2HW : 020 8202 9488 o.uk				
	CLIENT /	ARCHITEC	T:					
		Mark F	airh	nurst Limite	ed			
	PROJECT	THE C NW1 1HB	coc	K TAVERN	N			
	DRAWING	G:						
	Proposed View Perspective 1 and 2							
		•						
	DRAWN:	MZ		PROJECT NO	v:			
	SCALE:	NTS		104 <sup>-</sup>	72			
	DATE:	03.07.201	4		· <b>-</b>			
					REV:			
	104	472-0	14		A			

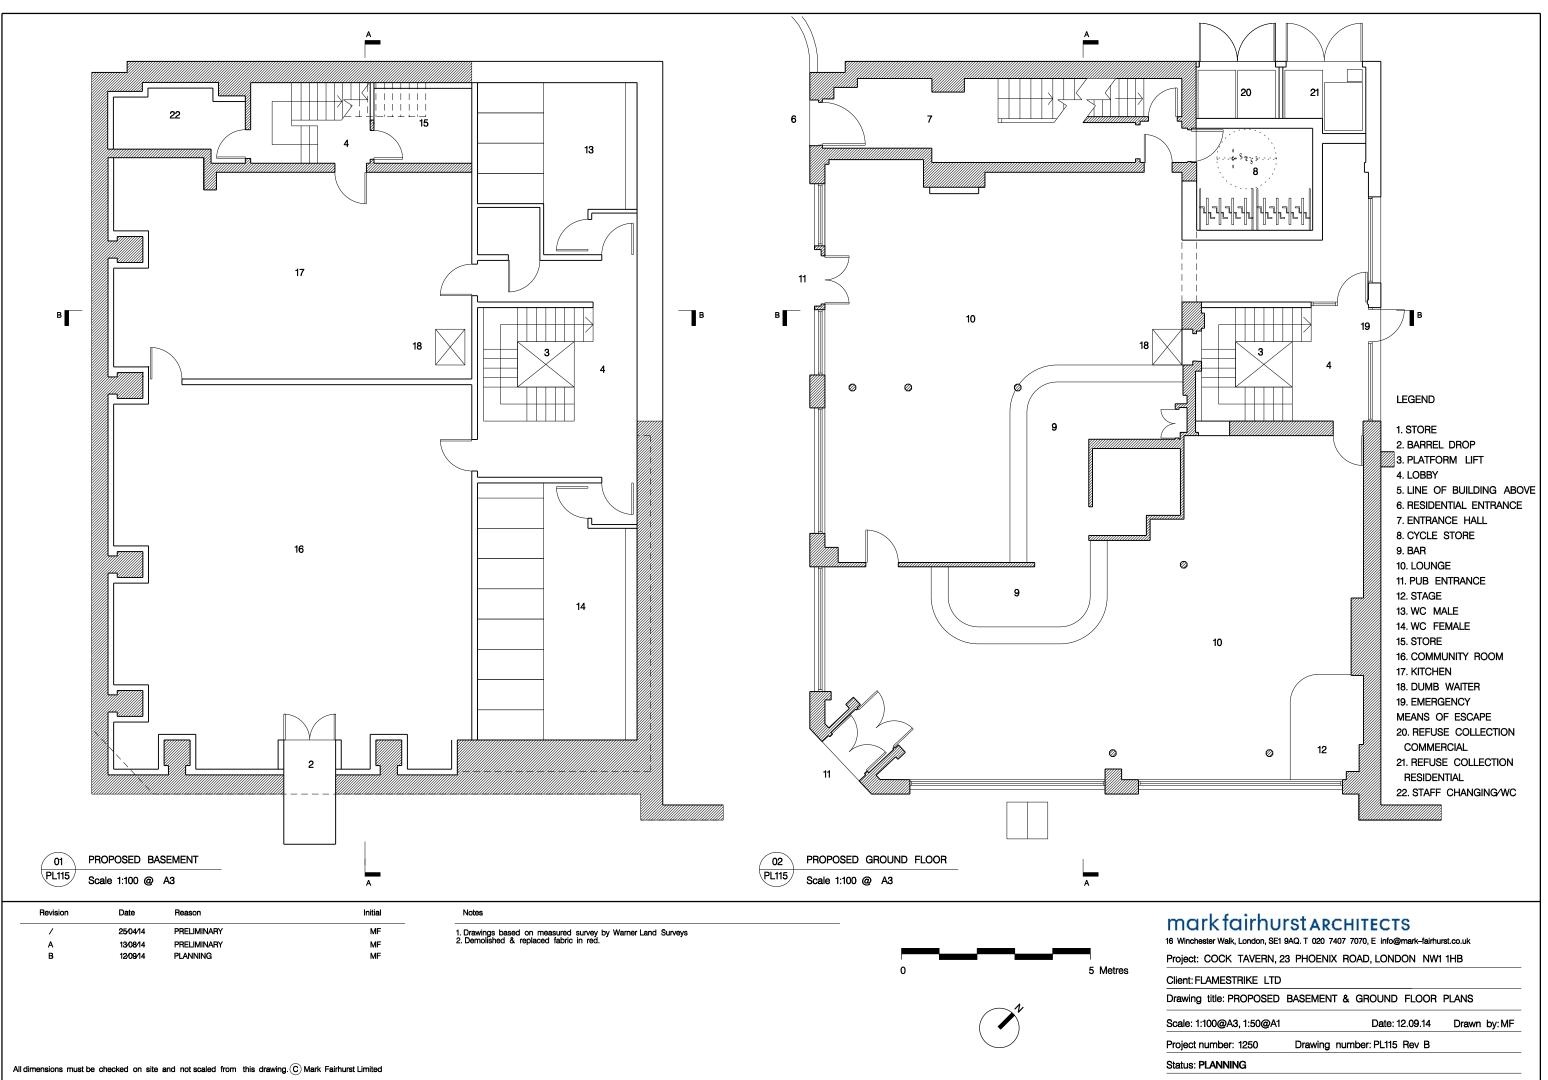

Proi	iect	number:	1250
	000	mannibor.	1200

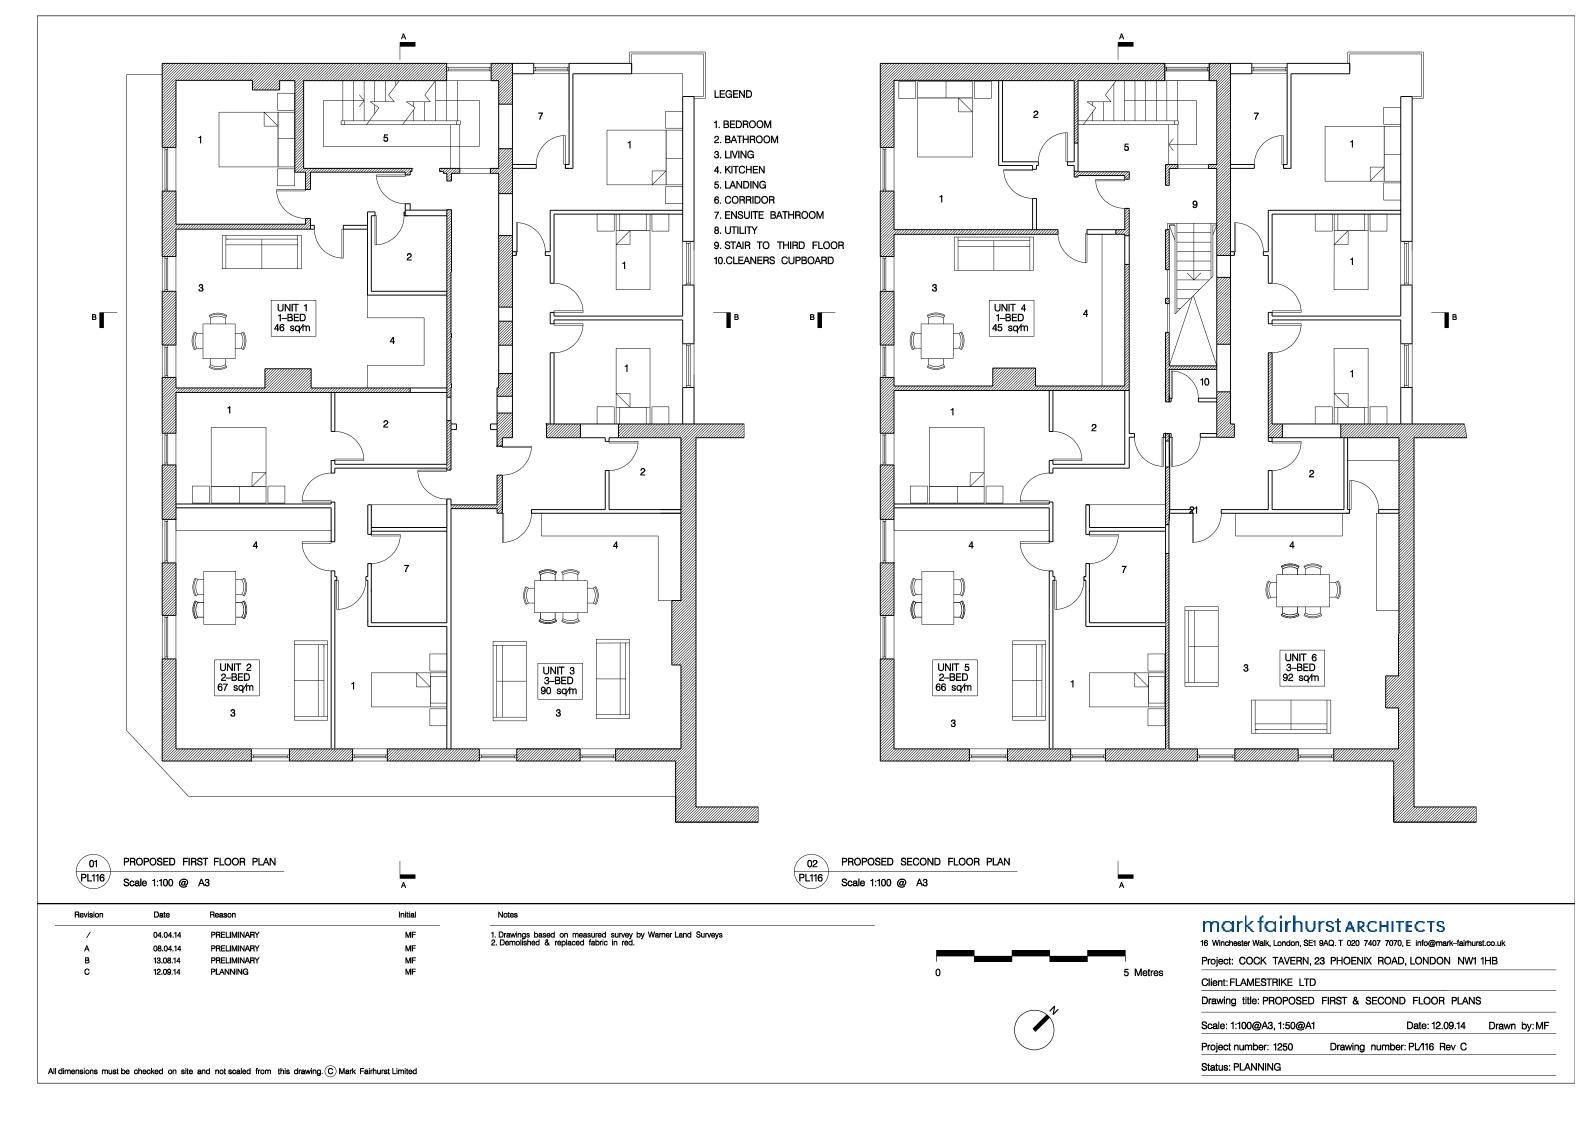

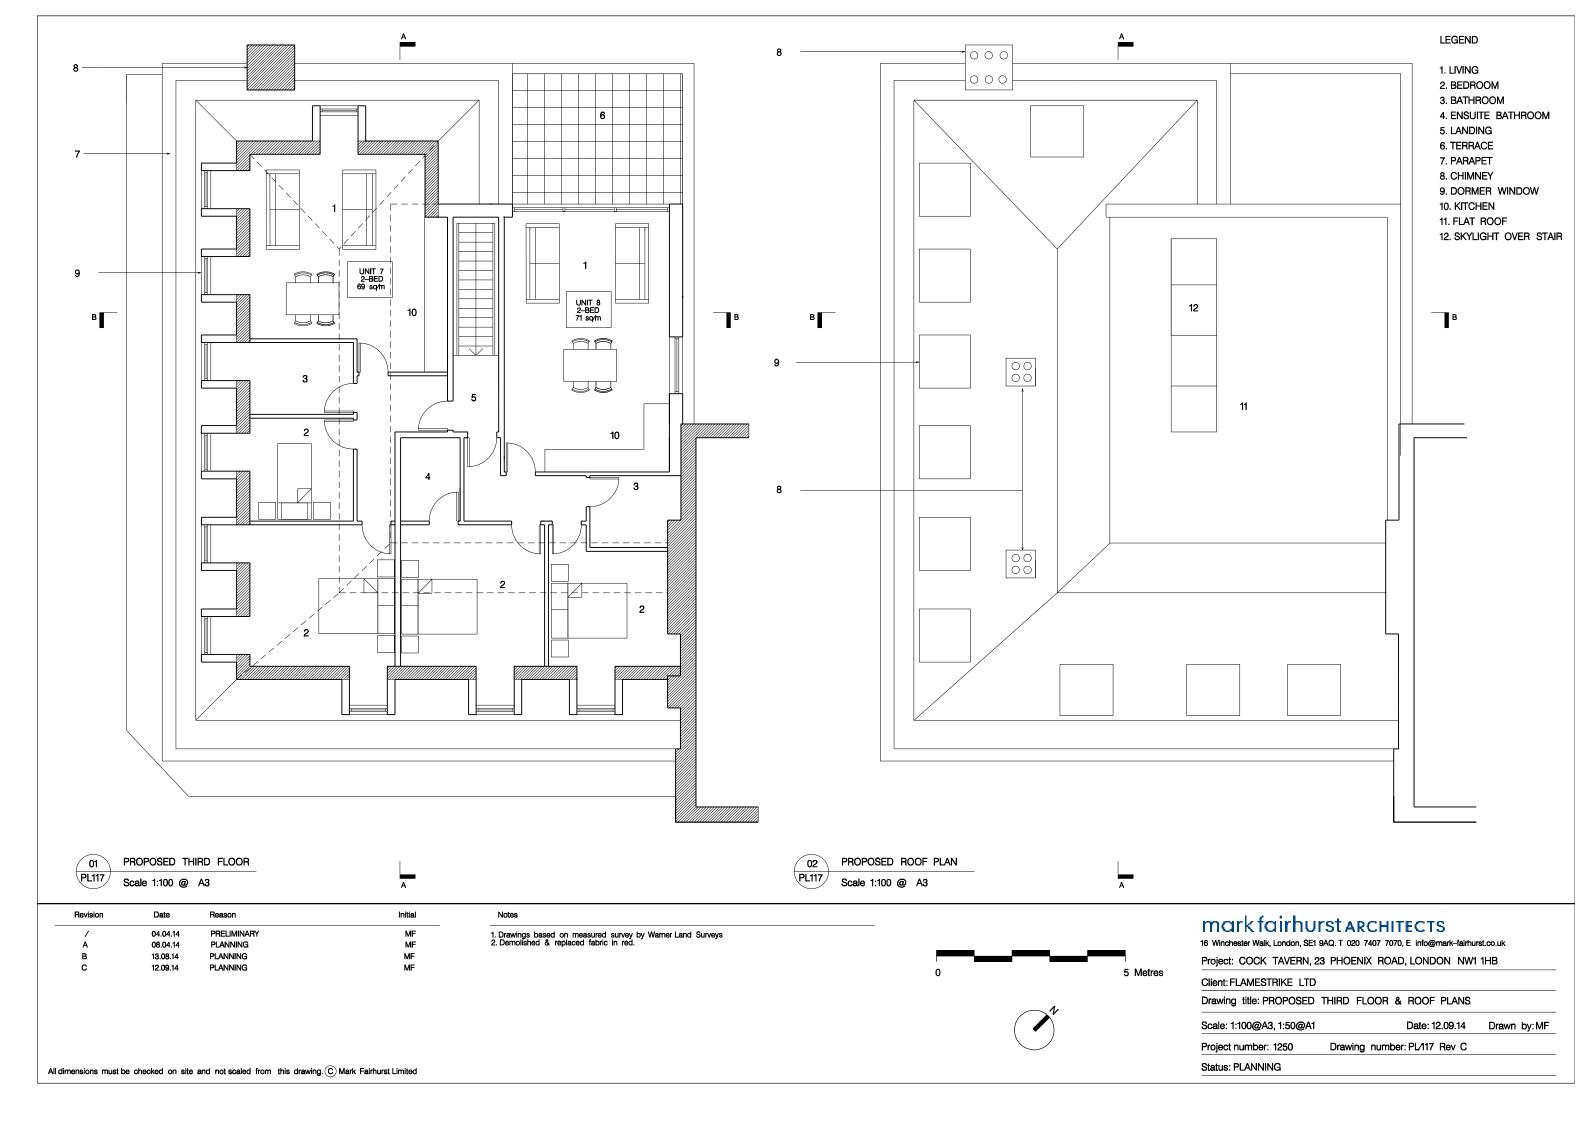

**APPENDIX 2** 

Daylight and Sunlight Results

Project Name: 2014-06-24 3D MASSI_MASSING Project No: 10472
Project No: 10472

Report Title: THE COCK TAVERN NW1 1HB Date of Analysis: 03/07/2014

DC	10 01 / 11d1y313. C	570772014													
										Available S	Sunlight I	Hours			
	Floor Ref.	Room Ref.	Room	Use.	Window Ref.	Scenario	VSC	Difference	Pass / Fail	Annual %	Diff %	Pass / Fail	Winter %	Diff %	Pass / Fail

#### 40-151 Walker House

Ground	NoRoomAttach -	W1	Existing	28	0.99	PASS	64	1.00	PASS	19	1.00	PASS
			Proposed	27.78	0.99	FA33	64	1.00	FA33	19	1.00	FASS
First	NoRoomAttach -	W1	Existing	30.88	1.00	PASS	72	1.00	PASS	21	1.00	PASS
			Proposed	30.77	1.00	FA33	72	1.00	FA33	21	1.00	FA33
Second	NoRoomAttach -	W1	Existing	33.75	1.00	PASS	77	1.00	PASS	24	1.00	PASS
			Proposed	33.61	1.00	PA33	77	1.00	PASS	24	1.00	PASS
Third	NoRoomAttach -	W1	Existing	36.44	1.00	PASS	79	1.00	PASS	25	1.00	PASS
			Proposed	36.36	1.00	PA33	79	1.00	PASS	25	1.00	PASS
Fourth	NoRoomAttach -	W1	Existing	38.17	1.00	PASS	81	1.00	PASS	27	1.00	PASS
			Proposed	38.17	1.00	PASS	81	1.00	PASS	27	1.00	PASS

#### 1-39 Walker House

Ground	NoRoomAttach -	W1	Existing Proposed	2.49 2.26	0.91	PASS	*North Facing
Ground	NoRoomAttach -	W2	Existing Proposed	2.82	0.96	PASS	*North Facing
Ground	NoRoomAttach -	W3	Existing Proposed	10.17 10.06	0.99	PASS	*North Facing
Ground	NoRoomAttach -	W4	Existing Proposed	8.9 8.63	0.97	PASS	*North Facing
Ground	NoRoomAttach -	W5	Existing Proposed	4.31 4.25	0.99	PASS	*North Facing
Ground	NoRoomAttach -	W6	Existing Proposed	8.28 8.11	0.98	PASS	*North Facing
Ground	NoRoomAttach -	W7	Existing Proposed	9.02	0.99	PASS	*North Facing
Ground	NoRoomAttach -	W8	Existing Proposed	4.12	1.00	PASS	*North Facing
Ground	NoRoomAttach -	W9	Existing	4.12	1.00	PASS	*North Facing
Ground	NoRoomAttach -	W10	Proposed Existing	3.36 7.11	0.98	PASS	*North Facing
First	NoRoomAttach -	W1	Proposed Existing	6.98 1.56	0.87	PASS	*North Facing
First	NoRoomAttach -	W2	Proposed Existing	1.36 4.08	0.96	PASS	*North Facing
First	NoRoomAttach -	W3	Proposed Existing	3.9 7.26	0.97	PASS	*North Facing
First	NoRoomAttach -	W4	Proposed Existing	7.03 6.88	0.97	PASS	*North Facing
First	NoRoomAttach -	W5	Proposed Existing	6.64 2.17	0.96	PASS	*North Facing
First	NoRoomAttach -	W6	Proposed Existing	2.09 6.4	0.98	PASS	*North Facing
First	NoRoomAttach -	W7	Proposed Existing	6.26 6.4	0.99	PASS	*North Facing
First	NoRoomAttach -	W8	Proposed Existing	6.33 6.14	1.00	PASS	·
First	NoRoomAttach -	W9	Proposed Existing	6.14 2.87			*North Facing
First	NoRoomAttach -	W10	Proposed Existing	2.87 5.36	1.00	PASS	*North Facing
Second	NoRoomAttach -	W1	Proposed Existing	5.28 1.91	0.99	PASS	*North Facing
Second	NoRoomAttach -	W2	Proposed	1.77 4.52	0.93	PASS	*North Facing
Second	NoRoomAttach -		Proposed Existing	4.38 7.86	0.97	PASS	*North Facing
Second	NoRoomAttach -	W3	Proposed Existing	7.69 6.89	0.98	PASS	*North Facing
Second	NoRoomAttach -	W5	Proposed Existing	6.66 2.48	0.97	PASS	*North Facing
	NoRoomAttach -		Proposed Existing	2.42	0.98	PASS	*North Facing
Second	NoRoomAttach -	W6	Proposed	7.34	0.96	PASS	*North Facing
Second	NURUUMALIALII -	W7	Existing Proposed	7.02 6.69	0.95	PASS	*North Facing

# Project Name: 2014-06-24 3D MASSI\_MASSING Project No: 10472 Report Title: THE COCK TAVERN NW1 1HB Date of Analysis: 03/07/2014

Date of Analys	sis: 03/07/2014								Available S	Suplicit 1	Jours			
Floor Ref.	Room Ref.	Room Use.	Use. Window Ref.	<sup>N</sup> Scenario	Scenario VSC	Difference	Pass / Fail	Available 3 Annual %	Diff %	Pass / Fail	Winter %	Diff %	Pass / Fail	
Second	NoRoomAttach -			W8	Existing Proposed	6.06 6.06	1.00	PASS			*North	Facing		
Second	NoRoomAttach -			W9	Existing Proposed	3.4 3.04	0.89	PASS			*North	Facing		
Second	NoRoomAttach -			W10	Existing Proposed	6.17 6.11	0.99	PASS			*North	Facing		
Third	NoRoomAttach -			W1	Existing Proposed	2.45 2.43	0.99	PASS			*North	Facing		
Third	NoRoomAttach -			W2	Existing Proposed	5.04 5	0.99	PASS			*North	Facing		
Third	NoRoomAttach -			W3	Existing Proposed	8.54 8.44	0.99	PASS			*North	Facing		
Third	NoRoomAttach -			W4	Existing Proposed	7.96 7.83	0.98	PASS			*North	Facing		
Third	NoRoomAttach -			W5	Existing Proposed	7.87 7.58	0.96	PASS			*North	Facing		
Third	NoRoomAttach -			W6	Existing Proposed	7.92 7.55	0.95	PASS			*North	Facing		
Third	NoRoomAttach -			W7	Existing Proposed	8.02 7.53	0.94	PASS			*North	Facing		
Third	NoRoomAttach -			W8	Existing Proposed	2.38 2.38	1.00	PASS			*North	Facing		
Third	NoRoomAttach -			W9	Existing Proposed	3.94 3.07	0.78	FAIL			*North	Facing		
Third	NoRoomAttach -			W10	Existing Proposed	6.47 6.47	1.00	PASS			*North	Facing		

**APPENDIX 3** 

Photograph





CHARTERED BUILDING SURVEYORS, ENTERPRISE HOUSE, THE CREST, LONDON NW4 2HN www.brooke-vincent.co.uk Tel 020 8202 1013

Mr. Mark Fairhurst 48A Union Street London SE1

Our Ref: JC/HA/10472 Date: 05 March 2015

Dear Mark

# The Cock Tavern, Pheonix Rd. London NW1

In addition to our Daylight and Sunlight report issued on the 4<sup>th</sup> July 2014, we have been instructed to provide our response to the revised proposal.

In the same manner as our original report, our response are based upon scheme drawings prepared by marc fairhurst architects, survey and photographs and by reference to local planning policy and BRE guidance. Policy and Guidance is fully explained in our original report.

# 1.0 Neighbouring Buildings

- 1.1 We can confirm the revised scheme the architects have provided, is now reduced in height and massing.
- 1.2 Our previous report confirmed that the amenity values of daylight and sunlight to neighbouring residential properties would be retained to a level that satisfies BRE criteria.
- 1.3 Therefore any reduction in height and massing would improve the results and analysis previously reported.

# 2.0 Summary

2.1 Our studies have again confirmed that, the neighbouring daylight and sunlight values would fully satisfy BRE criteria.

Yours sincerely

Helen Anderson B.Arch email: helen.anderson@brooke-vincent.co.uk Doc Ref. 10472/Addendum/ 5.03.15 /ha



Directors: John Carter FRICS David Sirman MRICS Andrew Cornick BSc(Hons) MRICS Brooke Vincent + Partners is the trading name of Brooke Vincent Limited, a company Registered in England and Wales No.6009355. Registered address as above.