


1. This drawing has been based upon a survey that was itself based on OUTLINE measurements NOT a full measured survey. As a result, considerable attention to the dimensions of any proposed works must be applied, taking site dimensions and templates as necessary.

2. While this drawing can be used as a base drawing for construction purposes, it is VERY IMPORTANT that all dimensions are checked carefully before any work commences or any materials are ordered.

3. This drawing can be used as part of a planning application, although your planning officer may sak for more specific information about some aspects of the design. For further information ask your architect. 4. Where applicable, a suitable Structural Engineer and/or a Party Wall Surveyor should be consulted. Although as far if he as possible these instances have been indicated, this is not processarily exhaustive and the whole scope of proposed works should be reviewed.

5. Unless other arrangements have been specifically made, your building contractor should serve a Building Notice, as and where applicable, to your local authority to satisfy the requirements of the Building Regulations. Your building contractor should also liaise with the Building Control officer regarding routine inspections of the work. While this drawing can be used as a base drawing for construction purposes, your building contractor may require more information. It is therefore important to discuss, with your architect & builder together, where more detail would be appropriate. This is a 'Scheme Level Drawing' and is intended to illustrate the general arrangement of the project proposals. As it stands this drawing does not include all of the detail necessary for a full plans building regulations application. Further detailed design / dwgs may be needed for this section. This symbol indicates that structural calculations / structural design may be required, both of which should be undertaken by a suitable structural engineer. Your designer can help point you in the right direction. This symbol indicates that it may be beneficial to have more detailed design drawings prepared to illustrate elements of the proposal in more detail so that your building contractor can more fully understand the intention of the design. You may need to consult a Party Wall Surveyor for this section. This symbol indicates that you may need to take action in order to comply with the Party Wall Act and it may ne wise to consult a suitable Party Wall surveyor. Your designer can help point you in the right direction. All dimensions are in millimetres All dimensions to be checked on site © Architect Your Home Architect Your Home Hackney
Unit B13, 3 Bradbury Street
London N16 8JN Project name: 1477_Flat 2 No.20 Ornan Road, London NW3 4PW Tel: 020 7249 1004 Email: hackney@architect-y ourhome.com/ Date: March 2014 Drawing name: Existing Second Floor Plan architectyourhome Revision: 1477 Drawn by: CF Drawing no: 012

EXISTING SECOND FLOOR PLANSCALE 1:50
0.0 0.5 1.0 1.5 2.0 2.5m

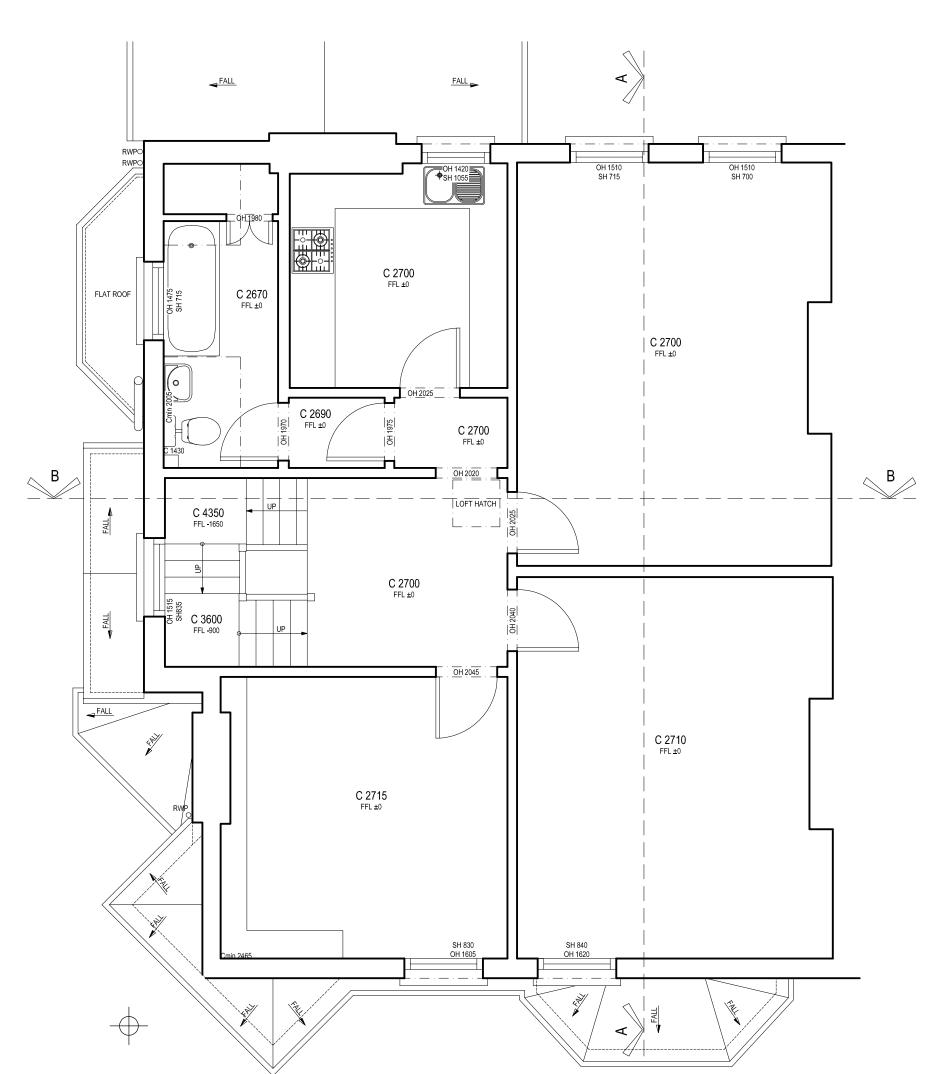

site dimensions and templates as necessary.


While this drawing can be used as a base drawing for 5. While this drawing can be used as a base drawing for 5. Construction purposes, it is VERY IMPORTANT that all dimensions are checked carefully before any work commences or any materials are ordered.

This drawing can be used as part of a planning application, although your planning officer may ask for more of specific information about some aspects of the design. For further information ask your architect. 1. This drawing has been based upon a survey that was itself based on OUTLINE measurements NOT a full measured survey. As a result, considerable attention to the dimensions of any proposed works must be applied, taking site dimensions and templates as necessary. 4. Where applicable, a suitable Structural Engineer and/or a Party Wall Surveyor should be consulted. Although as far ill ne as possible these instances have been indicated, this is not a go suitable these instances have been indicated, this is not a go suitable to the surveyor of the scope of proposed works should be reviewed.

5. Unless other arrangements have been specifically made, your building contractor should serve a Building Notice, as and where applicable to your local authority to satisfy the requirements of the Building Regulations. Your building contractor should also liaise with the Building Control of Officer regarding routine inspections of the work. While this drawing can be used as a base drawing for construction purposes, your building contractor may require more information. It is therefore important to discuss, with your architect & builder together, where more detail would be appropriate. This is a 'Scheme Level Drawing' and is intended to illustrate the general arrangement of the project proposals. As it stands this drawing does not include all of the detail necessary for a full plans building regulations application. Further detailed design / dwgs may be needed for this section. This symbol indicates that structural calculations / structural design may be required, both of which should be undertaken by a suitable structural engineer. Your designer can help point you in the right direction. This symbol indicates that it may be beneficial to have more detailed design drawings prepared to illustrate elements of the proposal in more detail so that your building contractor can more fully understand the intention of the design. You may need to consult a Party Wall Surveyor for this section. This symbol indicates that you may
need to take action in order to comply
with the Party Wall Act and it may ne
wise to consult a suitable Party Wall
surveyor. Your designer can help
point you in the right direction. All dimensions are in millimetres All dimensions to be checked on site © Architect Your Home Architect Your Home Hackney
Unit B13, 3 Bradbury Street
London N16 8JN Project name: 1477_Flat 2 No.20 Oman Road, London NW3 4PW Tel: 020 7249 1004 Email: hackney@architect-) ourhome.com Date: March 2014 Drawing name: Existing Loft Plan architectyourhome Revision: Job no: 1477 Drawn by: CF Drawing no: 013

EXISTING LOFT PLANSCALE 1:50
0.0 0.5 1.0 1.5

2.0

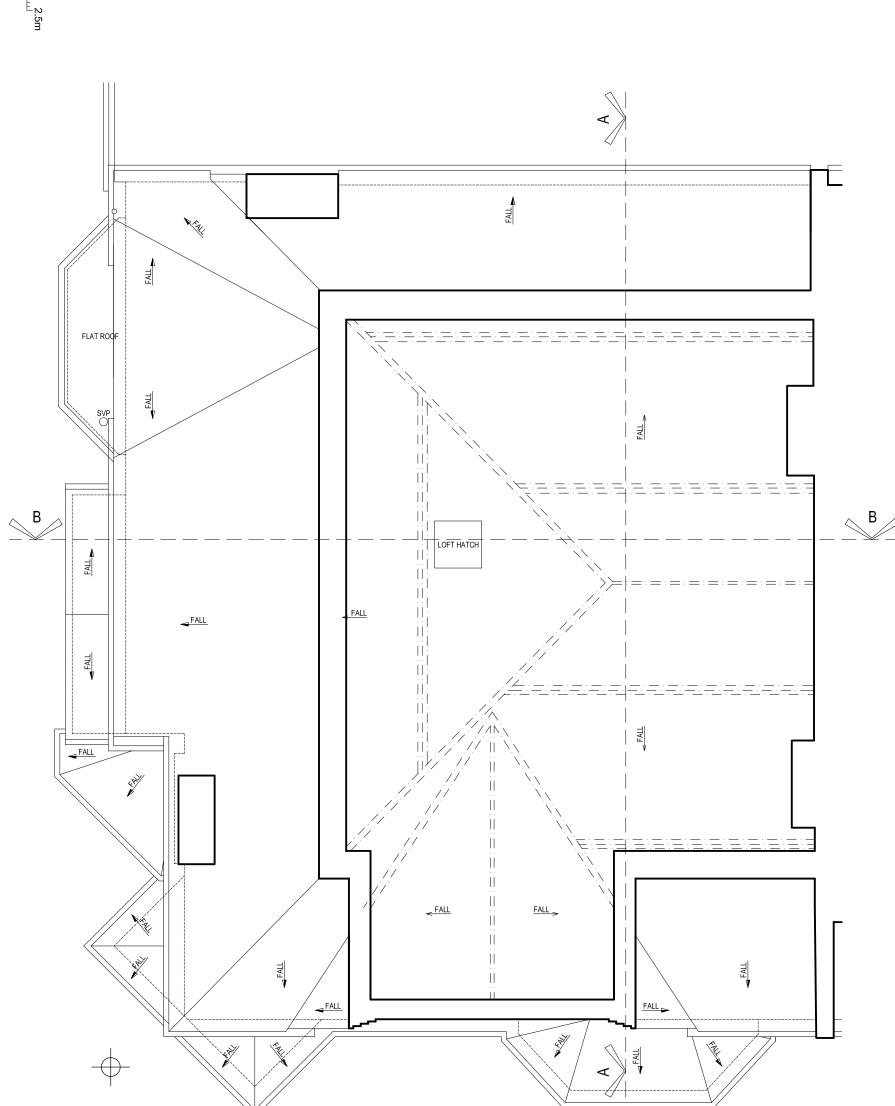

1. This drawing has been based upon a survey that was itself based on OUTLINE measurements NOT a full measured survey. As a result, considerable attention to the dimensions of any proposed works must be applied, taking ne site dimensions and templates as necessary.


2. While this drawing can be used as a base drawing for construction purposes, it is VERY IMPORTANT that all dimensions are checked carefully before any work commences or any materials are ordered.

3. This drawing can be used as part of a planning application, although your planning officer may ask for more of specific information about some aspects of the design. For further information ask your architect. EXISTING ROOF PLAN
SCALE 1:50
0.0 0.5 1.0 1.5 2 2.0 上2.5m 4. Where applicable, a suitable Structural Engineer and/or a Party Wall Surveyor should be consulted. Although as far like as possible these instances have been indicated, this is not any one cessarily exhaustive and the whole scope of proposed works should be reviewed.


5. Unless other arrangements have been specifically made, your building contractor should serve a Building Notice, as and where applicable to your local authority to satisfy the requirements of the Building Regulations. Your building contractor should also liaise with the Building Control ore Officer regarding routine inspections of the work. FALL N. A. FALL While this drawing can be used as a base drawing for construction purposes, your building contractor may require more information. It is therefore important to discuss, with your architect & builder together, where more detail would be appropriate. This is a 'Scheme Level Drawing' and is intended to illustrate the general arrangement of the project proposals. As it stands this drawing does not include all of the detail necessary for a full plans building regulations application. FLAT ROOF FALL SVP FALL Further detailed design / dwgs may be needed for this section. LOFT HATCH FALL This symbol indicates that it may be beneficial to have more detailed design drawings prepared to illustrate elements of the proposal in more detail so that your building contractor can more fully understand the intention of the design. This symbol indicates that structural calculations / structural design may be required, both of which should be undertaken by a suitable structural engineer. Your designer can help point you in the right direction. < FALL FALL FALL You may need to need to take action in order to comply consult a Party with the Party Wall Act and it may ne with the Sarty Wall Act and it may ne this section.

This symbol indicates that you may with the Party Wall Act and it may ne with the section surveyor. Your designer can help point you in the right direction. FALL FALL All dimensions are in millimetres All dimensions to be checked on site © Architect Your Home Architect Your Home Hackney
Unit B13, 3 Bradbury Street
London N16 8JN FALL > FALL NE THE Project name: 1477_Flat 2 No.20 Ornan Road, London NW3 4PW Tel: 020 7249 1004 Email: hackney@architect-y FALL FALL FALL , FALL ourhome.com A FALL Date: March 2014 Drawing name Existing Roof Plan architectyourhome Revision: Job no: 1477

Drawn by: CF Drawing no 014

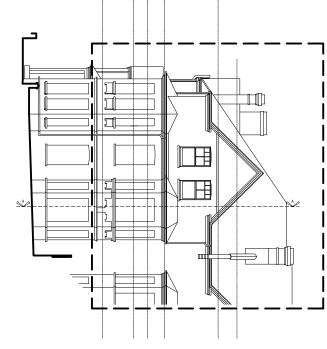

EXISTING FRONT ELEVATION SCALE 1:200

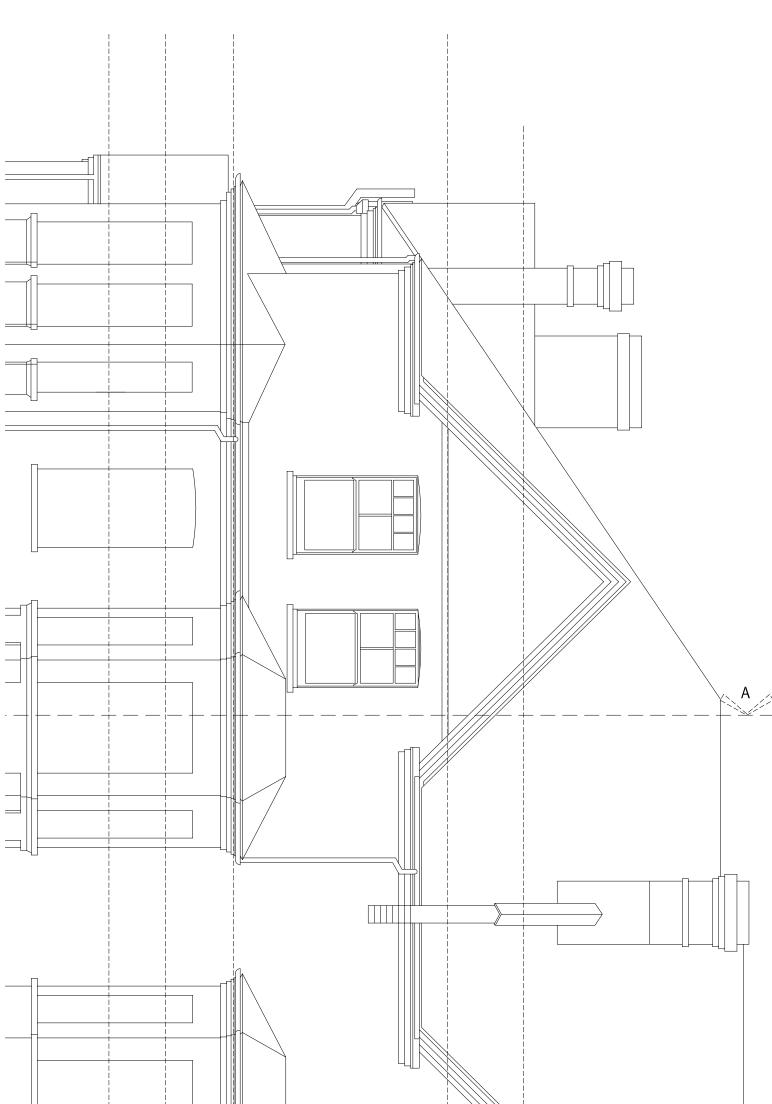

EXISTING FRONT ELEVATION
SCALE 1:50

0.5

0

2.0

1. This drawing has been based upon a survey that was itself based on OUTLINE measurements NOT a full measured survey. As a result, considerable attention to the dimensions of any proposed works must be applied, taking site dimensions and templates as necessary.

2. While this drawing can be used as a base drawing for construction purposes, it is VERY IMPORTANT that all dimensions are checked carefully before any work commences or any materials are ordered.

3. This drawing can be used as part of a planning application, although your planning officer may sak for more specific information about some aspects of the design. For further information ask your architect.

4. Where applicable, a suitable Structural Engineer and/or a Party Wall Surveyor should be consulted. Although as far lithe as possible these instances have been indicated, this is not a nong necessarily exhaustive and the whole scope of proposed works should be reviewed.

5. Unless other arrangements have been specifically made, your building contractor should serve a Building Notice, as and where applicable, to your local authority to satisfy the requirements of the Building Regulations. Your building contractor should also liaise with the Building Control ore Officer regarding routine inspections of the work.

This is a 'Scheme Level Drawing' and is intended to illustrate the general arrangement of the project proposals. As it stands this drawing does not include all of the detail necessary for a full plans building regulations application.

While this drawing can be used as a base drawing for construction purposes, your building contractor may require more information. It is therefore important to discuss, with your architect & builder together, where more detail would be appropriate.

Further detailed design / dwgs may be needed for this section. This symbol indicates that it may be beneficial to have more detailed design drawings prepared to illustrate elements of the proposal in more detail so that your building contractor can more fully understand the intention of the design.

This symbol indicates that structural calculations / structural design may be required, both of which should be undertaken by a suitable structural engineer. Your designer can help point you in the right direction.

All dimensions are in millimetres All dimensions to be checked on site © Architect Your Home

You may need to need to take action in order to comply consult a Party with the Party Wall Act and it may ne with the Sarty Wall Act and it may ne this section.

This symbol indicates that you may with the Party Wall Act and it may ne with the section surveyor. Your designer can help point you in the right direction.

Architect Your Home Hackney
Unit B13, 3 Bradbury Street
London N16 8JN Tel: 020 7249 1004 Email: hackney@architect-)

Project name: 1477_Flat 2 No.20 Ornan Road, London NW3 4PW ourhome.com Date: March 2014 Drawing name: Existing Front And Rear Elevation architectyourhome Revision: 1477 Drawn by: CF Drawing no: 013



EXISTING SIDE ELEVATIONSCALE 1:200 0.0 2.0 4.0 5.0 6.0

0.0

PROPOSED SIDE ELEVATION SCALE 1:50

05 1.0 5 2.0

1. This drawing has been based upon a survey that was itself based on OUTLINE measurements NOT a full measured survey. As a result, considerable attention to the dimensions of any proposed works must be applied, taking ne site dimensions and templates as necessary.

2. While this drawing can be used as a base drawing for construction purposes, it is VERY IMPORTANT that all dimensions are checked carefully before any work commences or any materials are ordered.

3. This drawing can be used as part of a planning application, although your planning officer may ask for more of specific information about some aspects of the design. For further information ask your architect.

4. Where applicable, a suitable Structural Engineer and/or a Party Wall Surveyor should be consulted. Although as far lithe as possible these instances have been indicated, this is not a nong necessarily exhaustive and the whole scope of proposed works should be reviewed.

5. Unless other arrangements have been specifically made, your building contractor should serve a Building Notice, as and where applicable, to your local authority to satisfy the requirements of the Building Regulations. Your building contractor should also liaise with the Building Control ore Officer regarding routine inspections of the work.

While this drawing can be used as a base drawing for construction purposes, your building contractor may require more information. It is therefore important to discuss, with your architect & builder together, where more detail would be appropriate.

This symbol indicates that structural calculations / structural design may be required, both of which should be undertaken by a suitable structural engineer. Your designer can help point you in the right direction.


All dimensions are in millimetres All dimensions to be checked on site © Architect Your Home

Project name: 1477_Flat 2 No.20 Ornan Road, London NW3 4PW


architectyourhome

This is a 'Scheme Level Drawing' and is intended to illustrate the general arrangement of the project proposals. As it stands this drawing does not include all of the detail necessary for a full plans building regulations application. -11 Further detailed design / dwgs may be needed for this section. This symbol indicates that it may be beneficial to have more detailed design drawings prepared to illustrate elements of the proposal in more detail so that your building contractor can more fully understand the intention of the design. $\overline{\mathbb{Q}}$ В You may need to need to take action in order to comply consult a Party with the Party Wall Act and it may ne with the Sarty Wall Act and it may ne this section.

This symbol indicates that you may with the Party Wall Act and it may ne with the section surveyor. Your designer can help point you in the right direction. Architect Your Home Hackney
Unit B13, 3 Bradbury Street
London N16 8JN Tel: 020 7249 1004 Email: hackney@architect-) ourhome.com Date: March 2014 Drawing name: Existing Side Elevation Revision: 1477 Drawn by: CF Drawing no: 021

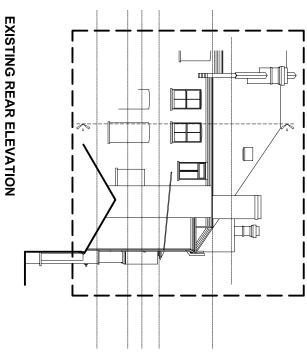

EXISTING REAR ELEVATIONSCALE 1:200

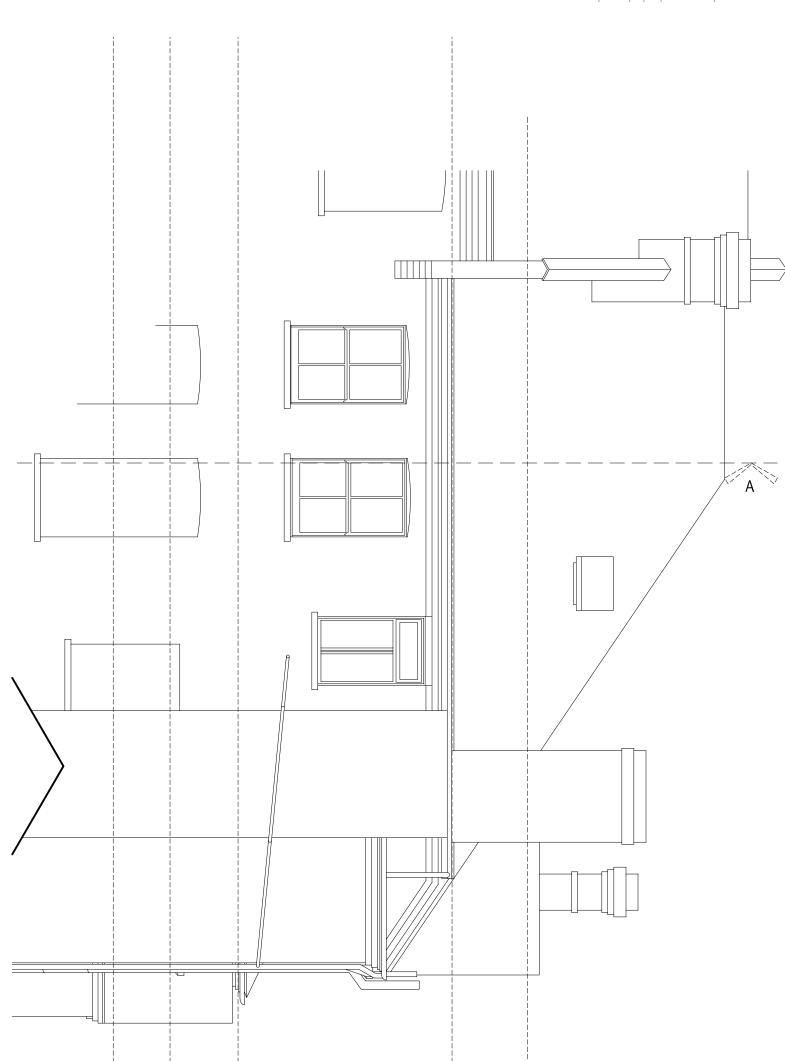

EXISTING REAR ELEVATIONSCALE 1:50
0.0 0.5 1.0 1.5 2.0

1.0

2.0

1. This drawing has been based upon a survey that was itself based on OUTLINE measurements NOT a full measured survey. As a result, considerable attention to the dimensions of any proposed works must be applied, taking site dimensions and templates as necessary.

2. While this drawing can be used as a base drawing for construction purposes, it is VERY IMPORTANT that all dimensions are checked carefully before any work commences or any materials are ordered.

3. This drawing can be used as part of a planning application, although your planning officer may sak for more specific information about some aspects of the design. For further information ask your architect.

4. Where applicable, a suitable Structural Engineer and/or a Party Wall Surveyor should be consulted. Although as far lithe as possible these instances have been indicated, this is not a nong necessarily exhaustive and the whole scope of proposed works should be reviewed.

5. Unless other arrangements have been specifically made, your building contractor should serve a Building Notice, as and where applicable, to your local authority to satisfy the requirements of the Building Regulations. Your building contractor should also liaise with the Building Control ore Officer regarding routine inspections of the work.

This is a 'Scheme Level Drawing' and is intended to illustrate the general arrangement of the project proposals. As it stands this drawing does not include all of the detail necessary for a full plans building regulations application.

While this drawing can be used as a base drawing for construction purposes, your building contractor may require more information. It is therefore important to discuss, with your architect & builder together, where more detail would be appropriate.

Further detailed design / dwgs may be needed for this section. This symbol indicates that it may be beneficial to have more detailed design drawings prepared to illustrate elements of the proposal in more detail so that your building contractor can more fully understand the intention of the design. This symbol indicates that structural calculations / structural design may be required, both of which should be undertaken by a suitable structural engineer. Your designer can help point you in the right direction.

You may need to need to take action in order to comply consult a Party with the Party Wall Act and it may ne with the Sarty Wall Act and it may ne this section.


This symbol indicates that you may with the Party Wall Act and it may ne with the section surveyor. Your designer can help point you in the right direction.

Tel: 020 7249 1004 Email: hackney@architect-)

All dimensions are in millimetres All dimensions to be checked on site © Architect Your Home

Architect Your Home *Hackney*Unit B13, 3 Bradbury Street
London N16 8JN Your Architect Your Home Licensee

Project name: 1477_Flat 2 No.20 Ornan Road, London NW3 4PW ourhome.com Date: March 2014 Drawing name: Existing Rear Elevation architectyourhome Revision: 1477 Drawn by: CF Drawing no:

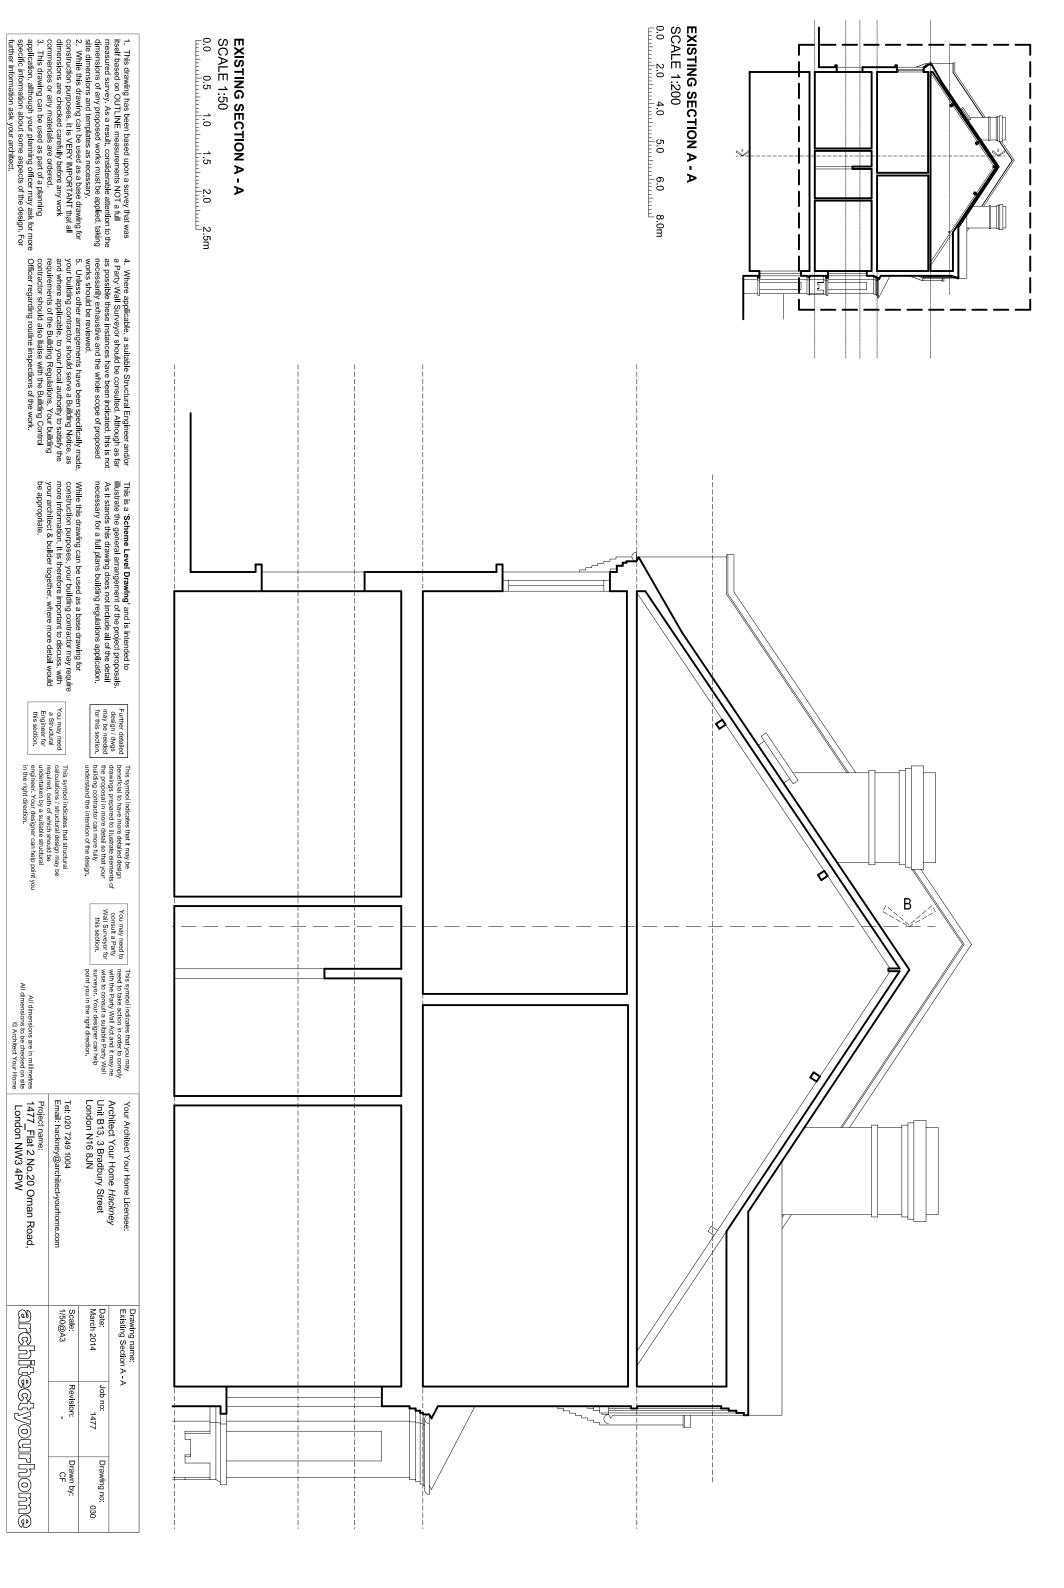

While this drawing can be used as a base drawing for construction purposes, your building contractor may require more information. It is therefore important to discuss, with your architect & builder together, where more detail would be appropriate.

This symbol indicates that structural calculations i structural design may be required, both of which should be undertaken by a suitable structural engineer. Your designer can help point you in the right direction.

All dimensions are in millimetres All dimensions to be checked on site © Architect Your Home

Project name: 1477_Flat 2 No.20 Ornan Road, London NW3 4PW

architectyourhome

Tel: 020 7249 1004 Email: hackney@architect-)

ourhome.com

Revision:

Drawn by: CF

