

Consulting Structural Engineers

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24 October 2014

Job Reference: 2710

62 Mansfield Road NW3 2HU

Structural Methodology/ Construction Management Plan

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1.0 Introduction

- 1.1 This method statement has been prepared in connection with the site 62 Mansfield Road, for the creation of a Basement under the extents of the existing property, and the creation of a new Ground Floor and associated works. The site is not in a conservation area and the immediate surrounding area is residential in character. The proposal is for the existing roof and internal ground floor walls to be demolished, and for a new single storey basement to be excavated within the existing extents of the building. This will be followed by a new Ground floor and Flat roof within the current extents of property.
- 1.2 This statement will also outline the construction methods involved as well as the impact, if any; this might have on neighbouring properties and the procedures that will be employed to safeguard the integrity of the properties.
- 1.3 This Construction Management Plan is based on preliminary plans by Barbara Weiss Architects LTD, Rev A 26/07/2013. These Plans are included in the Appendix A.

2.0 Project Overview

- 2.1 The subject property is located in a residential street with access for vehicular traffic.
- 2.2 The site is located at number 62 Mansfield Road, London NW3 2HU, which is located to the north west of London City Centre in the London Borough of Camden. The site area is the rear garden of No 62 Mansfield Road which comprises a retail premises with overlying accommodation and a rear garden converted into hard covered car parking area with double door gates leading onto Courthorpe Road. It is proposed to construct a two storey house comprising a basement and ground floor in the garden, within the footprint of the current car parking area.
- 2.3 The site is bounded to the north by a 2m high brick wall with an electricity sub-station immediately beyond, and residential properties beyond that. The site is bounded to the west by Courthorpe Road with residential properties beyond. The site is bounded to the south by 62 Mansfield Road property with Mansfield Road beyond. The site is bounded to the east by a 2m high brick wall which forms the garden wall of neighbouring property No. 64 Mansfield Road. The garden and patio area for No. 64 is beyond that.
- 2.4 Access to the new basement will be created via an internal staircase.
- 2.5 An application will be required to Camden Council for storage of materials and appropriate Enclosure Licenses to execute the works.
- 2.6 Party Wall Notices will need to be served to relevant parties.



3.0 Site Preparation and Enabling Works

- 3.1 Hoarding is to be a maximum of 2.4m high and to be painted.
- 3.2 Spoil arising from the works will be removed by hand and bagged from the working area and deposited within a roadside skip.
- 3.3 Pavements and roadside kerbs will be cleaned on a daily basis at the end of each shift or as and when required.
- 3.4 Temporary water supply and electrical services are to be provided to the working area.

4.0 Proposed Works

- 4.1 The proposal is for the existing car park to be replaced with a new 2 storey house, consisting of a single storey ground floor within the current extents of the car park, and single storey basement to be excavated within the same footprint. Headroom will be approximately 2.4m from the underside of the ground floor slab to the top of the basement slab.
- 4.2 There will be at least one large light well into the basement, from within the external walls of the building, with the basement being developed as a habitable space.
- 4.3 The remaining existing party and boundary walls will need to be underpinned in 1 metre lengths, using Reinforced Concrete retaining walls, a typical section of which is included in the Appendix B

5.0 Below Ground Drainage

- 5.1 In the event that ground water is encountered within the construction of the basement area, it is proposed that the concrete retaining walls and slab will act as the primary barrier against water ingress. An internal drain cavity system will be installed to form a watertight enclosure. The cavity drain system will incorporate a drain sump to collect any water which will then be pumped to the existing below ground surface water main drain.
- 5.2 A survey of the existing drainage system on site will need to be carried out to assess its condition and the connection point to the public sewer.



6.0 Execution of the Works

- 6.1 The site will be accessed from Courthope Road. Access to basement area will be through surface excavation during construction, and possibly demolition of some of the front external wall to allow greater access for machinery to excavate the basement, if required.
- 6.2 Temporary works will be required for the stability of the super-structure during the works.
- 6.3 Trial pits will first need to be carried out to determine the nature, extent and depth of the existing foundation.
- 6.4 The Ground floor slab will be broken out and levels reduced in a sequential pattern enabling the party walls to be underpinned in short lengths.
- 6.5 Adequate support should be provided to exposed face of excavations to ensure stability throughout the works.
- 6.6 Excavation of underpin bases are not to exceed 1.0m in length and no two adjacent sections should be excavated simultaneously. Even if the front external wall is demolished, the retaining wall will need to be built in the same manner to support the street level at the front of the property.
- 6.7 Dry packing to underpin sections should only take place a minimum of 24hrs after concreting. Maximum thickness of dry packing shall not exceed 75mm and should only be placed after the underside of the existing foundation is cleaned and regularised thoroughly.
- 6.8 Underpin bases and vertical sections are to be connected via steel reinforcement starter bars and dowel bars cast in or resin anchored to adjacent underpin at 300mm centres. Alternatively use Concrete joggle joints.

7.0 Construction Traffic Management Plan

- 7.1 Access to all vehicles, construction and excavation is from Courthope Road. Types of vehicles likely to be used during the construction of the proposed works are ready mix concrete lorries, excavators, tipper trucks, and a standard builder's merchant lorry. We anticipate an average of two deliveries per day throughout the construction period. Most of the vehicle traffic will be from tipper trucks carrying away site spoil during excavation.
- 7.2 Proposed vehicle sizes and type will ensure safe navigation within the road network.
 The property is serviced by the Local Authority waste and recycling collections and as such, access will be ensured without any difficulty.



- 7.3 The proposed working hours within which vehicles will arrive and depart are 08:00hrs
 16:00hrs Monday to Friday and Saturdays 08:00hrs-13:00hrs. No vehicle movements on Sundays and bank holidays.
- 7.4 All delivery vehicles to the site will be subject to the requirements of the Road Traffic Act and will pay due care and attention to the Health and Safety of members of the public.
- 7.5 A designated banks man will be on site throughout the duration of the works and will manage any vehicular traffic and/or members of the public on foot.
- 7.6 Measures will be taken to reduce the number of vehicles to and from the site by using recycling of existing material whenever possible and by compaction of bulky waste materials. Movement of traffic will also be reduced by effective coordination of delivery vehicles.
- 7.7 Any debris and dust arising from the works which might spread to the public highway will be the responsibility of the Foreman to ensure the public highway is hosed and swept on a daily basis.
- 7.8 The scale and nature of the project has a minimal impact on local businesses, trades, and tenants other than those occupying the property. Due to the low number of vehicle movements per day envisaged it is not proposed to establish a Construction Working Group.
- 7.9 The site Foreman will be appointed as Community Liaison for the client as far as any queries that may arise in relation to construction issues.
- 7.10 The site Foreman's contact details will be printed and clearly displayed on the boundary of the property in line with the Contractors Considerate Scheme recommendations.
- 7.11 The contractor will follow all relevant guidelines set out in the Contractors Considerate Scheme as well as guidance set out in the Code of Conduct within that organisation.
- 7.12 The agreed contents of this Construction Management Plan must be adhered fully unless otherwise agreed with the Council. The site Foreman shall liaise closely with the council to review this Construction Management Plan if problems arise in relation to the construction of the development. Any future revised plans or deviations from this document must be submitted to the Council for approval.



8.0 Machinery

8.1 For the proposed single storey basement, excavation machinery may be used if the contractor requires it. Site machinery will also consist of compressors and air tools.

9.0 Conclusion

The proposed works when executed correctly in accordance with this structural methodology, management plans as well as all relevant plans and specifications will not pose any significant threat to the structural stability of adjoining properties.



APPENDIX A



Mansfield Road

Gross Internal Area	sqm
Proposed Lower Ground Floor	28.5 sqm
Proposed Gound Floor	28.5 sqm
Total Floor Area	57 sqm

Client	Allan Properties Limited	bd	
Project	62 Mansfield Road		
Drawing Title	Site Plan		
Scale 1:200 / A3	3 Date Jun 2013	Drawn MC	MC
Job no. 1312	2 Dwg no. PL(00)01 Rev no. A	Rev no.	➤
BARBARA	BARBARA WEISS ARCHITECTS LTD	TECTS	11D
86A CRANE GROVE (18A CRANE GROVE LONDON N7 BLE TEL 020 7609 1867 FAX 020 77002952	87 FAX 020	77002952

Notes

1 Do not scale from drawing
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without the prior permission of the architect
Any descripting between the and any other documents shall be
referred immediately to the architect. IF IN DOUBT ASK

A 26.07.13 Issued for Pre-planning Application

Revisions






L(02)00/2





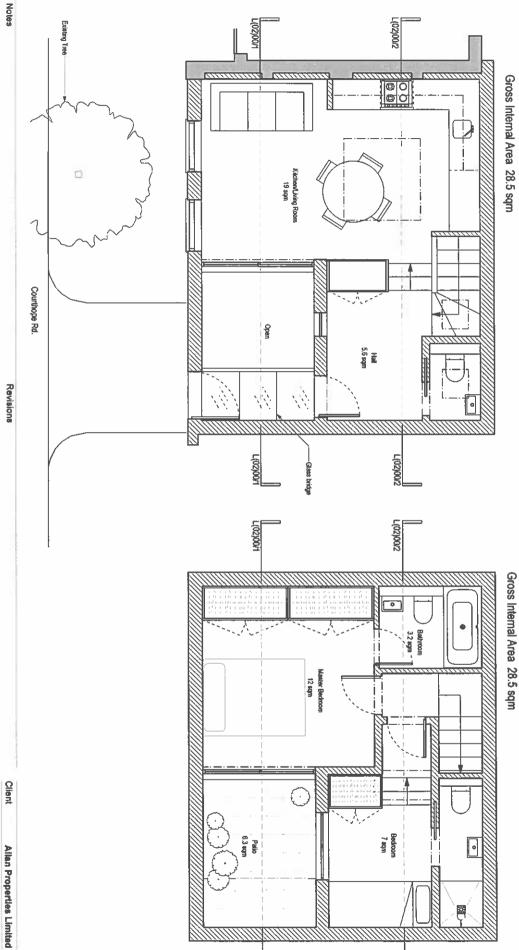

L(02)00/1

BARBARA WEISS ARCHITECTS LTD

18A CRANE GROVE LONDON N7 BLE TEL 020 76091867 FAX: 020 77002952

Scale 1:50 / A3 Date Jun 2013


Job no. 1312 Dwg no. L(01)00

Rev no. A Drawn MC Drawing Title Proposed LGF & Ground Floor Plan

62 Mansfield Road

A 28,07.13 Issued for Pre-planning Application

1. Do not scale from drawing.
2. All dimensions in millimeters unless noted otherwise.
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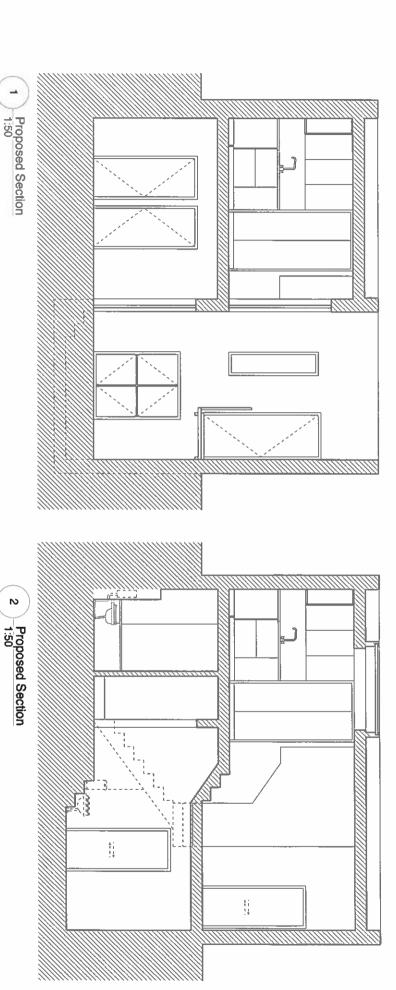
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Job no.	Scale 1:50 / A3	Drawing Title	Project	Client
1312) / A3			
Dwg no. L(01)01	Date Jun 2013	Proposed Roof Plan	62 Mansfleld Road	Allan Properties Limited
Revno. A	Drawn MC			Tea
>	NC.			

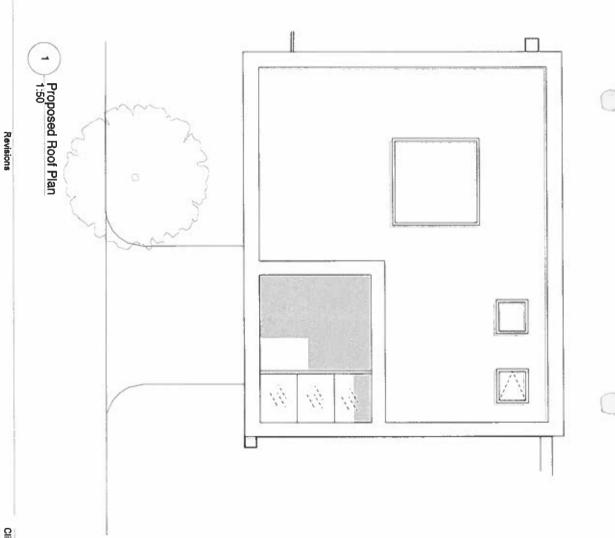16A CRANE GROVE LONDON N7 BLE TEL 020 76091887 FAX 020 77002852

BARBARA WEISS ARCHITECTS LTD



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Revisions

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Client

Allan Properties Limited 62 Mansfield Road


BARBARA WEISS ARCHITECTS LTD

16A CRANE GROVE LONDON N7 BLE TEL 020 76091867 FAX: 020 77002952

Drawing Title Proposed Sections
Scale 1:50 / A3 Date Jun 2013

Job no. 1312 Dwg no. L(02)00

Drawn MC Rev no. A

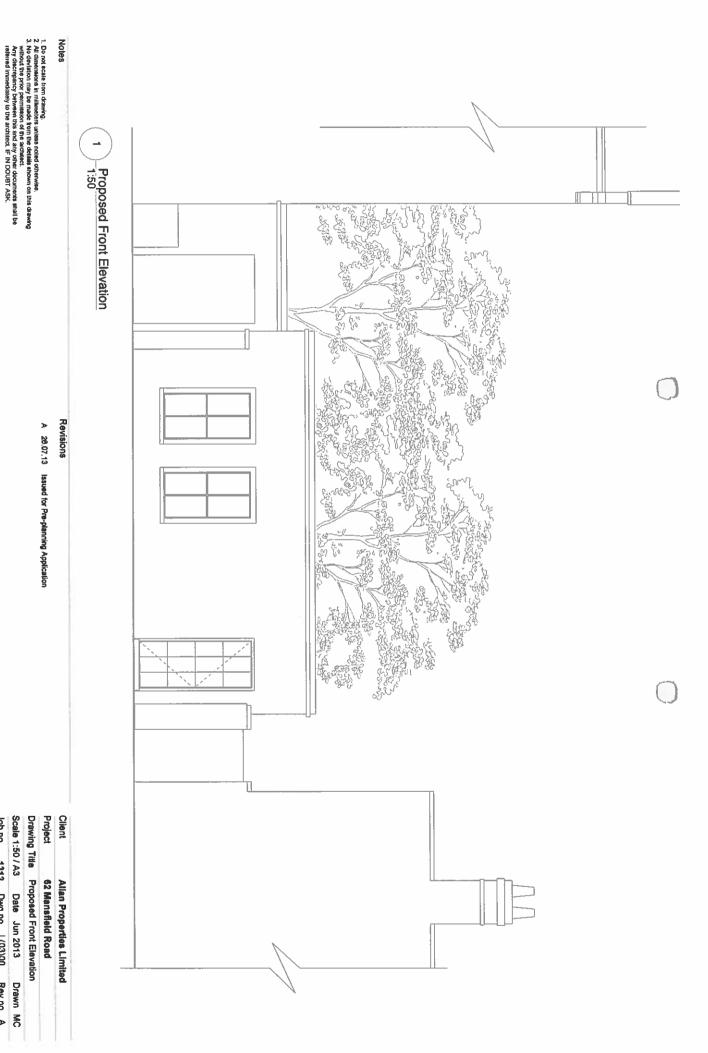


16A CRANE GROVE LONDON N7 6LE TEL. 020 76091867 FAX 020 77002952 BARBARA WEISS ARCHITECTS LTD Scale 1:50 / A3 Date Jun 2013

Drawn MC

Job no. 1312 Dwg no. L(03)00 Rev no. A



APPENDIX B

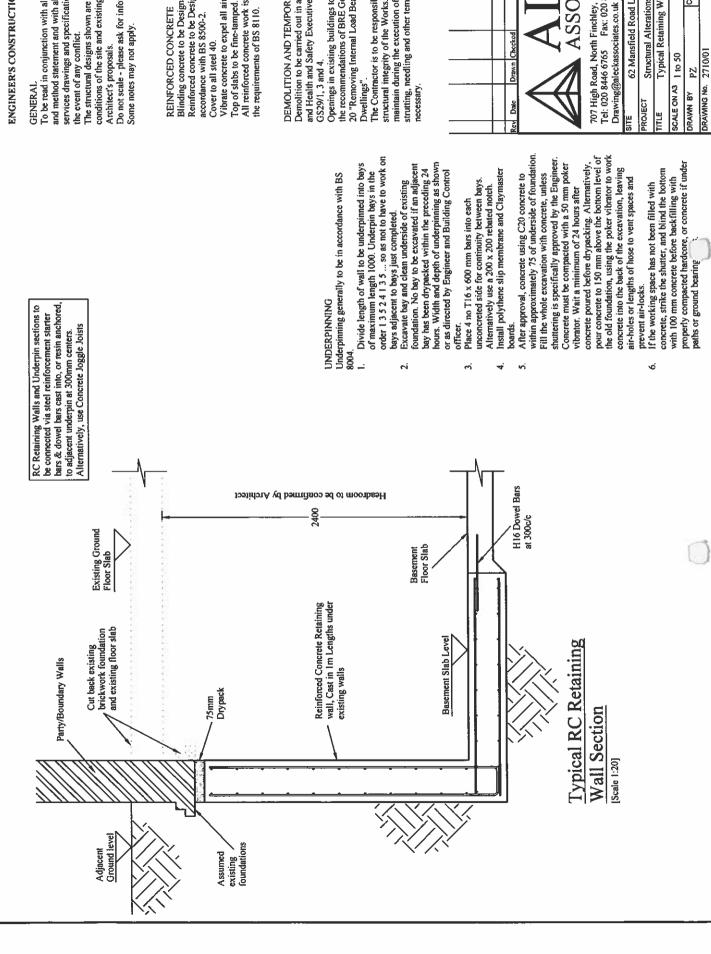

ENGINEER'S CONSTRUCTION NOTES

services drawings and specifications. Seek instructions in To be read in conjunction with all Engineers' drawings and method statement and with all architectural and

The structural designs shown are to be set out to suit the conditions of the site and existing works if any and the

Do not scale - please ask for information.

REINFORCED CONCRETE

Reinforced concrete to be Designated Mix RC35 in Blinding concrete to be Designated Mix GEN1.

Vibrate concrete to expel all air.


All reinforced concrete work is to be in accordance with Top of slabs to be fine-tamped.

DEMOLITION AND TEMPORARY WORKS

Demolition to be carried out in accordance with BS 6187 and Health and Safety Executive Guidance Notes

Openings in existing buildings to be formed according to the recommendations of BRE Good Building Guide no. 20 "Removing Internal Load Bearing Walls in Older

structural integrity of the Works. Design, supply and maintain during the execution of the Works all shoring, strutting, needling and other temporary works as may be The Contractor is to be responsible for the stability and

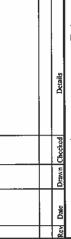

ASSOCIATES

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62 Mansfield Road London NW3 2HU	Structural Alterations, New Basement	Typical Retaining Wall Section	
ш	PROJECT	TITLE	

ALE ON A3	1 to 50	DATE	24.10.2014
AWN BY	PZ	СНЕСКЕО ВУ	SIA
AWING No. 2710/01	2710/01		REV

