

contractors are to check all levels and dimensions before work is put in hand, and any discrepancies are to be referred to the architects					
REV DATE DESCRIPTION DWN CHKD					
A 20.10.14 Balustrade revised, Finishes noted					



Architects + Interior Designers Limited GREAT BURSTEAD SCHOOL HOUSE, 70 LAINDON ROAD, BILLERICAY, ESSEX CM12 9LD TEL: 01277 632306 FAX: 01277 632307 E-MAIL:admin@lap-architects.co.uk

www.lap-architects.com

# project

The Bull and Gate 389 Kentish Town Road

London NW5 2TJ

# client


Young & Co's Brewery PLC


# drawing title

New staircase Details


А			revision				
che	ecke	d					
drawn KJB							
date August 20		2014					
	dro	drawn	110	drawn KJB	drawn KJB		

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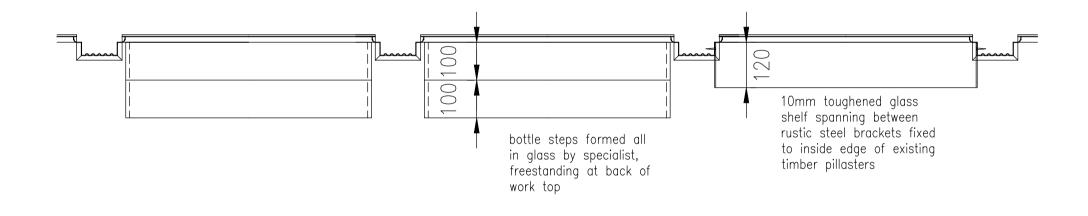


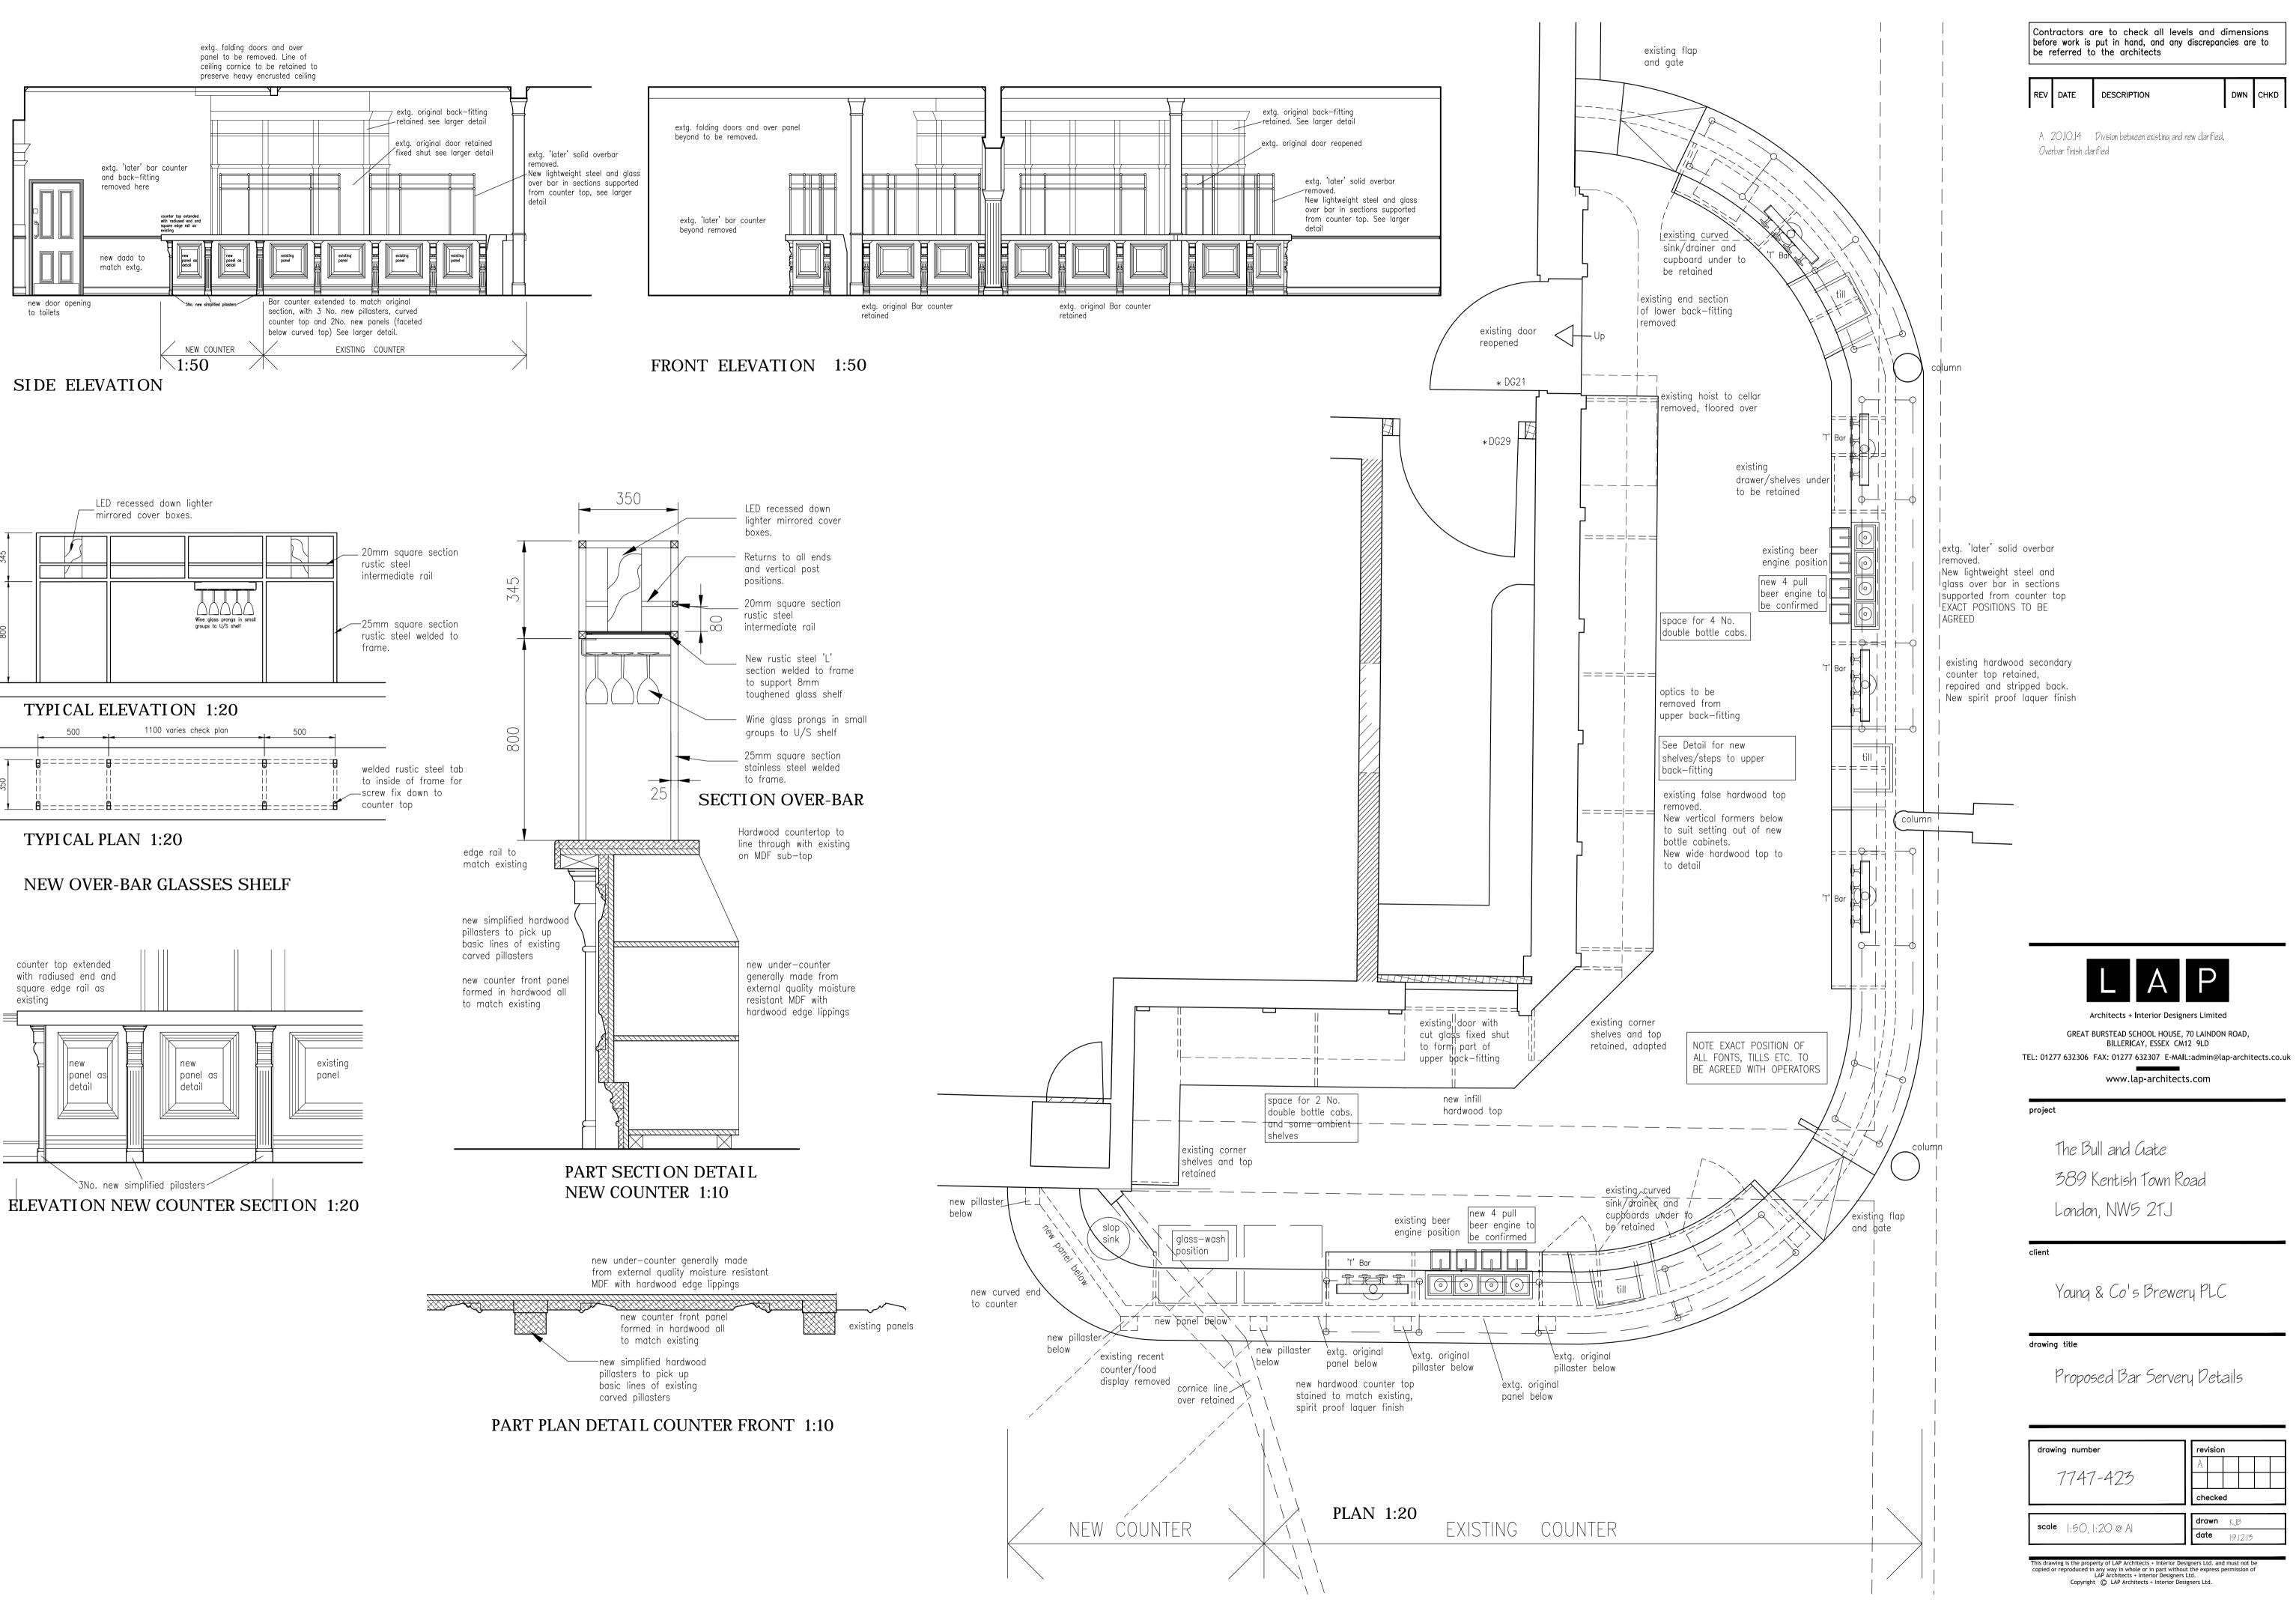

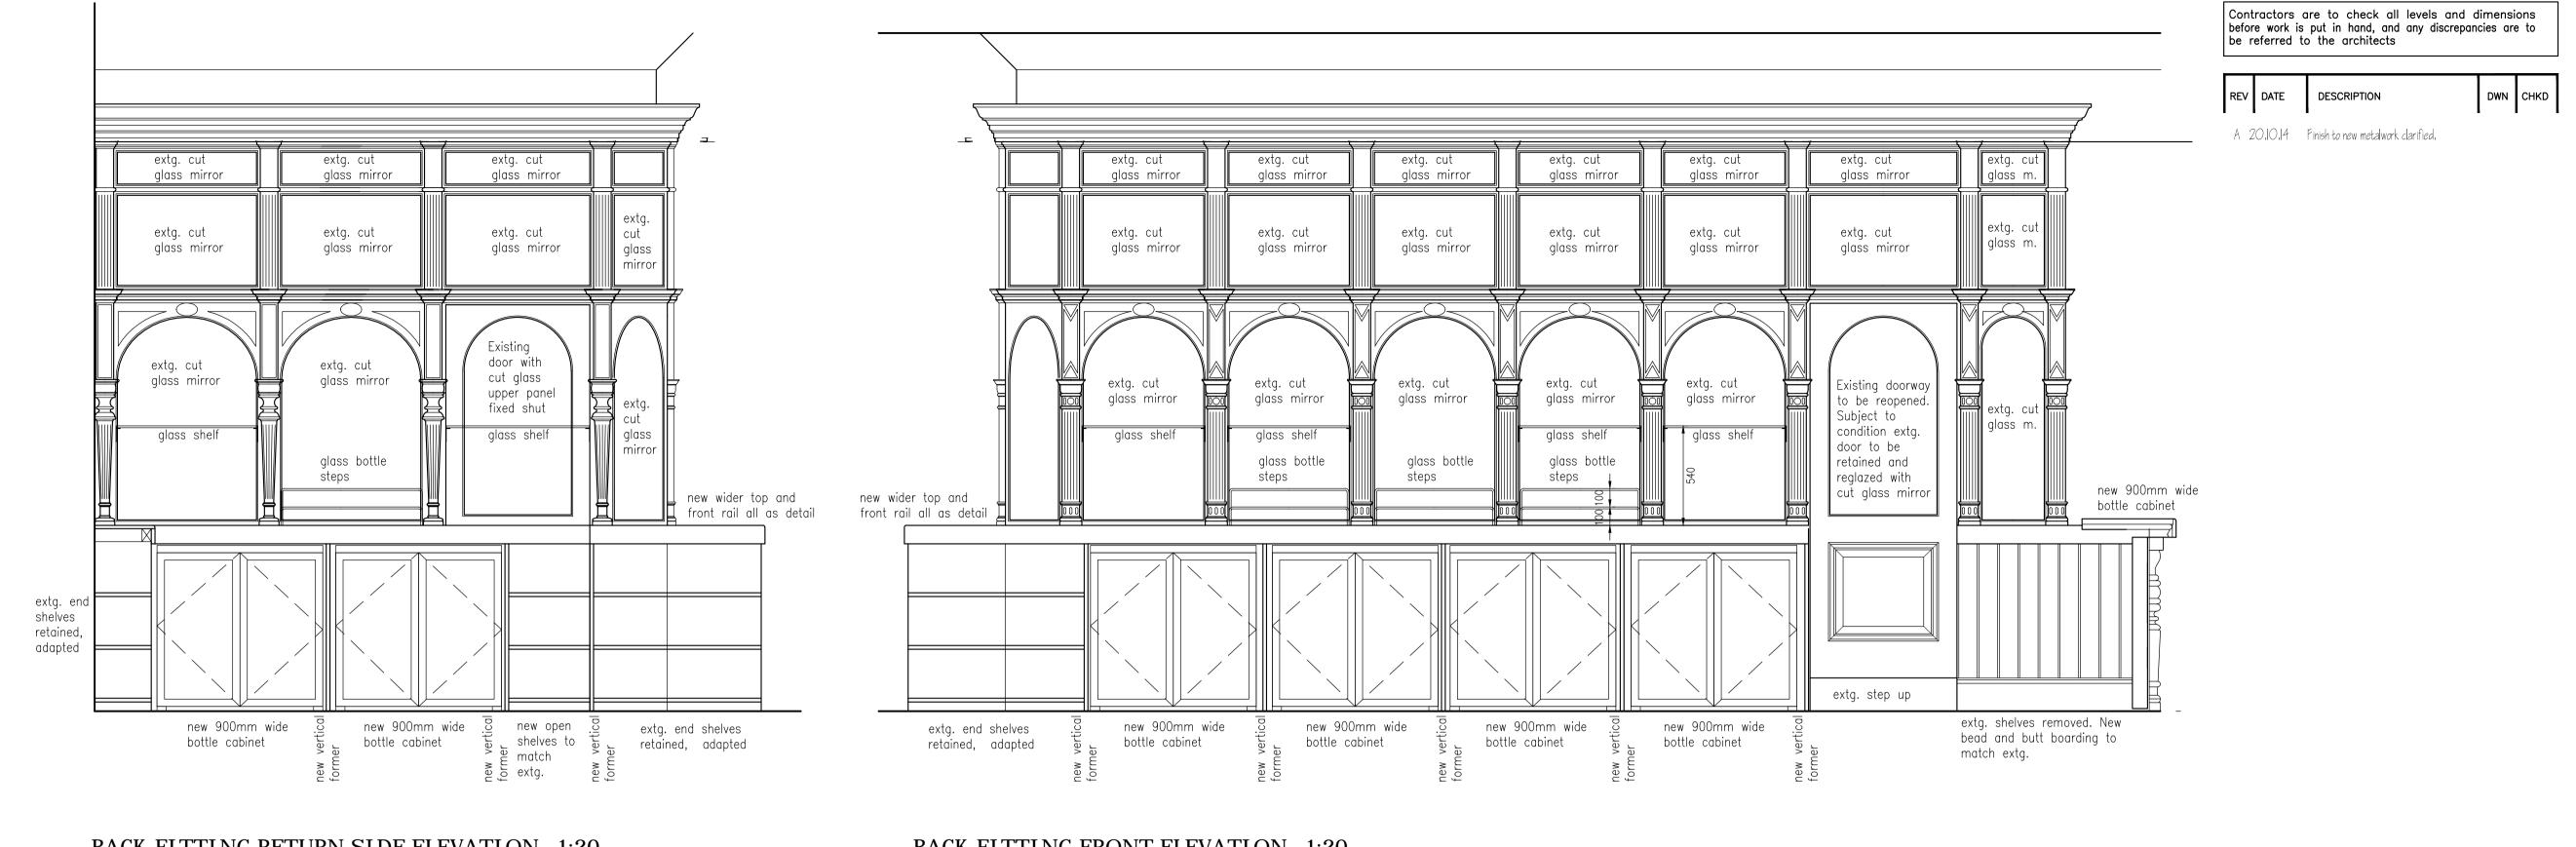


BACK-FITTING SECTION 1:10

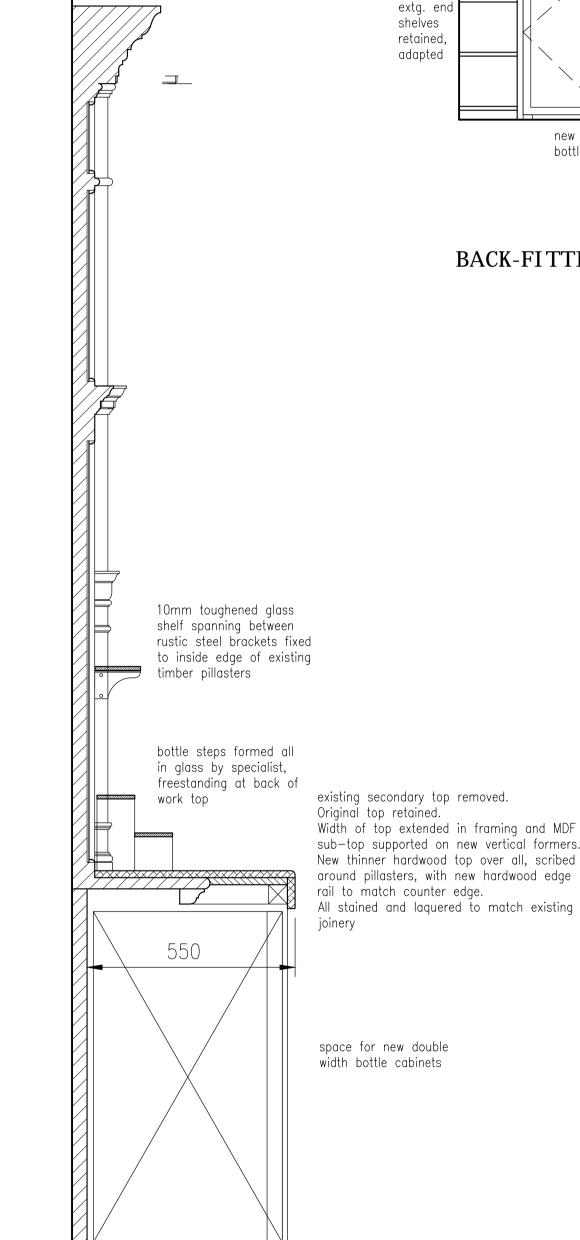



PLAN GLASS SHELVES 1:10

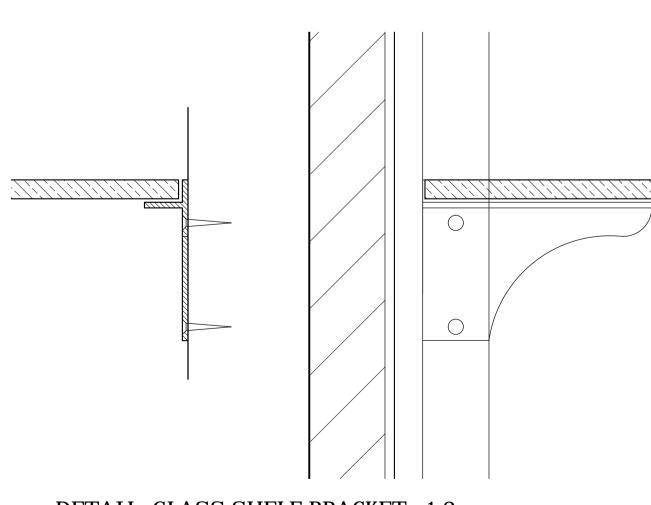

DETAIL GLASS SHELF BRACKET 1:2



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Young & Co's Brewery PLC

# drawing title

Proposed Bar Servery Details sheet 2

drawing number	revision
	A
7747-424	
	checked
scale  ;20,  ; 0 @ A	drawn KJB
120,110 071	date 19-08-2014

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strips and cold smoke seals to resist the

Note. If Magnetic door locks used they must be linked to fire alarm system, so that if Fire alarm is activated or there is a power failure, doors will be released.

- $\odot$  alarm call point

round, on 1200g. DPM on in-situ or suspended beam and block slab to Struct. Eng's details. blinding on hardcore (as S.E. spec.) 1000g. vapour barrier layed over insulation before slab is layed.

'Derbigum' or similar approved on

# RAIN WATER GOODS


Door furniture to contrast with door colour. Handrails, grab rails etc. to contrast with wall Colour variation to be greater than 30 point. Exact


MATERIALS

Test certificates for Intumescent materials, Electrical

Certificate being issued.

WALL LE	EGEND
<u>17 17 17 17 17 17 17 1</u>	<u>Facing Brickwork</u> Generally reclaimed stocks to appro mixed. To be laid Flemish bond.
7777777777777777777	<u>Blockwork</u> Check thickness, strength, and type location with other drawings and specifications, and Struct. Eng's spe
	existing walls
******	New partitions to timber floor areas 100x50 SW studs @400 c/c with 2 plasterboard on both sides (M.R. gr with plaster set coat. Acoustic quilt Allow for additional noggins or ply l fixings required Dimensions shown to finished face.
	103mm common brick outer leaf. 1 block inner leaf with 100mm wide o insulation as 'Dri-therm 34' External face to have 'bucket handl
	Stainless Steel wall ties to B.S. at 450mm vert. c/c staggered. and a all jambs etc.
	Plastered internally, or dry lined. All door reveals to have insulated cavil 'Thermabate' or similar.

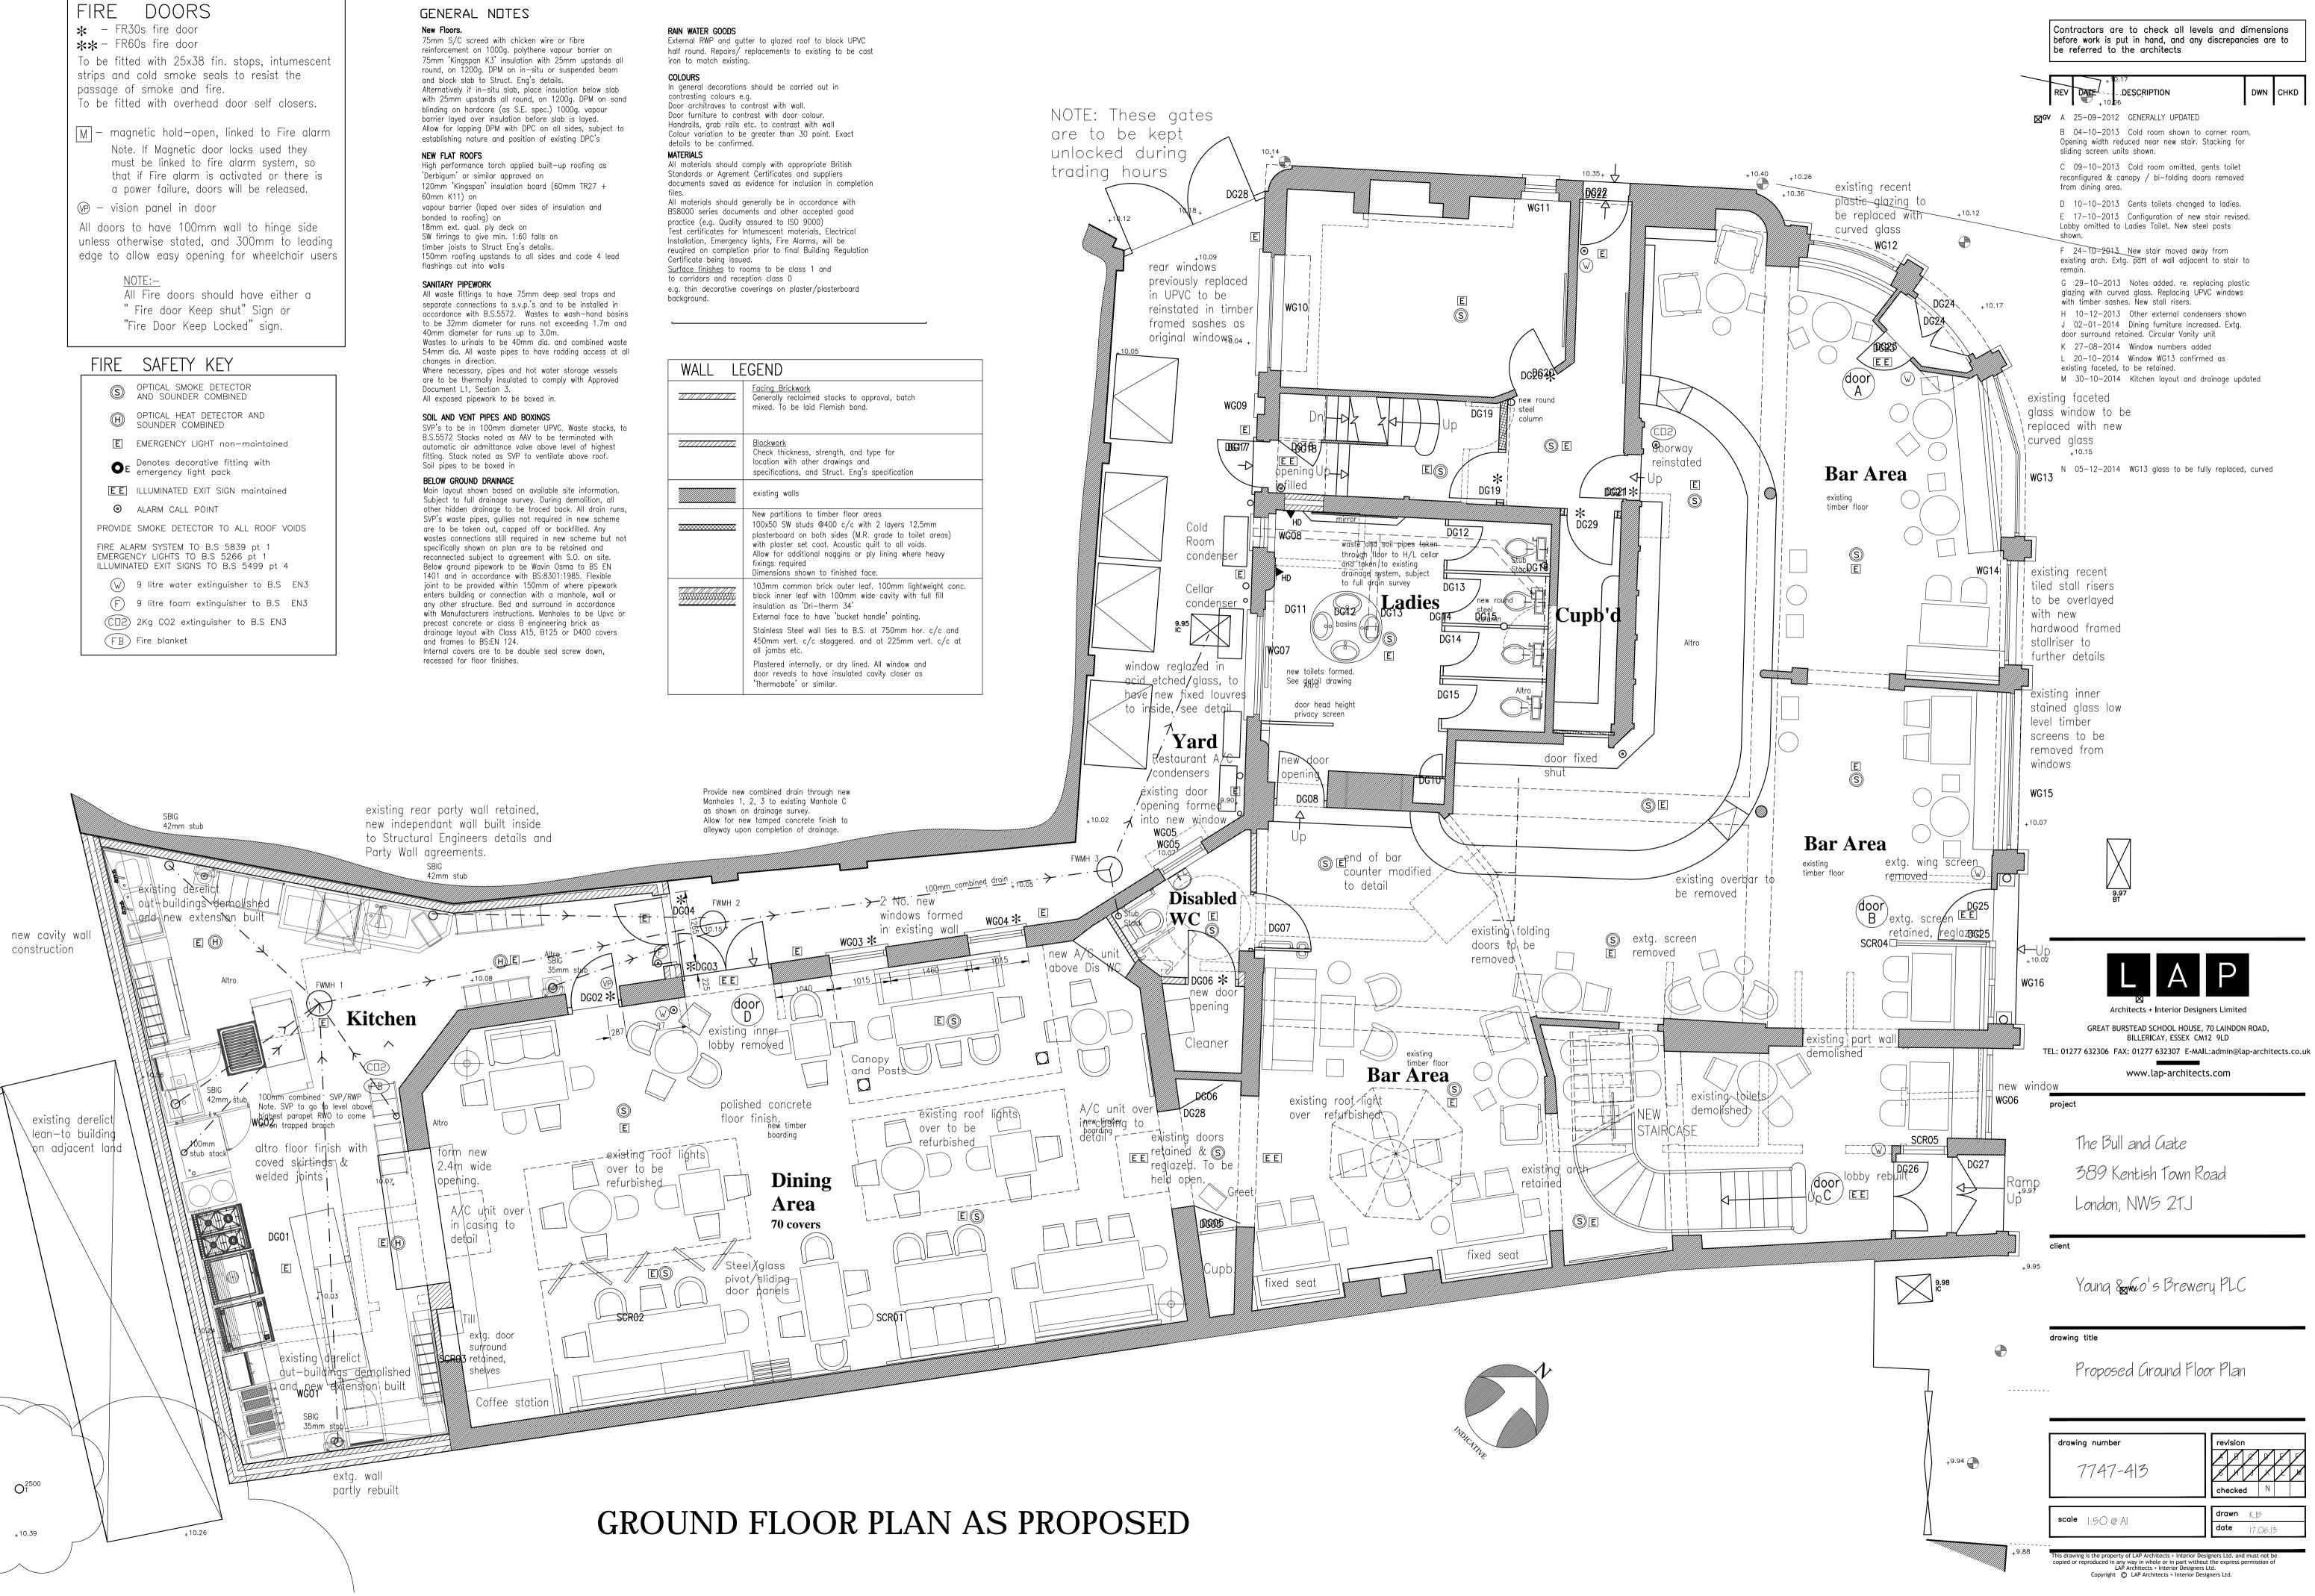

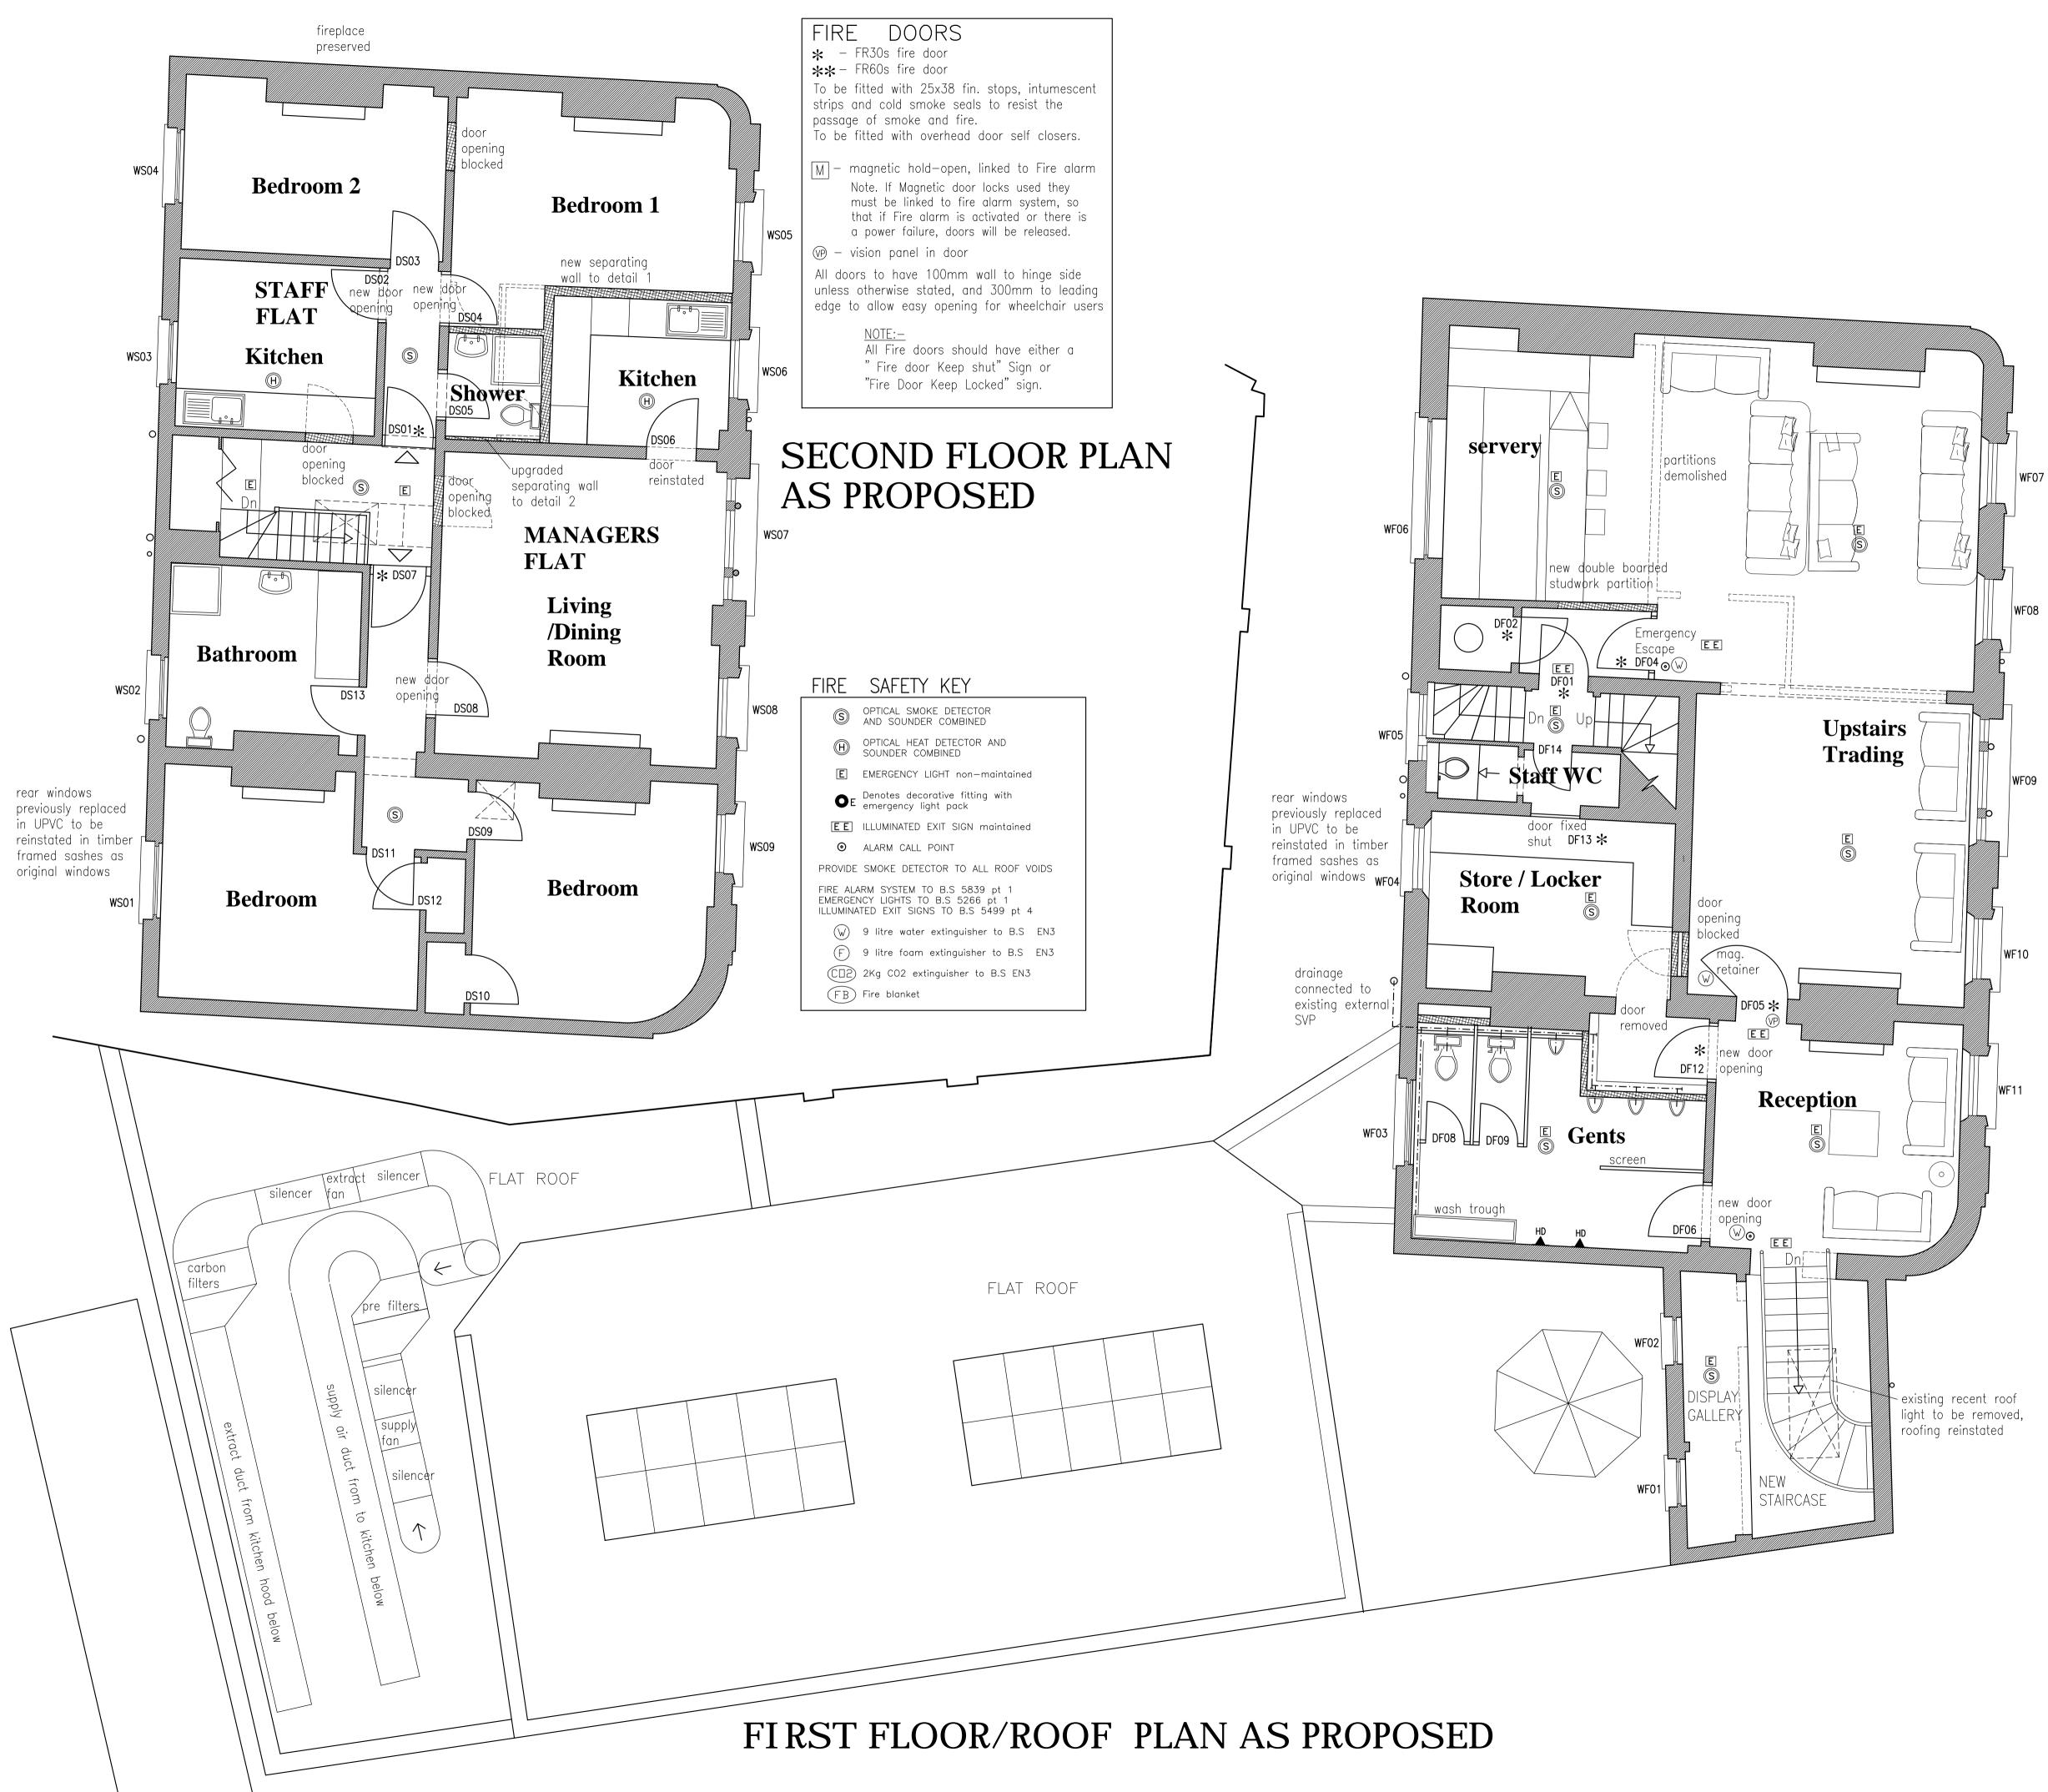

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REV DATE	DESCRIPTION	DWN	СНКД	
A 25-09-2012	2 GENERALLY UPDATED			
	3 Doors to Function Room updated d. Store now back—up with double			
	3 Ladies toilets reconfigured & changed to 'Store/Locker Room'.			
D 10-10-2013	3 Ladies toilet changed to gents.			
"Function Room'	3 Room name changed from ' to "Upstairs Trading", in the clients comment.			
F 17-10-2013 drainage	3 Gents toilet reconfigured to assis	t		
G 24-10-2013 arch. Opening a	3 New stair moved away from extg t First Floor level adjusted according	ı. gly		
J 18-11-2013	3 Kitchen extract system shown.			
	4 Window numbers added			
L 20-10-2014				
M 05-12-201 First Floor serve magnetic retaine	ery/furniture layout revised. DF05 on			

LAP

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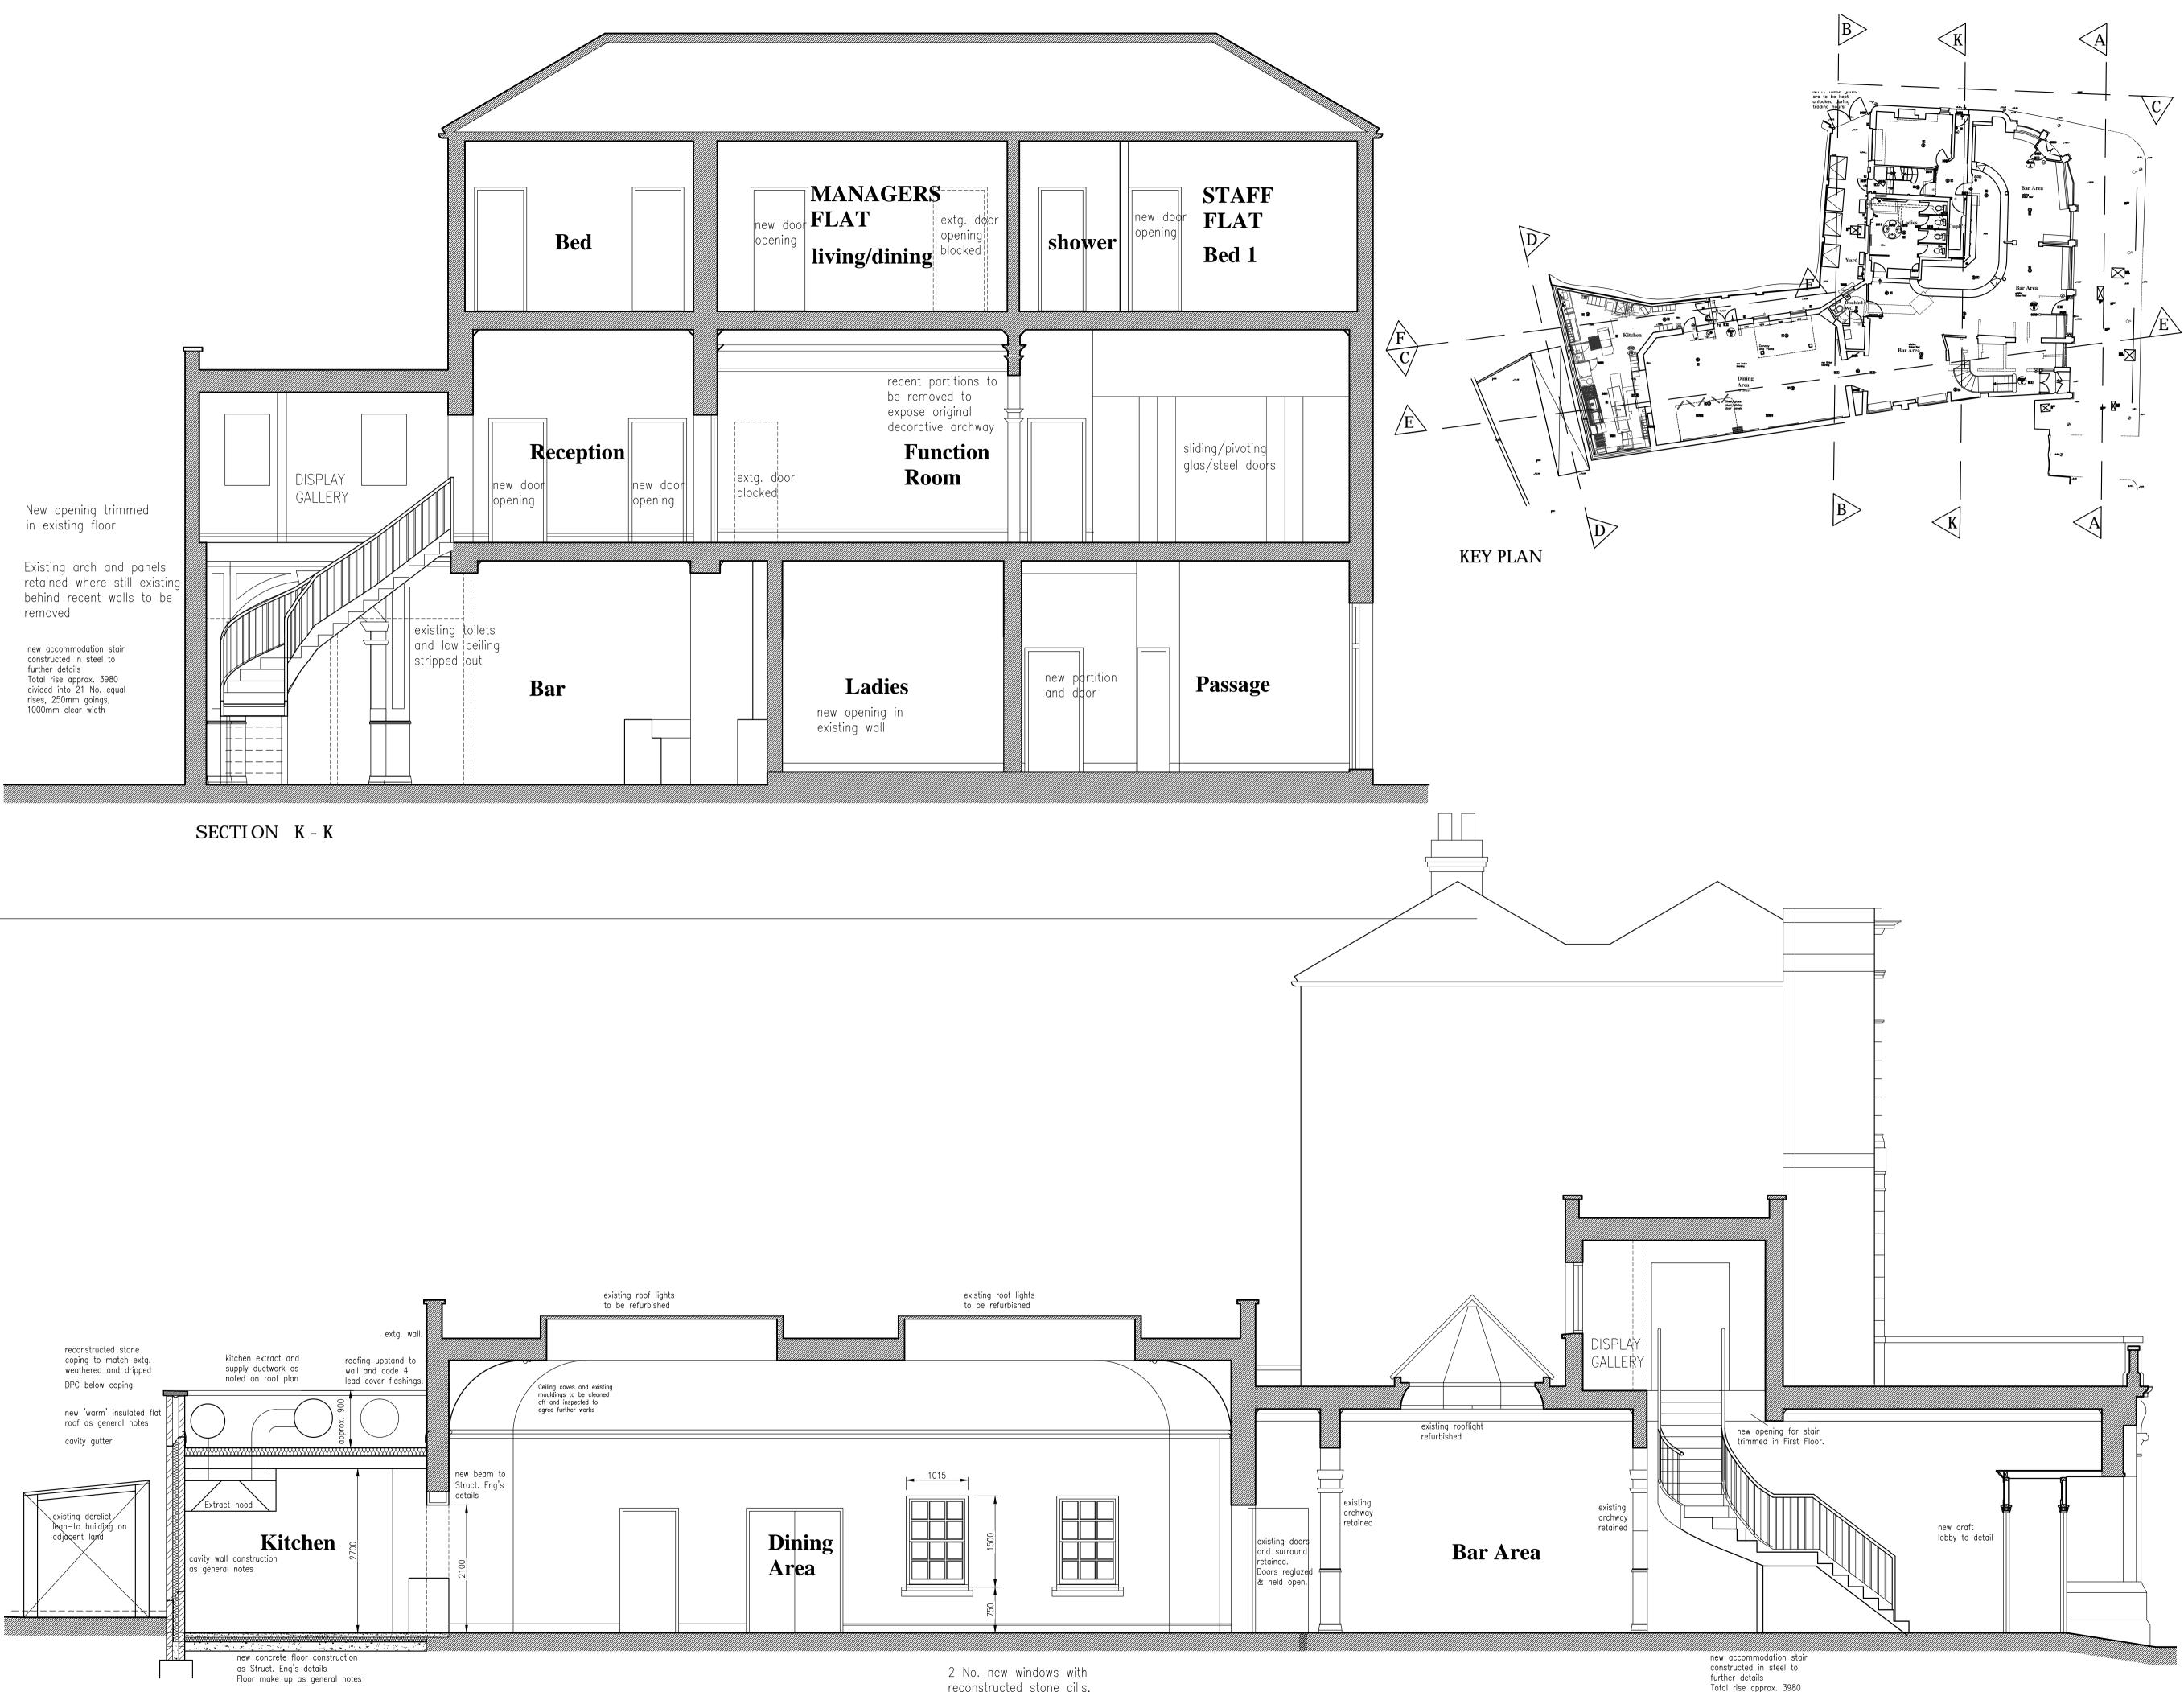
Young & Co's Brewery PLC


drawing title

Proposed First and Second Floor Plans

drawing number 7747-414	revision
scale  :50 @ A	drawn     KJB       date     17.06.13

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brick soldier arches,

formed in existing wall
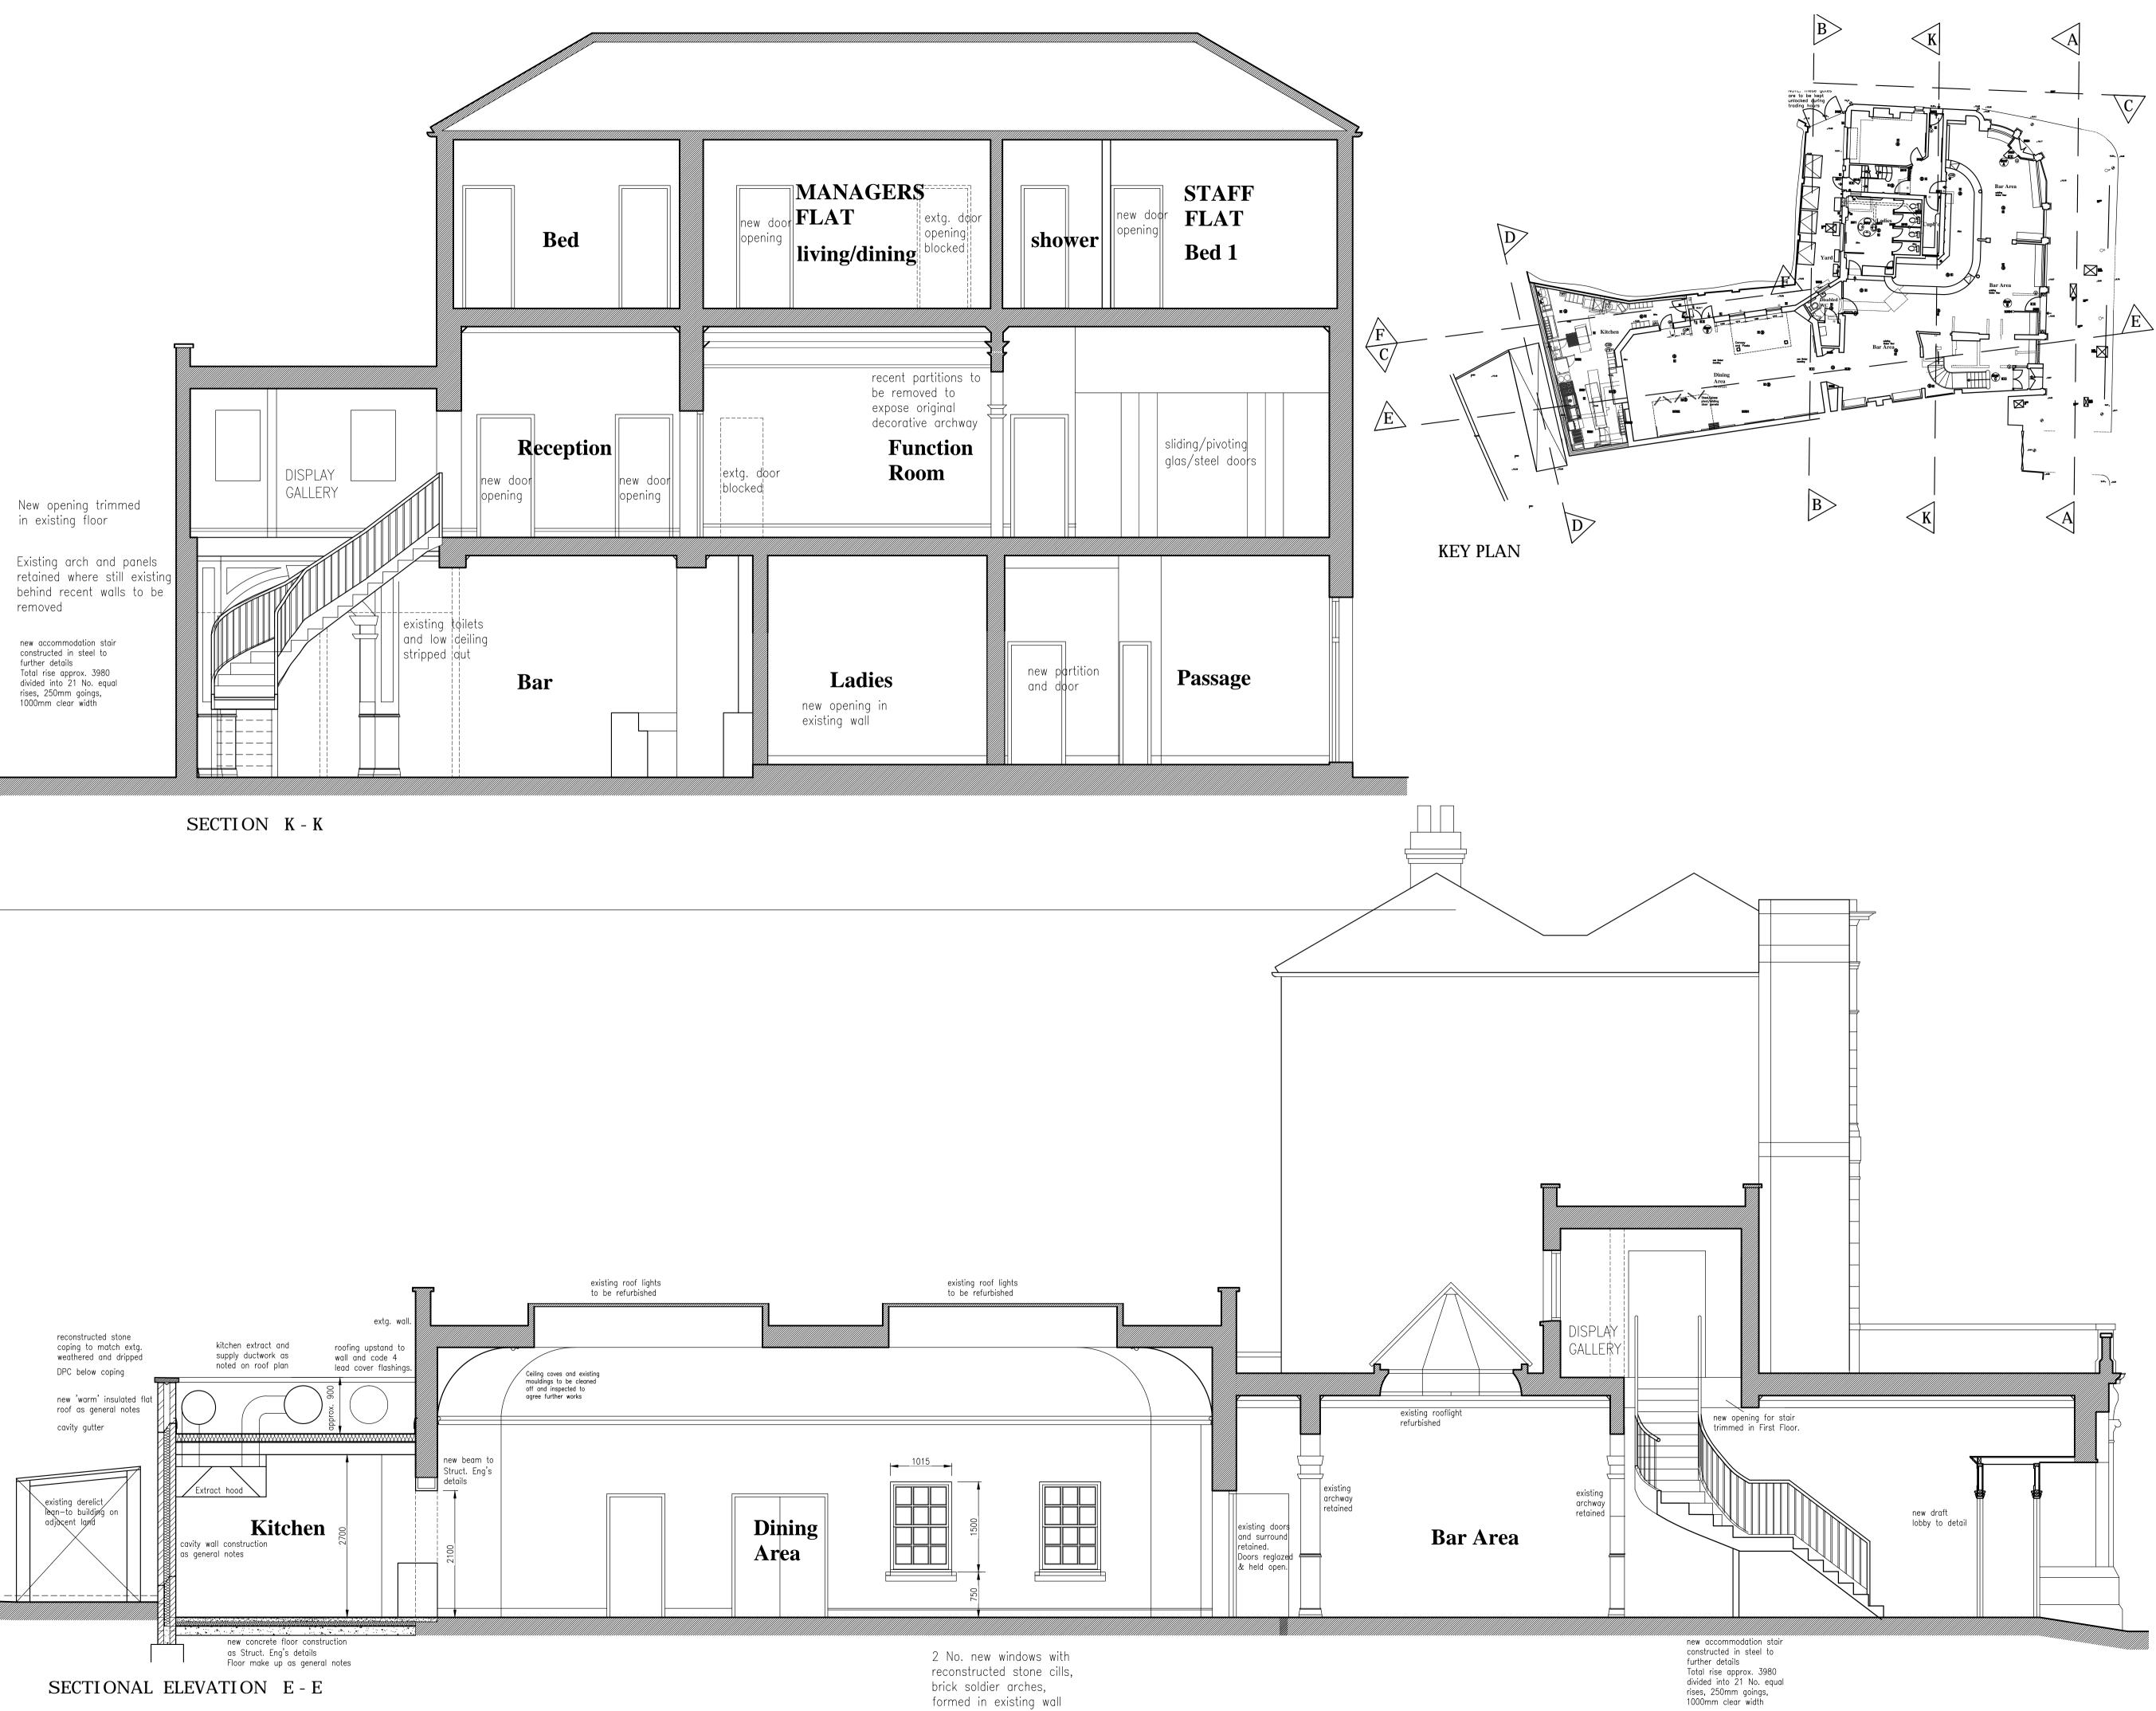
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REV	DATE	DESCRIPTION	DWN	СНКД		
В		<ul><li>3 Stair updated as latest plan</li><li>3 New Stair moved away from</li></ul>				
		<ul><li>3 Kitchen extract system shown</li><li>4 Stair updated, doors updated</li></ul>				

toilets updated



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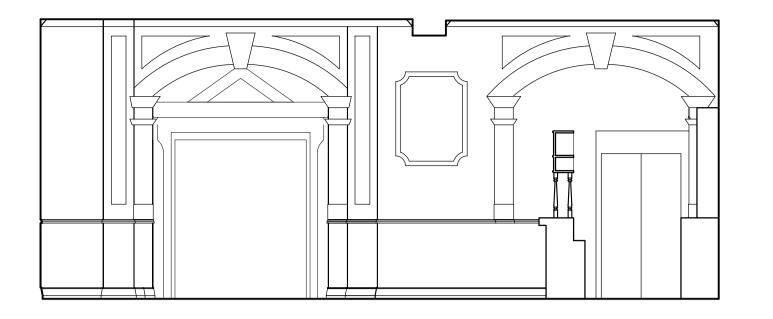
Young & Co's Brewery PLC


drawing title


Proposed Sections

drawing number	revision				
7747-415	A B C D				
	checked				
	drawn KJB				
scale  :50 @ A	date  4.02.13				
	. <u> </u>				

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counter retained

extg. folding doors and

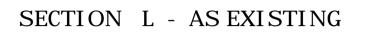over panel beyond to

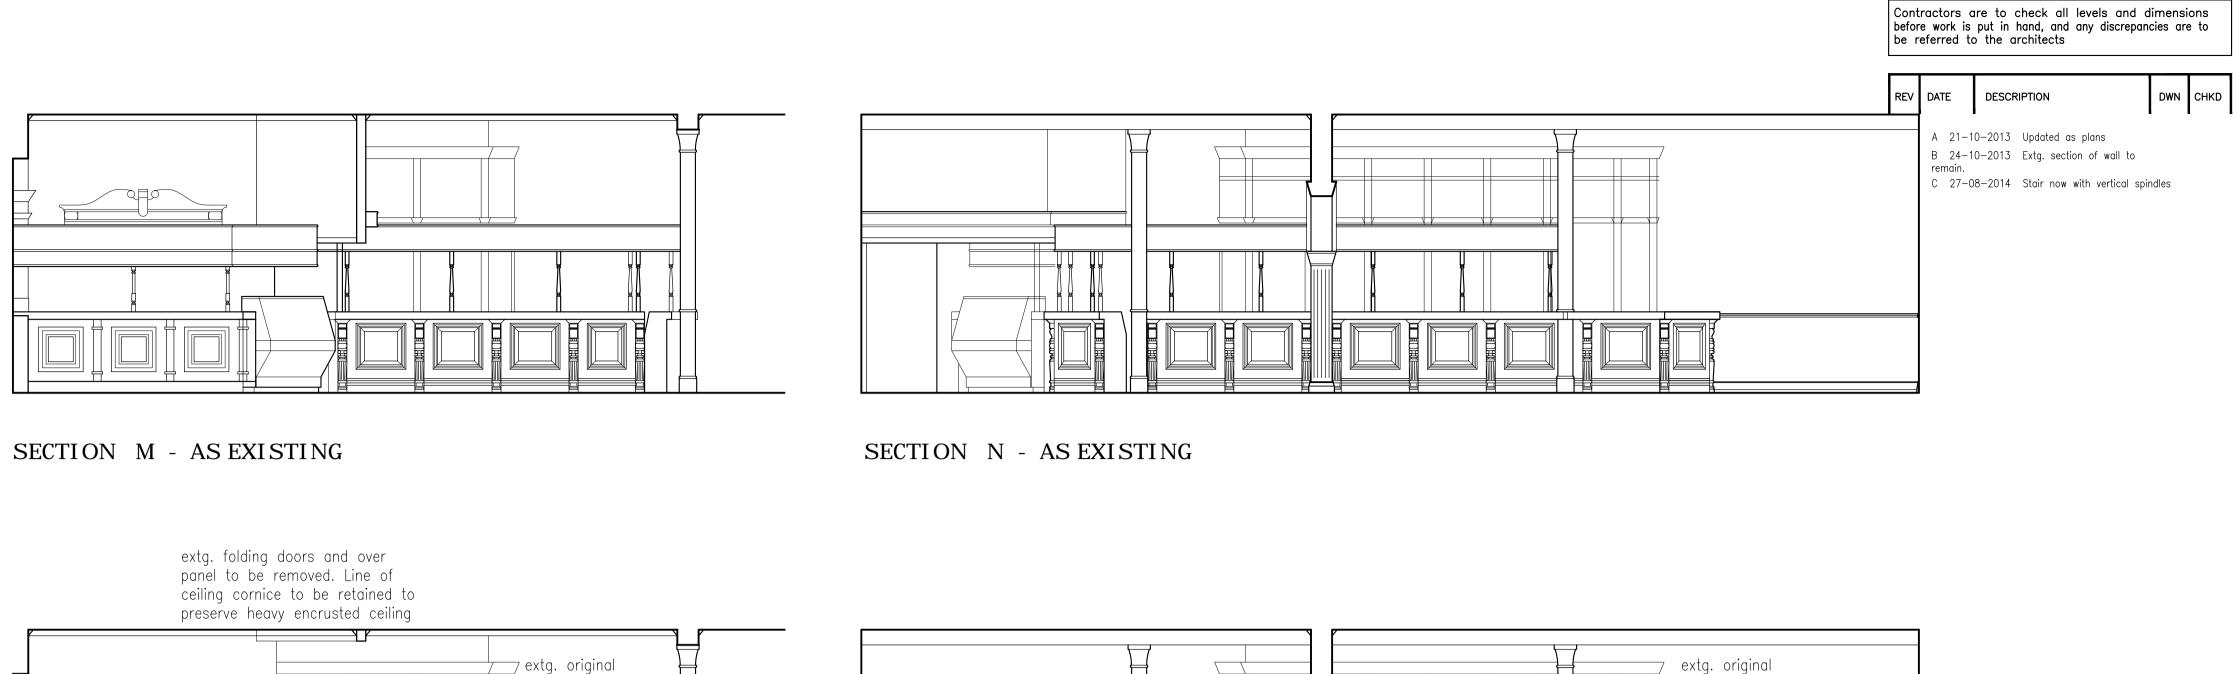
extg. 'later' bar


counter beyond

SECTION N - AS PROPOSED


removed

be removed.

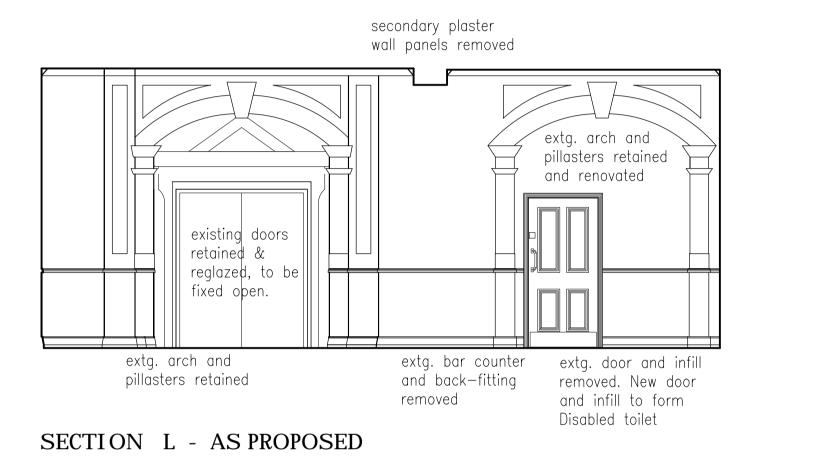


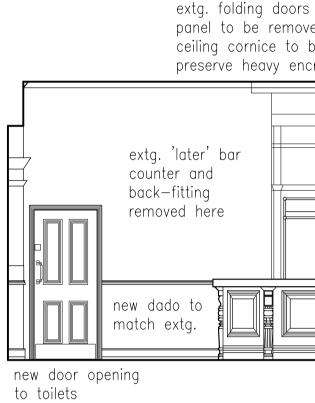


SECTION M - AS PROPOSED below curved top)

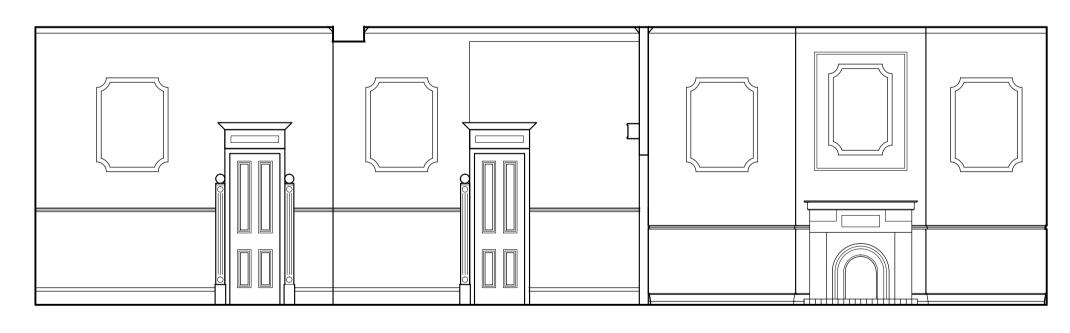

SECTION P - AS EXISTING

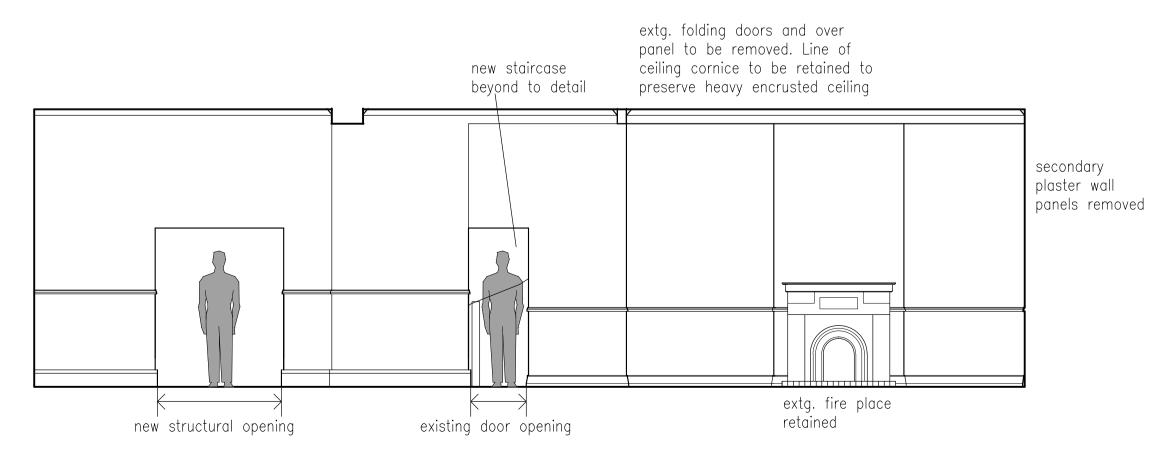

SECTION P - AS PROPOSED

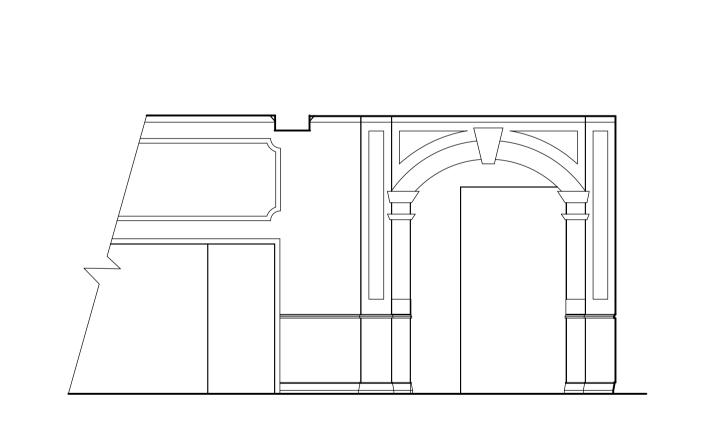

extg. 'later' solid

overbar removed.

New lightweight steel

in sections supported

and glass over bar

from counter top

back-fitting retained

extg. original door

retained fixed shut


Bar counter extended to match

original section, with new


pillasters, curved counter top

and 2No. new panels (faceted


SECTION R - AS EXISTING

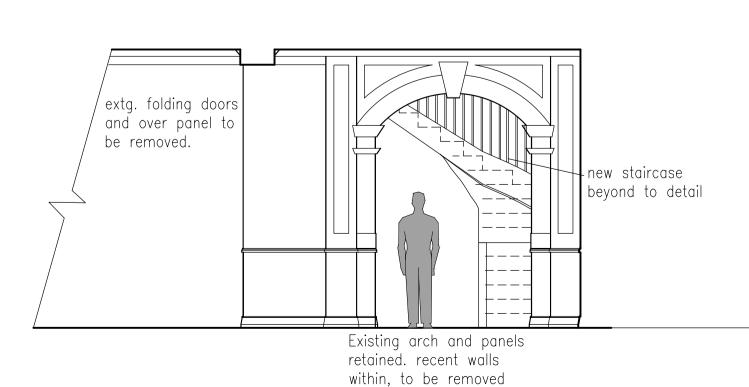

SECTION R - AS PROPOSED

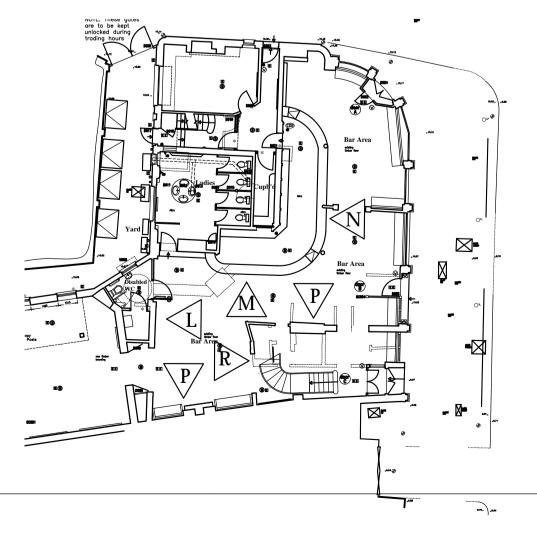

KEY PLAN

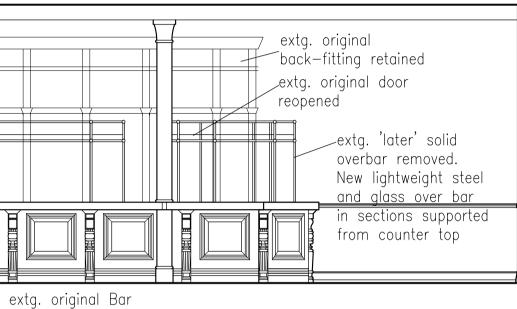

LAP

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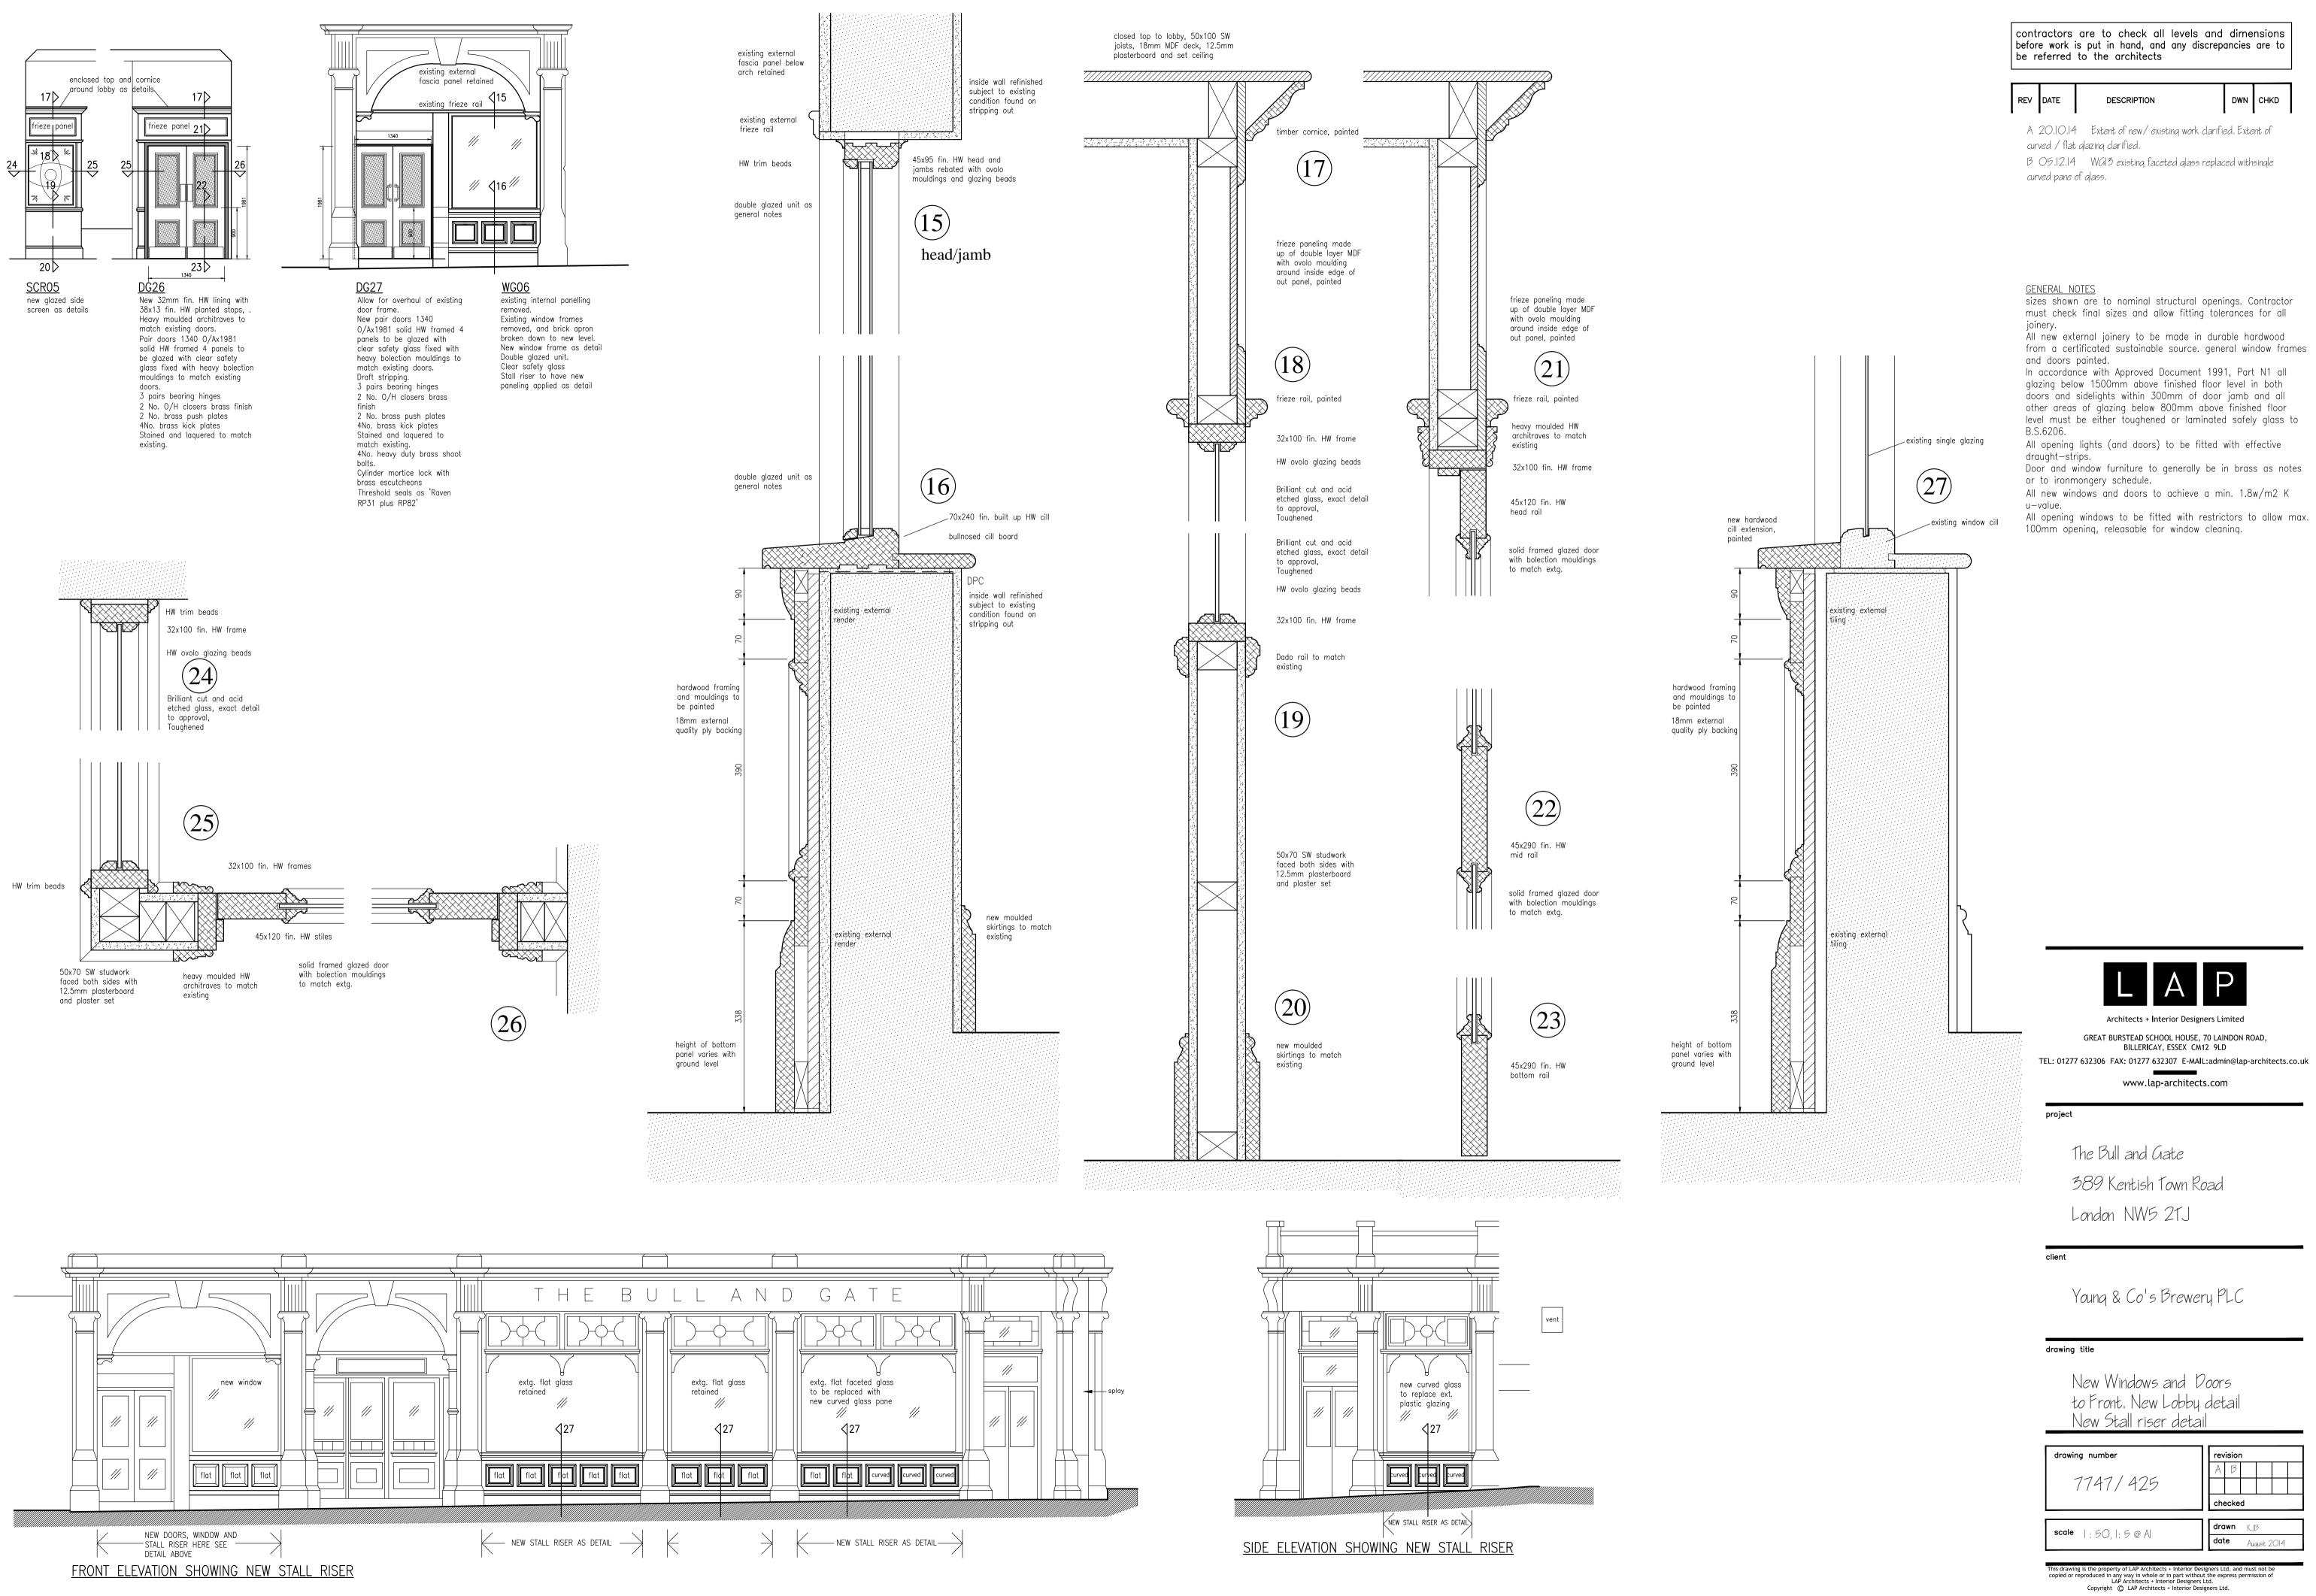
Young & Co's Brewery PLC


drawing title

Internal Bar Elevations As Existing and As Proposed


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	A B C
7747-417	
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scale 1:50 @ A	drawn KJB

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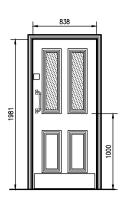


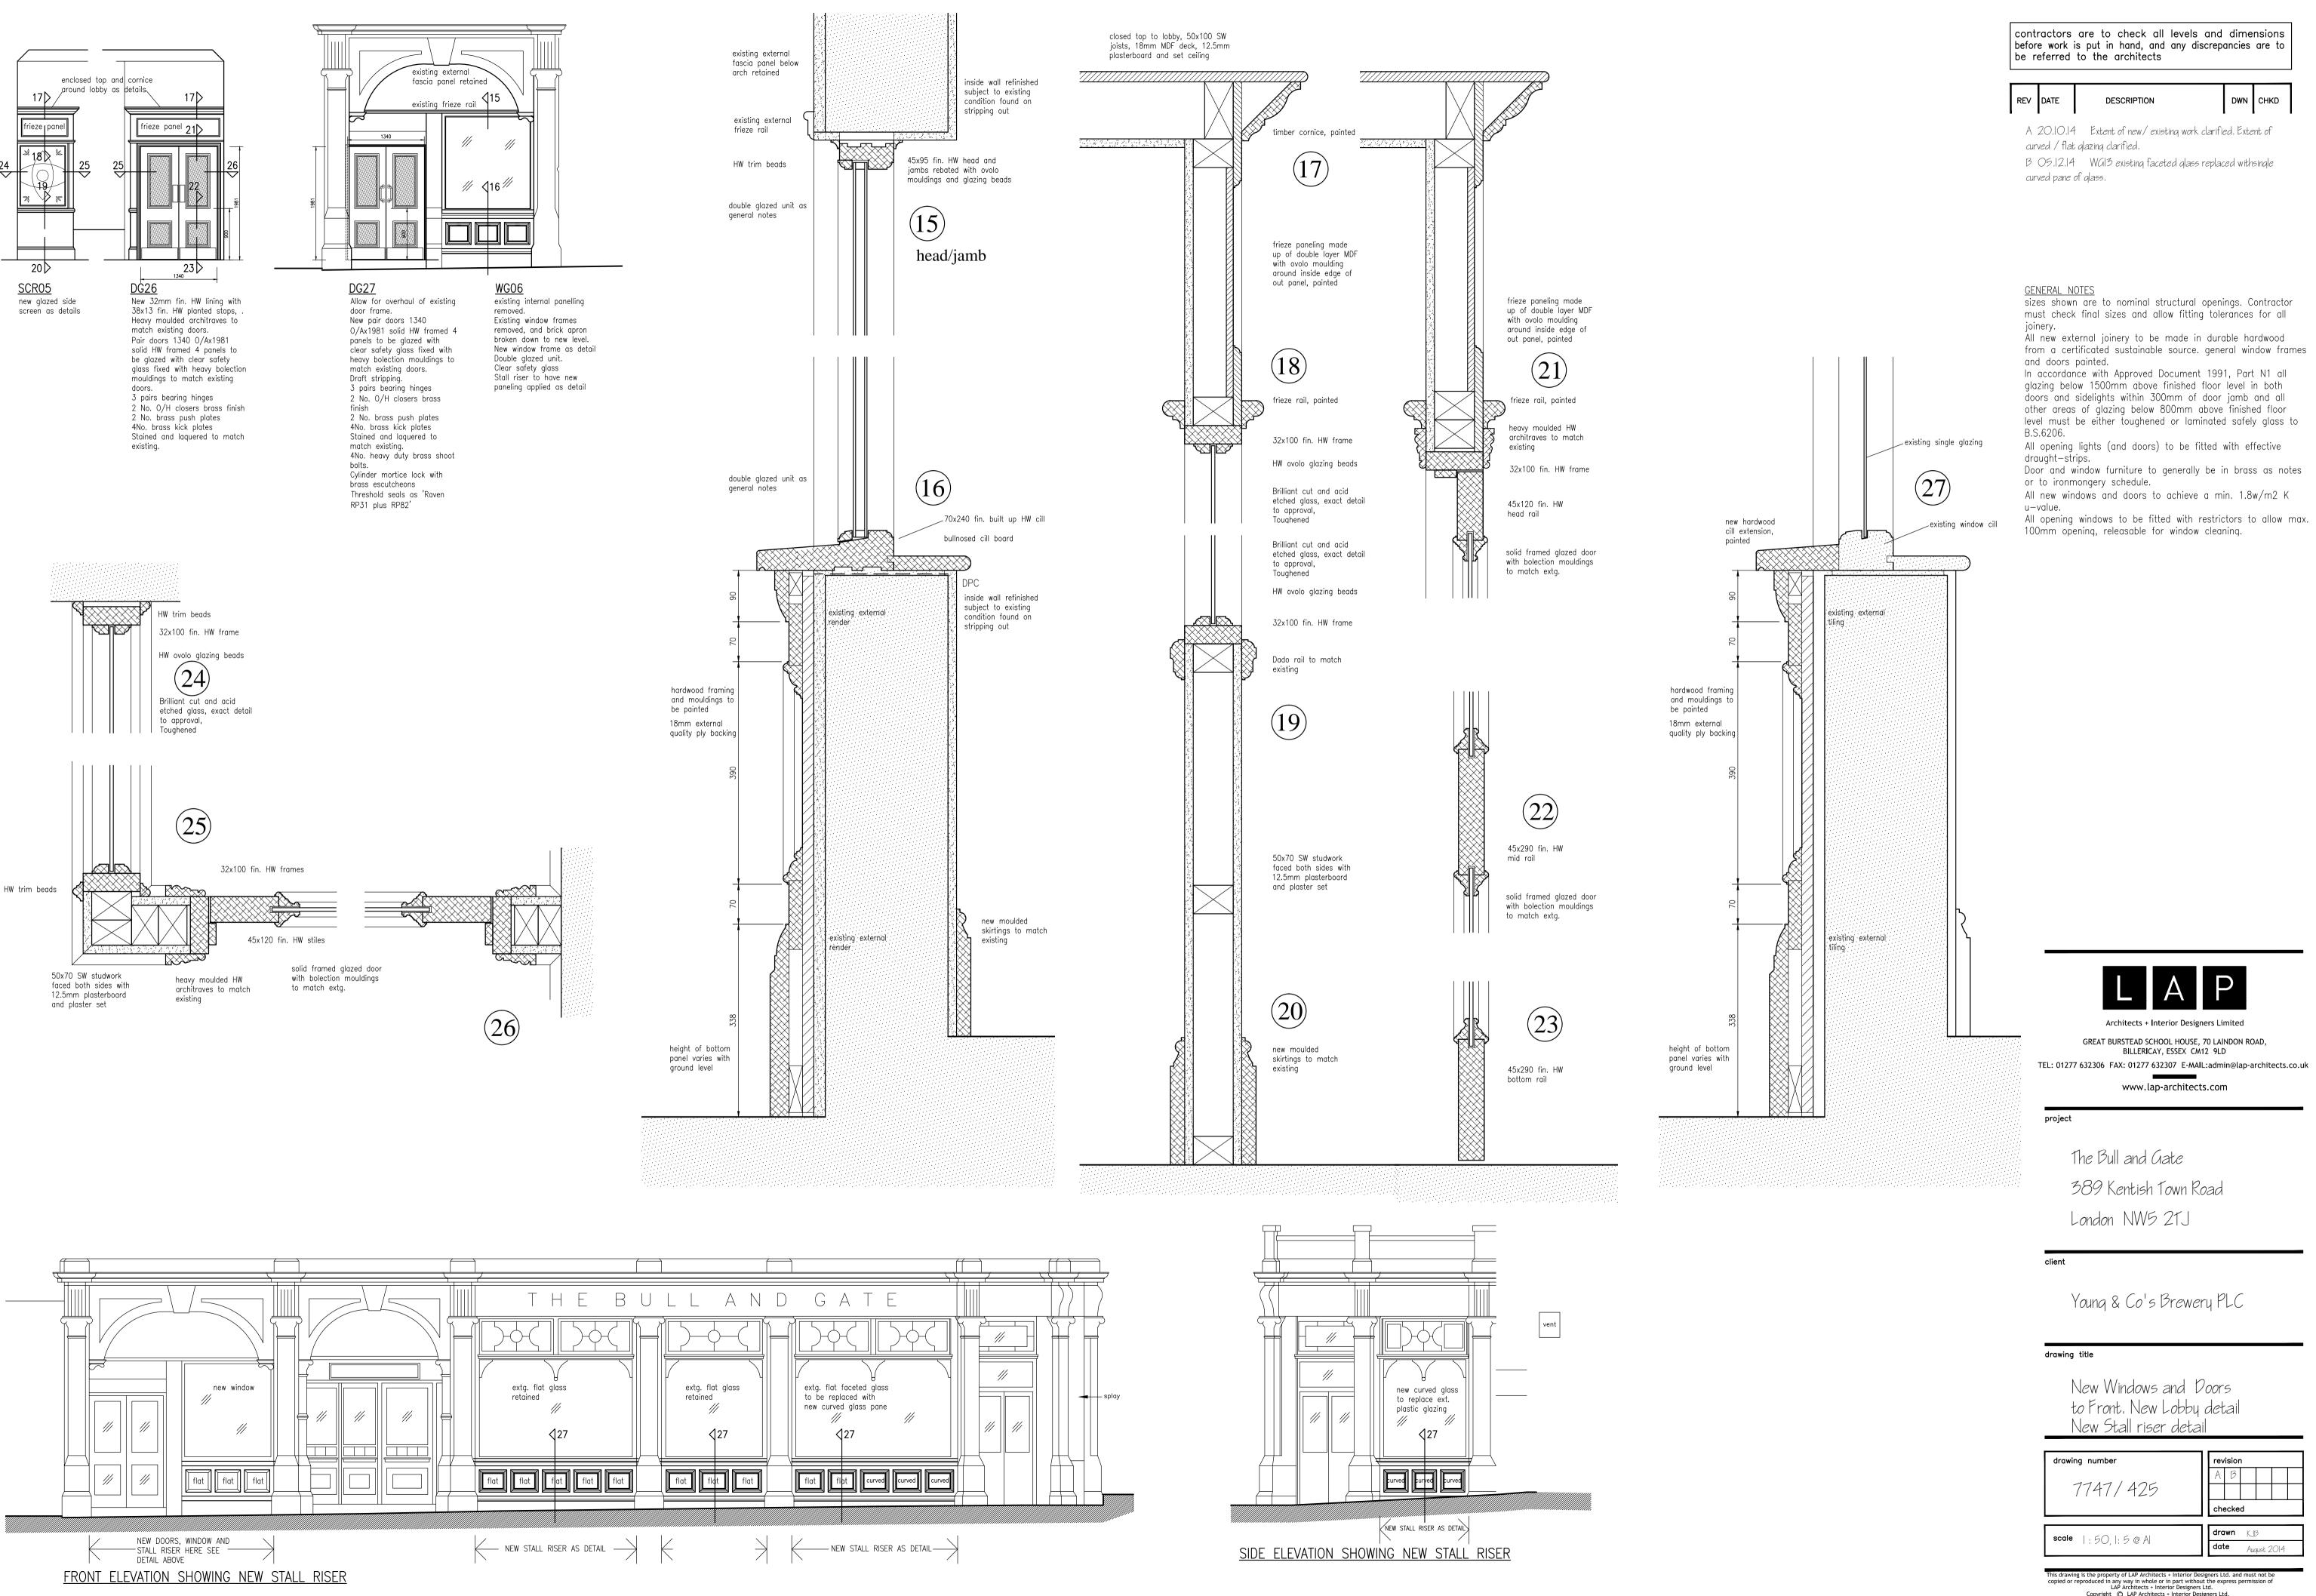

drawing number	revision				
	AB				
7747/425					
	checked				
scale  ;50,1;5@A	drawn KJB				
	date August 2014				

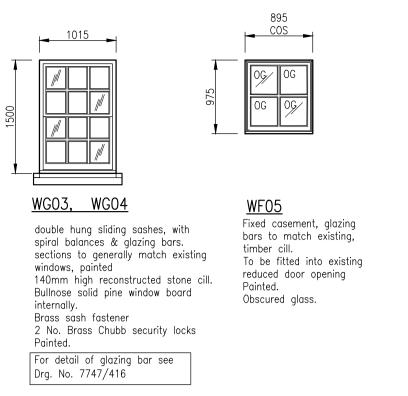

# Ground Floor New Windows



<u>DG02</u> New 32mm fin. SW lining with 38x25 fin. SW planted stops, intumescent strips and smoke seals. Heavy moulded architraves to match existing doors. 838x1981 solid framed, panelled FR30 door to match

existing doors. Top 2 panels to be glazed with clear 'Pyran' fixed with heavy bolection mouldings to match existing doors. 1.5 pairs bearing hinges 0/H closer brass finish brass push plate

SAA pull handle

shut' signs. Painted.

1No. brass kick plate brass/blue 'Fire door keep

# **Ground Floor Doors**

<u>DG03</u> Allow for new solid rebated frame with draft stripping. New pair solid framed external quality doors, rebated meeting edges 3 Pairs bearing butt hinges Set double panic bolts, brass finish. Painted.

check on site

ĪП

# 1265

# <u>DG04</u> New solid rebated frame

Cabin hook.

Painted.

with draft stripping. New solid cored FR30 838 wide main leaf with narrow side leaf, rebated meeting edges. 3 pairs bearing butt hinges. 2No. heavy shoot bolts and appropriate keeps. Cylinder mortice deadlock with thumb turn on inside.

<u>DG05</u> Retain existing panelled cupboard door. Provide and fit secure lock to

each door.

838

# <u>DF12,</u>

New 32mm fin. SW lining with 38x25 fin. SW planted stops, intumescent strips and smoke seals. Heavy moulded architraves to match existing 838x1981 solid framed and panelled FR30 door to match existing doors. 1.5 pairs bearing hinges 0/H closer brass push plate SAA pull handle Cylinder mortice deadlock with escape turn on inside, brass/SAA escutchions brass/blue 'Fire door keep shut' signs. Painted.

<u>DF11,</u> Omitted.

<u>DS01</u>

New 32mm fin. SW lining with

intumescent strips and smoke

seals. Heavy moulded architraves

762x1981 solid framed, panelled

FR30 door to match existing doors.

Cylinder mortice latch with escape

38x25 fin. SW planted stops,

to match existing doors.

1.5 pairs bearing hinges

'Fire door keep shut' signs

0/H closer


Painted.

túrn on inside.

<u>DF03, DF07, DF10,</u>

<u>DF02, DF14</u> Existing doors to be retained & generally

overhauled.

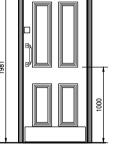

838

# <u>DF01, DF05,</u>

Painted.

New 32mm fin. SW lining with 38x25 fin. SW planted stops, intumescent strips and smoke seals. Heavy moulded architraves to match existing doors. 838x1981 solid framed, panelled FR30 door to match existing doors. 1.5 pairs bearing hinges 0/H closer brass push plate brass pull handle brass/blue 'Fire door keep shut' signs.

# <u>DF04</u>

Existing frame retained upgraded stops to FR30 Existing panelled door retained, to be upgraded to fire door using 'Envirograf Product 38' pack

<u>DS06</u>

<u>DS07</u>

Door to be reinstated & generally overhauled.

New 32mm fin. SW lining with

intumescent strips and smoke

seals. Heavy moulded architraves

838x1981 solid framed, panelled

FR30 door to match existing doors.

Cylinder mortice latch with escape

38x25 fin. SW planted stops,

to match existing doors.


1.5 pairs bearing hinges

'Fire door keep shut' signs.

0/H closer

Painted.


túrn on inside.

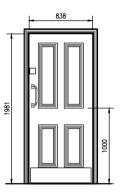

# <u>DF06</u>

New 32mm fin. HW lining with 38x13 fin. HW planted stops. Heavy moulded architraves to match existing doors. 838x1981 solid framed, panelled to match existing doors. 1.5 pairs bearing hinges O/H closer silver finish Polished St. St. pull handle Brass push plate 1No. brass kick plate 1No. Polished St. St. kick plate.


Painted

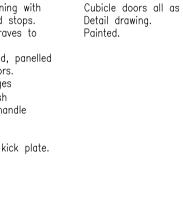


<u>DF08, DF09</u>



**First Floor Doors** 

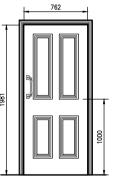


<u>DS02, DS04</u> New 32mm fin. HW lining with 38x13 fin. HW planted stops. Heavy moulded architraves to match existing doors. 762x1981 solid framed panelled door with recessed mouldings to match existing doors. Lever/latch set

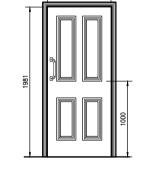

686

<u>DS05</u> New 32mm fin. HW lining with

38x13 fin. HW planted stops. Heavy moulded architraves to match existing doors. 686x1981 solid framed panelled door with recessed mouldings to match existing doors. Bathroom lever/latch set

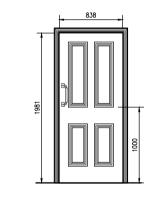


<u>DS08</u> New 32mm fin. HW lining with 38x13 fin. HW planted stops. Heavy moulded architraves to match existing doors. 838x1981 solid framed panelled door with recessed mouldings to match existing doors. Lever/latch set


new separating walls between bedrooms and


# <u>DS03, DS09 TO DS13</u> Existing doors to be retained & generally overhauled.

# Second Floor Doors

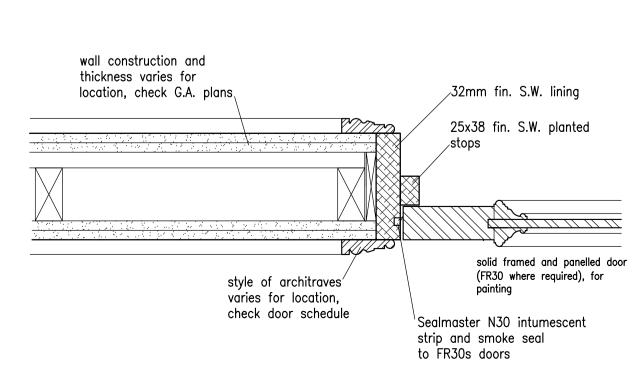

Typical Internal door lining

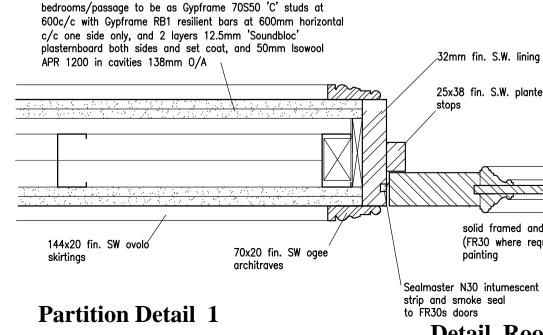


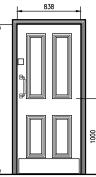




doors. 838x1981 solid framed, panelled FR30 door to match existing doors. 1.5 pairs bearing hinges 0/H closer SAA push plate

SAA pull handle 'Fire door keep shut' signs. Painted.

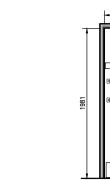

<u>DG07</u> New 32mm fin. HW lining with 38x13 fin. HW planted stops. Heavy moulded architraves to match existing doors. 915x1981 solid framed panelled door with recesses mouldings to match existing doors. 1.5 pairs bearing hinges RADAR lock brass finish internal pull bar as part of 'Doc M pack' Brass pull handle 2No. brass kick plates. Stained and laquered to match existing joinery.

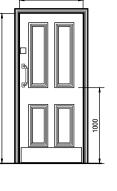

<u>DG08,</u> New 32mm fin. HW lining with 38x13 fin. HW planted stops. Heavy moulded architraves to match existing doors. 838x1981 solid framed panelled door with recessed mouldings to match existing doors. 1.5 pairs bearing hinges O/H closer silver finish Polished St. St. pull handle Brass push plate 1No. brass kick plate 1No. Polished St. St. kick plate. Stained and laquered to match existing joinery. Provide and fit secure lock to DG06 only.

<u>DG01, DG09, DG10</u> <u>DG11, DG16</u> Omitted

<u>DG12 to DG15</u> Cubicle doors all as Detail drawing. Painted. <u>DG17, DG22</u> Existing Door generally overhauled.

Allow for new cylinder mortice lock with thumb turn inside. Painted. <u>DG18</u> Existing original door to be retained. Understair cupboard to be cleared

out and door secured permanently shut to prevent storage below stair.

overhauled. Allow for upgrading to Fire Doors If not already. Allow for new O/H closers if required Painted. <u>DG21</u> Existing Doorway to be reopened. Existing construction to be checked on site. Allow for adapting existing frame and upgrading stops, rehang door on opposite side. Allow for New solid framed, panelled FR30 to match existing doors 1.5 pairs bearing butts. 0/H closer Brass push plate Brass pull handle 2No. brass kick plates Mortice cylinder deadlock with thumb turn on bar side, brass escutcheons

<u>DG19, DG20</u>

Existing Doors generally

DG23, DG24, DG25 Existing doors to be retained and generally overhauled.

<u>DG26, DG27</u> New Lobby doors see drawing No. 7747/425

<u>DG28</u> Existing double doors to be re-glazed & held open.


<u>DF13</u>

<u>DF15</u> Omitted.

All existing retained and refurbished. Door to have panels infilled on Store side To bring up to FR30 as with 6mm masterboard fixed in accordance with 'Promat' detail. To be fixed shut and sealed.

NOTE: ALL DOORS TO NOW BE SOLID FRAMED AND PANELLED (NOT FLUSH WITH PLANTED MOULDINGS)

Architrave

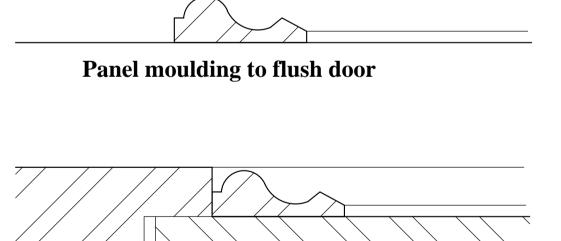

Full size mouldings

Panel moulding to framed door

25x38 fin. S.W. planted stops solid framed and panelled door

(FR30 where required), for painting Sealmaster N30 intumescent strip and smoke seal

**Detail Room Door** 

Typical Internal partition details to domestic accommodation

and set coat, and 25mm Isowool APR 1200 in caviy. Miniumum cavity width to be 35mm existing brick/block wall 144x20 fin. SW ovolo to be checked on site. skirtinas

Separating walls between bedrooms and bedrooms/passage


upgraded with GypLiner Universal bars at 600mm verticall c/c

one side only, and 2 layers 12.5mm 'Soundbloc' plasternboard

In locations where wall found to be existing studwork, treat as Detail 1 by adding resiliant **Partition Detail 2** bars and double SoundBloc to one side and adding extra layer of SoundBloc other side





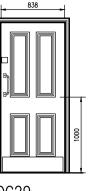

# <u>DG29</u>

New 32mm fin. SW lining with 38x25 fin. SW planted stops, intumescent strips and smoke seals. Heavy moulded architraves to match existing doors. 838x1981 solid framed, panelled FR30 to match existing doors. 1.5 pairs bearing hinges 0/H closer Cylinder mortice latch with escape turn on inside.

'Fire door keep shut' signs. Painted.

contractors are to check all levels and dimensions before work is put in hand, and any discrepancies are to be referred to the architects

# REV DATE DESCRIPTION

A 24,09,13 Doors generally updated, Partition details added B 09,10,13 Doors updated to accord with amendments to the floor plans. C 22.10.13 Doors updated to accord with amendments to the floor plans. D 21.08.14 Generally updated

DWN CHKD

E 20.10.14 DFOI lobby door now retain, renewed.

F 05.12.14 Windows WGO3, 04, 05 now with full panes, glazing bars omitted. All panelled doors now to be solid framed and panelled

(not planted mouldings), DFO5 to be existing panelled door retained and upgraded with intumescent material. DIS omitted

G 22-12-2014 New Ground Floor windows WG03, 04, 05 reinstated as 'all glazing bar' Door references DF04 and 05 corrected (previously around the wrong way)

# <u>GENERAL NOTES</u>

sizes shown are to nominal structural openings. Contractor must check final sizes and allow fitting tolerances for all

All new external joinery to be made in durable hardwood from a certificated sustainable source, general window frames and doors painted.

In accordance with Approved Document 1991, Part N1 all glazing below 1500mm above finished floor level in both doors and sidelights within 300mm of door jamb and all other areas of glazing below 800mm above finished floor level must be either toughened or laminated safely glass to B.S.6206.

All opening lights (and doors) to be fitted with effective draught-strips.

Door and window furniture to generally be in brass as notes or to ironmongery schedule. All new windows and doors to achieve a min. 1.8w/m2 K

u-value. All opening windows to be fitted with restrictors to allow max. 100mm opening, releasable for window cleaning



Architects + Interior Designers Limited

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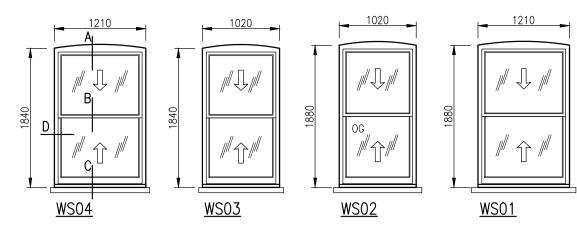
# Young & Co's Brewery PLC

# drawing title

Windows and Doors Schedule Elevations and Details

drawing number 7747/416	revision			
scale  ;50,1;5@A	drawn KJB date April 2013			

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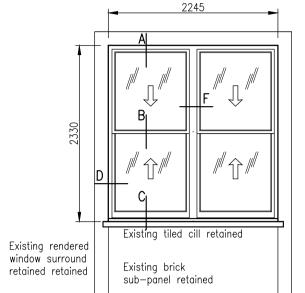



Existing UPVC windows removed.

Existing Stone cills retained, to be further inspected once windows removed. (previous remedial works carried out with lead capping) New Double hung sliding sash window, double glazed units, with spiral

balances as details, painted.

Trickle vents to heads of these windows. SECOND FLOOR WINDOWS



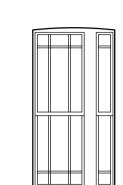

<u>WF05</u>


<u>WG09</u>

Existing external security bars removed. Existing original window retained, single

glazed, repaired to bottom of central

mullion, stripped and repainted

existing rendered infill to bottom of window to be removed

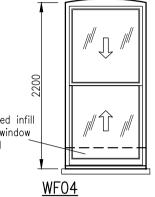



1066

Existing UPVC windows removed.

Existing Stone cills retained, to be further inspected once windows

removed. (previous remedial works carried out with lead capping) New Double hung sliding sash window, double glazed units, with spiral balances as details, painted

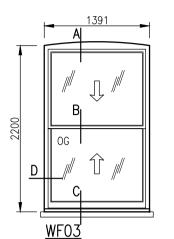

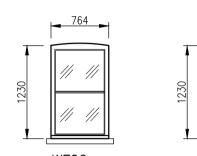


<u>WF02</u> Existing external steel security bars removed. Existing UPVC windows removed. Existing Stone cills retained, to be further inspected once windows removed. New fixed light window to match casement window details, double glazed units, painted

<u>WF04</u>

Existing UPVC window removed. Existing tiled cill retained. New Double hung sliding sash window, double glazed units, with spiral balances as details, painted


# FIRST FLOOR WINDOWS

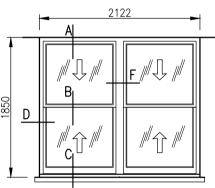

<u>WG10</u>


Existing external security bars removed. Existing UPVC window removed. Existing tiled cill retained.

New Double hung sliding sash window, double glazed units, with spiral balances as details, painted

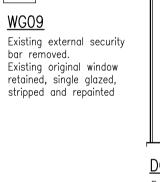

<u>WG08</u> Existing external security bars removed. Existing original window retained. Top panel removed and top sash reinstated as original. Single glazing to be

replaced with new obscured glass. Stripped and repainted

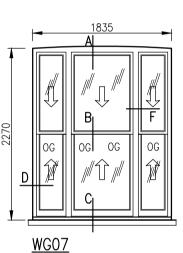


# Existing external security bars removed. Existing recent timber window removed. Existing stone cill retained. New Double hung sliding sash window, double glazed units, with spiral balances

as details, painted. Obscured glass to lower panes.


GROUND FLOOR WINDOWS

REPLACEMENT WINDOWS TO REAR ELEVATION New timber window sections to be as Mumford and Wood Conservation Spring sash range complete with DGU's and full draught stripping OR similar alternative subject to full approval.

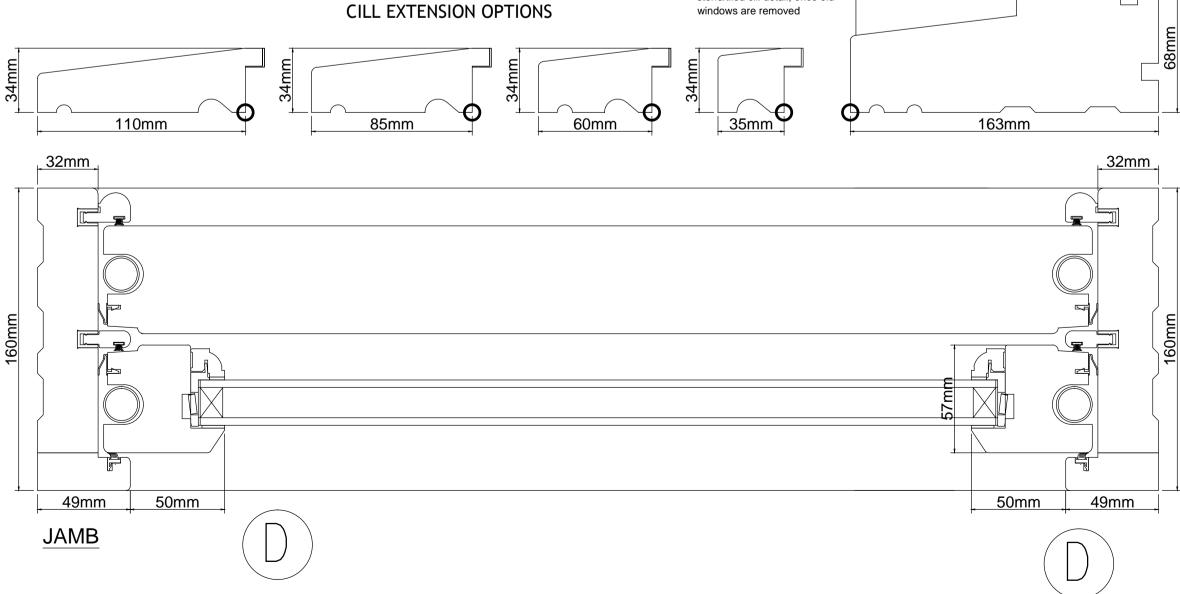

SECTIONS TAKEN FROM MUMFORD AND WOOD LTD. CONSERVATION SPRING SASH WINDOW HEAD, CILL, JAMB & TRICKLE VENT OPTIONS U.K. PATENT GB2297344B & GB2283269B

**-** . .

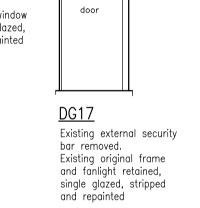

<u>GENERAL NOTES</u>

sizes shown are to nominal structural openings. Contractor must check final sizes and allow fitting tolerances for all joinery.

All new external joinery to be made in durable hardwood from a certificated sustainable source. general window frames and doors painted.


In accordance with Approved Document 1991, Part N1 all glazing below 1500mm above finished floor level in both doors and sidelights within 300mm of door jamb and all other areas of glazing below 800mm above finished floor level must be either toughened or laminated safely glass to

B.S.6206. All opening lights (and doors) to be fitted with effective draught-strips.


Door and window furniture to generally be in brass as notes or to ironmongery schedule.


All new windows and doors to achieve a min. 1.8w/m2 K u-value.

All opening windows to be fitted with restrictors to allow max. 100mm opening, releasable for window cleaning.

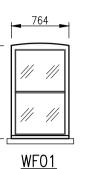

allow for extended head rail where existing brick arched 160mm ٩b TRICKLE VENT CANOPY Note. Trickle vents only on 2nd floor domestic accommodation rooms 57mm В NOTE. Projection of cill to be determined from existing stone/tiled cill detail, once old windows are removed

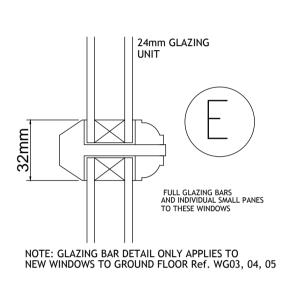

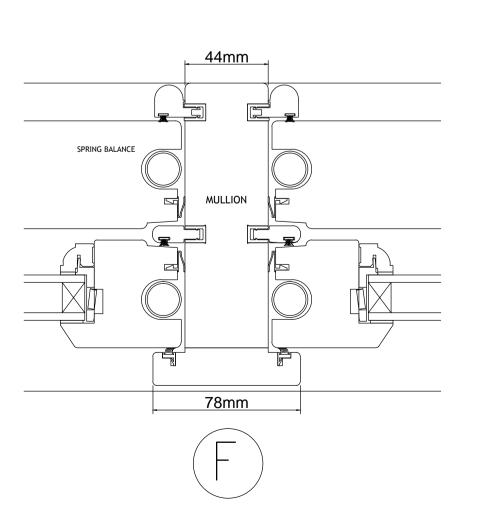

cor bef be	contractors are to check all levels and dimensions before work is put in hand, and any discrepancies are to be referred to the architects						
REV	DATE	DESCRIPTION	DWN	СНКД			
	05.12.14 azing bars c	New windows now to be full pane do. mitted.	ıble qlaz	ed units,			

B 22.12.14 Glazing bar detail added back for Ground Floor windows WGO3, 04, 05



Architects + Interior Designers Limited GREAT BURSTEAD SCHOOL HOUSE, 70 LAINDON ROAD, BILLERICAY, ESSEX CM12 9LD TEL: 01277 632306 FAX: 01277 632307 E-MAIL:admin@lap-architects.co.uk www.lap-architects.com

project

The Bull and Gate 389 Kentish Town Road London NW5 2TJ

client

Young & Co's Brewery PLC

# drawing title

Windows and Doors Replacement windows to Rear Elevation

drawing number	revision
	ЖВ
7747/426	
	checked
	_
scale  ;50,1;2@A	drawn KJB
1, 70, 1, 2 € / 1	date Aug 2014

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DATE	DESCRIPTION	DWN	СНКС
25-09-2012	GENERALLY UPDATED	•	
21-10-2013	Updated to match 1:50 layouts		
24-10-2013	Upcated to match 1:50 layouts		
ing with curve	ed glass. Replacing UPVC windows	tic I	
	Kitchen extract system shown t	0	
	Toilet basins revised		
30-10-2014	Kitchen layout and drainage rev	ised	
	21-10-2013 24-10-2013 29-10-2013 ing with curvi timber soshe 18-11-2013 roof 27-08-2014 20-10-2014 ting foceted, stated.	24-10-2013 Upoated to match 1:50 Isports 29-10-2013 Notes added, re. replacing place Imper scales, dass Replacing UVC endows Imper scales, New stall rises. 18-11-2013 Kitchen extact system shown t rol 27-08-2014 Toilet basins revised 20-10-2014 Window WG13 confirmed as ting facetad, to be retained Door DF01 tated.	21-10-2013 Updated to match 1:50 loyouts 24-10-2013 Updated to match 1:50 loyouts 29-10-2013 Notes added, re. replacing plattic inner soshes. New stall rises. 18-11-2013 Kichen extract system shown to roof 27-08-2014 Tolet basins revised 20-10-2014 Window W013 confirmed as ing faceted, to be refored Door DF01



GREAT BURSTEAD SCHOOL HOUSE, 70 LANNON ROAD, BILLERICAY, ESSEX CM12 9LD TEL: 01277 632306 FAX: 01277 632307 E-WALL:admin@lap-architects.co.uk www.lap-architects.com

project

- The Bull and Gate
- 389 Kentish Town Road London, NW5 2TJ

client

Young & Co's Brewery PLC

drawing title

Proposed Floor Plans General Arrangement All Floors

drawing number	revi	revision				
	A	В	С	D	٤	F
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# FIRE DOORS

# - FR30s fire door \*

\*\* - FR60s fire door To be fitted with 25x38 fin. stops, intumescent strips and cold smoke seals to resist the passage of smoke and fire.

To be fitted with overhead door self closers. M - magnetic hold-open, linked to Fire alarm

Note. If Magnetic door locks used they must be linked to fire alarm system, so that if Fire alarm is activated or there is a power failure, doors will be released. (P) - vision panel in door

All doors to have 100mm wall to hinge side unless otherwise stated, and 300mm to leading edge to allow easy opening for wheelchair users

> NOTE:--All Fire doors should have either a Fire door Keep shut" Sign or "Fire Door Keep Locked" sign.

# FIRE SAFETY KEY

S OPTICAL SMOKE DETECTOR AND SOUNDER COMBINED OPTICAL HEAT DETECTOR AND
SOUNDER COMBINED E EMERGENCY LIGHT non-maintained OE Denotes decorative fitting with emergency light pack EE ILLUMINATED EXIT SIGN maintained

ALARM CALL POINT

PROVIDE SMOKE DETECTOR TO ALL ROOF VOIDS FIRE ALARM SYSTEM TO B.S 5839 pt 1 EMERGENCY LIGHTS TO B.S 5266 pt 1 ILLUMINATED EXIT SIGNS TO B.S 5499 pt 4

(W) 9 litre water extinguisher to B.S EN3 (F) 9 litre foom extinguisher to B.S EN3 (CD2) 2Kg CO2 extinguisher to B.S EN3

(FB) Fire blanket

SBIG 42mm stub

xisting deretic

buildings

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4

D. C.C.

IN TH

new covity woll

existing derelict

lean-to building

-

OT 2500

, 10.39

adjacent lar

construction

new extension bui

E

11

WG02 trop

altro floor

DG01

(F)

coved skirtings &

welded joints

SVP to go to level above svp to go to level above svp to go to come

-111

existing derelict out-buildings cent and new extension

0

THIN

extq. woll

partly rebuilt

WGON

inish with

Kitchen

(CDS)

T

~

E

on built

# GENERAL NOTES

GENERAL INJES New Foors 75mm S/C screed with chicken wire or fore reinforcement on 1000g, polythere vopour borrier on 75mm Knappon K3' insulation with 25mm upstands oil round, on 12000, DM on in-sult borg Accreatevy if in-sults soft, pocci insulation between the with 25mm upstands all round, on 12000, DM on sold binding on horacine (cs. SE speec) 1000g, vopour borrier loyed over insulation before slob is loyed. More for loging DM with DEC on all sides, subject to establishing nature and position of existing DPC's wire DAT pools

establishing nature and position of existing DPC's NEW FLAT ROOFS Infigit performance tarch applied built-up roofing as Derbigum 'er similar appared on Jamm Kington insultation boods (BOmm TR27 + Bomm Kill) and Infigure and a state of the state of the booded for roofing on Jamm est, coult ply deck on SM firings to give min. 150 fails on timber josts to Struct Eng's details. Johann could be used to all sides and code 4 lead flashings cut into wells

existing rear party wall retained,

new independant wall built inside

SBIG 42mm stub

Party Wall agreements.

o Structural Engineers details and

SANITARY PIPEWORK All waste fittings to have 75mm deep seal traps and All wattle fittings to have "Jomm deep sed traps and separate connections to supplications and to be installed in accordinger with BSS512. Wattes to wath-hand beains to be 32mm diameter for runs up to 30m. Wattes to unionate to the 40mm dia. and combined watte S4mm dia. All watte pipes to have rooding access at all changes in direction. changes in direction. Where necessary, pipes and hot water storage vessels are to be thermally insulated to comply with Approved Document L1, Section 3. All exposed pipework to be baxed in.

SOL AND VOIT PIPES AND BOXINGS SVP's to be in 100mm dometer UPXC. Waste stocks, to BS 5527 Stocis noted on AVV to be terminate with automatic or admittance valve above level of highest filling. Stock noted as SVP to vertilate above noot. Sol pipes to be tored in

Soil pipes to be tored in **BELOW GROUND DRANGE** Moin layout shown board on ovaloble site information. Subject to full drainage to be traced back. All drain runs, SVP's waste pipes, guiles not required in new scheme but not specifically shown on plan ore is to be taking of no backfield. Any wastes connections sill required in new scheme but not peerfordly shown on plan ore is be retained and the to be taken on plan ore is be retained and the performed planet of the Skill 1985. Theside pint to be provided within 150mm of wares ppeerof inters builing or connection with a connet, woll or any other structure. Bed and surround in accordance with the full conters instructions. Monholes to be type or precast concrete or closs 3 engineering brick as drainage layout with Class Alts, B125 or D400 covers and firmers to BSEN 124. Internal covers cre to be doube sed screw down, recessed for floor finithmes.

() E - 150

O

DG02 \*

S

E

over to be

refurbished

existing roof lights

ES

0

10.08

form new 2.4m wide

pening

detail

etdined,

Coffee stati


RAIN WATER COODS External RWP and gutter to glazed roof to black UPVC half award. Ranairs/ replacements to existing to be cast half round. Repairs/ replace iron to match existing.

# COLOURS In general decorations should be contried out in contrasting colours e.g. Door architores to contrast with wall. Door functions to contrast with wall. Door functions to contrast with avail Colour variation to be greater than 30 point. Exact details to be confirmed.

METRALS MATERNES All materials should comply with appropriate British Standards or Agreement Certificates and suppliers documents soved as evidence for inclusion in completion

Thes. All materials should generally be in accordance with BSB000 series documents and other accepted good proctice (e.g., Ouality assured to ISO 5000) Test certificates for Inturescent materials, Electrical isolationian, Emergeny 1984; Free Airoms, will be required on completion prior to final Building Regulation certificate being issued. Sea Condens and reception class 0 e.a. this, deconduce counting on balart / falaterinoand

e.g. thin decor beckground. ative coverings on plaster/plasterboard

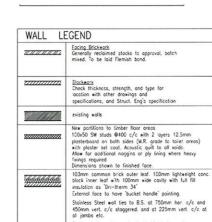

Provide new combined drain through new Manholes 1, 2, 3 to existing Manhole C as shown on drainage survey. Allow for new tamped concrete finish to alleyway upon completion of drainage.

FWWH

N EE

door

lobby removed

polished concrete

Dining

Area

70 covers

floor finish. new imber boarding

Steel / glass

pivot/sliding door panels

10 15

t

WO

Picstered internally, or dry lined. All window and door reveals to have insulcted cavity closer as 'Thermabate' or similar.

windows formed

in existing wall

T===

461

ES

refurbished

ES


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sto

WG03 \*


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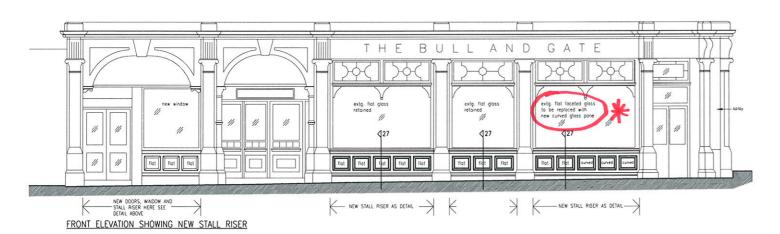
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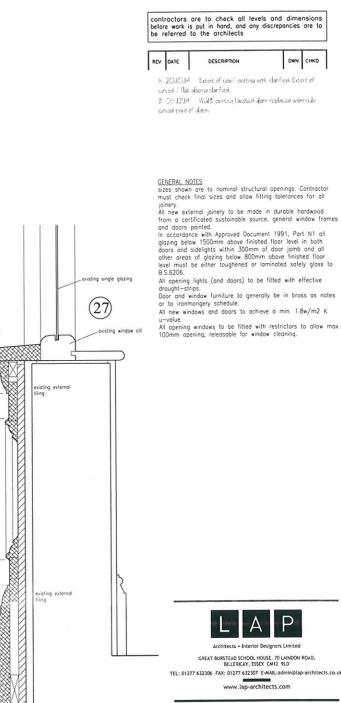
# A/C uhit in cosing to

# **GROUND FLOOR PLAN AS PROPOSED**



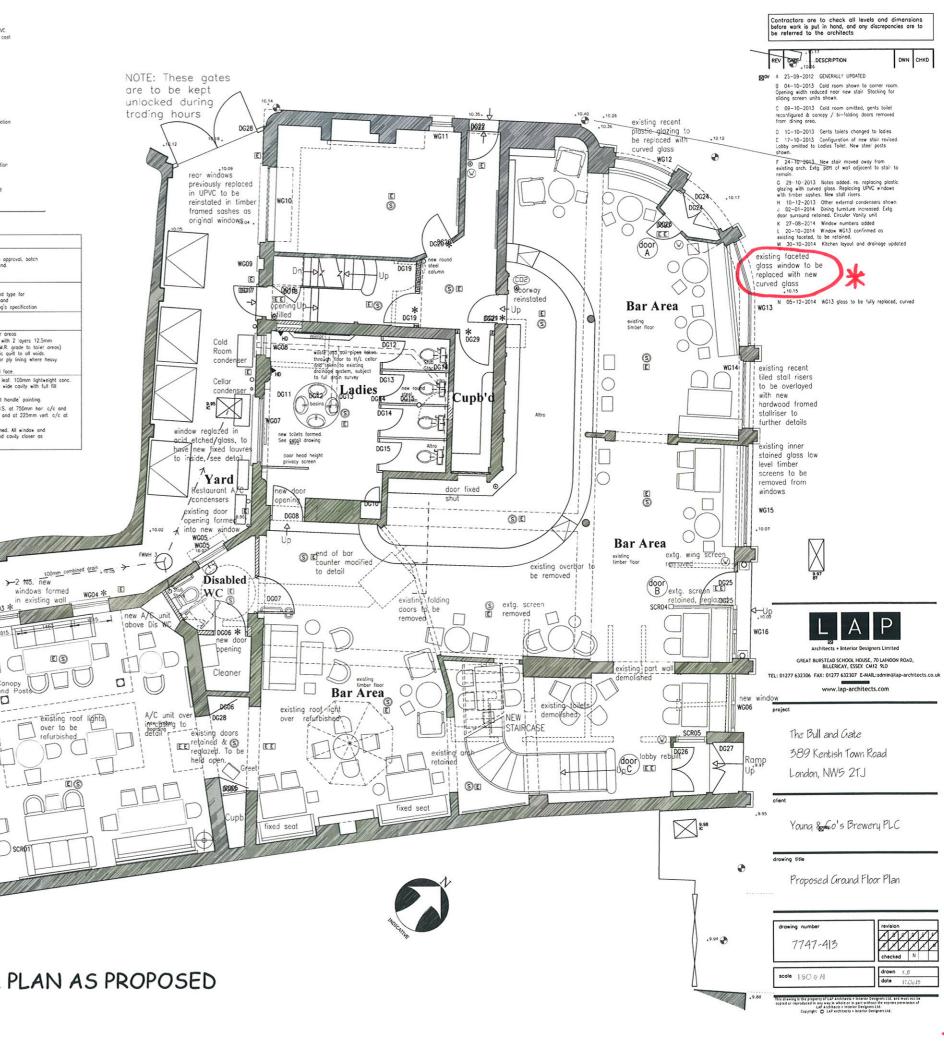



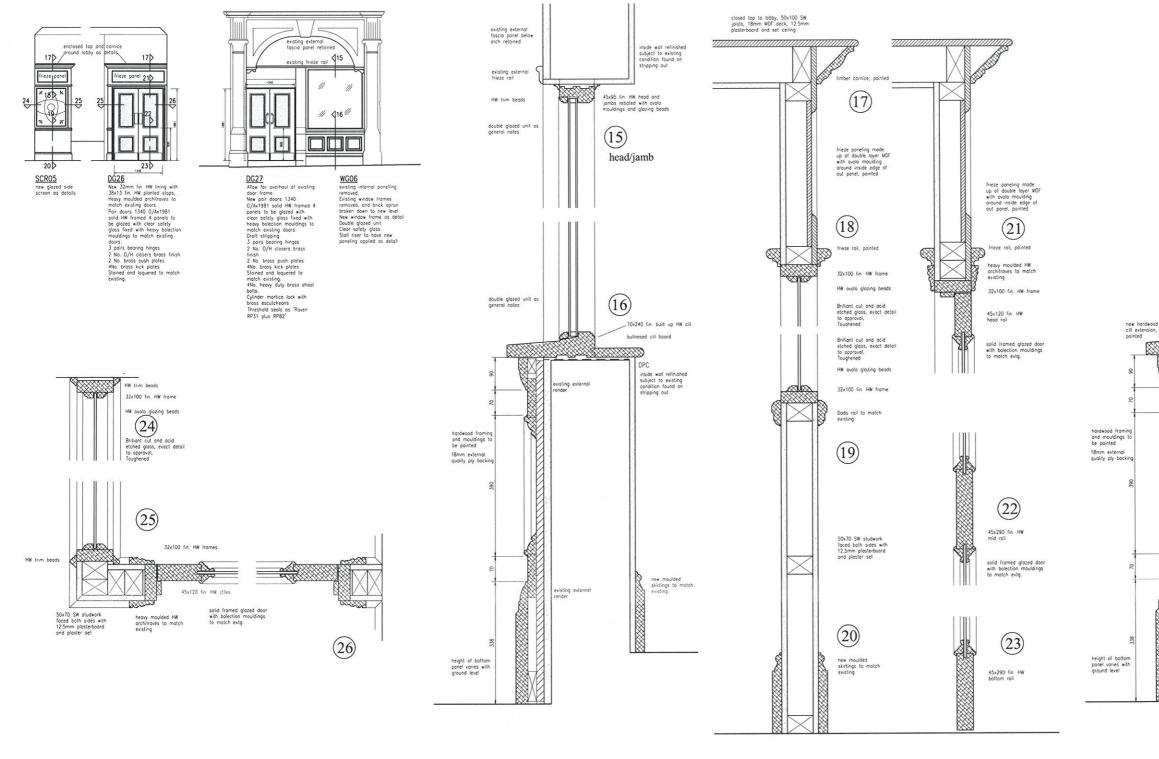

# project

The Bull and Gate 389 Kentish Town Road London NW5 2TJ

client

Young & Co's Brewery PLC

# drawing title

New Windows and Doors to Front. New Lobby detail New Stall riser detail

drowing number	revision
7747/425	AB
	checked
scole  :50,1:58A	drown K.B
	dote Auget 2014

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