



- Brick type used throughout building textured clinker brick, engobe/coal fired. Bond random. Colour brown/purple variegated brick with a degree of patterning within each brick. Mortar flush pointed, colour to be determined after review of sample boards
- Ground and first floor horizontal ribbed texture
- Stair cores and lift over runs/roof access elements expressed with
- Vertical stretcher bond to window heads
- Lower roof terrace walls pattern formed from absent headers
- Glazed brick band to base of building. Bond random. Colour dark green
- Cantilevered reconstitueed stone canopy with recessed lighting to communal entances, polished finish. Colour - light grey
- Cantilevered reconstitued stone canopy with recessed lighting to maisonette (16) entances, polished finish. Colour - light grey

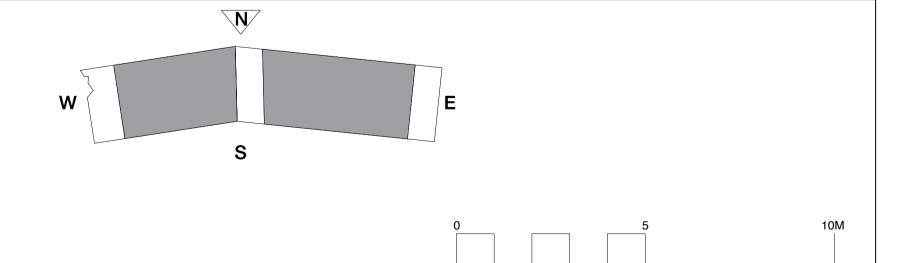
Reconstitueed stone balcony ledge, polished finish. Colour - light grey

- Reconstitueed stone window base, forming recessed seat, polished finish.
- Colour light grey Reconstitueed stone banding, polished finish. Colour - light grey
- Reconstituted stone banding to balcony, polished finish. Colour light grey
- Concrete upstand to ground floor screens
- Clear glazed communal entrance door, with full hight glazed window above. Door set to be PAS 24 Approved. Colour - light bronze/gold

High quality lighting to communal entrance areas

- Slip resistant decorative tile, pattern A to communal entrance floor and walls. Tile pattern extends to extent of overhead canopy externally Suspended stainless steel soffit with mirrored finish to communal entrance lobby ceiling
- Slip resistant decorative tile, pattern B to maisonette entrance threshold. Tile pattern extends to extent of overhead canopy externally
- Refuse door perforated anodised aluminium. Colour light
- Solid core private entrance door, with clear glazed side light. Door set to be PAS 24 Approved. Colour TBC
- Clear glazed communal entrance door to garden, with clear glazed side panel. Door set to be PAS 24 Approved. Colour light bronze/gold Clear glazed window with solid side opening to match frame. Frame and opening side panel - anodised aluminium. Colour - light bronze/gold
- Clear glazed balcony door. Frame anodised aluminium. Colour light bronze/gold
- Window frame set behind brickwork reveal, minimum set back 225mm
- Polyester powder coated steel section ballustrade. Colour light bronze/gold to match window frames. Random ballustrade spacing Polyester powder coated steel section ballustrade. Colour - light bronze/gold to
- match window frames. Consistent ballustrade spacing Full height anodised perforated aluminium panels, with a square channel profile. Panels to be fixed at ends. Middle sections may be movable,
- Anodised aluminium perforated acoustic attenuation panel. Colour light bronze/gold

subject to detailed solar shading analysis



Revisions

24.02.14

Green roofs added to part of terraces Boundary condition to Agar Childrens centre shown

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Scale 1:100@A1 February 2014

Drawn by Checked by EC / PK Job Number Status

Planning

HB1423

Agar Grove Estate Regeneration

Drawing Plot A North Elevation

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60 Bastwick Street mail@ London EC1V 3TN hawkinsbrown.com 020 7336 8030t 020 7336 8851f

Drawing No. & Revision

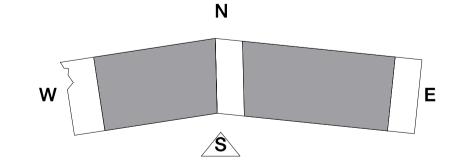
1423_DWG_PL_A_00_250_A

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- Anodised aluminium perforated acoustic attenuation panel. Colour light bronze/gold



Revisions	
1 10 11310113	

Green roofs added to part of terraces

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Scale 1:100 (200) February 2014

Status

Drawn by Checked by EC/PK EC/PK

Job Number

HB1423

Planning

Project Agar Grove Estate Regeneration

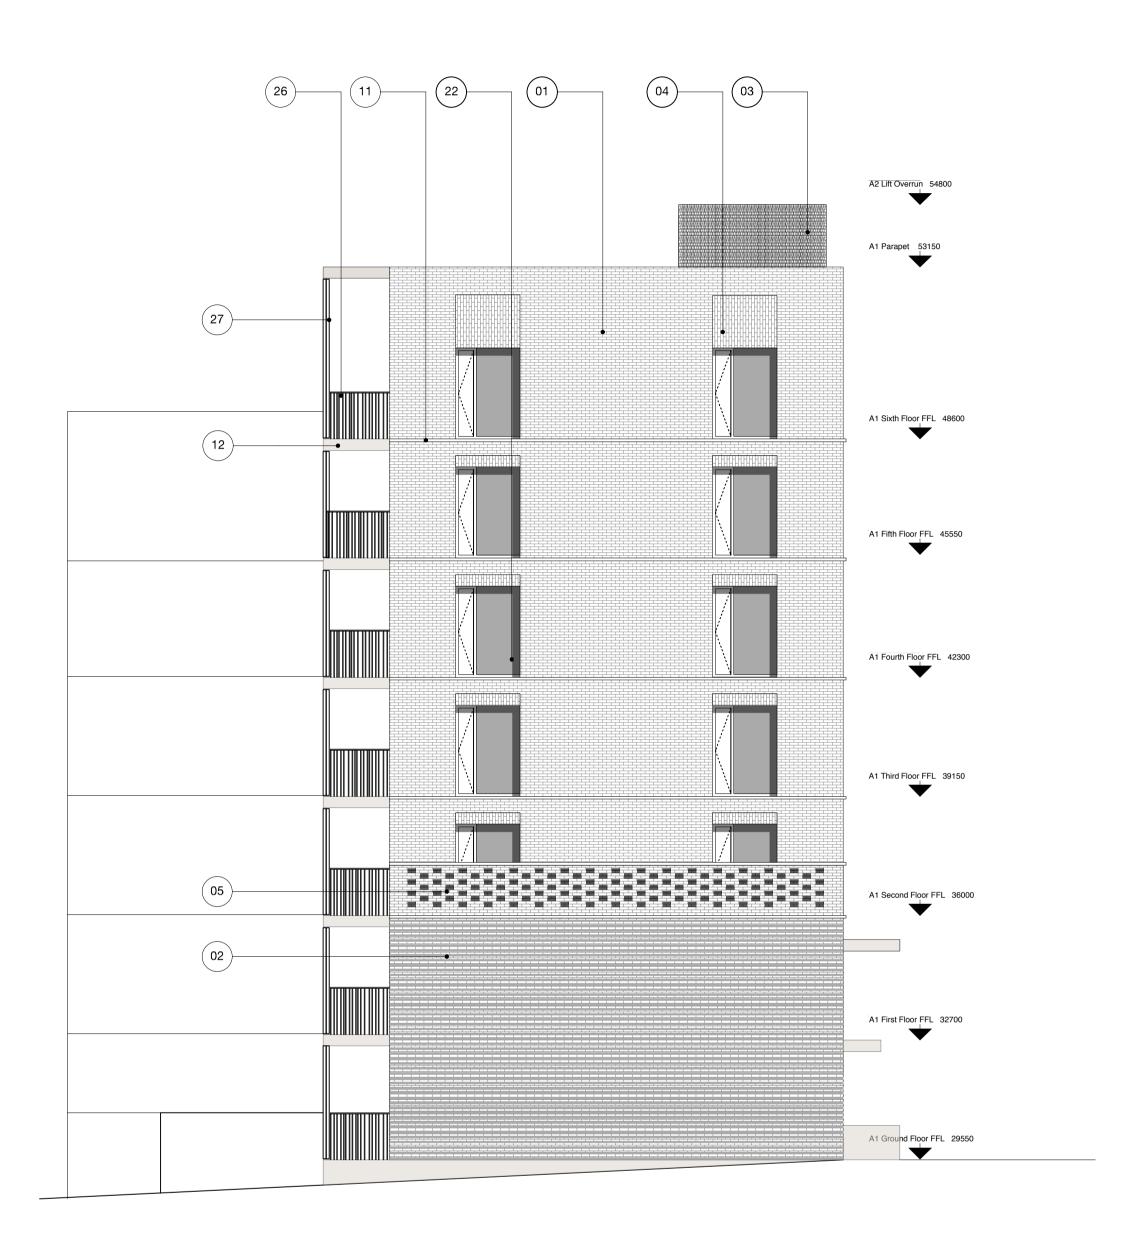
Drawing Plot A South Elevation

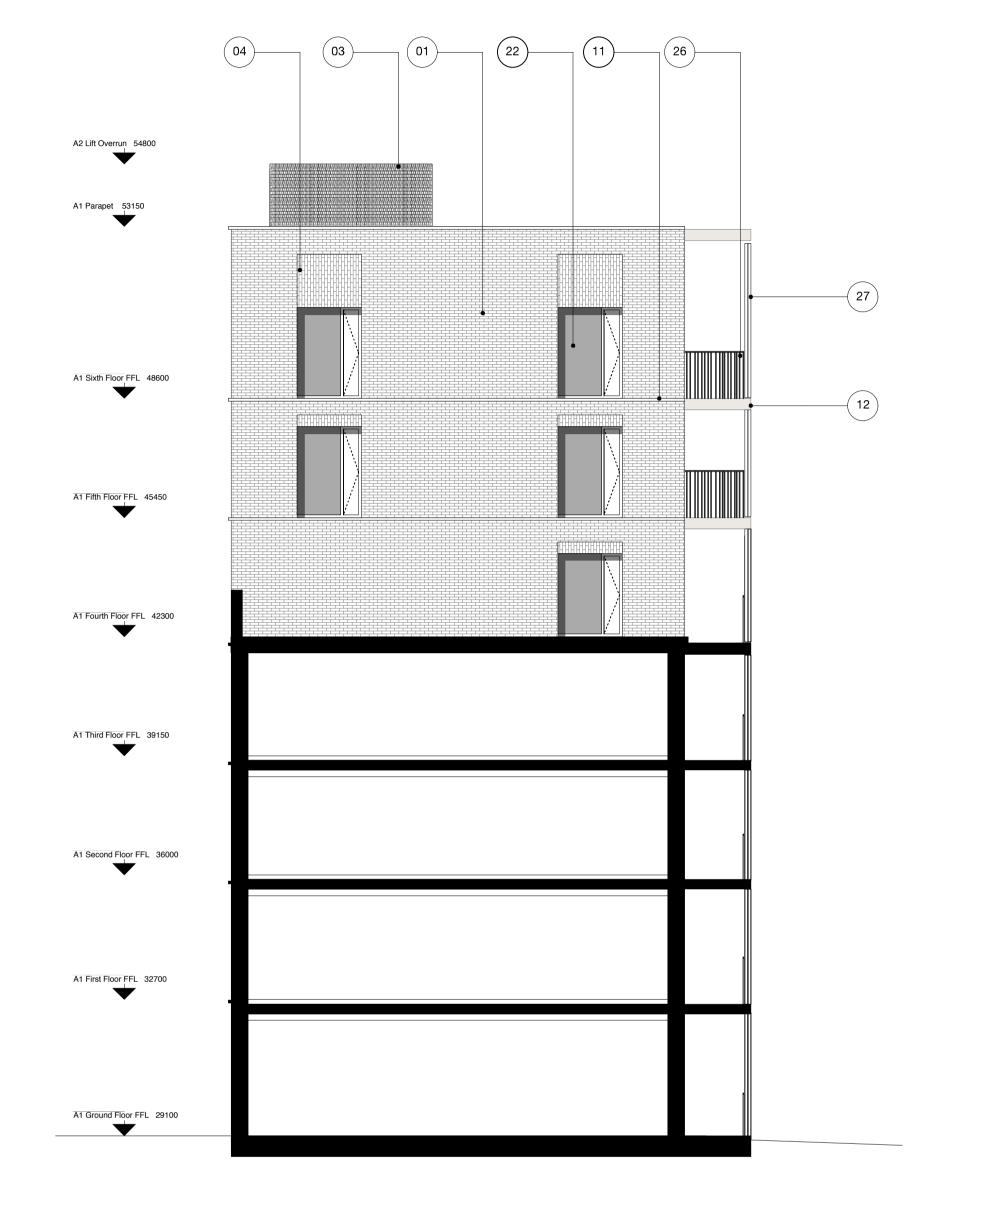
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Drawing No. & Revision 1423_DWG_PL_A_00_251_A





Side Elevation West (W1)

Side Elevation East (E1)

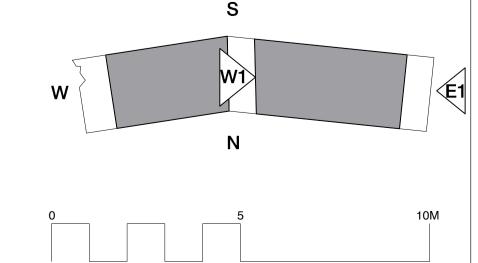
Plot A Material Specification

- Brick type used throughout building textured clinker brick, engobe/coal fired. Bond random. Colour brown/purple variegated brick with a degree of patterning within each brick. Mortar flush pointed, colour to be determined after review of sample boards
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- Cantilevered reconstitueed stone canopy with recessed lighting to communal entrance areas entances, polished finish. Colour light grey
- Reconstitueed stone balcony ledge, polished finish. Colour light grey
- Reconstitueed stone window base, forming recessed seat, polished finish.
- Reconstitueed stone banding, polished finish. Colour light grey Reconstituted stone banding to balcony, polished finish. Colour - light grey
- Concrete upstand to ground floor screens
- Clear glazed communal entrance door, with full hight glazed window above. Door set to be PAS 24 Approved. Colour - light bronze/gold

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 - bronze/gold Solid core private entrance door, with clear glazed side light. Door set to be PAS 24 Approved. Colour - TBC
 - Clear glazed communal entrance door to garden, with clear glazed side panel. Door set to be PAS 24 Approved. Colour light bronze/gold Clear glazed window with solid side opening to match frame. Frame and opening side panel - anodised aluminium. Colour - light bronze/gold
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- Anodised aluminium perforated acoustic attenuation panel. Colour light bronze/gold

subject to detailed solar shading analysis



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Revisions

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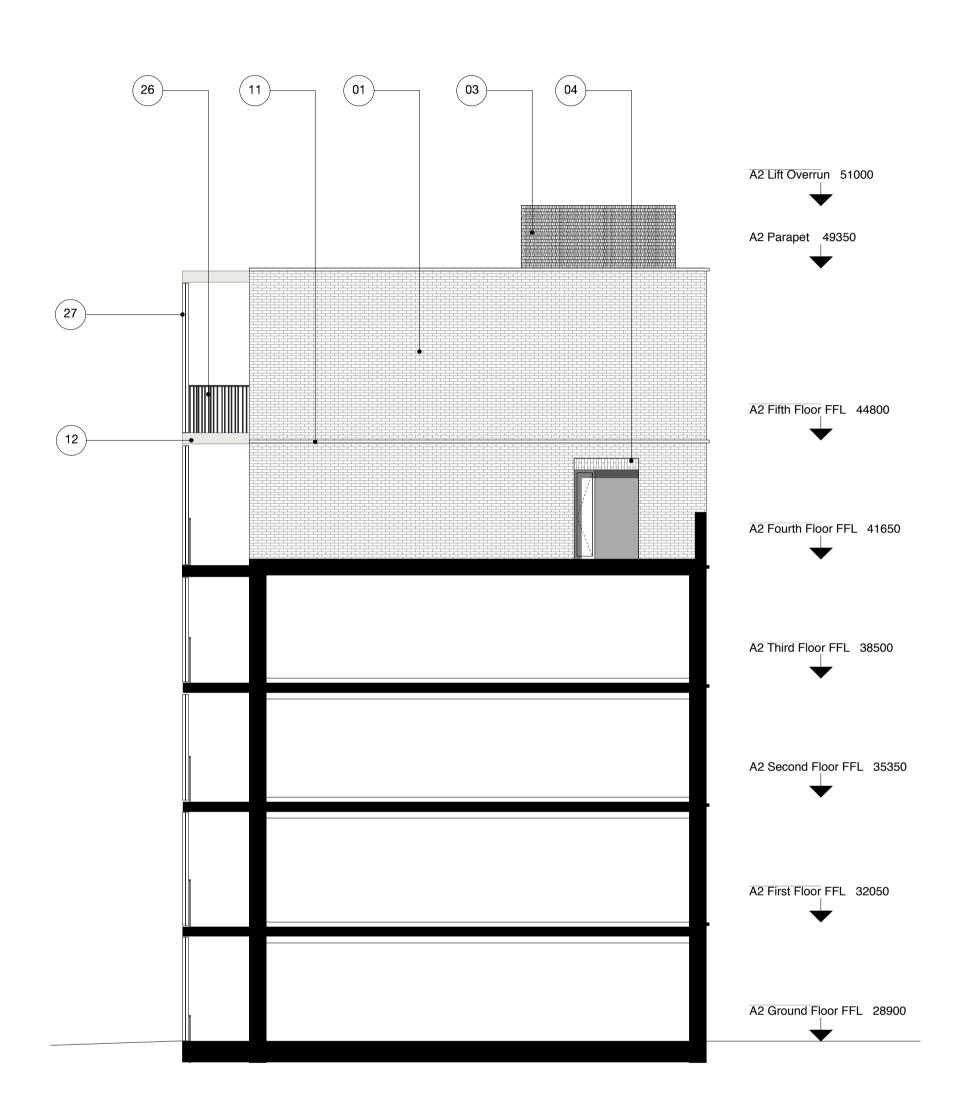
Agar Grove Estate Regeneration

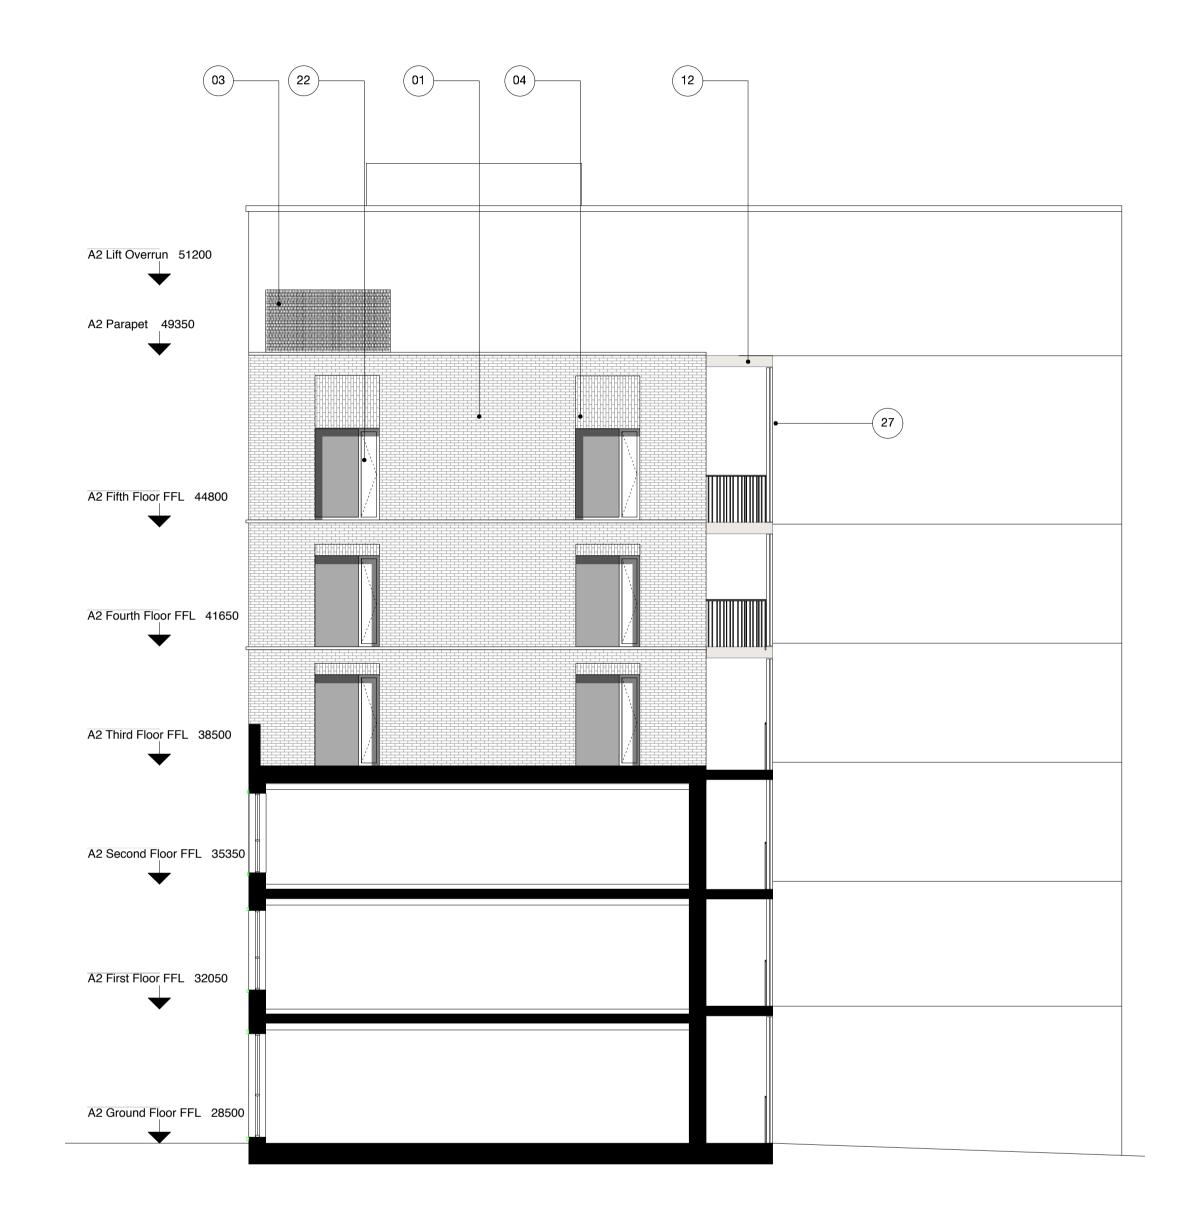
Drawing Side Elevations E1 & W1

Scale @ A1 @ (A3)	Date
1:100 (200)	December 2013
Drawn by	Checked by
PK	SR
Job Number	Status
HB1423	Planning

Drawing No. & Revision

1423_DWG_PL_A_00_252





Side Elevation East (E2)



Plot A Material Specification

- Brick type used throughout building textured clinker brick, engobe/coal fired. Bond random. Colour brown/purple variegated brick with a degree of patterning within each brick. Mortar - flush pointed, colour to be determined after review of sample boards
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- Reconstitueed stone banding, polished finish. Colour light grey
- Reconstituted stone banding to balcony, polished finish. Colour light grey Concrete upstand to ground floor screens
- Clear glazed communal entrance door, with full hight glazed window above. Door set to be PAS 24 Approved. Colour - light bronze/gold

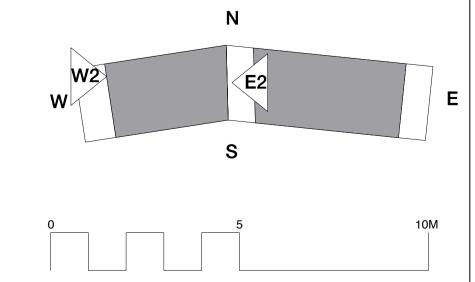
High quality lighting to communal entrance areas

- Slip resistant decorative tile, pattern A to communal entrance floor and walls. Tile pattern extends to extent of overhead canopy externally Suspended stainless steel soffit with mirrored finish to communal
- entrance lobby ceiling Slip resistant decorative tile, pattern B to maisonette entrance threshold. Tile pattern extends to extent of overhead canopy externally Refuse door - perforated anodised aluminium. Colour - light
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- Clear glazed balcony door. Frame anodised aluminium. Colour -
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Revisions

24.02.14 A Level to terrace W2 corrected

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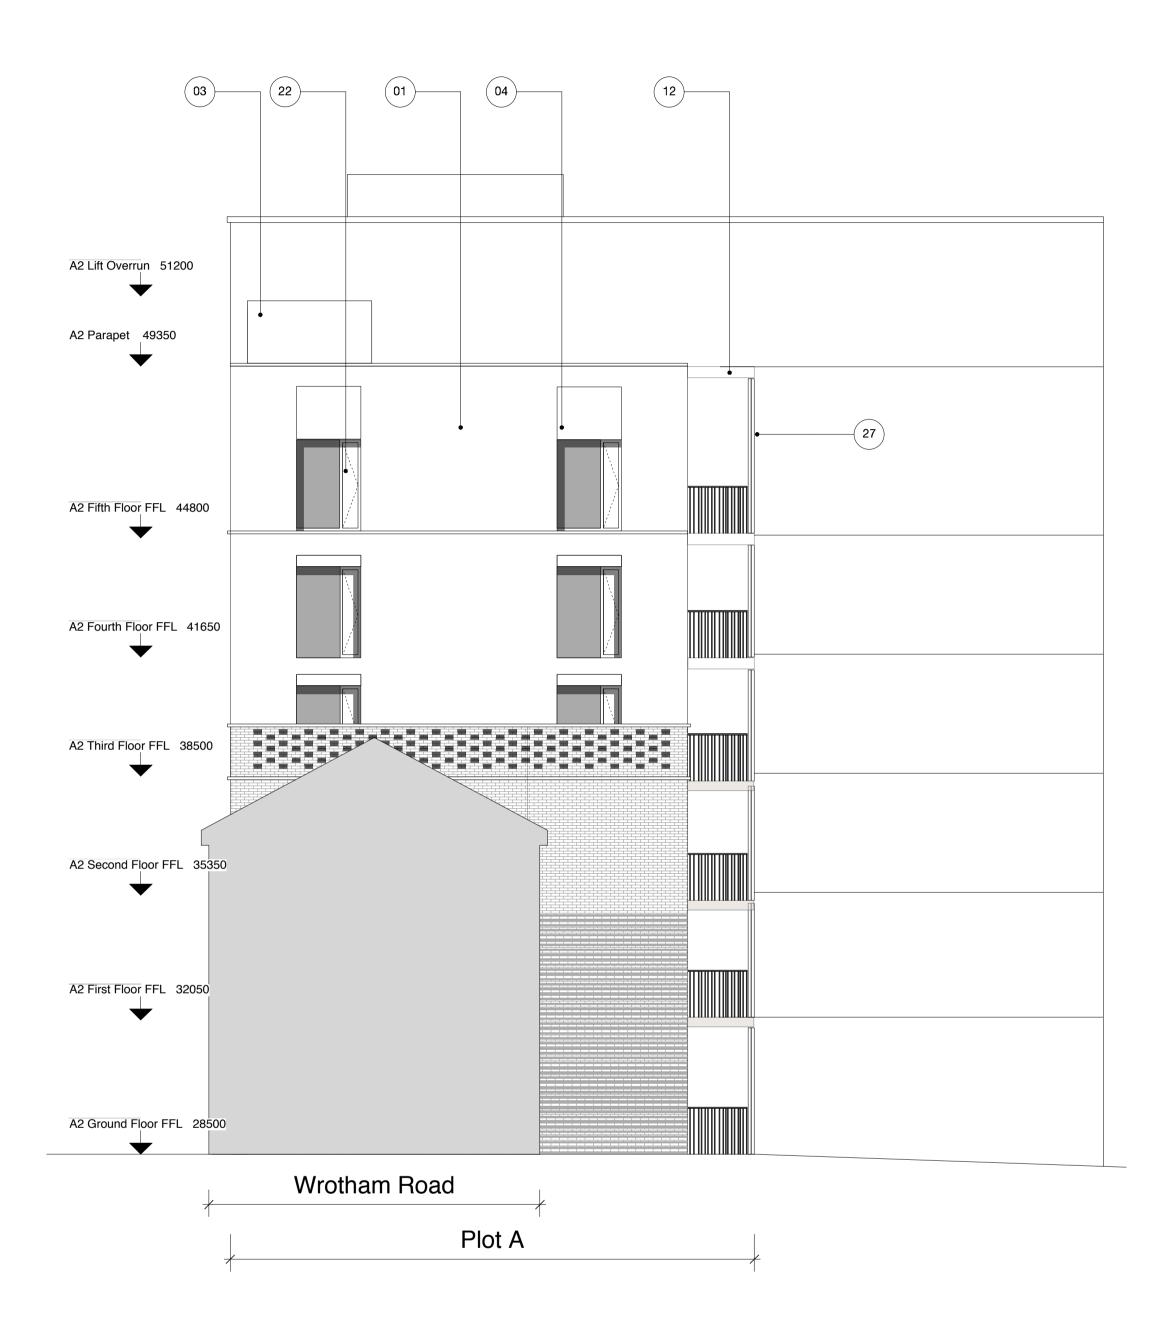
Agar Grove Estate Regeneration

Drawing Side Elevations E2 & W2

Date Scale @ A1 @ (A3) 1:100 (200) February 2014 Drawn by Checked by SR Job Number Status HB1423 Planning

Drawing No. & Revision

1423_DWG_PL_A_00_253_A



Side Elevation West (W3)

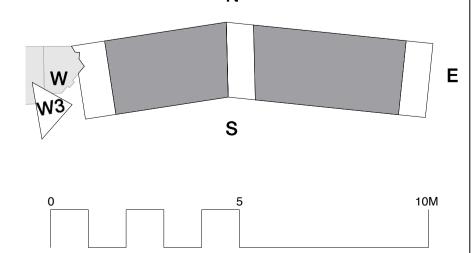
Plot A Material Specification

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Concrete upstand to ground floor screens

High quality lighting to communal entrance areas

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Revisions

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Agar Grove

Drawing

Estate Regeneration

Side Elevation W3

Scale @ A1 @ (A3)	Date
1:100 (200)	February 2014
Drawn by	Checked by
JW	SR
	Ort
Job Number	Status
Job Number HB1423	

Drawing No. & Revision

1423_DWG_PL_A_00_254