



NOTES:-
1. The accuracy and content of this drawing are dependent on the original specification and EDI should be consulted before use of other scales or use in CAD form.
2. Where underground services are shown, all reasonable care has been taken within the spirit of the original specification and requirement. Before use of this information the user should consult EDI and satisfy themselves of the completeness and accuracy of such detail before undertaking any works. Due to the nature of this work and the limitations imposed by ground conditions and the detection equipment no guarantee can be given that all services have been recorded.
3. All reasonable care has been taken in the survey detail represented on this drawing but any discrepancies must be reported to EDI immediately. Our aim is to produce the best possible results within the specification and cost constraints of our clients. Any comments are most welcome.
4. All levels and co-ordinates are related to the datum described. Levels shown at kerbs are channel level unless stated. The horizontal control of this survey is arbitrary. The vertical control of this survey is based on OS datum as translated from GPS coordinates using the OSGM02 transformation as supplied by the OS. This may differ from existing OS benchmarks in the area which should be disregarded; all levels should be taken from EDI survey stations.

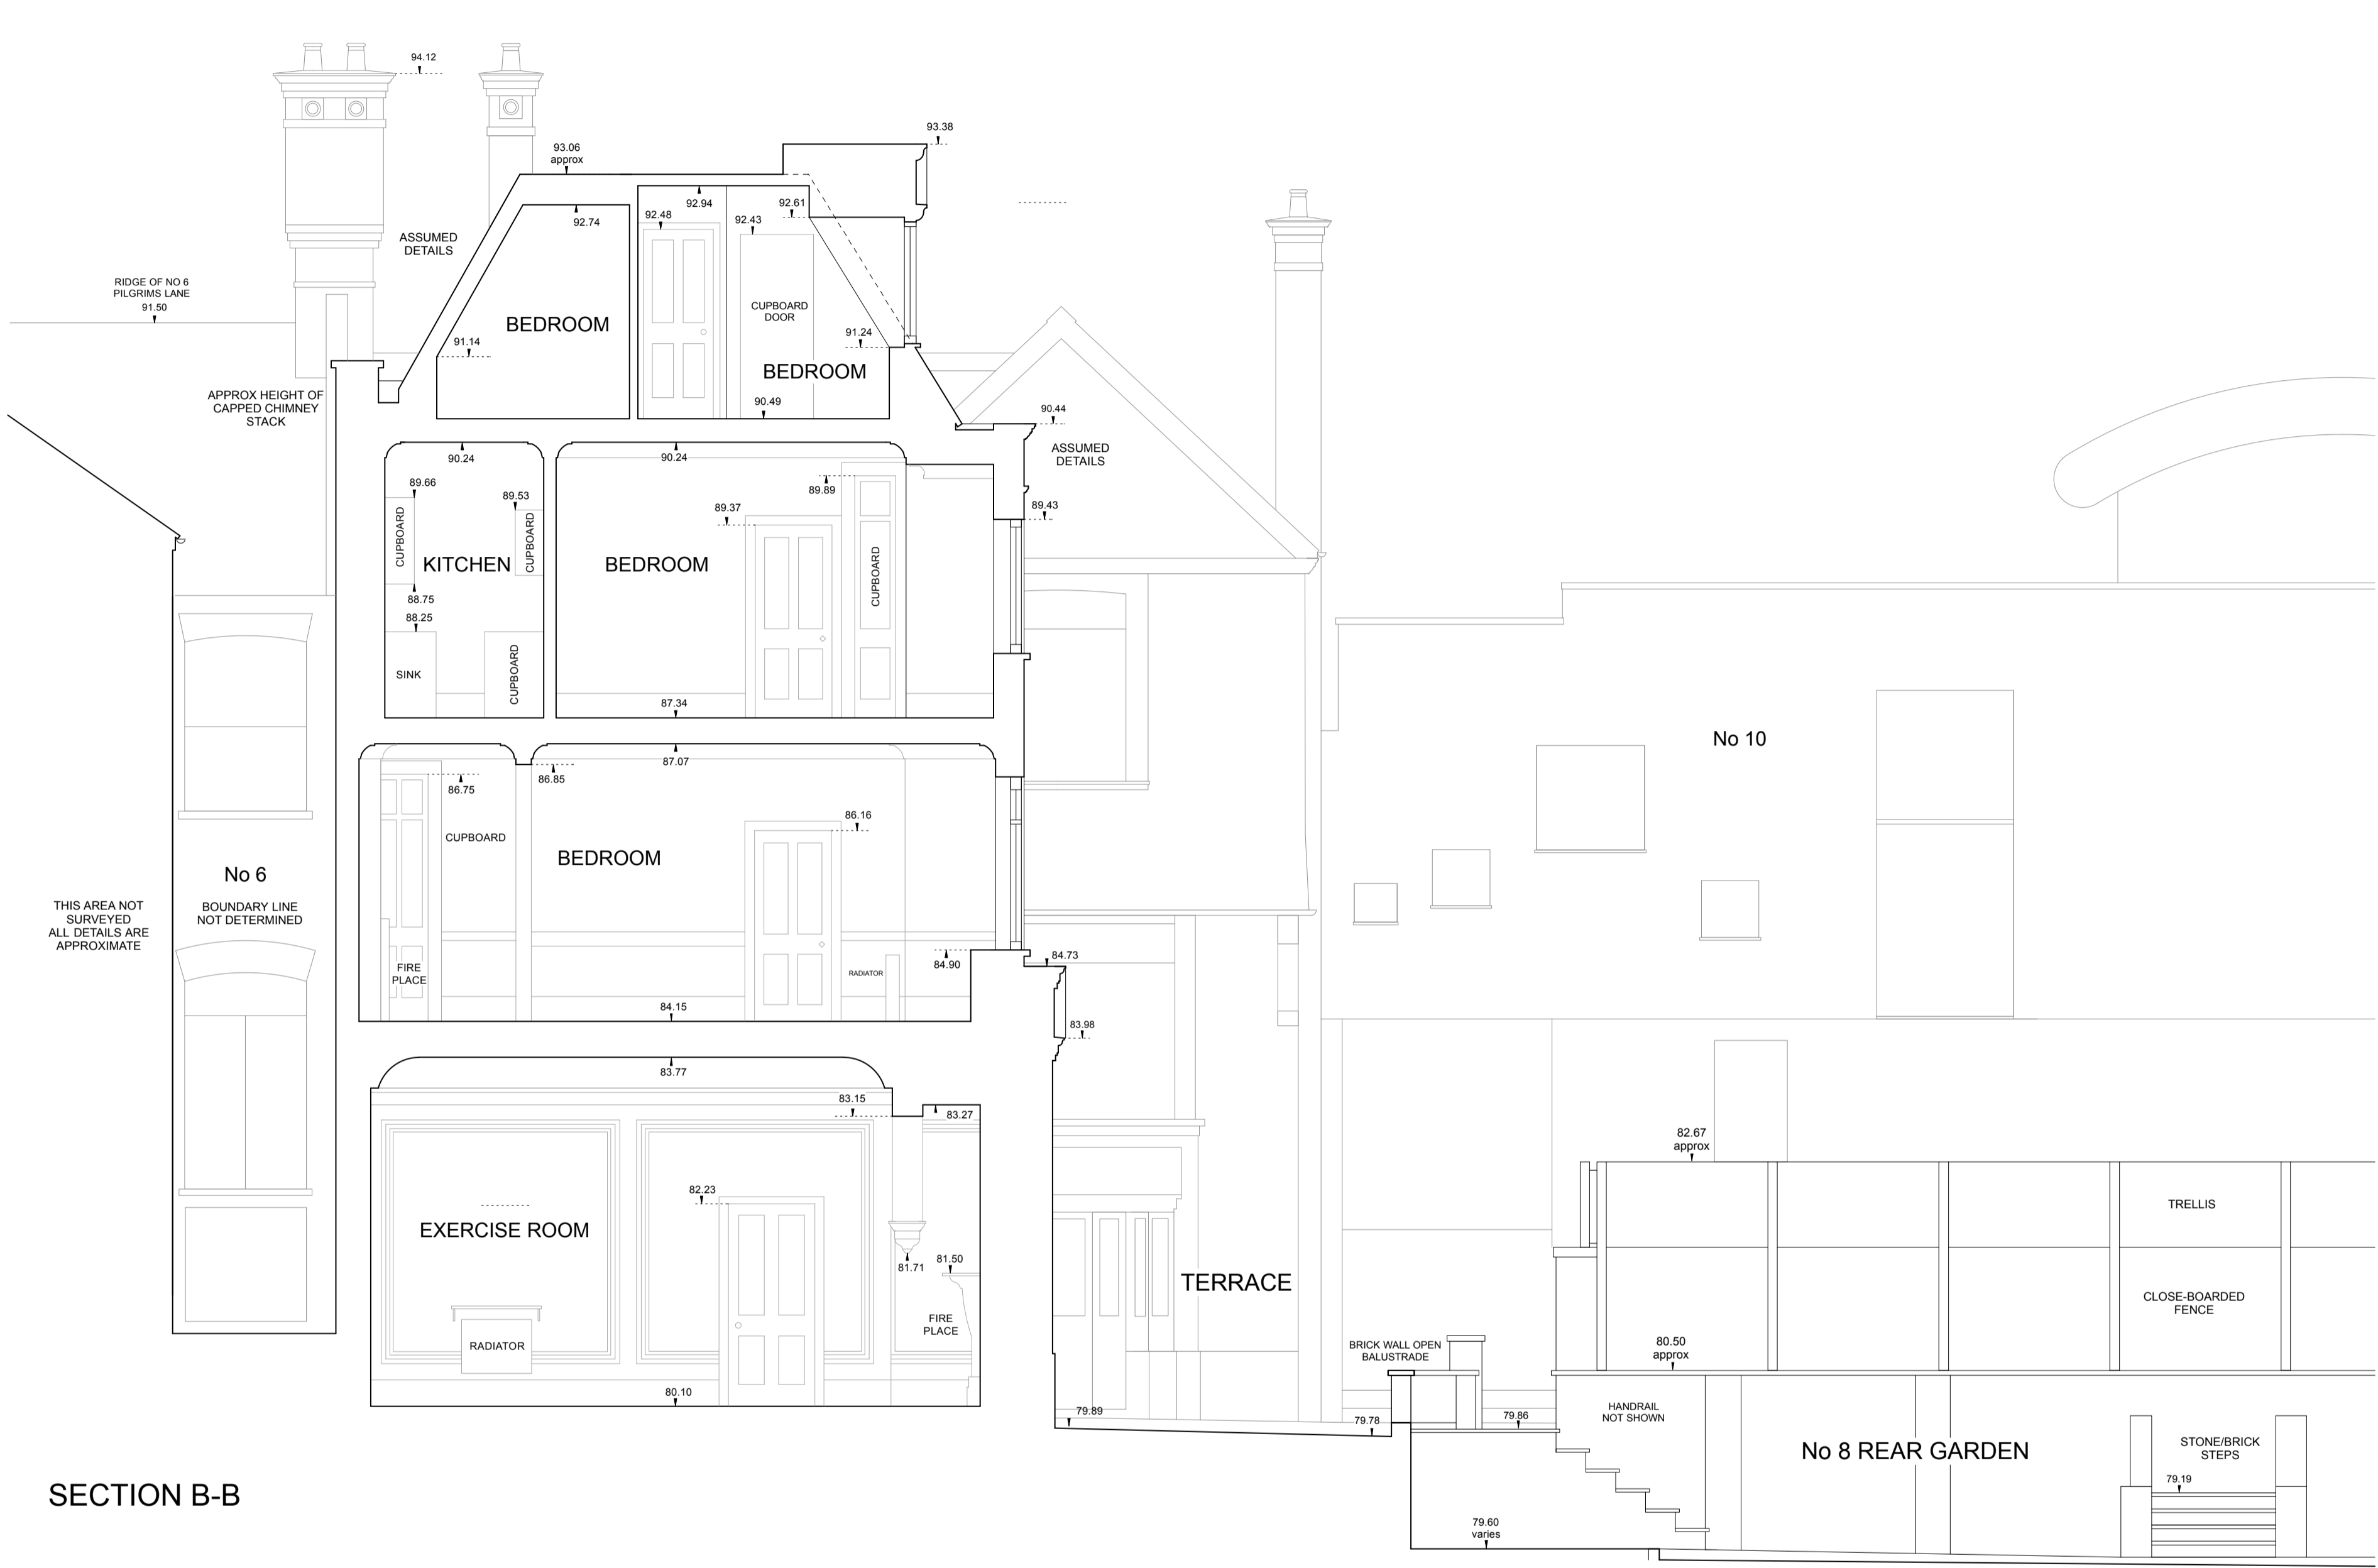


SECTION B-B

DATUM 78.00m A.O.D

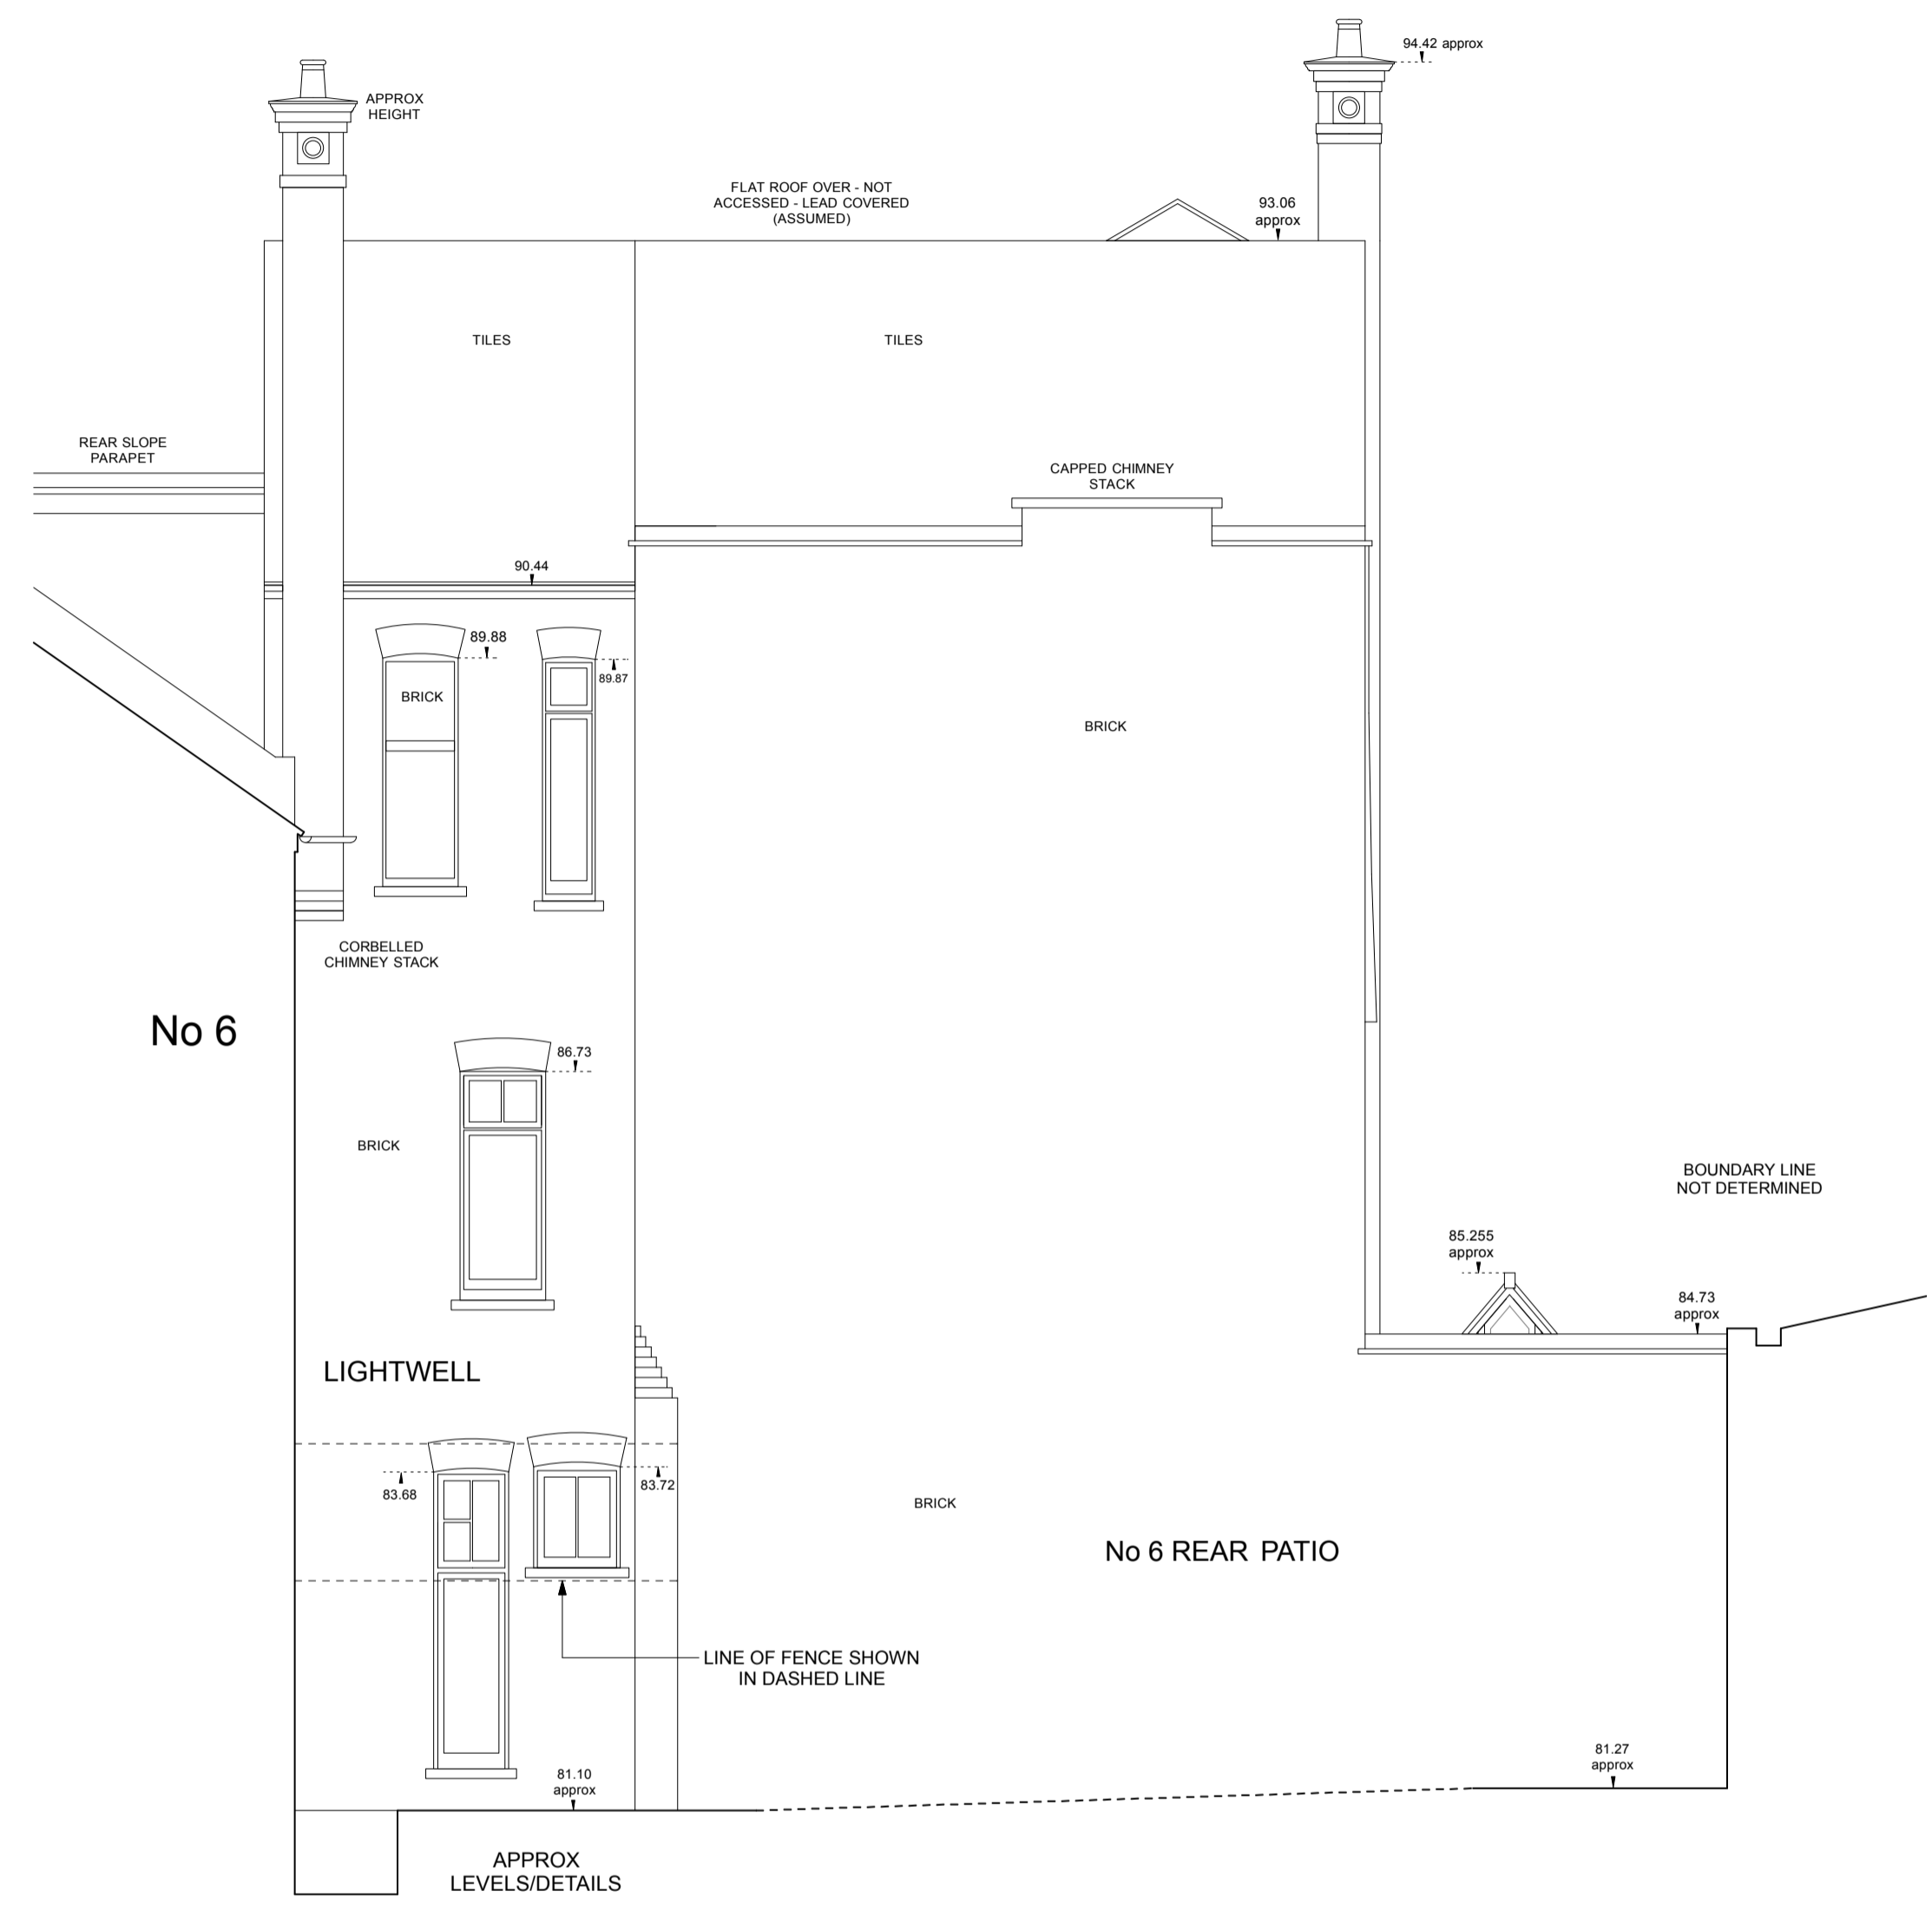

REAR ELEVATION E

DATUM 78.00m A.O.D

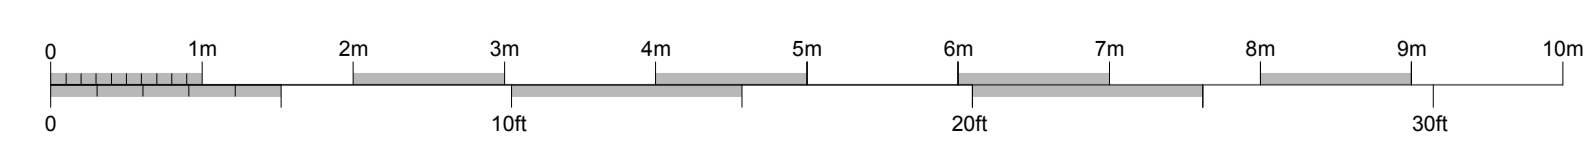

LEGEND	UR	Unrail	Finishes	Building Level Details
AB Brick	UR	Unrail	B Brickwork	D Door
BD Bolted	UTL	Unable to lift	BB Bricks/Block	EL Floor Level
BS Beam	V	Vent	C Concrete	FLL Floor Level
CL Cover Level	VP	Vent Pipe	CL1 Ceiling Tiles	FLR Flat Roof Level
CH Drainage Channel	CF	Cupboard	CF Carpet	HL Head Level
CPC Damp proof Course	CR	Corneil Reader	CPT Carpet Tiles	PLR Parapet Level
EQ Equip Rise	WM	Water Meter	CT Ceramic Tiles	RL Ridge Level
GV Gas Valve	WP	Waste Pipe	FT Floor Tiles	SL Still Level
IC Inspection Cover			HSD Handboard	SP Spring of Arch
IL Inset Level			L Limestone	TA Top of Arch
JK Junction Box			P Plaster	W Window
JM Junction Meter			S Steelwork	T Timber
MD Meter			VT Vinyl Tiles	
RE Roofing Eave				
RM Road Manhole				
RSJ Rolled Steel Joist				
RWP Rain Water Pipe				
SD Service Duct				
SV Stop Valve				

AutocAD 2007

No.	Job No.	Date	Revision Detail	Surveyor	Checked

EDI SURVEYS LTD.
163-165, RANELAGH ROAD, IPSWICH, SUFFOLK, IP2 0AH
Tel: (01473) 211222 Fax: (01473) 221660 Email: enquiries@edisurveys.co.uk
www.edisurveys.co.uk

PROJECT
8 PILGRIMS LANE
HAMPSTEAD
LONDON NW3 1SL

CLIENT
MRS I ABIOLA C/O
BROD WIGHT ARCHITECTS
75 HAVERSTOCK HILL
LONDON NW3 4SL

DRAWING No.
999/S08

Job No. 11943
Scale 1:50
Surveyor M.CABLE
Date June 2010
Checked GMP

DRAWING TITLE
REAR ELEVATIONS
B and E
Section E-E
EXISTING