

Lower Ground Floor Plan: Proposed

Discharge of Conditions Rev D - 13/08/14

#### Introduction: Enabling Works 3

The Wilkins Terrace and Lower Refectory project has been split into a number of packages. The Enabling Works 3 (Catering Support) package of the works will provide office space and support facilities for the catering team both during construction and after completion of the Terrace and Lower Refectory.

The Enabling Works 3 (Catering Support) will be undertaken in advance of the Main Works and as such the design team aim to partially discharge conditions relevant to these works as soon as possible.

#### Enabling Works 3 (Catering Support) Project Areas



Offices, Showers, WCs, Changing, Lockers and Store




Preparation for Main Works including drainage and fire protection to window openings. WCs and finishes to be installed as part of Main Works.

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#### LBC Condition 3e: Service runs and Ducting - Locations for Penetrations

The following images highlight the indicative locations and dimensions of builders work holes required for ductwork, pipework and trucking to be installed as part of Enabling Works 3.

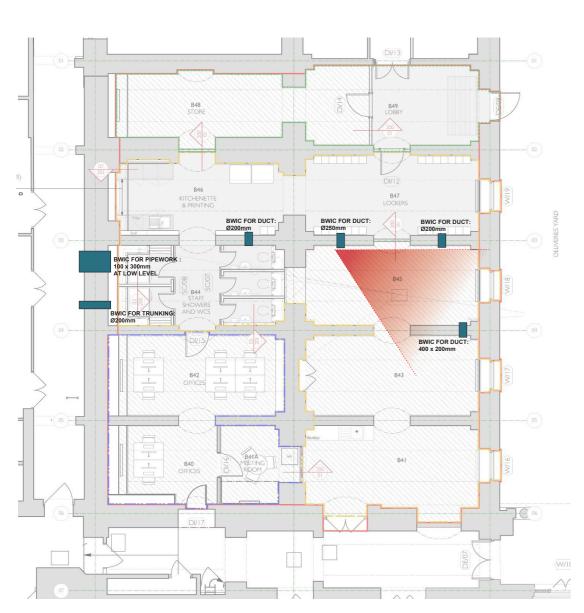


View indicated on Proposed Plan - WCs, Lower Ground Floor





Indicative location of proposed builders work penetrations

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LBC Condition 3e: Service runs and Ducting - Locations for Penetrations



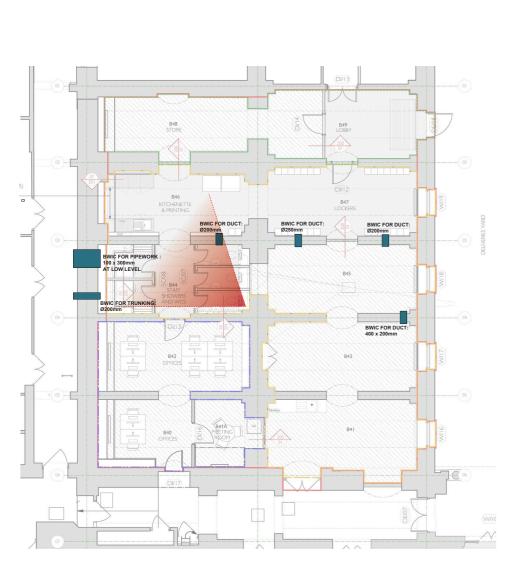


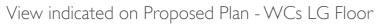

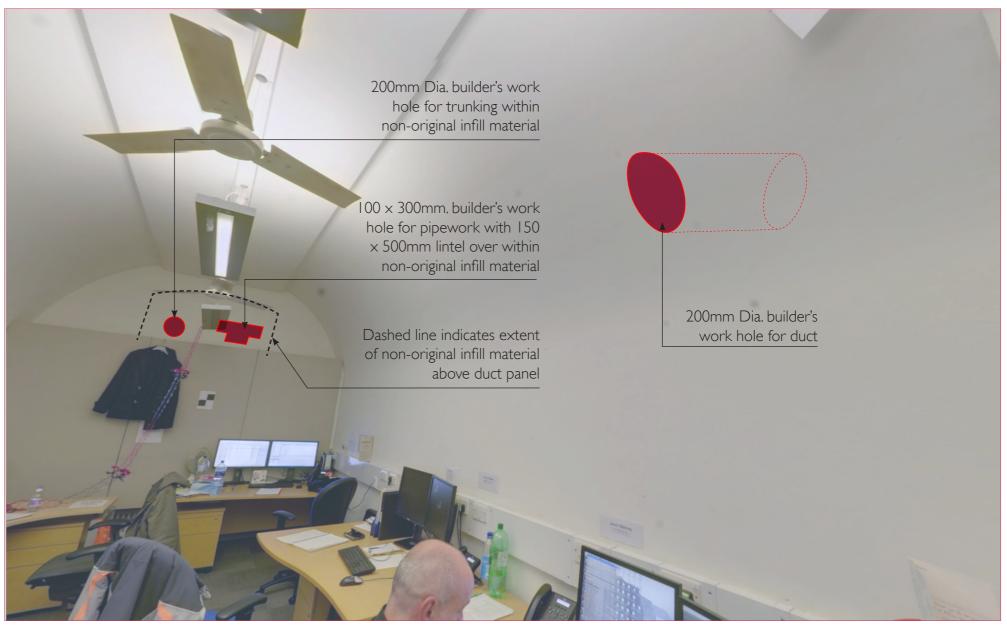Indicative location of proposed builders work penetrations

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LBC Condition 3e: Service runs and Ducting - Locations for Penetrations



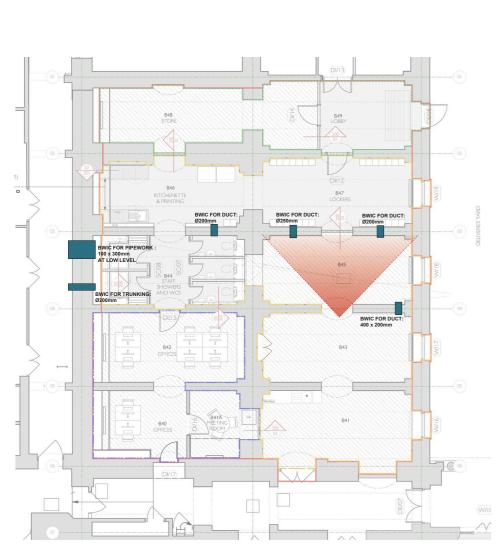





Indicative location of proposed builders work penetrations

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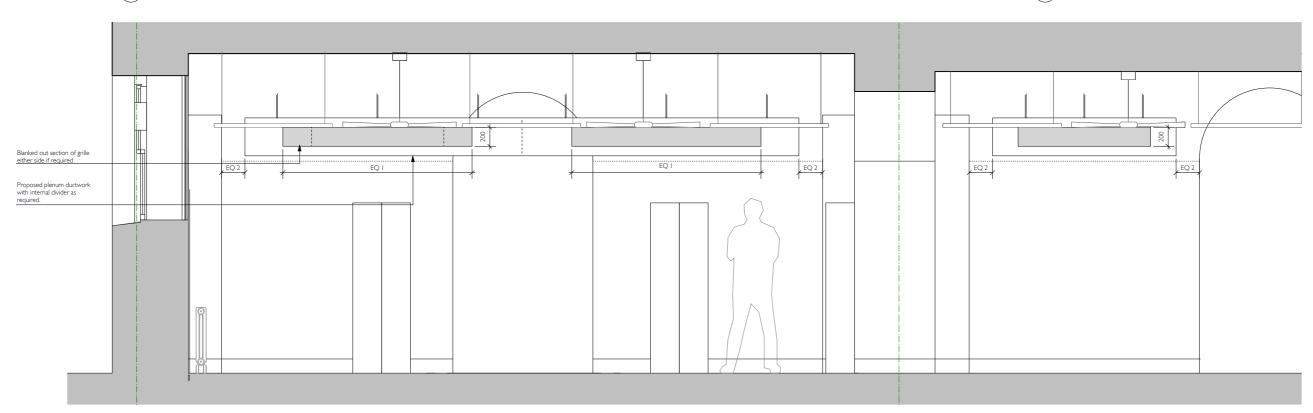
LBC Condition 3e: Service runs and Ducting - Typical Duckwork installation

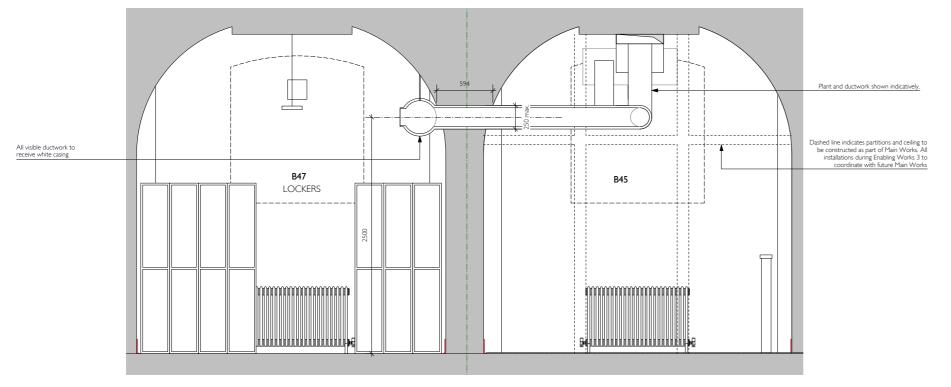


Section through Rooms B47 & B45 I:20

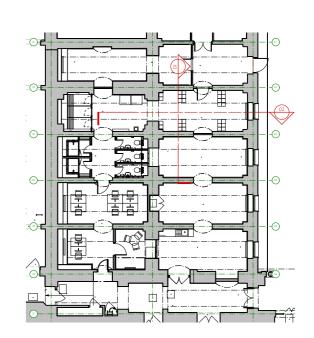

03 Key Plan NTS




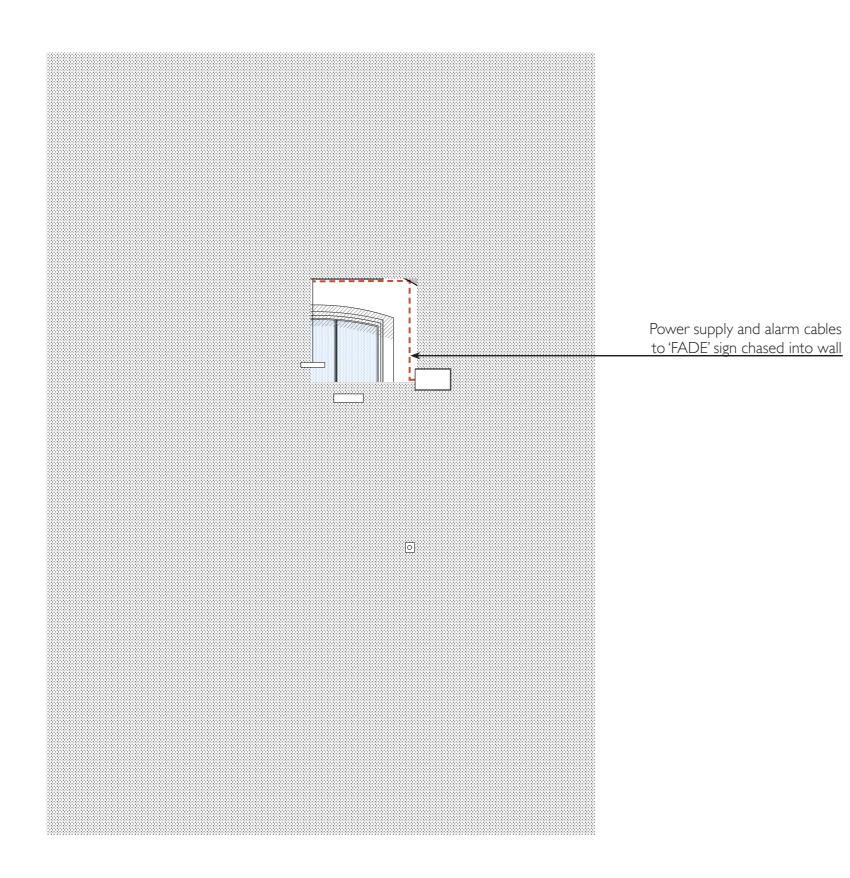

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#### LBC Condition 3e: Service runs and Ducting - FADE sign installation


A 'Fire Alarm Activated, Do Not Enter' (FADE) sign is required internally adjacent to new door from the Catering Support lobby, to deter access to the future service yard when a fire alarm has been activated in the area. The existing power and fire alarm supplies will be adapted to supply the sign. Cables and will be chased into the wall to minimise visible clutter.

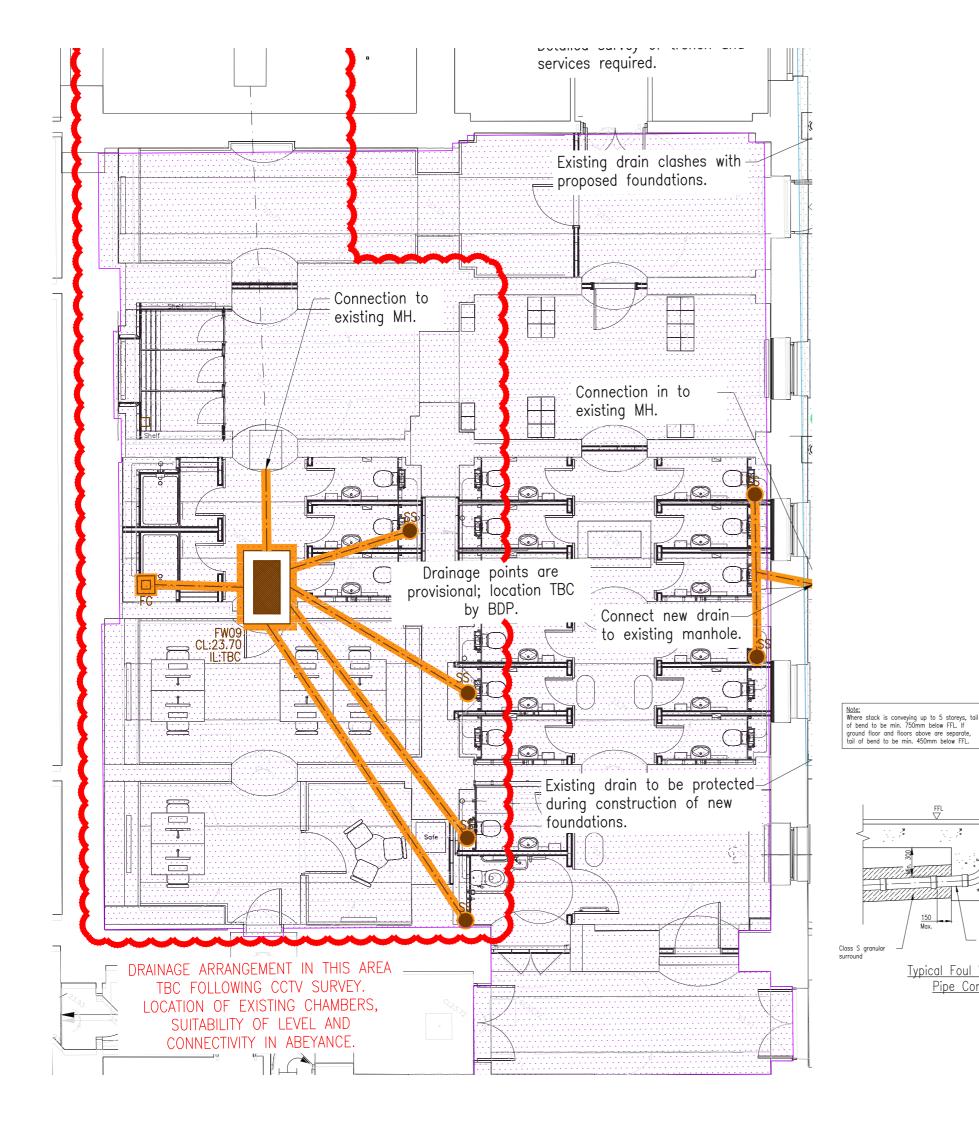

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#### LBC Condition 3e: Drainage

New drainage routes are required for the proposed showers and WCs. Drainage routes and a new inspection chamber are to be installed as part of Enabling Works 3 as indicated in the drawing opposite. A trench approximately 300mm wide is required for the installation of each drainage run.

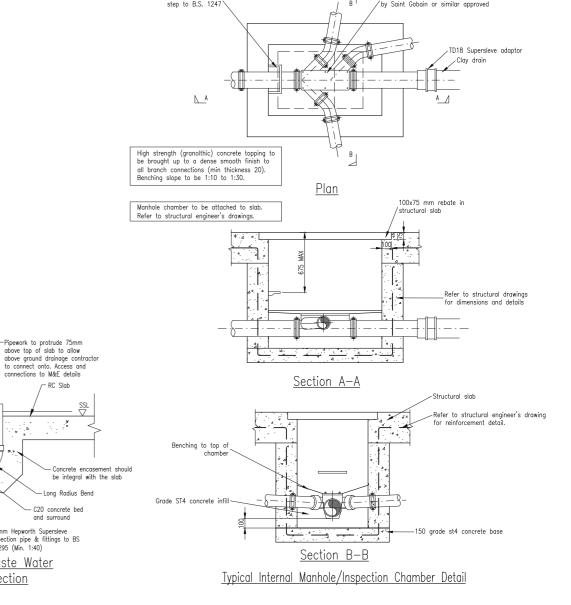

- 100mm Hepworth Supersleve connection pipe & fittings to BS EN 295 (Min. 1:40)

Typical Foul Waste Water

Pipe Connection

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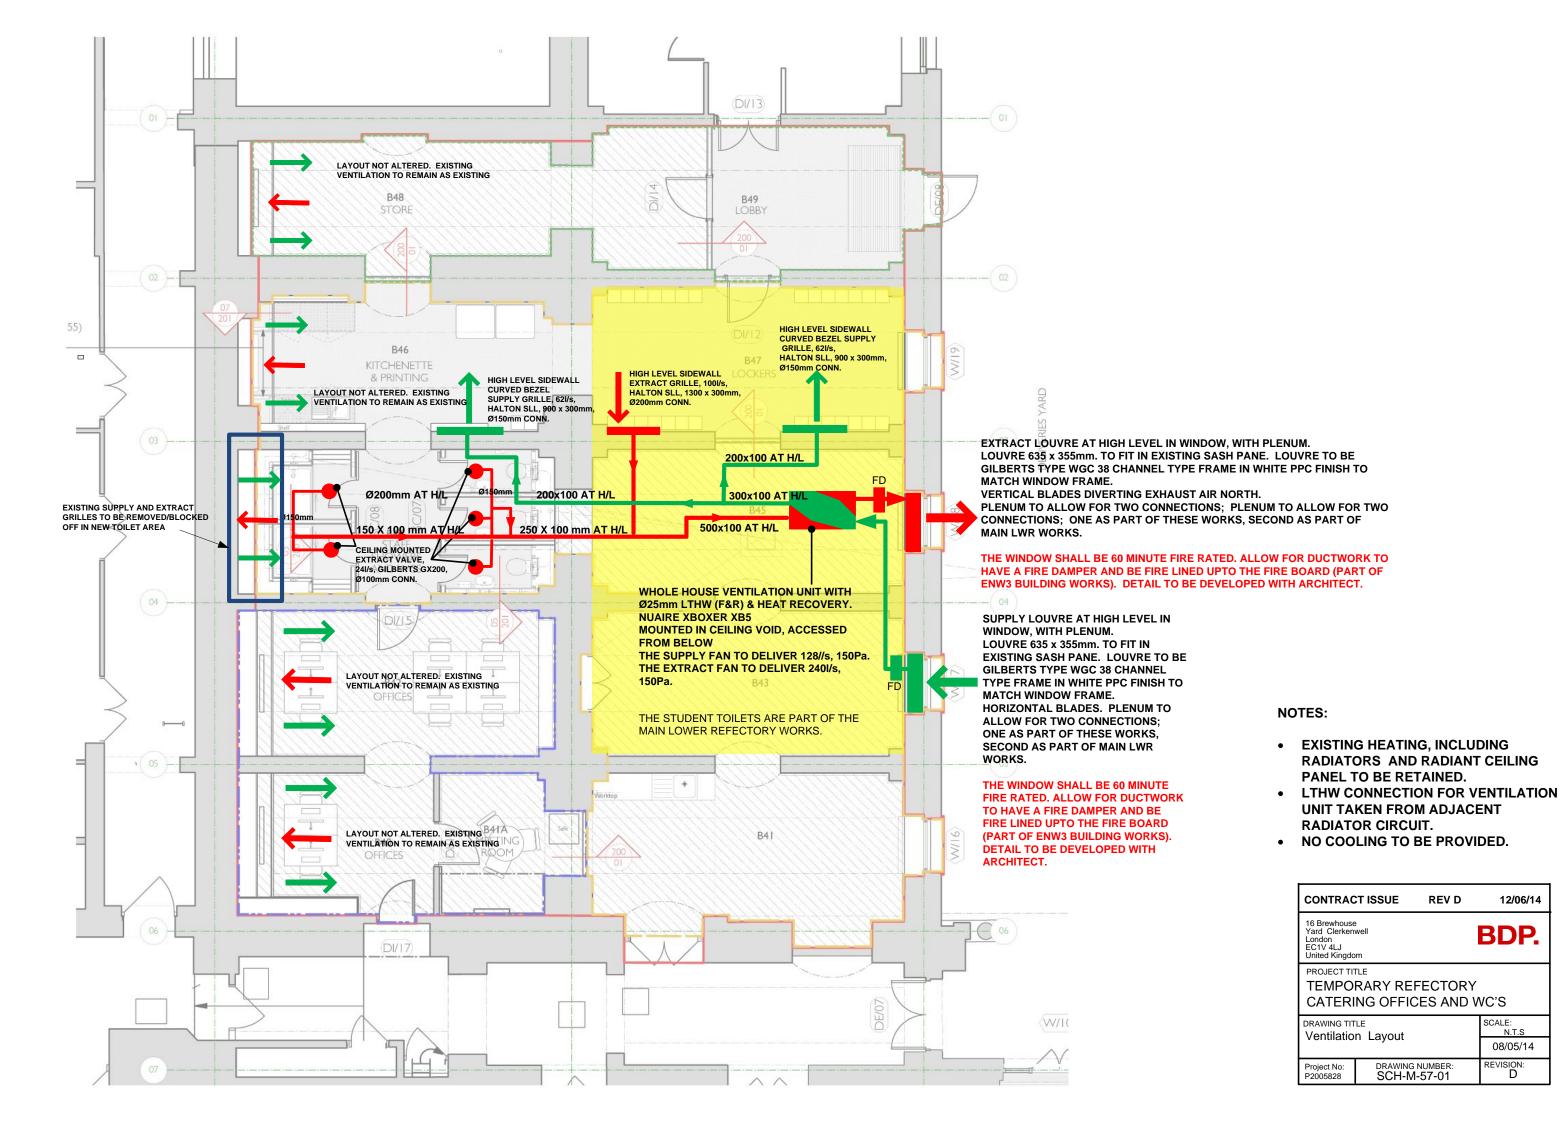
LBC Condition 3e: Mechanical, Electrical and Public Health Services Drawings



#### NOTES:

- ALL BWIC AT HIGH LEVEL UNLESS NOTED OTHERWISE.
- FINAL DIMENSIONS AND SETTING OUT OF BWIC TO BE COMPLETED BY M&E CONTRACTOR.
- REFER TO STRUCTURAL ENGINEER FOR BELOW GROUND DRAINAGE.

16 Brewhouse Yard Clerken London EC1V 4LJ United Kingdo	BDP.					
TEMPO	PROJECT TITLE TEMPORARY REFECTORY CATERING OFFICES AND WC'S					
DRAWING TIT	SCALE: N.T.S					
IVILI DVV	WIEL DAVIO					
Project No: P2005828	DRAWING NUMBER: REVISION: SCH-MEP-50-01					




12/06/14

BDP.

SCALE:

08/05/14 REVISION:

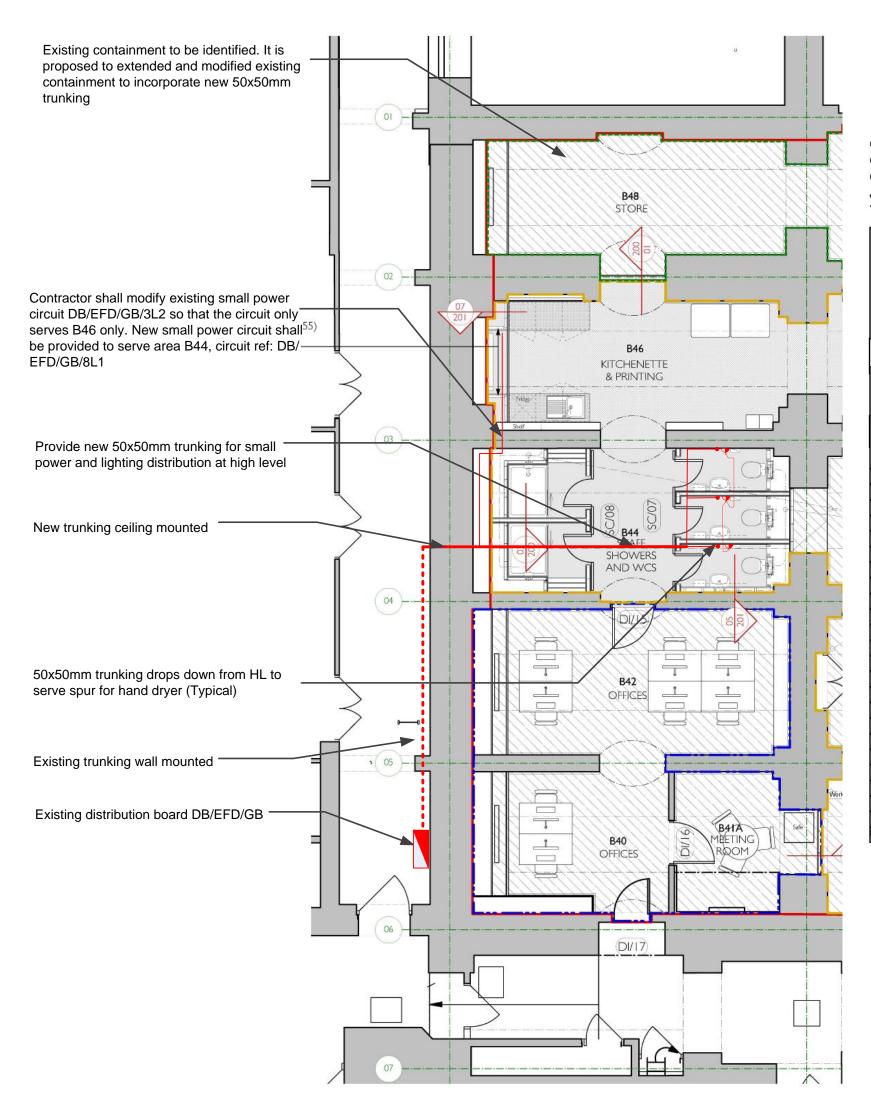

#### SCHEDULE OF CIRCUIT DETAILS FOR THE INSTALLATION

Customer Code UCL148
Customer Name UCL
Customer Site WILKINS
Job Number 70952
Test Date 10/05/2010

Unique Reference : DB113807 Site DB Number : EFD/GB

Location of the distribution board B97

Distribution board designation

EFD/GB

Supply to distribution board is from: DB094179,RM B36

Overcurrent protective device for the distribution circuit: Associated RCD (if any): BS(EN)

Type BS (EN) 88 Rating 100 A RCD No of Poles: L∆n m/A

Supply Cable Type: F

Conductor Size: 25.0

#### **CIRCUIT DETAILS**

Circuit Designation	Type of Ref		No of	f Circuit Conductors:		Max.	DEVIC	OVERCURRENT PROTECTIVE DEVICES		RCD	Maximum Zs	
Circuit Number & Phase		wiring	Method	Points Served	Live (mm2)	CPC (mm2)	disconnection time permitted by BS 7671 (s)	BS (EN)	Rating (A)	Short circuit capacity (kA)	Operating current I <sub>Δ</sub> n (mA)	permitted by BS 7671 (Ω)
1L1	SKTS B42/B40	D	В	4	2.5,2.5	2.5	0.4	BS EN 60898 TYPE C	32	10	N/A	0.72
1L2	SKTS B41A	D	В	5	2.5,2.5	2.5	0.4	BS EN 60898 TYPE C	32	10	N/A	0.72
1L3	SKTS B41	D	В	3	2.5	2.5	0.4	BS EN 60898 TYPE C	20	10	N/A	1.15
2L1	SPURS B40/B42	D	В	3	2.5	2.5	0.4	BS EN 60898 TYPE C	20	10	N/A	1.15
2L2	SKTS B44/B45	D	В	15	2.5,2.5	2.5	0.4	BS EN 60898 TYPE C	32	10	N/A	0.72
2L3	SPUR B41	D	В	1	2.5	2.5	0.4	BS EN 60898 TYPE C	20	10	N/A	1.15
3L1	SKTS B47/B46	D	В	15	2.5,2.5	2.5	0.4	BS EN 60898 TYPE C	32	10	N/A	0.72
3L2	POWER B45 (MODIFIED)	D	В	3	2.5	2.5	0.4	BS EN 60898 TYPE C	20	10	N/A	1.15
3L3	SKTS B41/B43	D	В	15	2.5,2.5	2.5	0.4	BS EN 60898 TYPE C	32	10	N/A	0.72
4L1	SKTS B46/B47	D	В	3	2.5	2.5	0.4	BS EN 60898 TYPE C	20	10	N/A	1.15
4L2	SKTS B49/B48	D	В	15	2.5,2.5	2.5	0.4	BS EN 60898 TYPE C	32	10	N/A	0.72
4L3	SPURS B41/B43	D	В	4	2.5	2.5	0.4	BS EN 60898 TYPE C	20	10	N/A	1.15
5L1	H/DRYER B39	D	В	1	2.5	2.5	0.4	BS EN 60898 TYPE C	20	10	N/A	1.15
5L2	SPUR B49/B48	D	В	4	2.5	2.5	0.4	BS EN 60898 TYPE C	20	10	N/A	1.15
5L3	LTS B40/B42	D	В	5	1.5	1.5	0.4	BS EN 60898 TYPE C	10	10	N/A	2.30
6L1	LTS B39	D	В	2	1.5	1.5	0.4	BS EN 60898 TYPE C	10	10	N/A	2.30
6L2	HUB SPUR B43	D	В	1	2.5	2.5	0.4	BS EN 60898 TYPE C	16	10	N/A	1.44
6L3	LTS B41/B43/B41A	D	В	10	1.5	1.5	0.4	BS EN 60898 TYPE C	10	10	N/A	2.30
7L1	SKTS B42	D	В	6	2.5,2.5	2.5	0.4	BS EN 60898 TYPE C	32	10	N/A	0.72
7L2	Spare	N/A	N/A	N/A	N/A	N/A	0	N/A	N/A	N/A	N/A	N/A
7L3	LTS B49/B47/B45	D	В	12	1.5	1.5	0.4	BS EN 60898 TYPE C	10	10	N/A	2.30
8L1	POWER B44 (NEW)	D	В	3	4.0	4.0	0.4	BS EN 60898 TYPE C	20	10	N/A	1.15
8L2	LTS B44 (NEW)	D	В	3	2.5	2.5	0.4	BS EN 60898 TYPE C	20	10	N/A	1.15
8L3	LTS B48/B46 (MODIFIED)	D	В	9	1.5	1.5	0.4	BS EN 60898 TYP	EC 10	10	N/A	2.30

16 Brewhouse Yard Clerken London EC1V 4LJ United Kingdo	BDP.	
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DRAWING TIT	SCALE: N.T.S	
Layout	23/04/14	
Project No: P2005828	DRAWING NUMBER: SCH-E-60-01	REVISION:

