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inclusive design

lifetime homes

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#### introduction

This Design & Access Statement has been prepared by Dexter Moren Associates on behalf of McGregor Homes Ltd. in support of the planning application for the replacement of the existing light industrial space (currently Iverson Tyres) and 23 residential units, comprising 18 market apartments and 5 affordable units on behalf of McGregor Homes Ltd.

Following the submission and approval of a previous scheme on February 2014 (App. Ref: 2013/7505/P), a four to seven storey development is proposed on the site, situated at 159-161 Iverson Road West Hampstead, within the Borough of Camden.

This statement has been prepared in accordance with national planning policy and has been set out using the guidance available from CABE, the Commission for Architecture and the Built Environment, in the publication "Design & Access Statements - How to write, read and use them".

The planning submission is further supported by the following reports, produced by other specialists;

/ Planning Statement by Indigo Planning

/ Environmental Noise Assessment Report by Aulos Acoustics

/ Ecological Appraisal & Bat Roost Assessment by The Ecology Consultancy

/ Daylight/Sunlight Report by eb7

/ Energy Statement by Richard Hodkinson Consultancy

/ Sustainability Statement by Richard Hodkinson Consultancy

/ Transport Statement by Vectos Transport Planning

# 01 introduction







The irregularly shapped site at 159-161 Iverson Road is currently occupied by a tyre sales centre, Iverson Tyres Ltd. It comprises a one storey warehouse building, 3 portacabins and a forecourt. The site is highly accessible with West Hampstead tube, Thameslink Rail Station and town centre in the immediate vicinity. This irregular shaped site is approximately 910sqm in size and slopes from east to west. The fall across the length of the site which follows the gradient of Iverson Road is approximately 1.6m.

#### 1.2 Surrounding context

To the north of the site is the railway embankment and the existing West Hampstead Thameslink Rail Station.

To the east of the site there is currently a vacant plot previously occupied by a garden centre. Planning Permission (ref2012/0099/P) was granted dated 12.12.12 for a 36 unit residential development on this site. The development consisted of 33 apartments and 3 family houses. This scheme was designed by Dexter Moren Associates and this submission extrapolates this first development.

To the south of the site, on the opposite side of Iverson Road, there is a mix of uses including residential properties (both flats and terrace houses) . These buildings are yellow brick and range in height from single storey (No.190 Iverson Road) to four storey (No.200 Iverson Road), a relatively recent residential development which is of no particular design merit but quite tall relative to its surroundings. Further along Iverson Road at No.s 166-184 are three and a half storey residential properties.

To the west of the site is a 3-4 storey Network Rail signal box building including an access road that forms the western boundary. Next to it, along Liddell Road is a group of industrial buildings that will be part of a mixed use masterplan comprising residential buildings, school and offices (please see section 09c to see proposed scheme at public consultation).

#### 1.3 Transport links and Local amenities


The site is located within easy reach to West Hampstead Thameslink, Overground and Underground Stations (Jubilee Line), making it a highly accessible location with a PTAL level of 5.

Both West Hampstead and Kilburn offer a high concentration of bars and restaurants and the area is well served by a wide variety of retail, food and & beverage outlets along West End Lane which is 200m to the east.

# 02a existing site





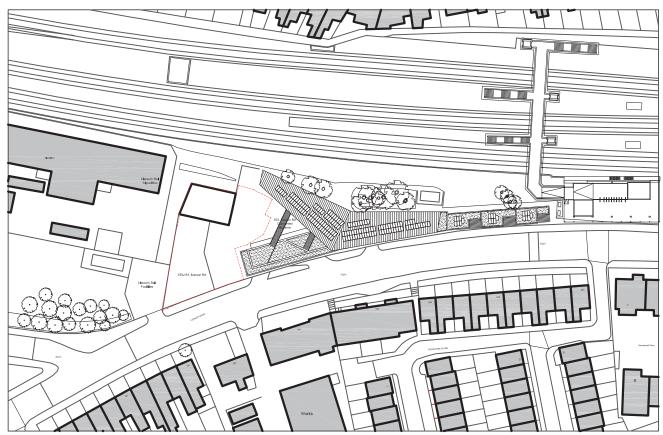


Ordnance Survey, (c) Crown Copyright 2011. All rights reserved. Licence number 100020449


Location Plan Scale 1:1250								Site Boundar	y <b>———</b>
dexter moren associates	57d Jamestown road Iondon nw1 7db UK			project 159-161 Iverson Road	drawing title Location Plan	scale 1:1250 @ A3 NTS @ A4	date 11.11.13	drawn by JB	checked by
architecture urban design Interior design creative media www.dextermoren.com	t: 020 7267 4440 f: 020 7267 6044			client McGregor Homes Ltd.	drawing status Planning	job no. 0974	drawing no.		revision P0
architecture		P0 Issued for Planning	20.11.13 JB		Fiaming	0974	A 000 001		FU

# 02b context existing site plan

#### 1.6 Existing Site Photos

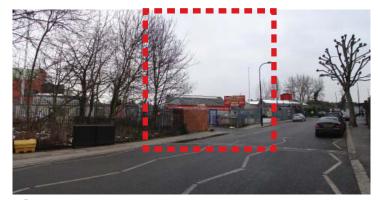



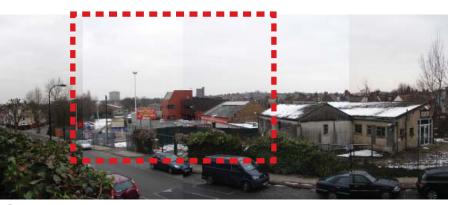

7 View along Iverson Road looking East

Panorama with site looking North

3 Site looking West



Long view looking East towards West End Lane



Looking West along Iverson Road beyond site




200 Iverson Rd\_Raised 3 storey apartments above car park (equivalent of 4 storey) opposite the site



4 Storey Victorian terraces further along Iverson Road



New West Hampstead Thameslink Station

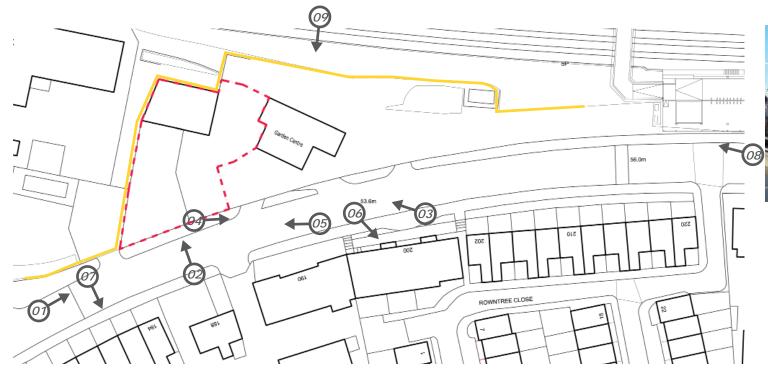





View of rear of site looking from across the Thameslink platform



02c context site photos



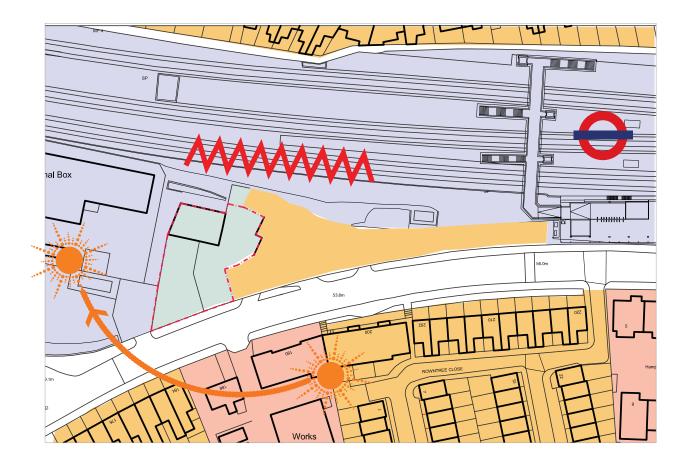

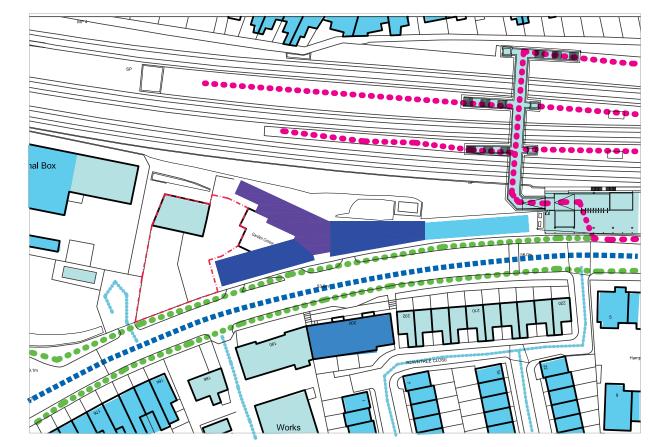

#### Site Analysis



Rail Noise



Sunpath



Residential




Light Industrial



Commercial

Transport

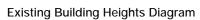



Medium Traffic Routes





Pedestrian Major Routes



Pedestrian Medium Routes



6 Storeys



5 Storeys



4 Storeys






# 03 site analysis

159-161 Iverson Road Design & Access Statement\_August 2014



London Borough of Camden. Local development framework, proposals map 2010 & key

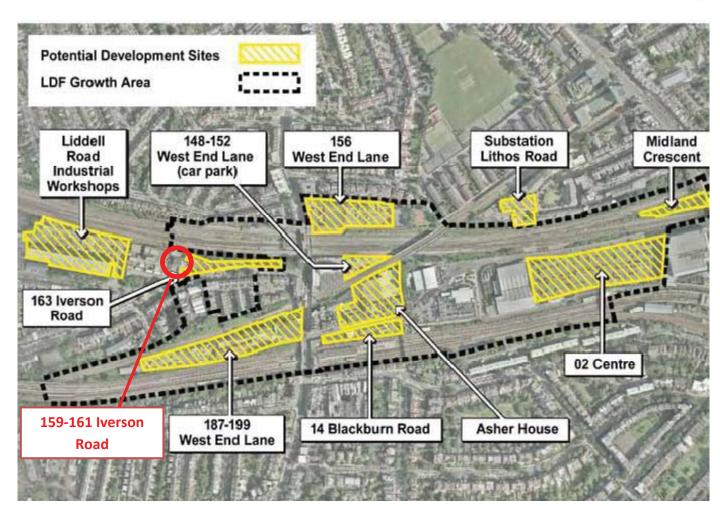

West Hampstead place plan development map

Lege	nd			
	Growth Area		Metropolitan Walk	8
$\overline{}$	Central London Area (Clear Zone Region)		Habitat Corridor	
	Contract (Court Editor Cognitive		Habitat Corridor - Missing Link	
1	Saved Proposal Sites		Regent's Canal	
Built Env	rironment	Town Co	entres and Employment	
	Conservation Area	Town Ce	Central London Frontage	
•	Ancient Monument		Town Centre	
1	Archaeological Priority Area		Neighbourhood Centre	
==	Designated View - Landmark Viewing Corridor		Industry Area	
	Designated View - Lateral Assessment Area		Hatton Garden Area	
==	Designated View - Background Assessment Area			
		Transpo	rt	
Natural E	Environment		Safeguarding Area	
(///)	Open Space			
	Metropolitan Open Land	Waste ar	nd Minerals	
7777				

dexter moren associates architecture urban design interior design creative media

Please refer to the Planning Statement, produced by Indigo Planning, which supports this application.

## 04 planning policy & context





# Aulos Acoustics Acoustic Consultant

The Garden Rooms, 22 Fort Rd. Guildford, GU1 13TE T 02033 971790

#### eb7

Daylight/Sunlight Assessor

Studio 1B 63 Webber St London SE1 0QW T 020 7148 6290

#### Vectos

**Transport Planning Consultants** 

Network Building 97 Tottenham Court Road London, W1T 4TP













(top left) consented scheme at 163 Iverson Rd, West Hampstead (top right) The Spotted Dog, Willesden

(centre left) Mystar Estate, Fulham (centre middle & right) Lille Road, Fulham

(bottom left & middel) Bagleys Lane, Chelsea (bottom right) Leverstock Green Road, Hemel Hempstead

#### design team

The team consists of expert consultants with track records of designing and delivering regeneration projects all over the UK. The client is committed to deliver a high quality development on the site to the benefit of the local community and economy.

## McGregor Homes Ltd

11b Passfield Business Centre Lynchborough Road, Passfield, Hampshire ĞU30 7SB T 01428 751049

#### Dexter Moren Associates

Architect

57d jamestown road london nw1 7db T 020 7267 4440

# Indigo Planning Planning Consultant

Central London office 87 Chancery Lane London WC2A 1ET T 020 7269 6300

#### Richard Hodkinson Consultancy

Energy Consultant

Code for Sustainable Homes Consultant


Evans House 107 Marsh Road Middlesex, HA5 5PA T 020 8429 7026


### The Ecology Consultancy

Ecologist

1st Floor, Beckett House 72, Borough High St. London SE1 1XF T 020 7378 1914


# design team

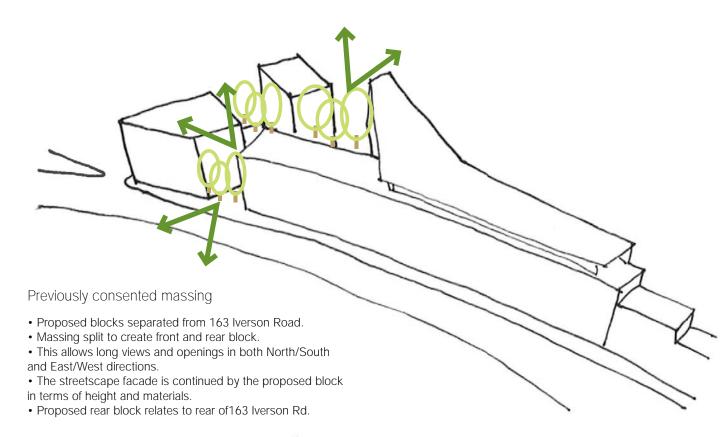

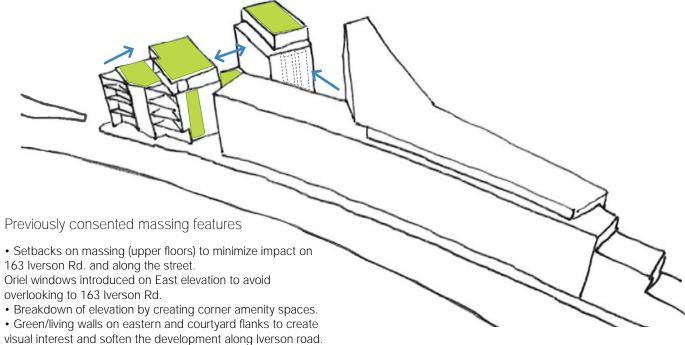

• Green/living roofs to improve biodiversity and reduce


rainwater run off.

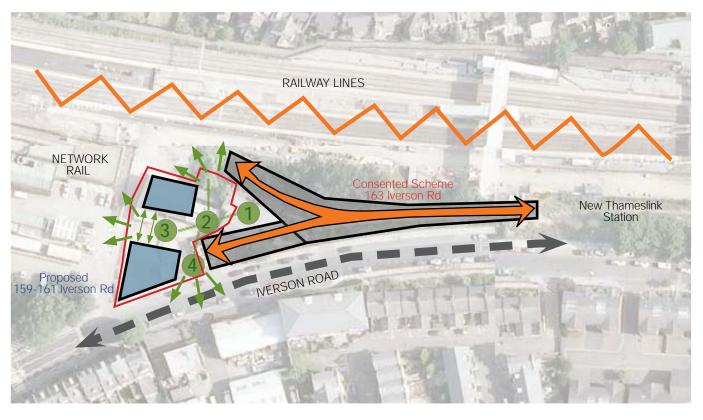

- 1 Main landscaped area of planning consented building at 163 Iverson Rd.
- The proposed building is separated from the adjoining building in order to maintain and enhance the landscaped area.
- 3 By creating two separate blocks the landscaped gap between them continues the amenity area and improves the sense of openness.
- The proposed block facing Iverson Rd is separated from the consented block at no.163, creating a new green area that improves the streetscape appearance and the access to the residential block at the rear.

The proposed scheme follows the same principles as the consented scheme presented, which was the result of design development that addressed comments and views both from two pre-planning advice meetings and the Public Consultation.

# 06 design concept previously consented scheme

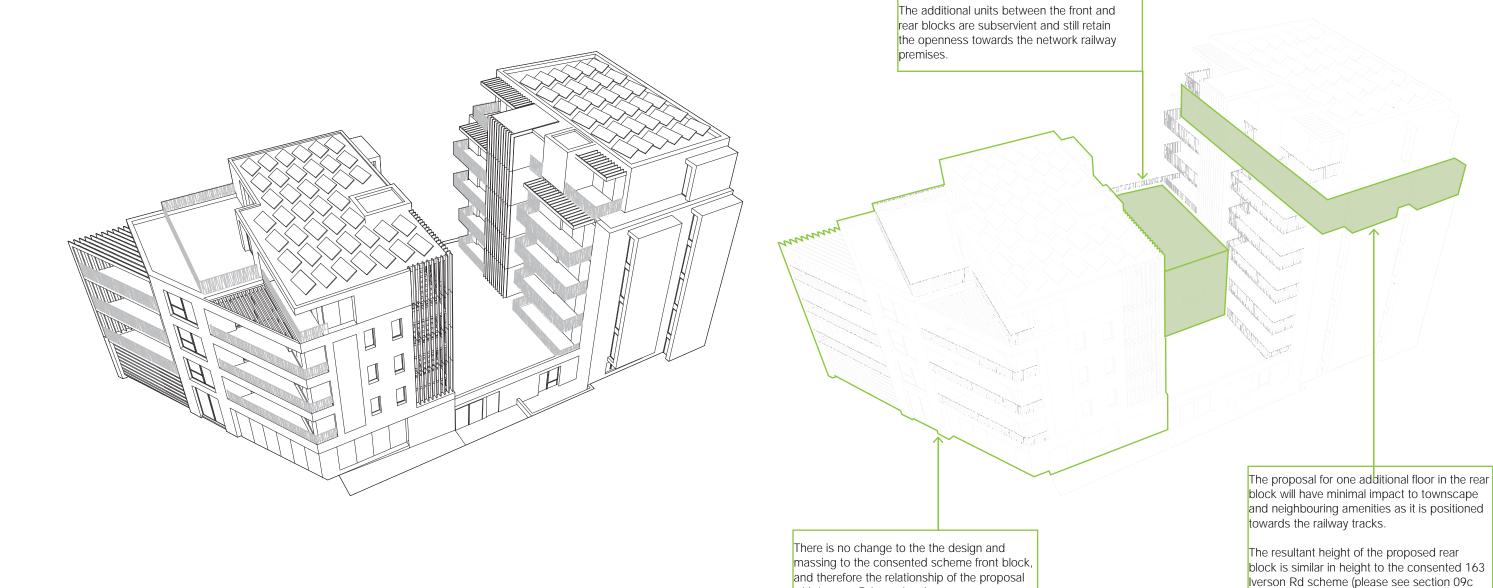


Previously Consented Massing Ref: 2013/7505/P

Proposed Massing & Variations

with Iverson Rd remains the same.

07 design variations to consented scheme

elevation in context)

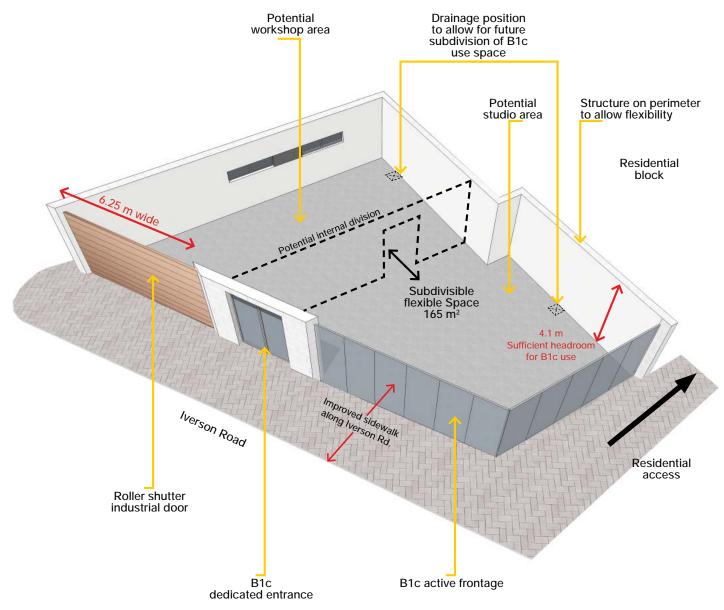

#### **Employment Space**

The design seeks to retain or enhance the physical features that will enable the flexible use of the replacement employment space by a range of businesses.

#### **Existing Building**

The existing Tyre Centre is formed of a 160 m² warehouse and a forecourt split into 2 areas on different levels comprising portacabins and parking areas accessible from 2 separate gates from Iverson Rd.

The building is setback from the street and does not encourage an active frontage or improve the surrounding public realm in a mostly residential neighbourhood. In addition, the fences and signage along Iverson Rd are detrimental to the appearance of this particular part of the street.

#### Proposed replacement

- The proposed industrial replacement space is equivalent to the existing building.
- More flexible space by designing a plain space with columns & services along the perimeter and on the ceiling.
- Flexible floor plan with potential for subdivision if required.
- Improved B1c use space provision including a taller headroom and a lighter workshop and administration facilities.
- Improvement to the street active frontage with a variety of entrances and landscape improvements in relation to the adjoining building at 163 Iverson Rd.
- Retention of industrial features such as the roller shutter access for deliveries and industrial related materials.

	OBJECTIVE	EVICTING DUU DING	DDODOGED DITH DING	FLEXIBILITY
	ORJECTIVE	EXISTING BUILDING	PROPOSED BUILDING	FLEXIBILITY
1	Equivalent replacement floorspace.	159.4sqm GIA	165sqm GIA	increased
2	Condition	Poor condition, requires significant investment.	New, therefore mimimal maintenance costs to future tenants.	increased
3	Building specification.	Poor. Single skin solid brick walls under pitched and tiled uninsulated roof. Building services in poor condition. High running costs.	Excellent. Purpose built to achieve excellent levels of insulation and energy efficiency to minimise running costs for future tenants.	increased
4	Clear and flexible space with few supporting columns.	pporting columns. Mainly open plan workshop with columns to perimeter with wc area partitioned off.  Open plan workshop with columns to perimeter.		retained
5	Adequate floor to ceiling height.	2,950mm generally with 2,700mm to underside of mezzanine support beams.	4,100mm throughout.	increased
6	Wide doors/corridors.	Single 2,032mm x 838mm pedestrian access door with step access to plus roller shutter goods door 2,900mm x 2,610mm .  Double pedestrian doors with level access plus roller shutter goods door 3,700mm x 4,100mm.		increased
7	Loading facilities.	Via goods door only.	Via improved goods door only.	increased
8	Natural light.	Poor. No natural lighting.	Good. Curtain wall glazing to Iverson Rd frontage.	increased
9	Availability of range of unit sizes.	Single unit, building services do not allow subdivision.  Designed to allow for future subdivision to suit a range of businesses.		increased
10	Space for servicing by/parking of commercial vehicles.	Good parking provision for light commercial vehicles on forecourt, step in site levels does not allow for turning of HGV's.	Development to be car free with servicing from Iverson Road in accordance with advice from highways officer.	reduced







08
employment
light industrial
replacement space