


LAND SECURITIES

# **O2 Shopping Centre, London NW3** External banner signs

Application for Advertisement Consent

### AIR

## **O2 Shopping Centre, London NW3** Site plan

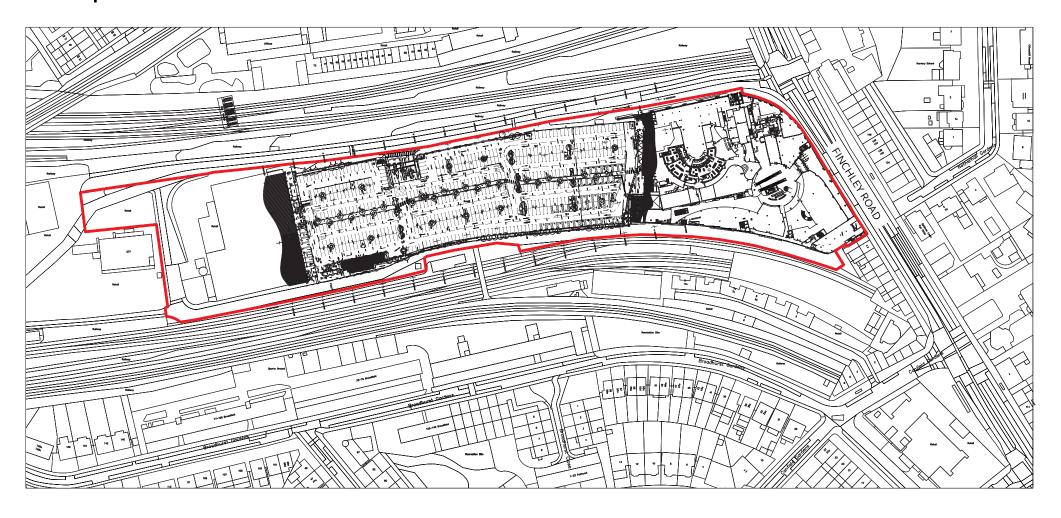

SCALE 1:2500

SITE BOUNDARY LINE -





## Front (Finchley Road) Existing/previous



Image shows previous banner signs on Finchley Road facade which have been now removed to be replaced by new proposed banner signs on same column locations.

### PLANNING

Project: O2 Finchley Road Client: Land Securities

Drawing No: N/A

Drawing Title: Finchley Road - facade

Date: 20/05/2014 Scale: N/A

## Front (Finchley Road)

### As before

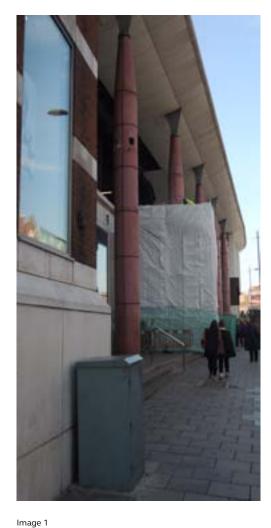




Image 2

Image 1 shows previous banner signs removed from columns prior to commencement of facade development works as shown in image 2.

### PLANNING

Project: O2 Finchley Road Client: Land Securities

Drawing No: N/A

Drawing Title: Finchley Road - facade

Date: 20/05/2014

Scale: N/A

## Front (Finchley Road)

## Proposed banners



### BN\_01-BN\_05. Banner signs

1000 x 3000mm approx. Quantity: x5 off

Double sided banner signs from external grade high-quality banner PVC. Banners secured to existing columns with appropriate fixings to satisfy wind-loading requirements.

Banner signs to be illuminated via light units mounted in soffit. Illumination to wash down outer face of each banner sign.

LED Illumination. 240 V 13amp power required at location.

All illumination will be static and no more than 540 candelas per square metre.

Please note logos shown are for illustration purposes only. Graphic content of banners will vary.

### **PLANNING**

Project: O2 Finchley Road

Drawing No: N/A

Drawing Title: Finchley Road - proposed

Date: 20/05/2014

Scale: N/A

## Front (Finchley Road) – plan Proposed new sign locations



### BN\_01-BN\_05. Banner signs

1000 x 3000mm approx. Quantity: x5 off

Double sided banner signs from external grade high-quality banner PVC. Banners secured to existing columns with appropriate fixings to satisfy wind-loading requirements.

Banner signs to be illuminated via light units mounted in soffit. Illumination to wash down outer face of each banner sign.

LED Illumination. 240 V 13amp power required at location.

All illumination will be static and no more than 540 candelas per square metre.

### PLANNING


Project: O2 Finchley Road Client: Land Securities

Drawing No: N/A

Drawing Title: Finchley Road - plan

Date: 20/05/2014 Scale: 1:1000

## Front (Finchley Road) – elevation Proposed new sign locations

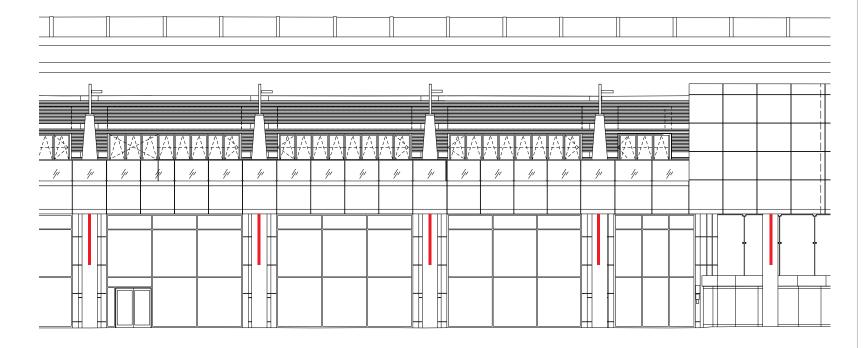

### BN\_01-BN\_05. Banner signs

1000 x 3000mm approx. Quantity: x5 off

Double sided banner signs from external grade high-quality banner PVC. Banners secured to existing columns with appropriate fixings to satisfy wind-loading requirements.

Banner signs to be illuminated via light units mounted in soffit. Illumination to wash down outer face of each banner sign.

LED Illumination. 240 V 13amp power required at location.

All illumination will be static and no more than 540 candelas per square metre.

### **PLANNING**

Project: O2 Finchley Road Client: Land Securities

Drawing No: N/A

Drawing Title: Finchley Road - elevation

Date: 20/05/2014 Scale: 1:100

© Air Design 2014

### Front (Finchley Road) - section

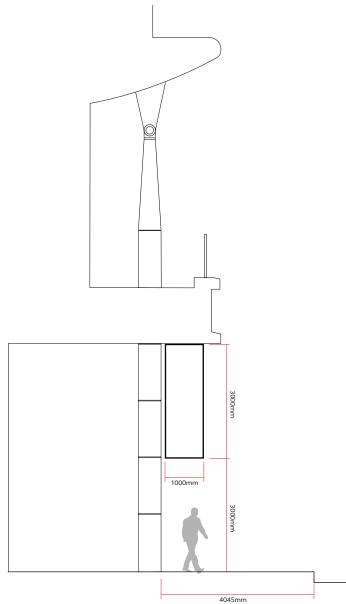




Image for reference purposes

### BN\_01-BN\_05. Banner signs

1000 x 3000mm approx. Quantity: x5 off

Double sided banner signs from external grade high-quality banner PVC. Banners secured to existing columns with appropriate fixings to satisfy wind-loading requirements.

Banner signs to be illuminated via light units mounted in soffit. Illumination to wash down outer face of each banner sign.

LED Illumination. 240 V 13amp power required at location.

All illumination will be static and no more than 540 candelas per square metre.

Please note logos shown are for illustration purposes only. Graphic content of banners will vary.

### PLANNING

Project: O2 Finchley Road

Drawing No: N/A

Drawing Title: Finchley Road - section

Date: 20/05/2014 Scale: 1:100

## Rear (Car park) – existing



Image shows existing rear facade columns.

### PLANNING

Project: O2 Finchley Road

Drawing No: N/A

Drawing Title: Car park - existing

Date: 20/05/2014 Scale: N/A

## Rear (Car park) - proposed



BN\_06-BN\_09. Banner signs

1000 x 3000mm approx. Quantity: x4 off

Double sided banner signs from external grade high-quality banner PVC. Banners secured to existing columns with appropriate fixings to satisfy wind-loading requirements.

Banner signs to be illuminated via external light units. Illumination to wash outer face of each banner sign.

LED Illumination. 240 V 13amp power required at location.

All illumination will be static and no more than 540 candelas per square metre.

Please note logos shown are for illustration purposes only. Graphic content of banners will vary.

### **PLANNING**

Project: O2 Finchley Road

Drawing No: N/A


Drawing Title: Car park - proposed

Date: 20/05/2014

Scale: N/A

## Rear (Car park)

## Proposed new sign locations

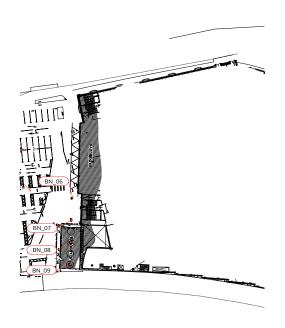



### BN\_06-BN\_09. Banner signs

1000 x 3000mm approx. Quantity: x4 off

Double sided banner signs from external grade high-quality banner PVC. Banners secured to existing columns with appropriate fixings to satisfy wind-loading requirements.

Banner signs to be illuminated via external light units. Illumination to wash outer face of each banner sign.

LED Illumination. 240 V 13amp power required at location.

All illumination will be static and no more than 540 candelas per square metre.



11

Project: O2 Finchley Road Client: Land Securities


Drawing No: N/A

Drawing Title: Car park – plan
Date: 20/05/2014

Date: 20/05/2014 Scale: 1:1000



## Rear (Car park) – elevation Proposed new sign locations

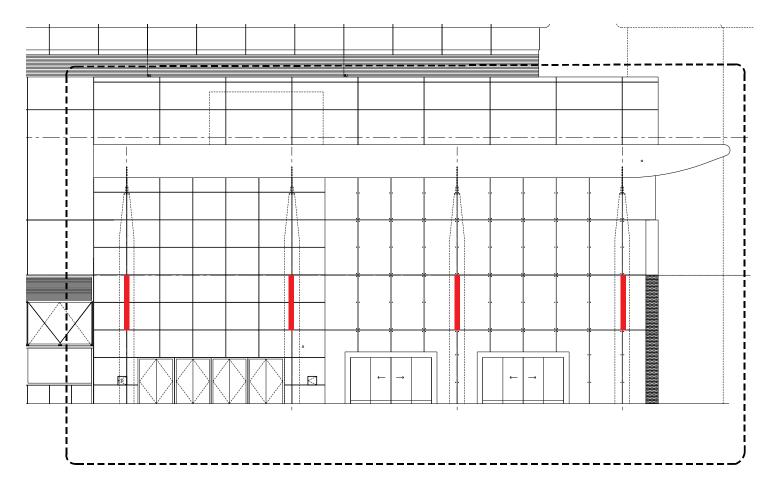

### $BN\_06\text{-}BN\_09\text{.}\ Banner\ signs$

1000 x 3000mm approx. Quantity: x4 off

Double sided banner signs from external grade high-quality banner PVC. Banners secured to existing columns with appropriate fixings to satisfy wind-loading requirements.

Banner signs to be illuminated via external light units. Illumination to wash outer face of each banner sign.

LED Illumination. 240 V 13amp power required at location.

All illumination will be static and no more than 540 candelas per square metre.

### PLANNING

12

Project: O2 Finchley Road Client: Land Securities

Drawing No: N/A

Drawing Title: Car park - elevation

Date: 20/05/2014 Scale: 1:100

## Rear (Car park) Lamp post banners - existing



Image shows existing lamp posts to which car park banner signs will be fixed.

### **PLANNING**

Project: O2 Finchley Road

Drawing No: N/A

Drawing Title: Lamp post banners - existing

13

Date: 20/05/2014

Scale: N/A

## Rear (Car park) Lamp post banners Proposed banners



CPB\_01-CPB\_42. Car park banner signs 500 x 1500mm approx.
Quantity: x42 off

Double sided printed banners on external grade mesh/perforated banner material to ensure appropriate wind-loading. Banners securely fixed with appropriate fixings to existing lamp posts. Contractor/engineer to advise.

Banner content will vary and may include tenant logos, special events and promotions.

Please note logos shown are for illustration purposes only. Graphic content of banners will vary.

### **PLANNING**

Project: O2 Finchley Road
Client: Land Securities

Drawing No: N/A


Drawing Title: Lamp post banners - proposed

Date: 20/05/2014

Scale: N/A

# Rear (Car park) Lamp post banners Proposed new sign locations



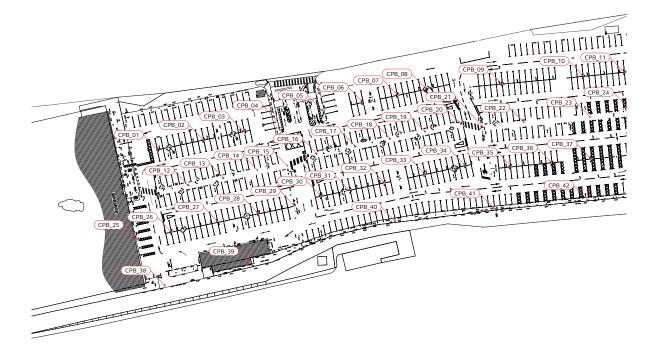

CPB\_01-CPB\_42. Car park banner signs 500 x 1500mm approx. Quantity: x42 off

Double sided printed banners on external grade mesh/perforated banner material to ensure appropriate wind-loading. Banners securely fixed with appropriate fixings to existing lamp posts. Contractor/engineer to advise.

Banner content will vary and may include tenant logos, special events and promotions.

Please note logos shown are for illustration purposes only. Graphic content of banners will vary.

### PLANNING

Project: O2 Finchley Road Client: Land Securities


rawing No: N/A


Drawing Title: Lamp post banners - proposed

15

Date: 20/05/2014 Scale: 1:1000

## Rear (Car park) Lamp post banners – detail Proposed banners

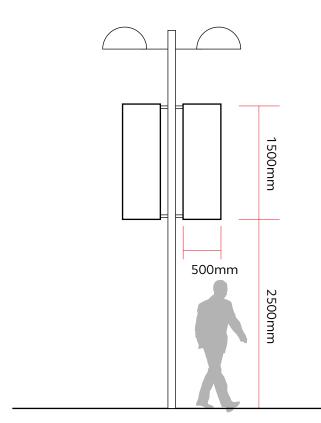

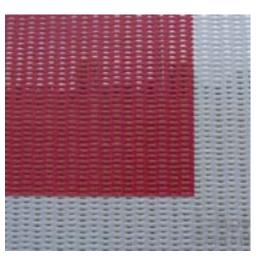

Mesh banner material allows air to flow through, reducing wind load by up to 50%



### CPB\_01-CPB\_42. Car park banner signs 500 x 1500mm approx.

Quantity: x42 off

Double sided printed banners on external grade mesh/perforated banner material to ensure appropriate wind-loading. Banners securely fixed with brackets to existing pillars. Contractor/engineer to advise.

Banner content will vary and may include tenant logos, special events and promotions.

### PLANNING

16

Project: O2 Finchley Road Client: Land Securities

Drawing No: N/A

Drawing Title: Lamp post banners - detail

Date: 20/05/2014 Scale: 1:50

## **Banner signs** Background colour





### **Test backgrounds**

MEBA



White background

MEBASE



Graphite grey background

The proposed signage scheme displays tenant logos on a black background. This allows the various logos to be legible and impactful without the banner signs themselves appearing overpowering on the building.

A white background would appear harsher and would tend to dominate the façade, in addition to requiring an increased maintenance regime.

Alternative backgrounds using more muted colours; grey or 'stone' do not provide a uniformly suitable background for all logos, have reduced impact and will often not satisfy tenant logo guidelines.

The black background creates a more sophisticated impression and offers a consistent 'neutral' background which restricts and controls the amount of colour on the signs whilst still allowing tenants logos to be correctly displayed either as white logos, or in the appropriate brand colour.

'Stone'/'brick' background

### **PLANNING**


Project: O2 Finchley Road Client: Land Securities

Drawing No: N/A


Drawing Title: Banners - Background colour

Date: 20/05/2014 Scale: N/A


# **Proposed banners**Content guidance

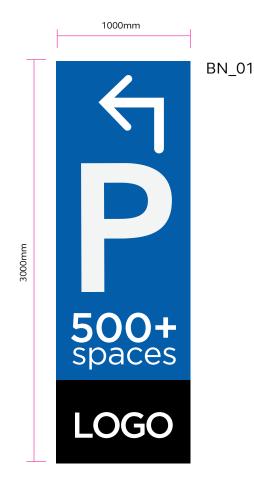

Banner type 1: Car park directional

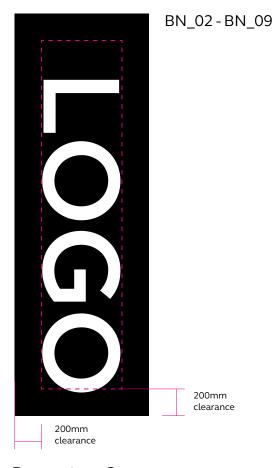

**Banner type 2**: Tenant logo to fit within guidelines

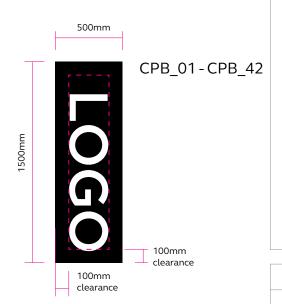

Banner type 3 (lamp posts)

#### Banner sign content

Banner signs are double sided and each side will display varied and changeable content including car park information, tenant logos and special promotions.

Tenant logo proportions will be controlled with guidelines as shown.

### **PLANNING**

Project: O2 Finchley Road Client: Land Securities

Drawing No: N/A

Drawing Title: Banners - Content guidance

Date: 20/05/2014 Scale: N/A