

a brief description

Procter House lies in a prominent location close to the junction of Kingsway and High Holborn. Constructed in the 1960's, it comprises four inter-connecting buildings which together front both sides of Procter Street.

At its junction with High Holborn it spans Procter Street to provide a south aspect frontage along High Holborn itself.

It is this portion of Procter House that bridges Procter Street and returns to the edge of Catton Street that this proposal is concerned with.

The existing building consists of concrete construction with horizontal bands of glazing and limestone cladding. There is a large scale to the building and a strong horizontal emphasis on all sides.

Currently, Procter House is unoccupied and is falling into a state of disrepair. The retail spaces at street level are empty and the lack of public activity produces a rather bleak environment.

The proposed scheme aims to revitalise what is otherwise considered a 'blighted' neighbourhood in Bloomsbury.



EXISTING VIEW DOWN PROCTER STREET



EXCERPT OF LOCATION MAP



SKETCH VIEW OF PROPOSED BUILDING FROM HIGH HOLBORN

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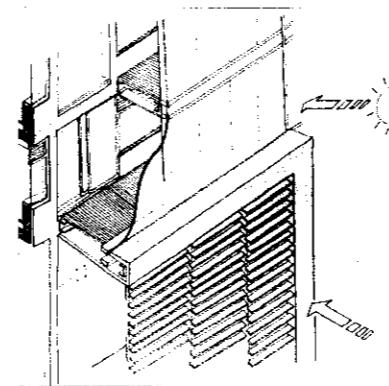
10 PROCTER STREET
INTRODUCTION

aims of this proposal

The proposal for the redevelopment of Procter House has been driven by three central principles : sustainable building and energy solutions, rejuvenation of an urban landmark and the organisation of the workplace.

sustainability

To provide natural ventilation and low energy heating and cooling.
Utilise natural daylight.
Soften the existing concrete building with more sensitive and practical materials.




landmark

Bring added value, through architecture, to the image of the building.
To respond positively to the changing urban context.
Offer the potential for a more vibrant streetscape.



workplace

Maximise office space.
Create softer environments.
Provide good comfort levels.

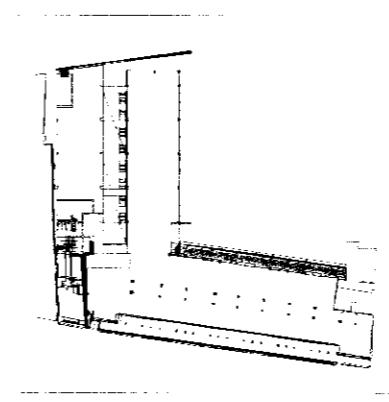

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10 PROCTER STREET
INTRODUCTION

The Proposal at Procter House

The proposed redevelopment of Procter House features predominately class A office space although it also promotes a new mix. A large retail unit is located in the basement and further 2-storey retail units face onto High Holborn and Procter Street which will be utilised by the busy area around Holborn tube station and neighbouring offices. A new wine bar and restaurant is also proposed which will enrich the surrounding environment.

The main entrance to the building shall be off Procter Street. A taxi drop off point will be provided along with a landscaped street edge which marks the entrance and offers protection from the road.

A new core is proposed to take people to both the 'west wing' towards the Catton Street side of the building and also to the wing that bridges over Procter St.

'the west wing'




The west wing is organised around a central atrium space running south to north, which has continuous featured stair traversing from 1st floor to 4th floor. The daylight from the atrium is shared by the redeveloped existing building and an additional portion of new build office. These are linked by bridges that 'fly' across the atrium. The atrium on the upper floors folds out to become a winter garden for the offices.

'the bridge wing'

The long and narrow floor plate of the Procter House would suggest that work spaces be situated along the exterior walls with a central circulation space. The current proposal turns that principle inside out. On the main bridge building the circulation is placed on the outside of the building in a "saddle bag" light weight construction or circulation galleries hung on the outside of the building. The advantage is to this is that it opens the floor plates solely to work areas, thus maximising the area usage. It also throws intense human activity to the outside of the building, quite visible to the public sector.

On the underside of the bridge building a light box and acoustic barrier is proposed that would replace the existing acoustic plane and brighten up this dark and noisy existing space. The light box then follows through to become an architectural feature for the rest of the building.

The facades are receptive to natural daylight and in some places are functioning outer layers of the double skin facades providing solar shading and preventing heat loss.

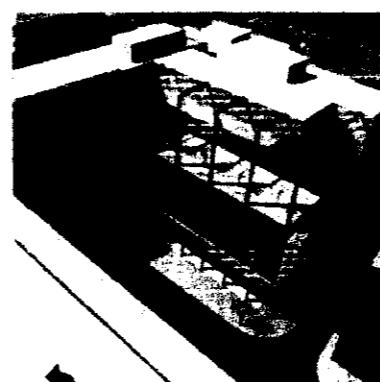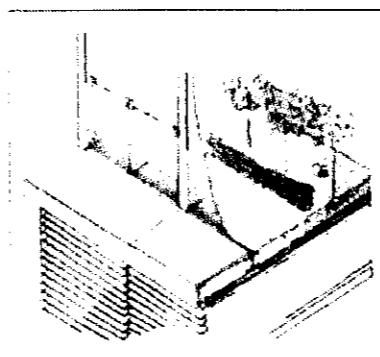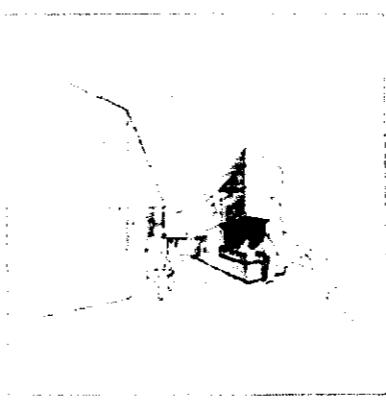


Understanding this document

What follows is a brief Site Analysis of some of the existing conditions in and around Procter House. This then leads into some conceptual diagrams which aim to provide a picture of the overall proposed scheme.

Drawings of the existing scheme and the proposed scheme are then introduced showing plans, sections and elevations.

Reports from the Mechanical & Electrical Engineer and the Structural Engineer tackle particular elements of the proposed scheme and can be found at the end of this document.

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**10 PROCTER STREET
INTRODUCTION**

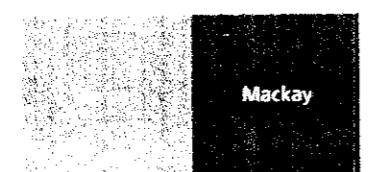10 PROCTER STREET - NET AREAS (S.M.)

DATE: 15.12.99


Rev.: 31.01.00

	PROPOSED OFFICE	PROPOSED RETAIL	PROPOSED A3	TOTAL
Basement	0	1228	336	
Ground	38	310	320	
First	254	203	87	
Second	1051	45	0	
Third	1113	45	0	
Fourth	1064	45	0	
Fifth	987	45	0	
Sixth	773	0	0	
Seventh	1084	0	0	
Eighth	1091	0	0	
	7455	1921	743	10119

Areas are approximate only.

They are based on survey drawings by KND.

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SITE PLAN

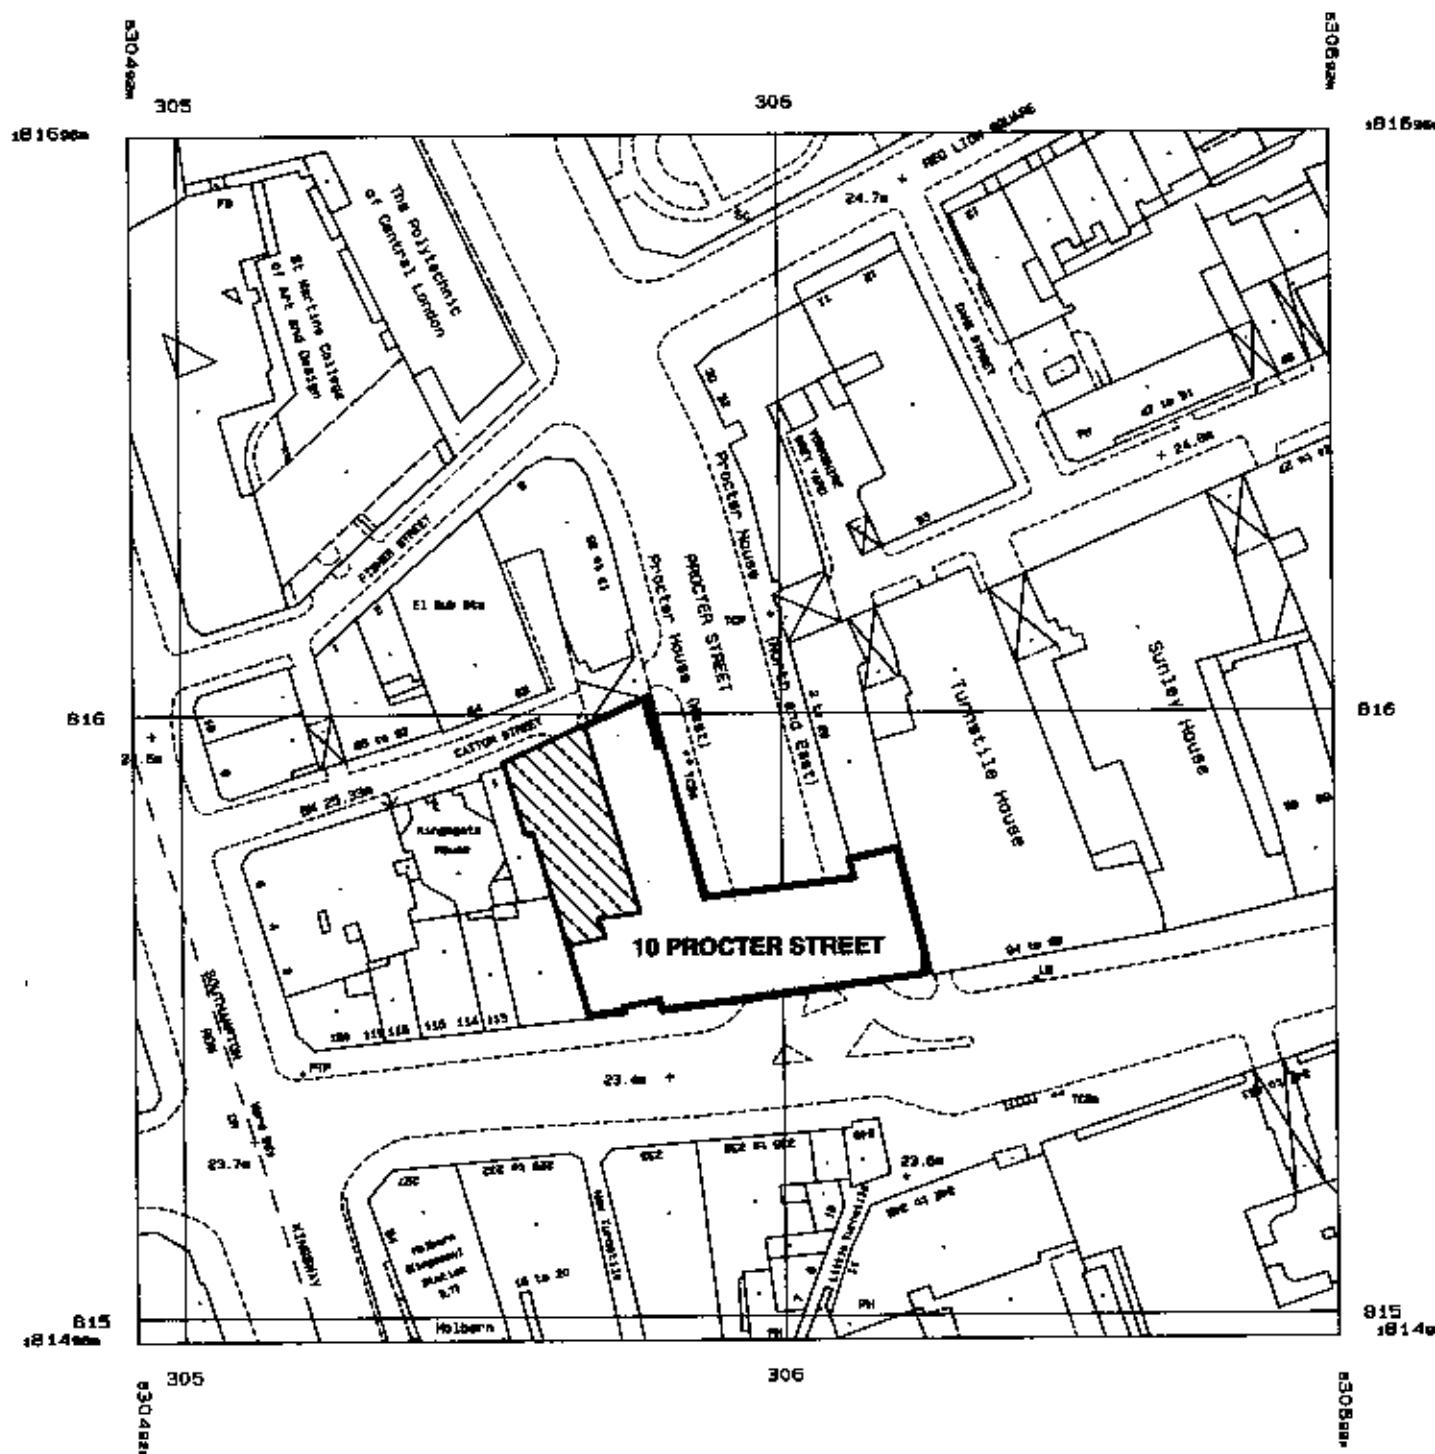KEY PLAN
NOTES

Rev. Description
DRAWING STATUS

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Job No. 10 PROCTER STREET

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Existing Proctor House Entrance On High Holborn




The Entrance And Streetscape Are Open To The Slow Moving And Congested Traffic And Consequential Vehicle Fumes.



Continuous Vehicle Congestion On High Holborn. The Stone And Glass Facade Of Proctor House Is Currently In A State Of Disrepair.

SITE ANALYSIS - EXISTING CONDITION

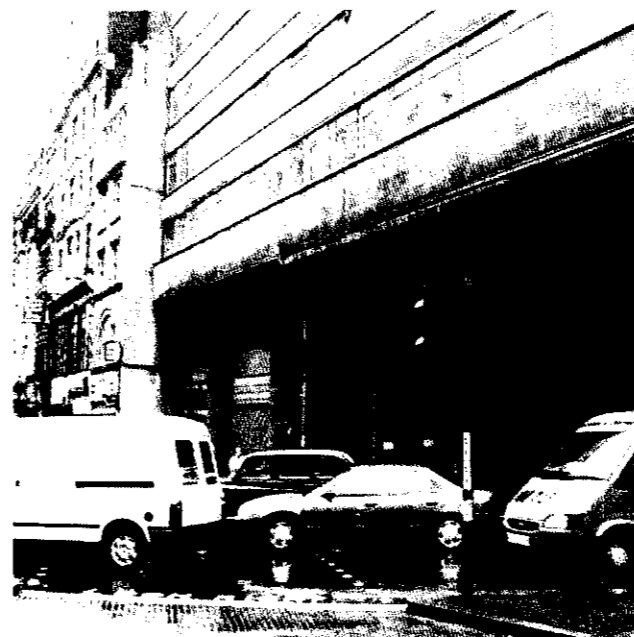

Pedestrian Crossing And Surrounding Areas Are Darkened By The Existing Building, Even In Daylight Hours.

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JOB TITLE 10 PROCTER STREET		
DRAWING TITLE PHOTO OF EXISTING SOUTH FACADE		
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Date: 21.01.00	CHECKED BY	
Drawing No.	Rev	




The underbelly of the building is dark and hazardous, especially outside daylight hours. No provision is made for a protected pedestrian environment.



The lower floors of the existing building are unengaging with the surrounding streetscape. Currently there is a strong horizontal emphasis to the facade.



View south on Procter Street. People use alternative routes rather than passing by an empty building with boarded-up shops.

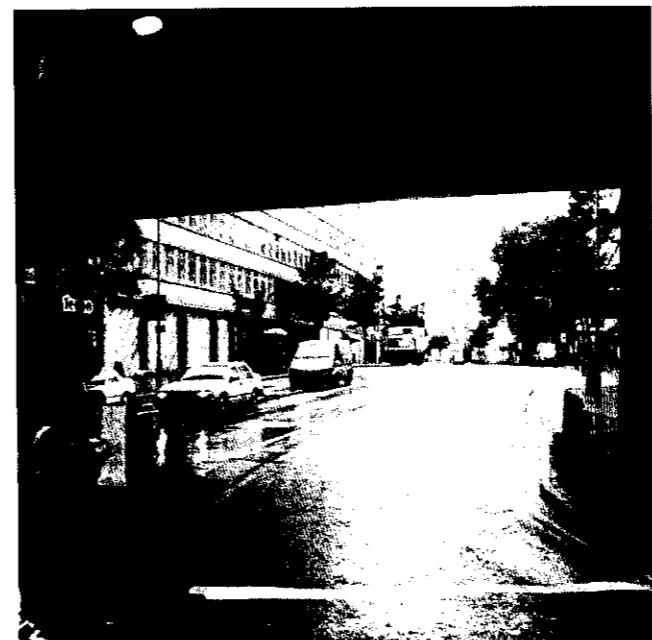

Procter Street is currently undesirable and therefore underused by pedestrians.

SITE ANALYSIS - EXISTING CONDITION


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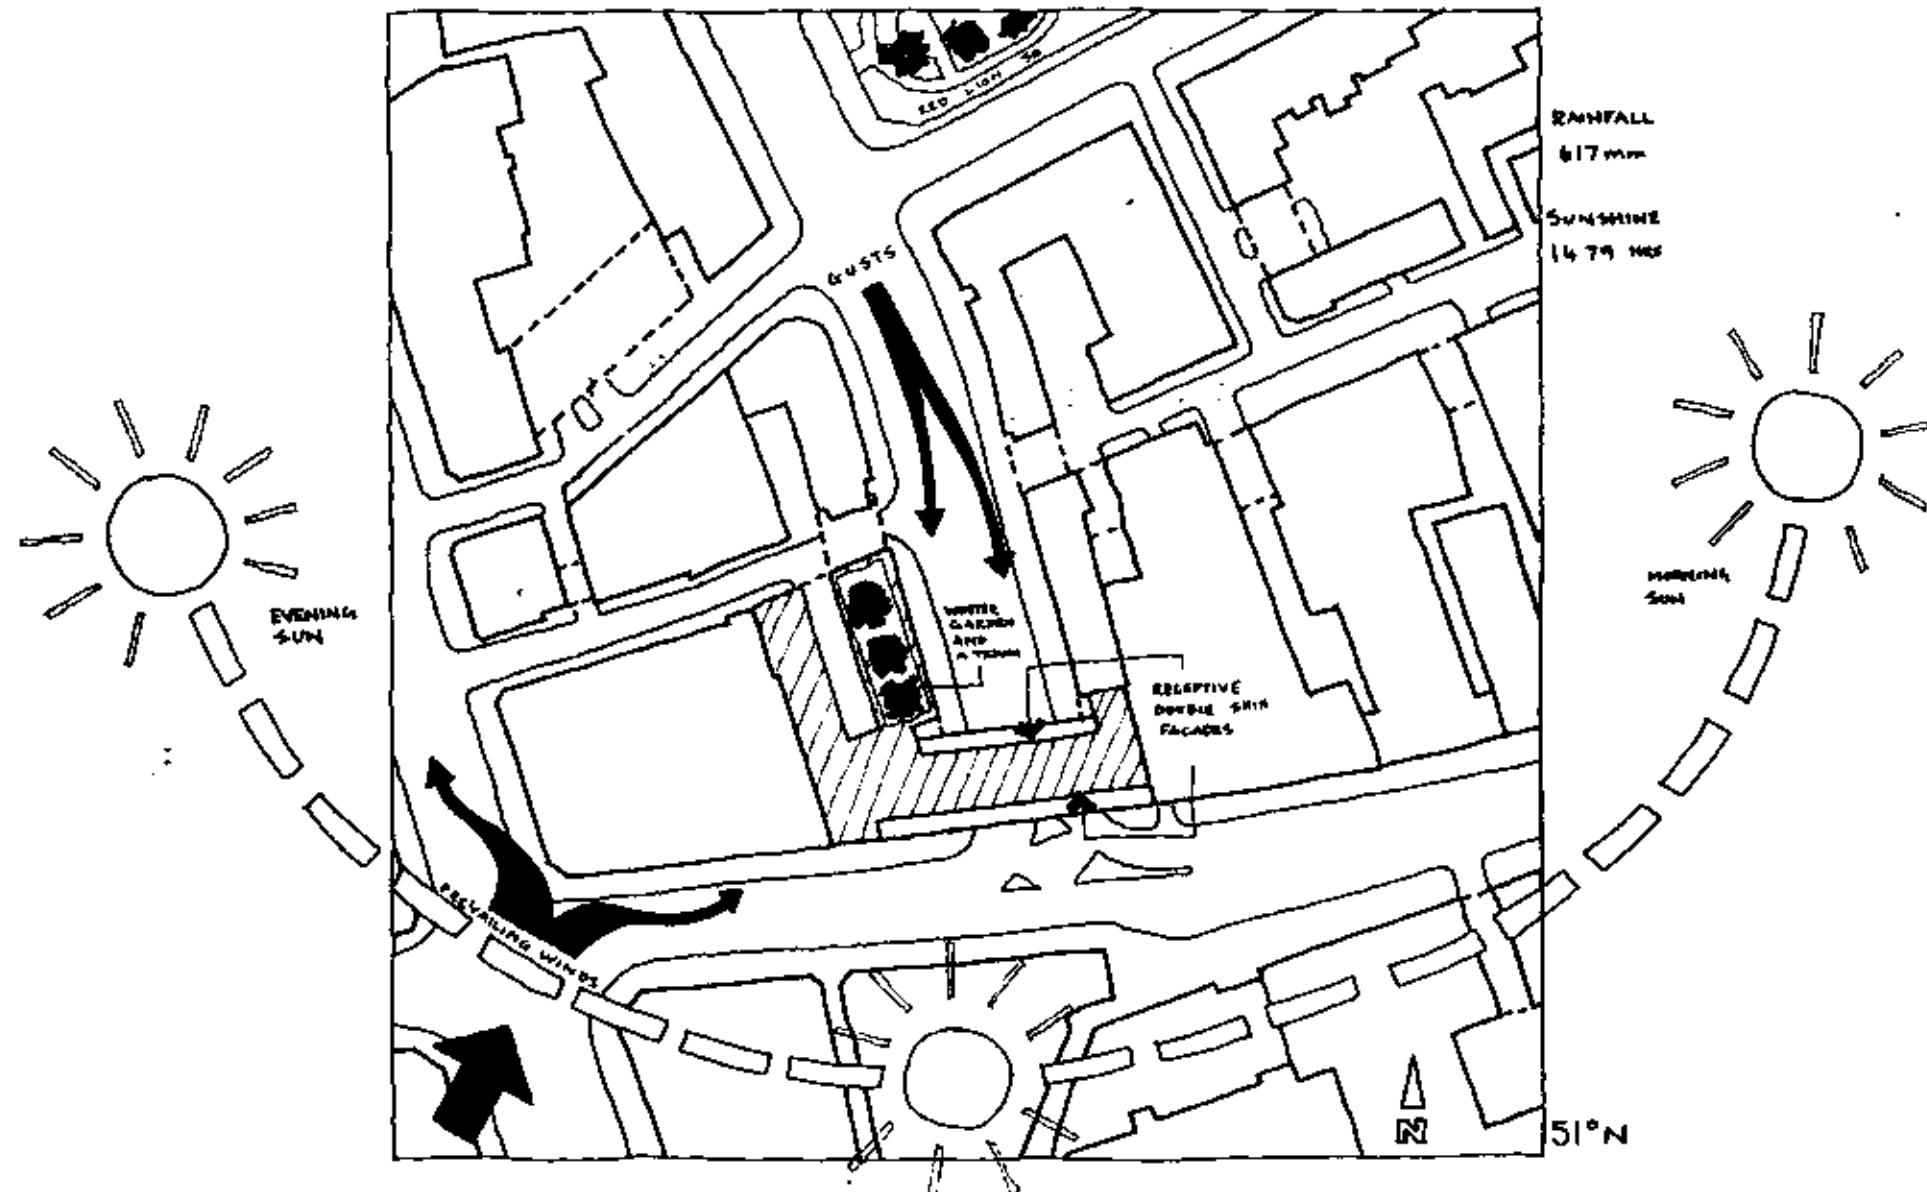
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Scale DRAWN BY

Date CHECKED BY


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FILE JOB NUMBER



SITE ANALYSIS - SOLAR PATH AND WIND DIRECTION
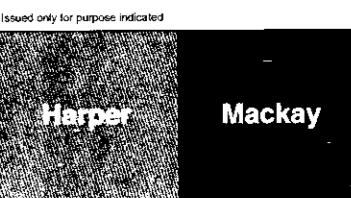
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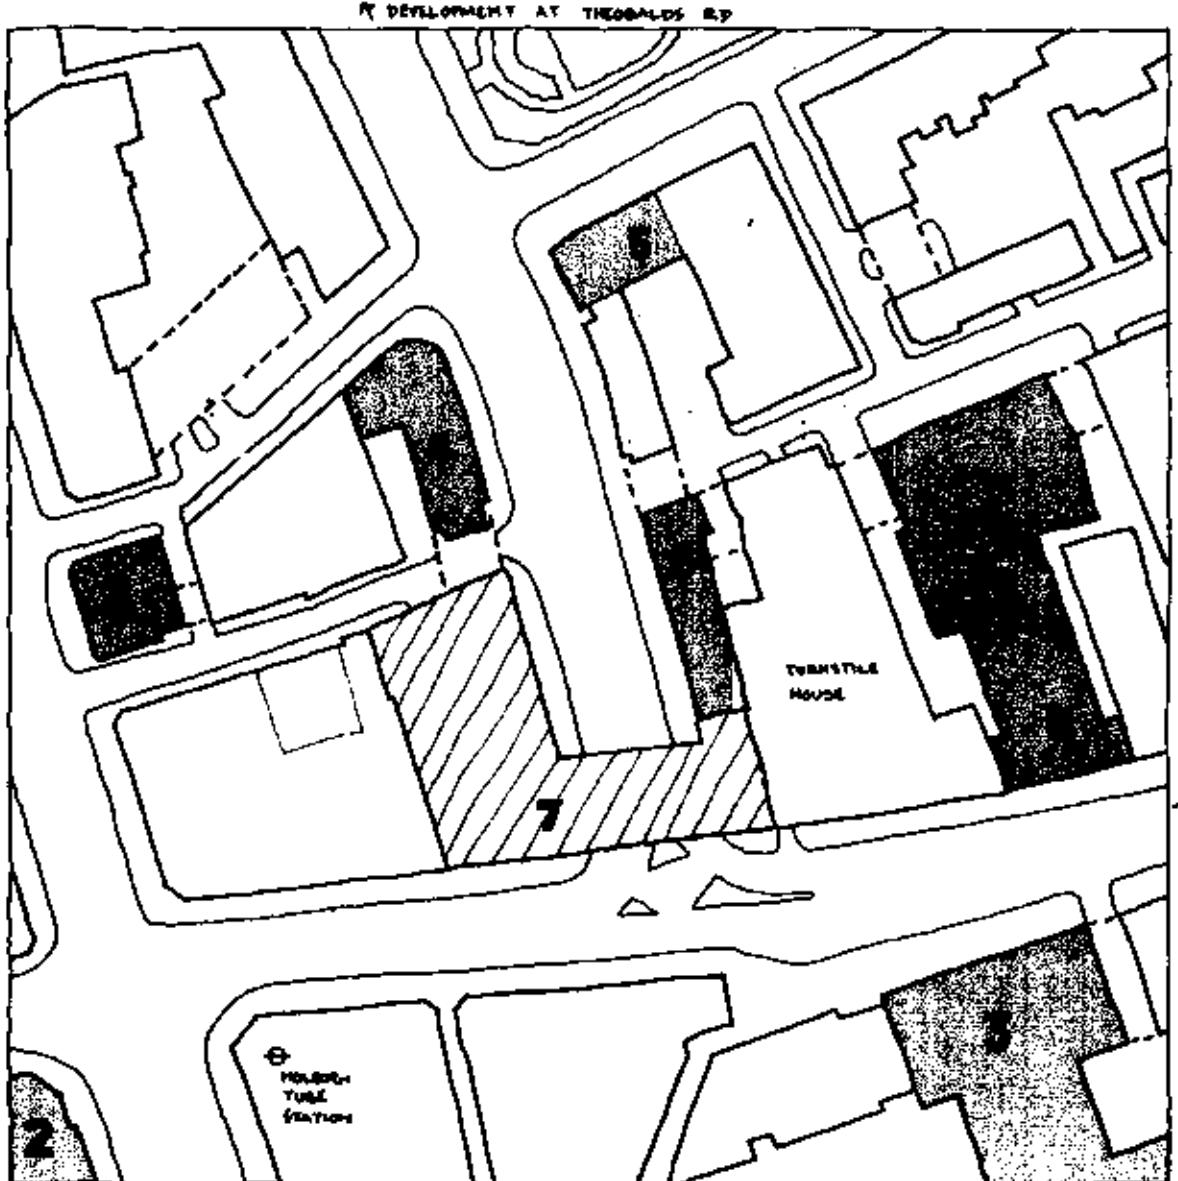
Drafter Title SITE ANALYSIS- PEDESTRIAN/ TRAFFIC ROUTES

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SITE ANALYSIS - MAIN PEDESTRIAN AND TRAFFIC ROUTES

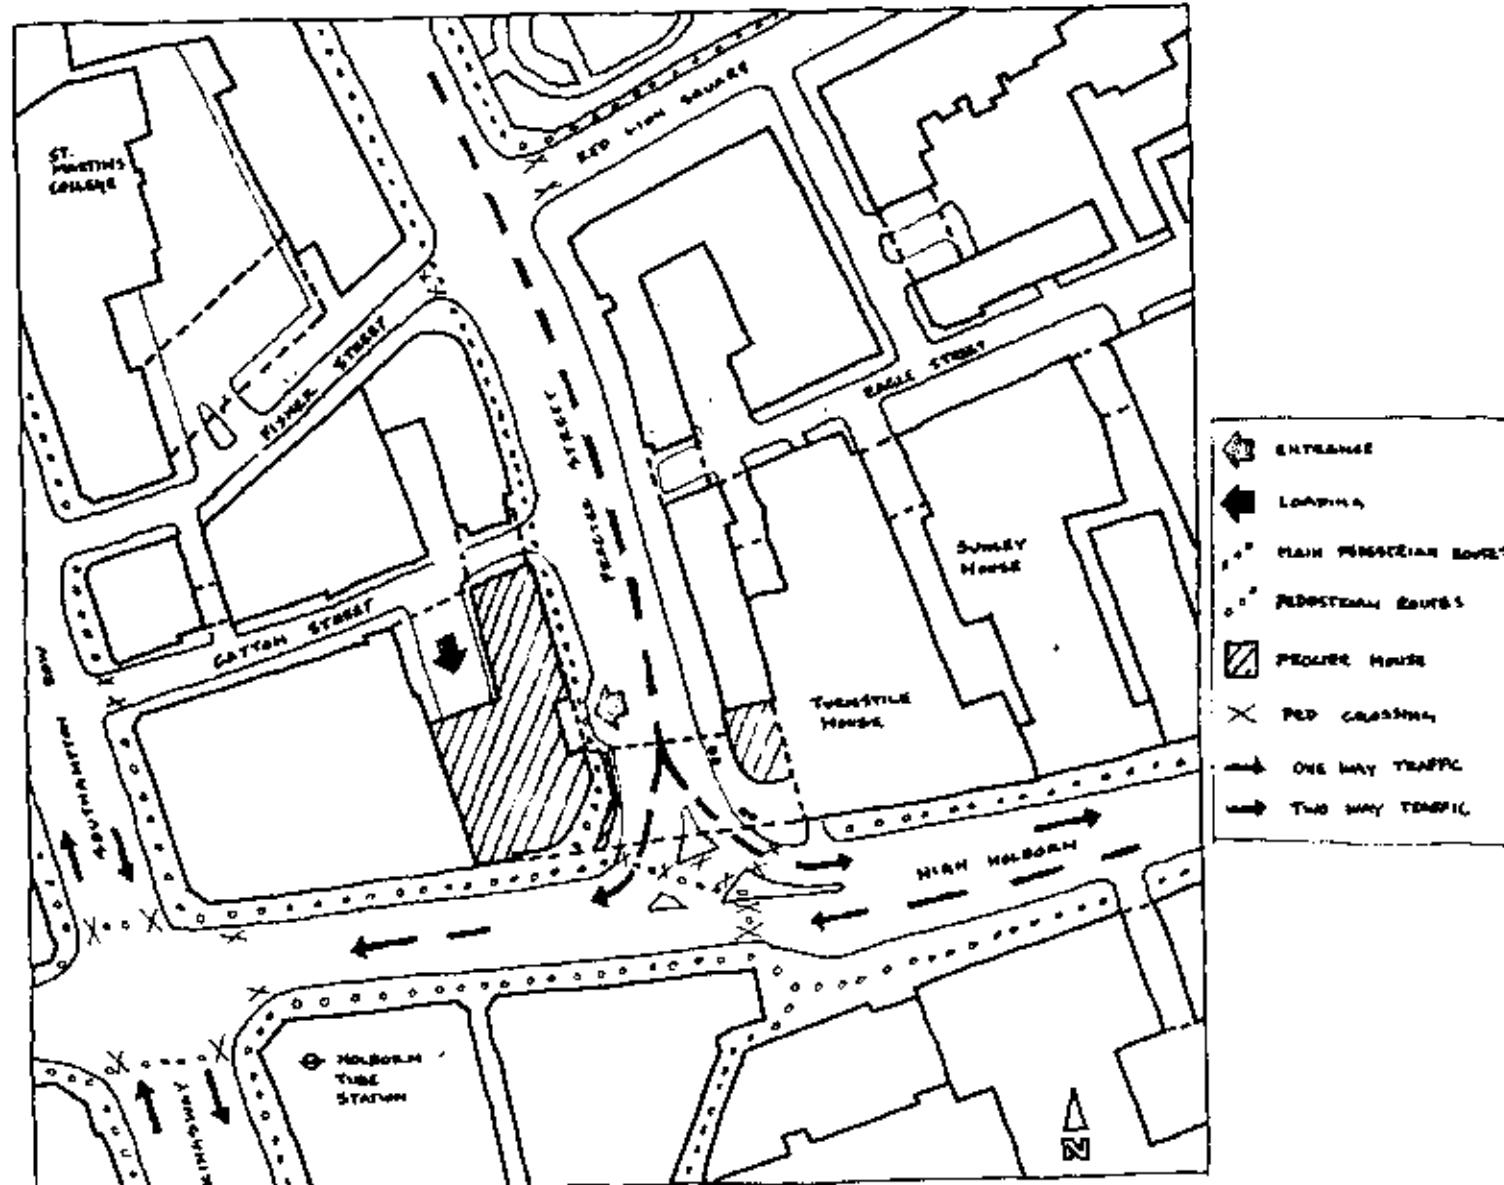By positioning the entrance on Proctor Street we extend the hubris of High Holborn and provide a more relaxed threshold.

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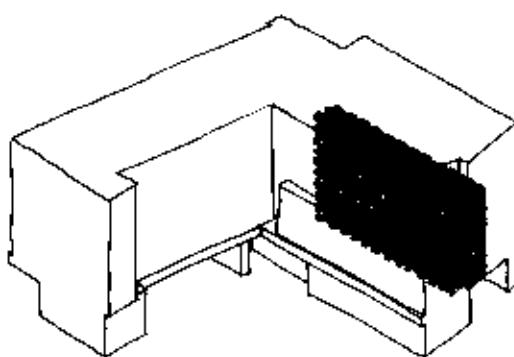


SITE ANALYSIS - SURROUNDING DEVELOPMENT


The surrounding site is undergoing substantial redevelopment. Procter House, currently vacant, has the potential to add to the surrounding density with a sustainable approach.

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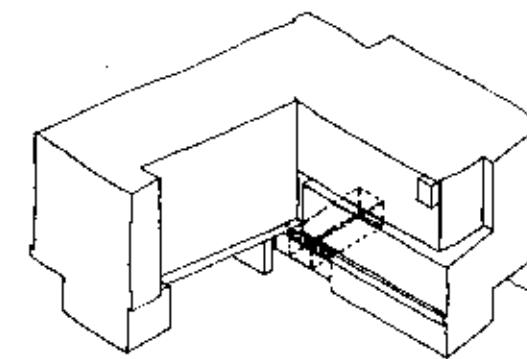
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atrium




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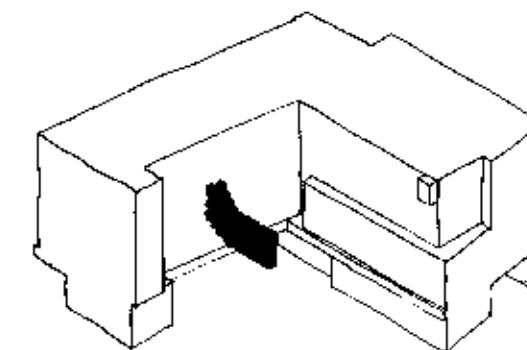
entrance

KEY PLAN

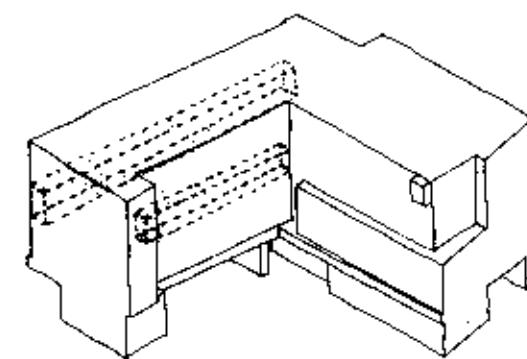
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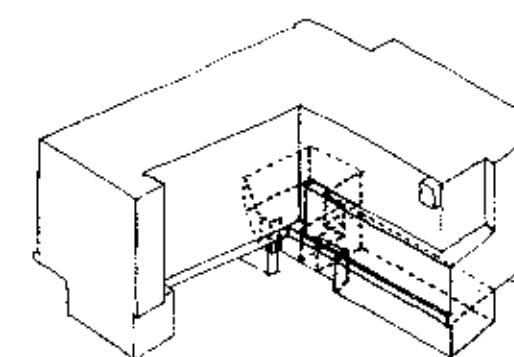
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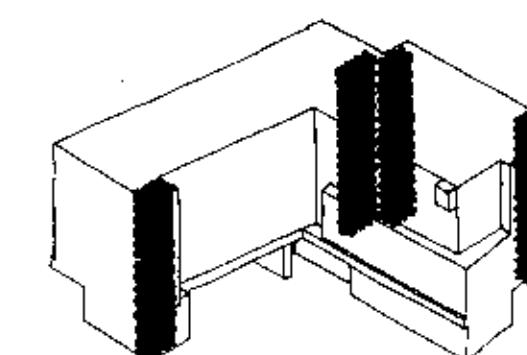
into-wall




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retail/A3

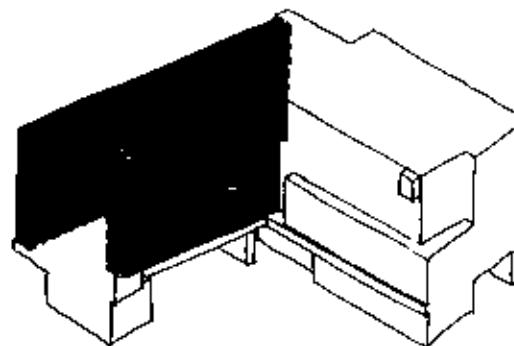



vertical cores

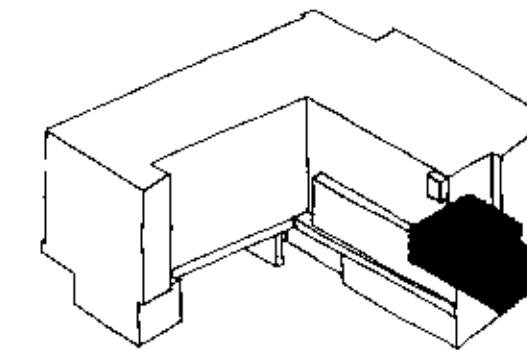

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VOLUMETRIC ORGANISATION
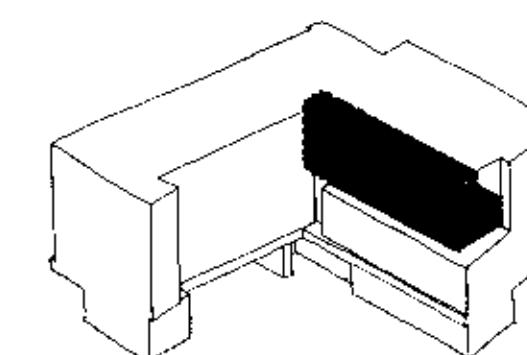
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Job Title	10 PROCTER STREET	Date
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Scale	DRAWN BY RB	RECORDED BY SA
Date	21.01.00	Re-
Drawing No. HM/691/05/01		
FILE:	JOB NUMBER: A3	

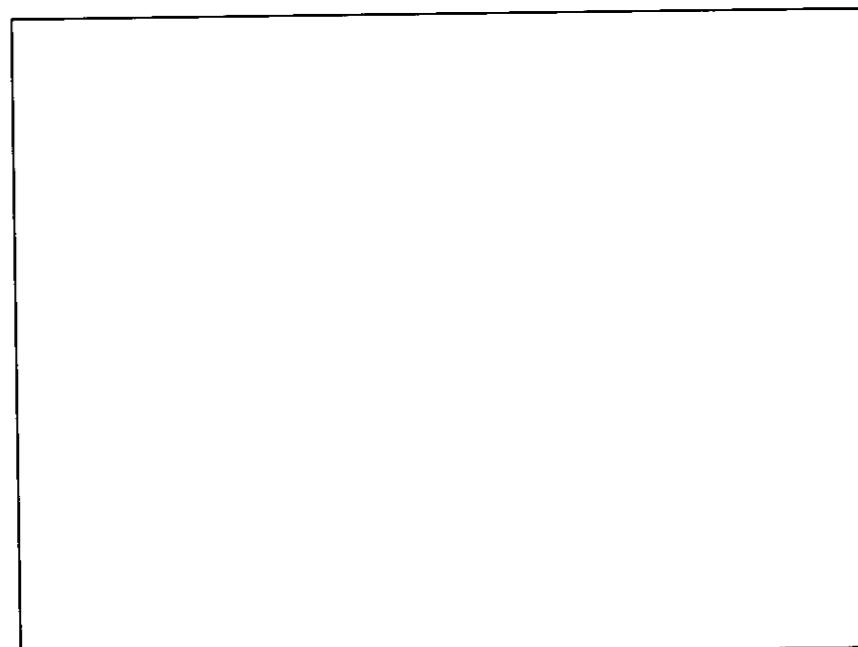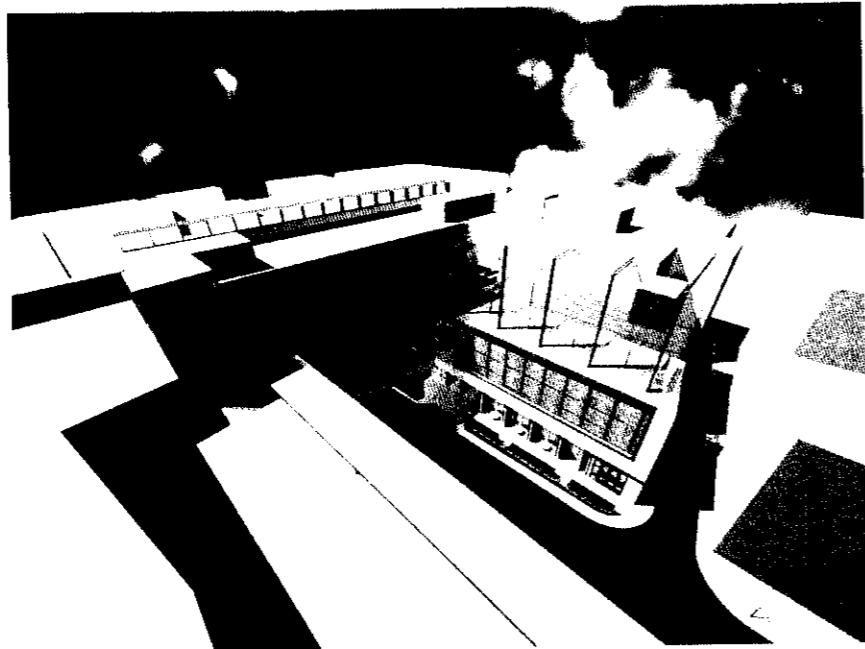

3D RENDER VIEWS

1. Aerial view overlooking procter street, showing wintergarden
2. Night view from pavement, high holborn showing lit undercroft
of proposed scheme


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3D RENDER VIEWS

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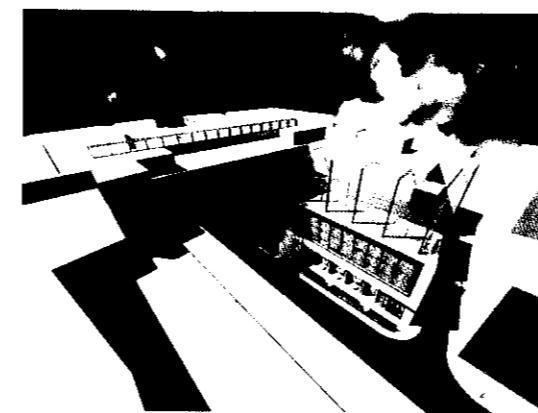
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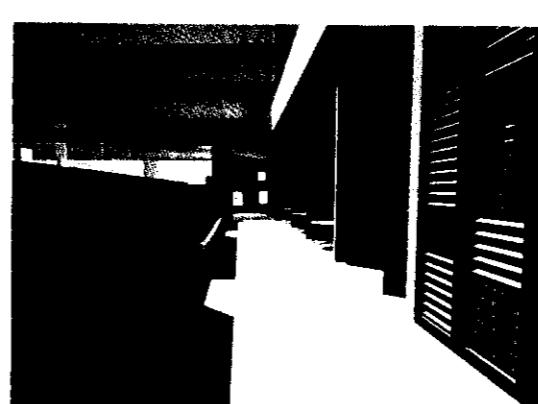
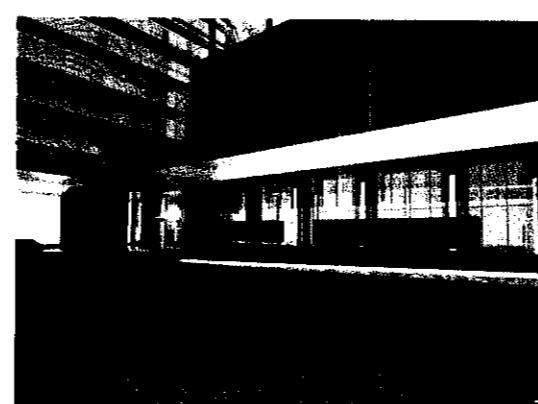


3D RENDER VIEWS

1. Procter Street South
2. Aerial View, Procter Street
3. High Holborn Street View
4. 'Info-Wall' - Internal Street
5. 'Info-Wall' - High Holborn
6. 'Info-Wall' - Procter Street
7. Protective Screen- Procter Street
8. Esplanade

KEY PLAN

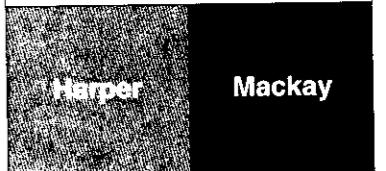NOTES



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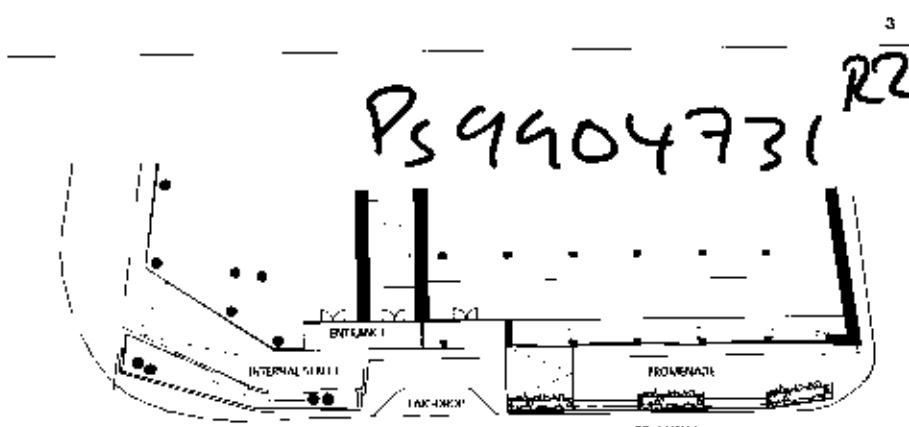
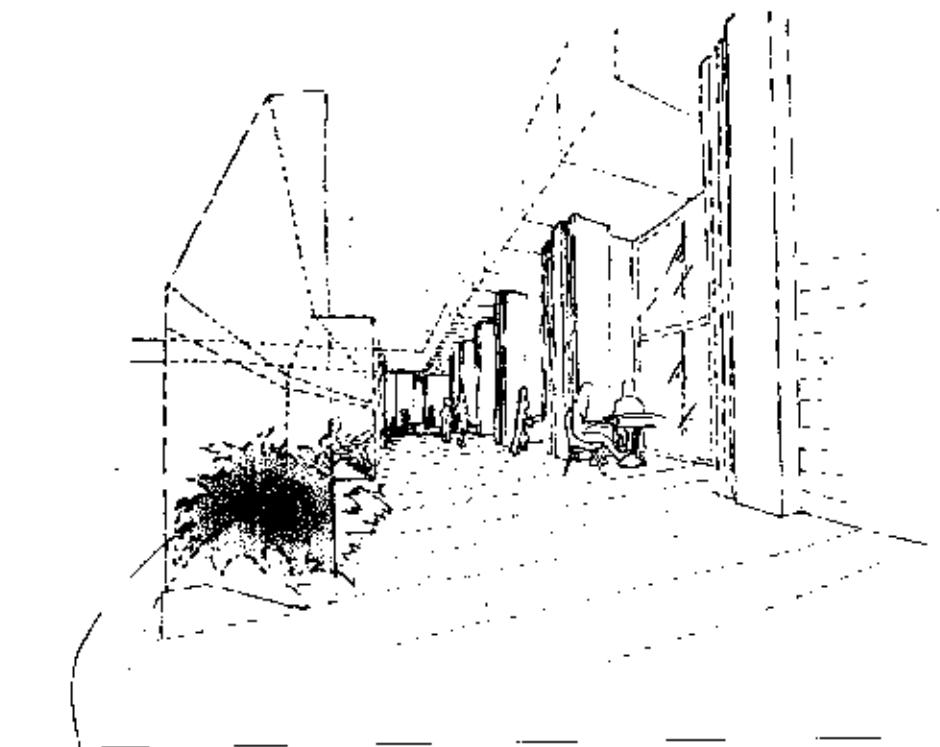
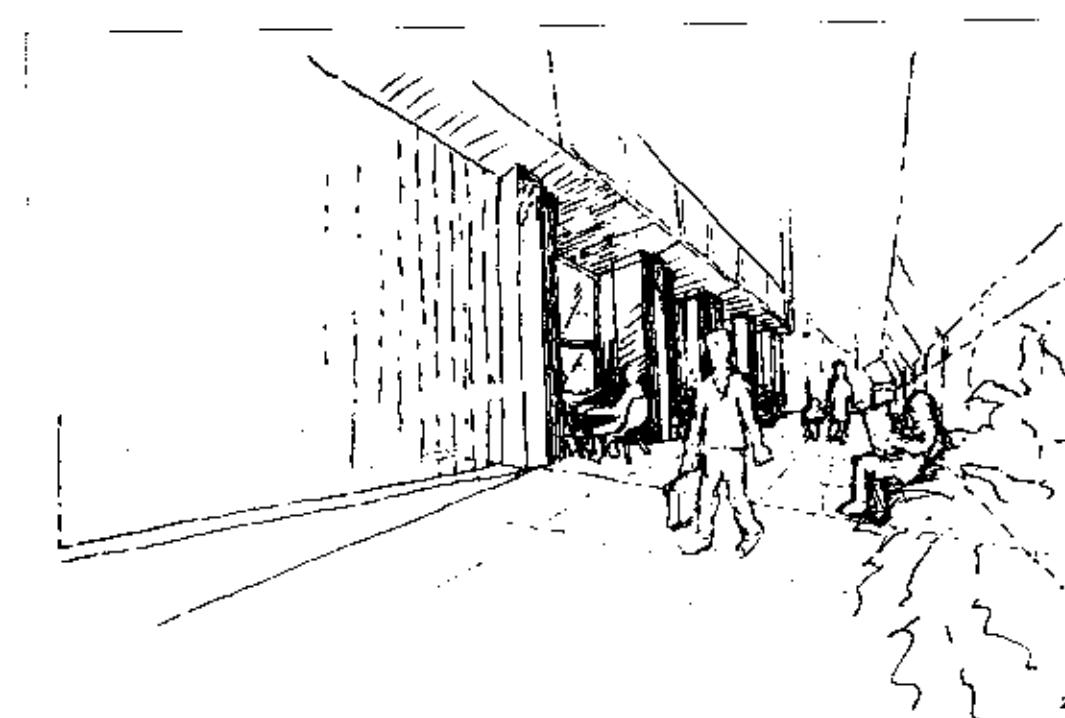
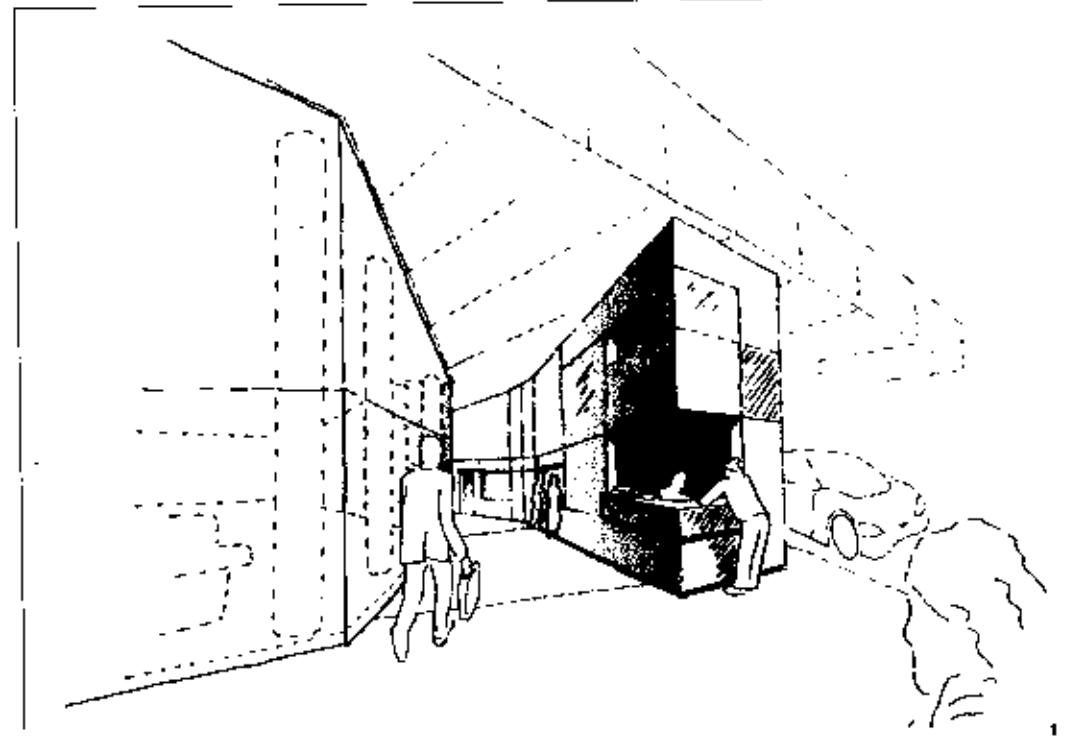
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DRAWING TITLE	3D RENDER VIEWS 2
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STREETSCAPE

In order to compensate for the ordinarily traffic-choked approach to Proctor House consideration has been taken to extend the 'skin' of the building to accommodate for pedestrian activity. This is achieved in two ways:

THE INTERNAL STREET

The addition of an 'INFO-WALL' provides a sonic and visual barrier to the traffic in addition to allowing the insertion of programmatic contents within its thickness. These may consist of short-time-based programs alongside interactive media or art installations that will enliven a currently undesirable and dormant zone, see fig. 1.

THE PROMENADE

The addition of a 'MEDIA-WALL' will perform the task of reducing wind speeds within the pedestrian zone. A manipulation of topography will trigger events within the semi-enclosed sheltered promenade engaging pedestrians with the neighbouring programs and allowing areas for seating and planting. Externally it will provide a blank canvas for artists to produce media based works that will enrich the streetscape, see figs. 2, 3.

KEY PLAN

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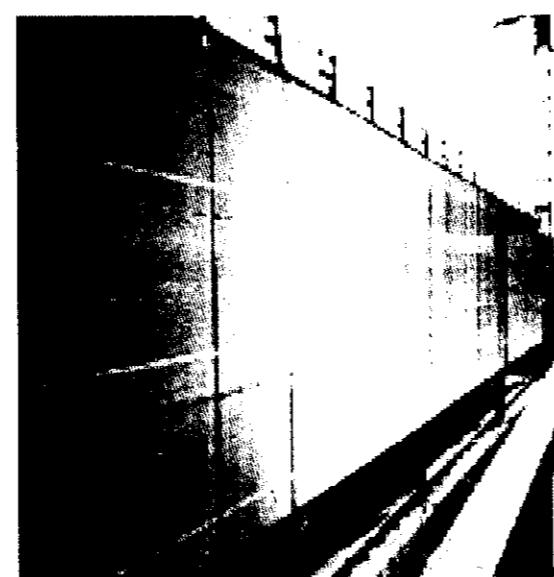
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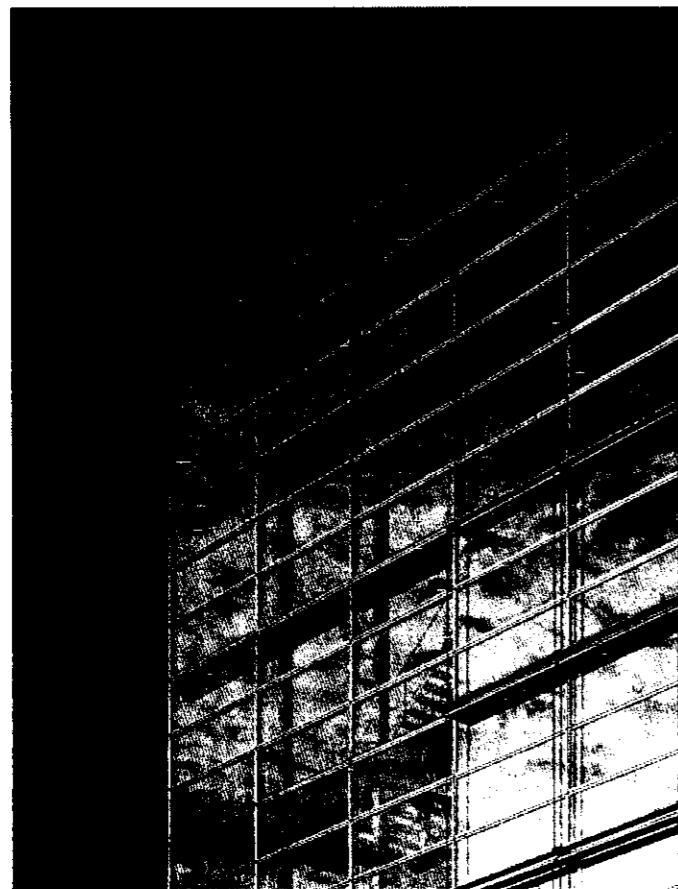
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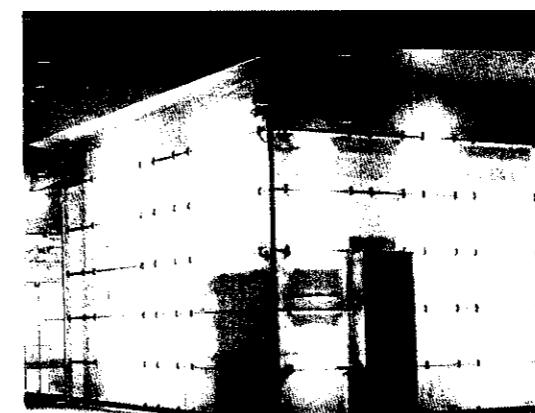
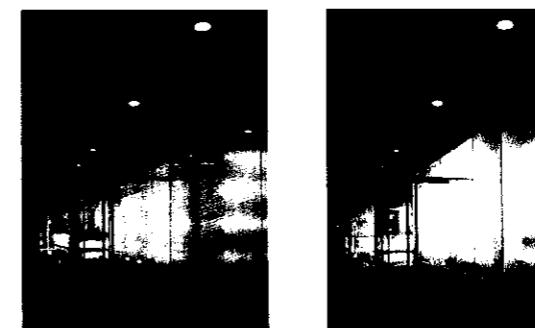
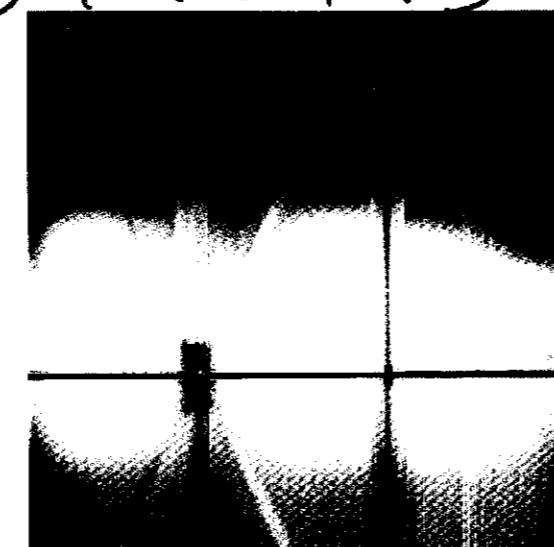


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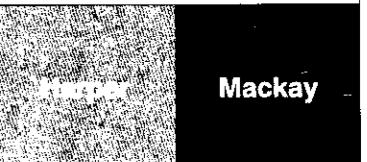


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FACADE TREATMENT


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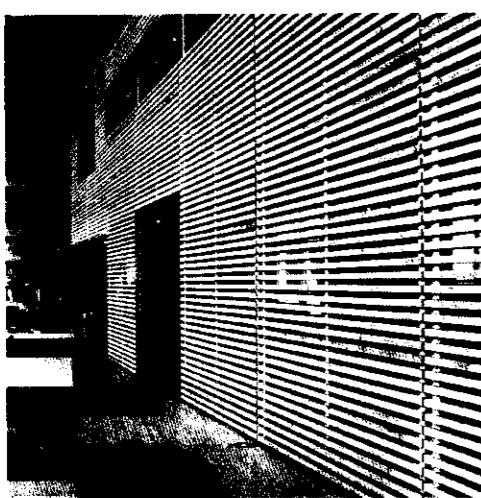
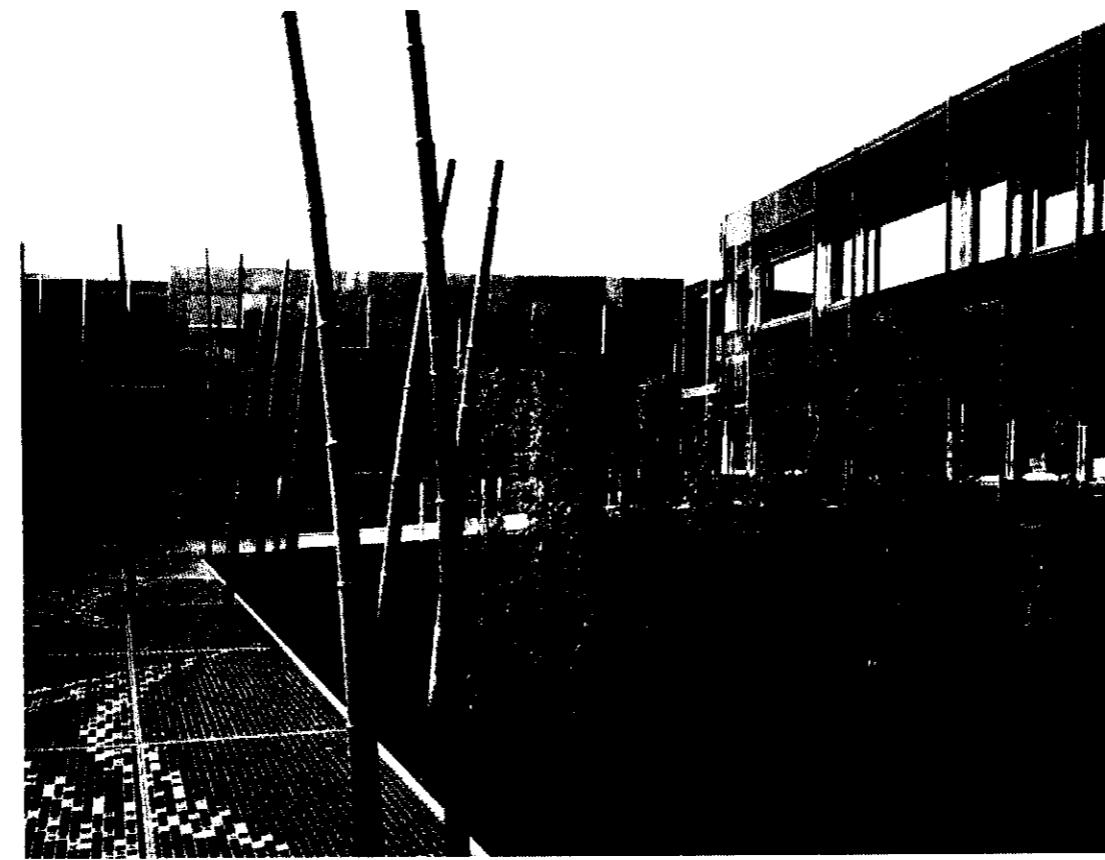
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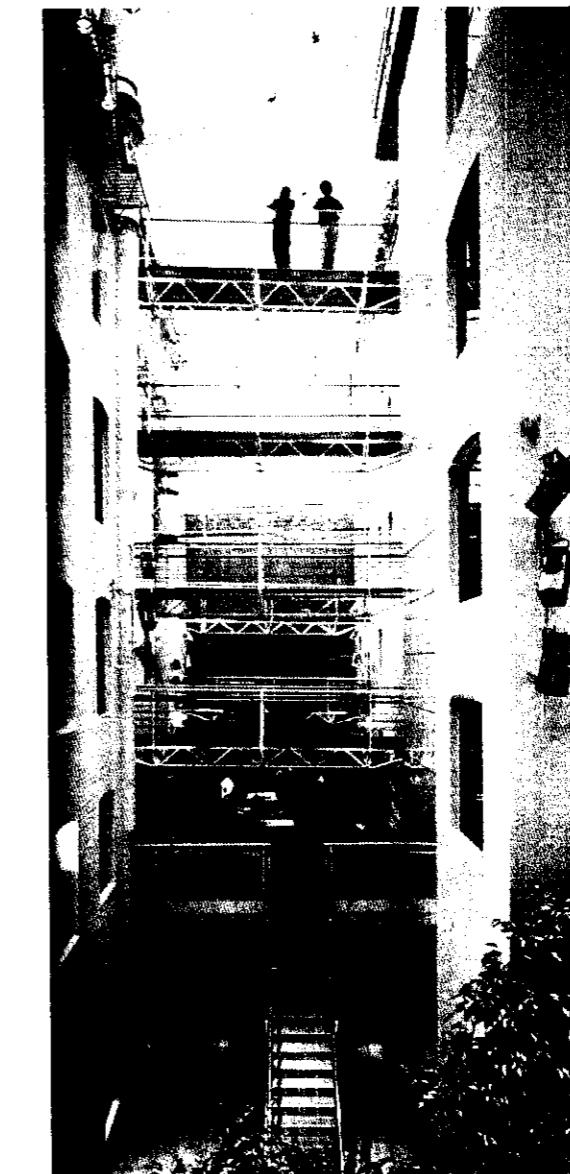
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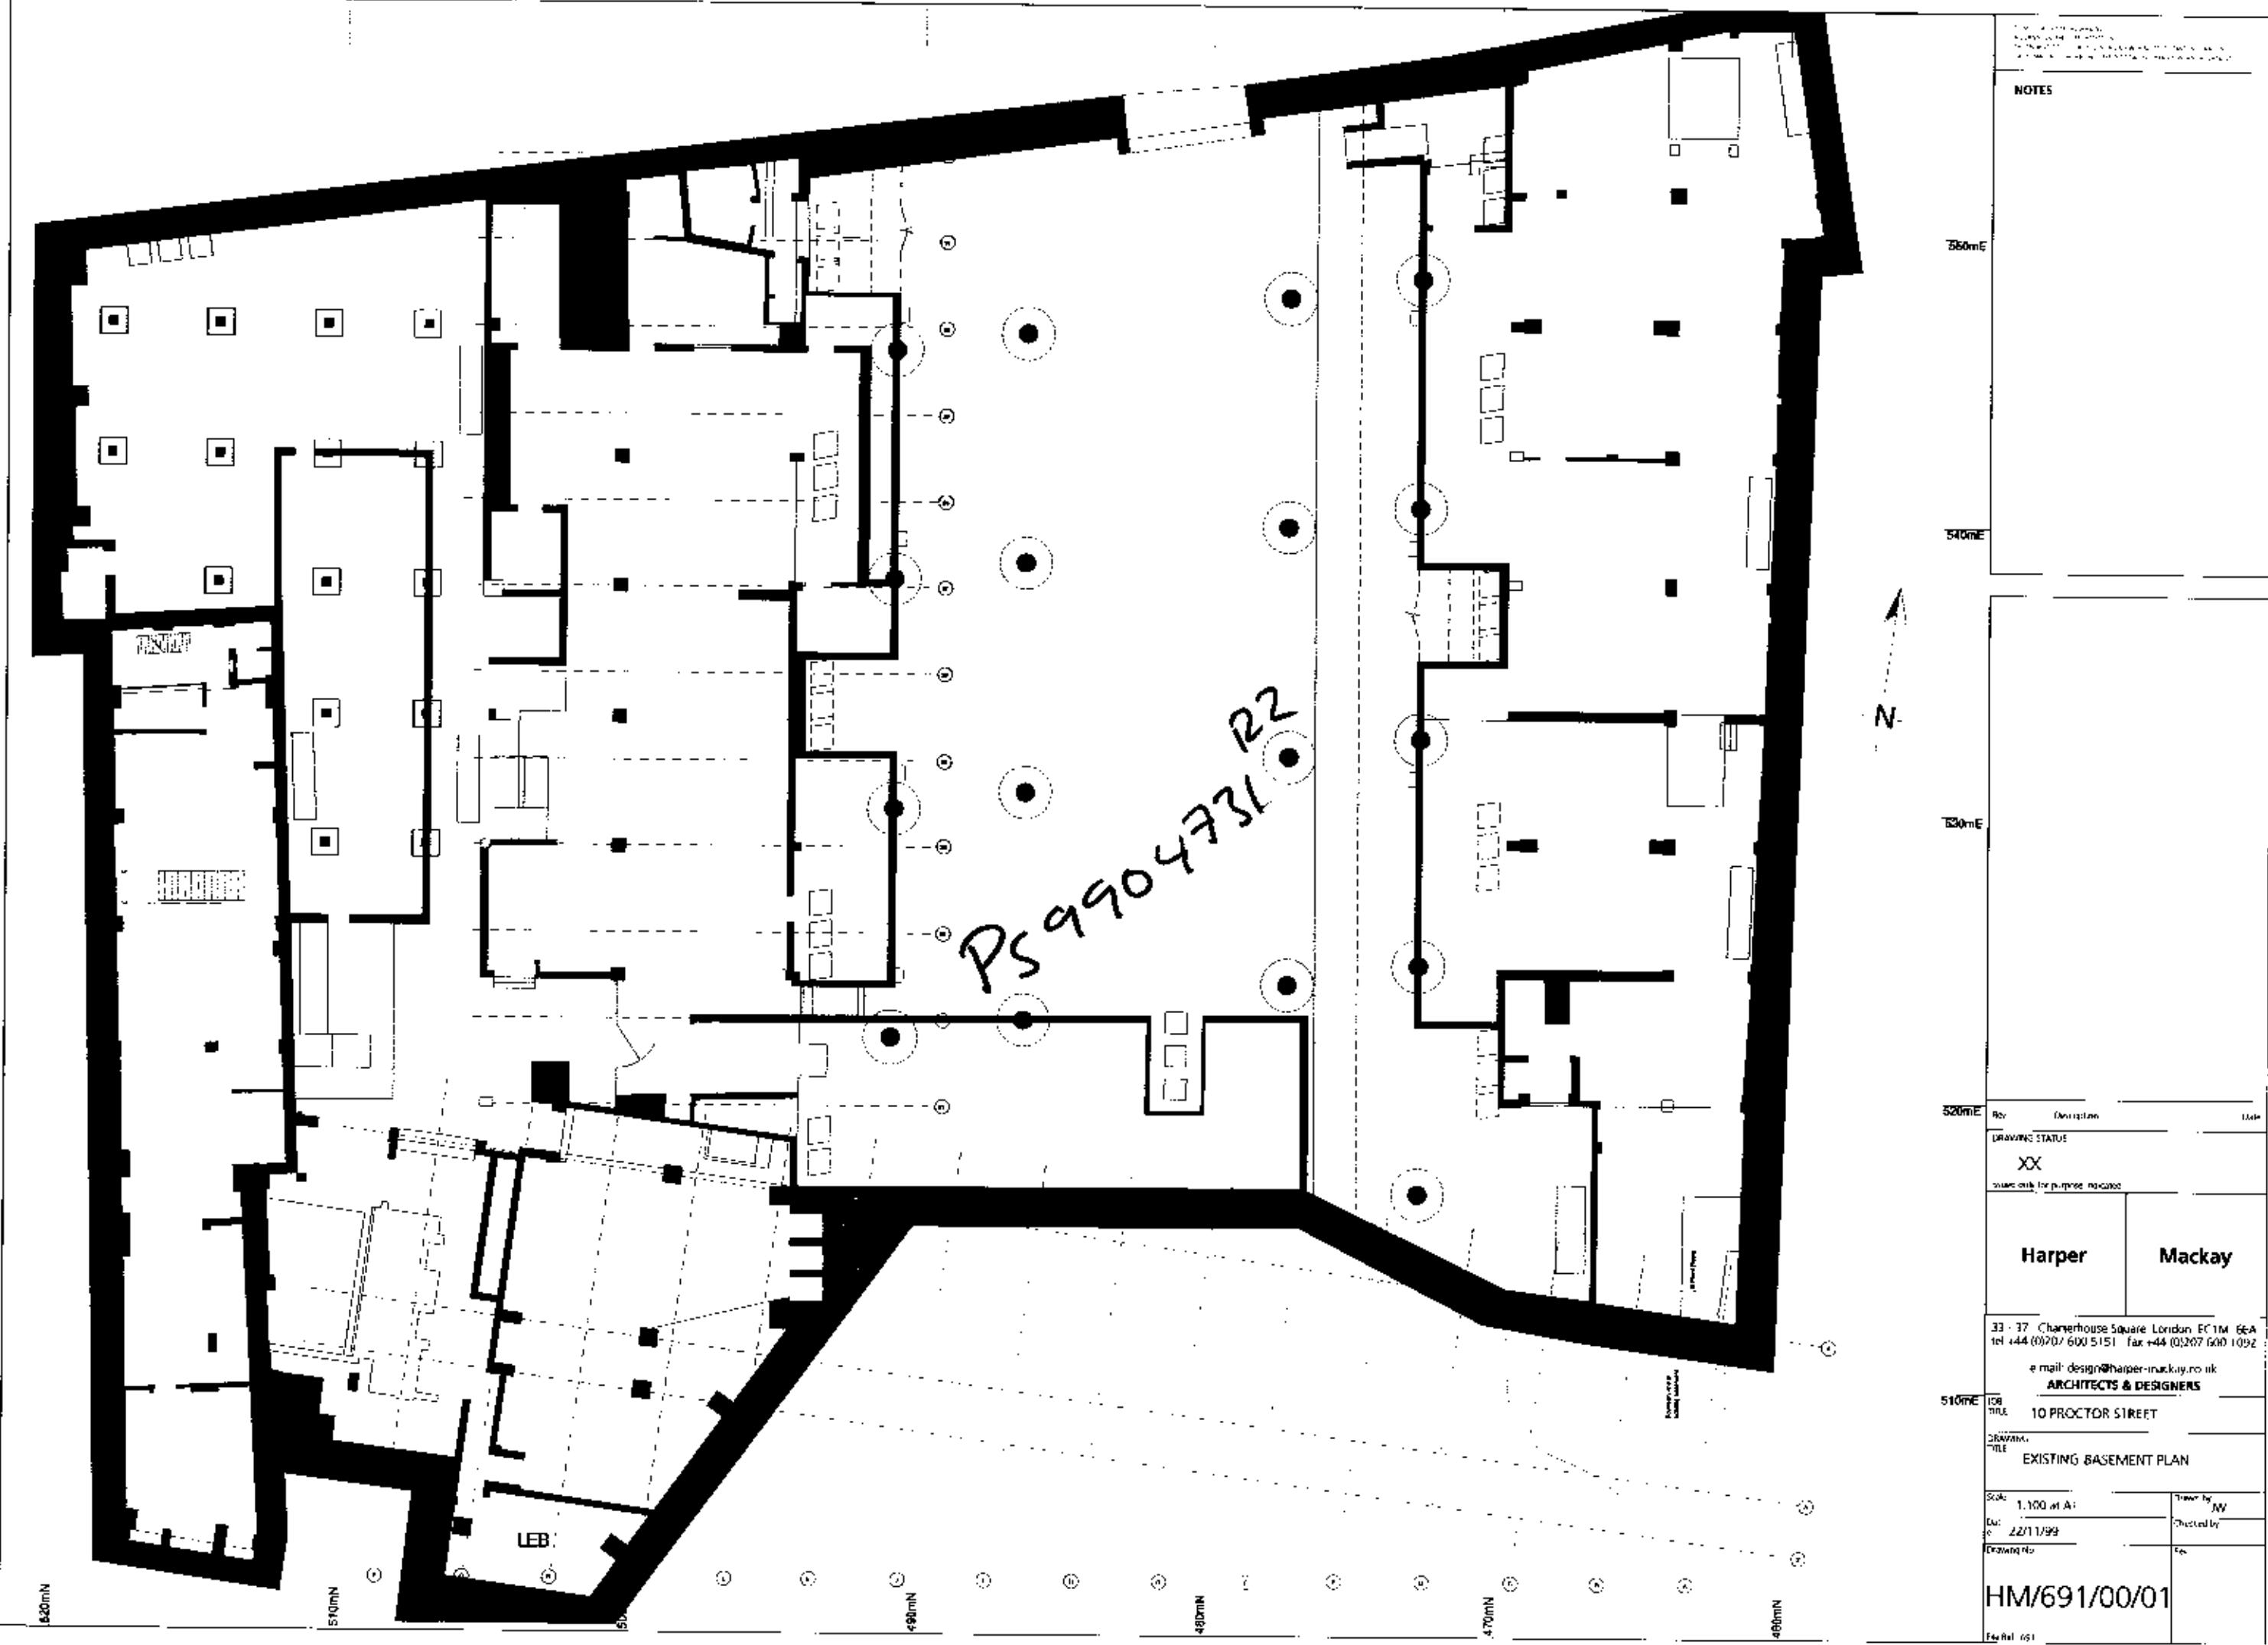
3D image of proposed atrium



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PS9904731 R2

N

This is an architectural drawing of an existing first floor plan. The plan includes various rooms, windows, and doors. A north arrow (N) is located in the upper right quadrant. Handwritten text 'PS9904731 R2' is written diagonally across the center of the drawing. A large black rectangular redaction box covers the top left portion of the plan. A small redaction box is also present near the bottom center. The drawing is annotated with several small circles containing numbers and letters, likely indicating specific points of interest or measurements.

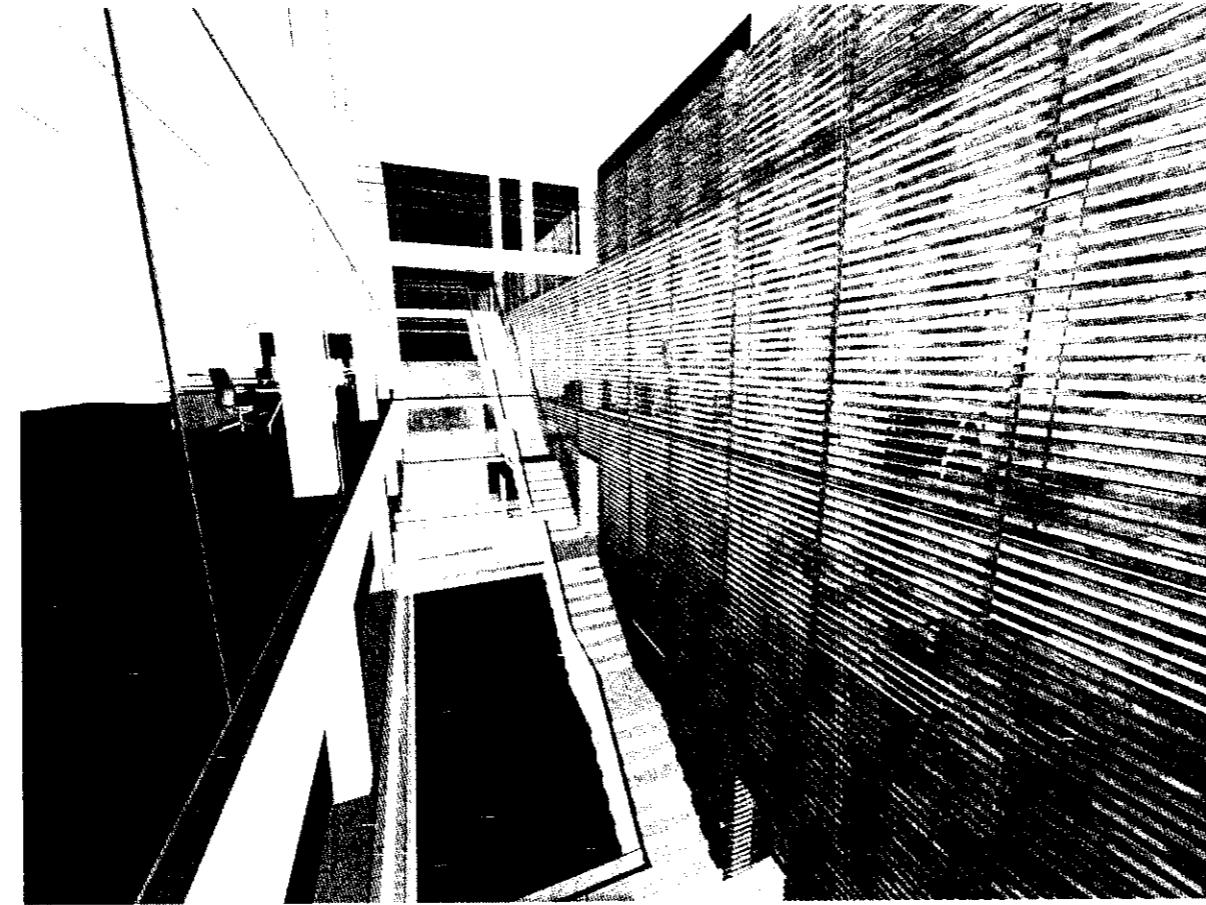NOTES

DRAWING STATUS

FOR PLANNING

Issued only for purpose indicated

Harper	Mackay
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ARCHITECTS & DESIGNERS


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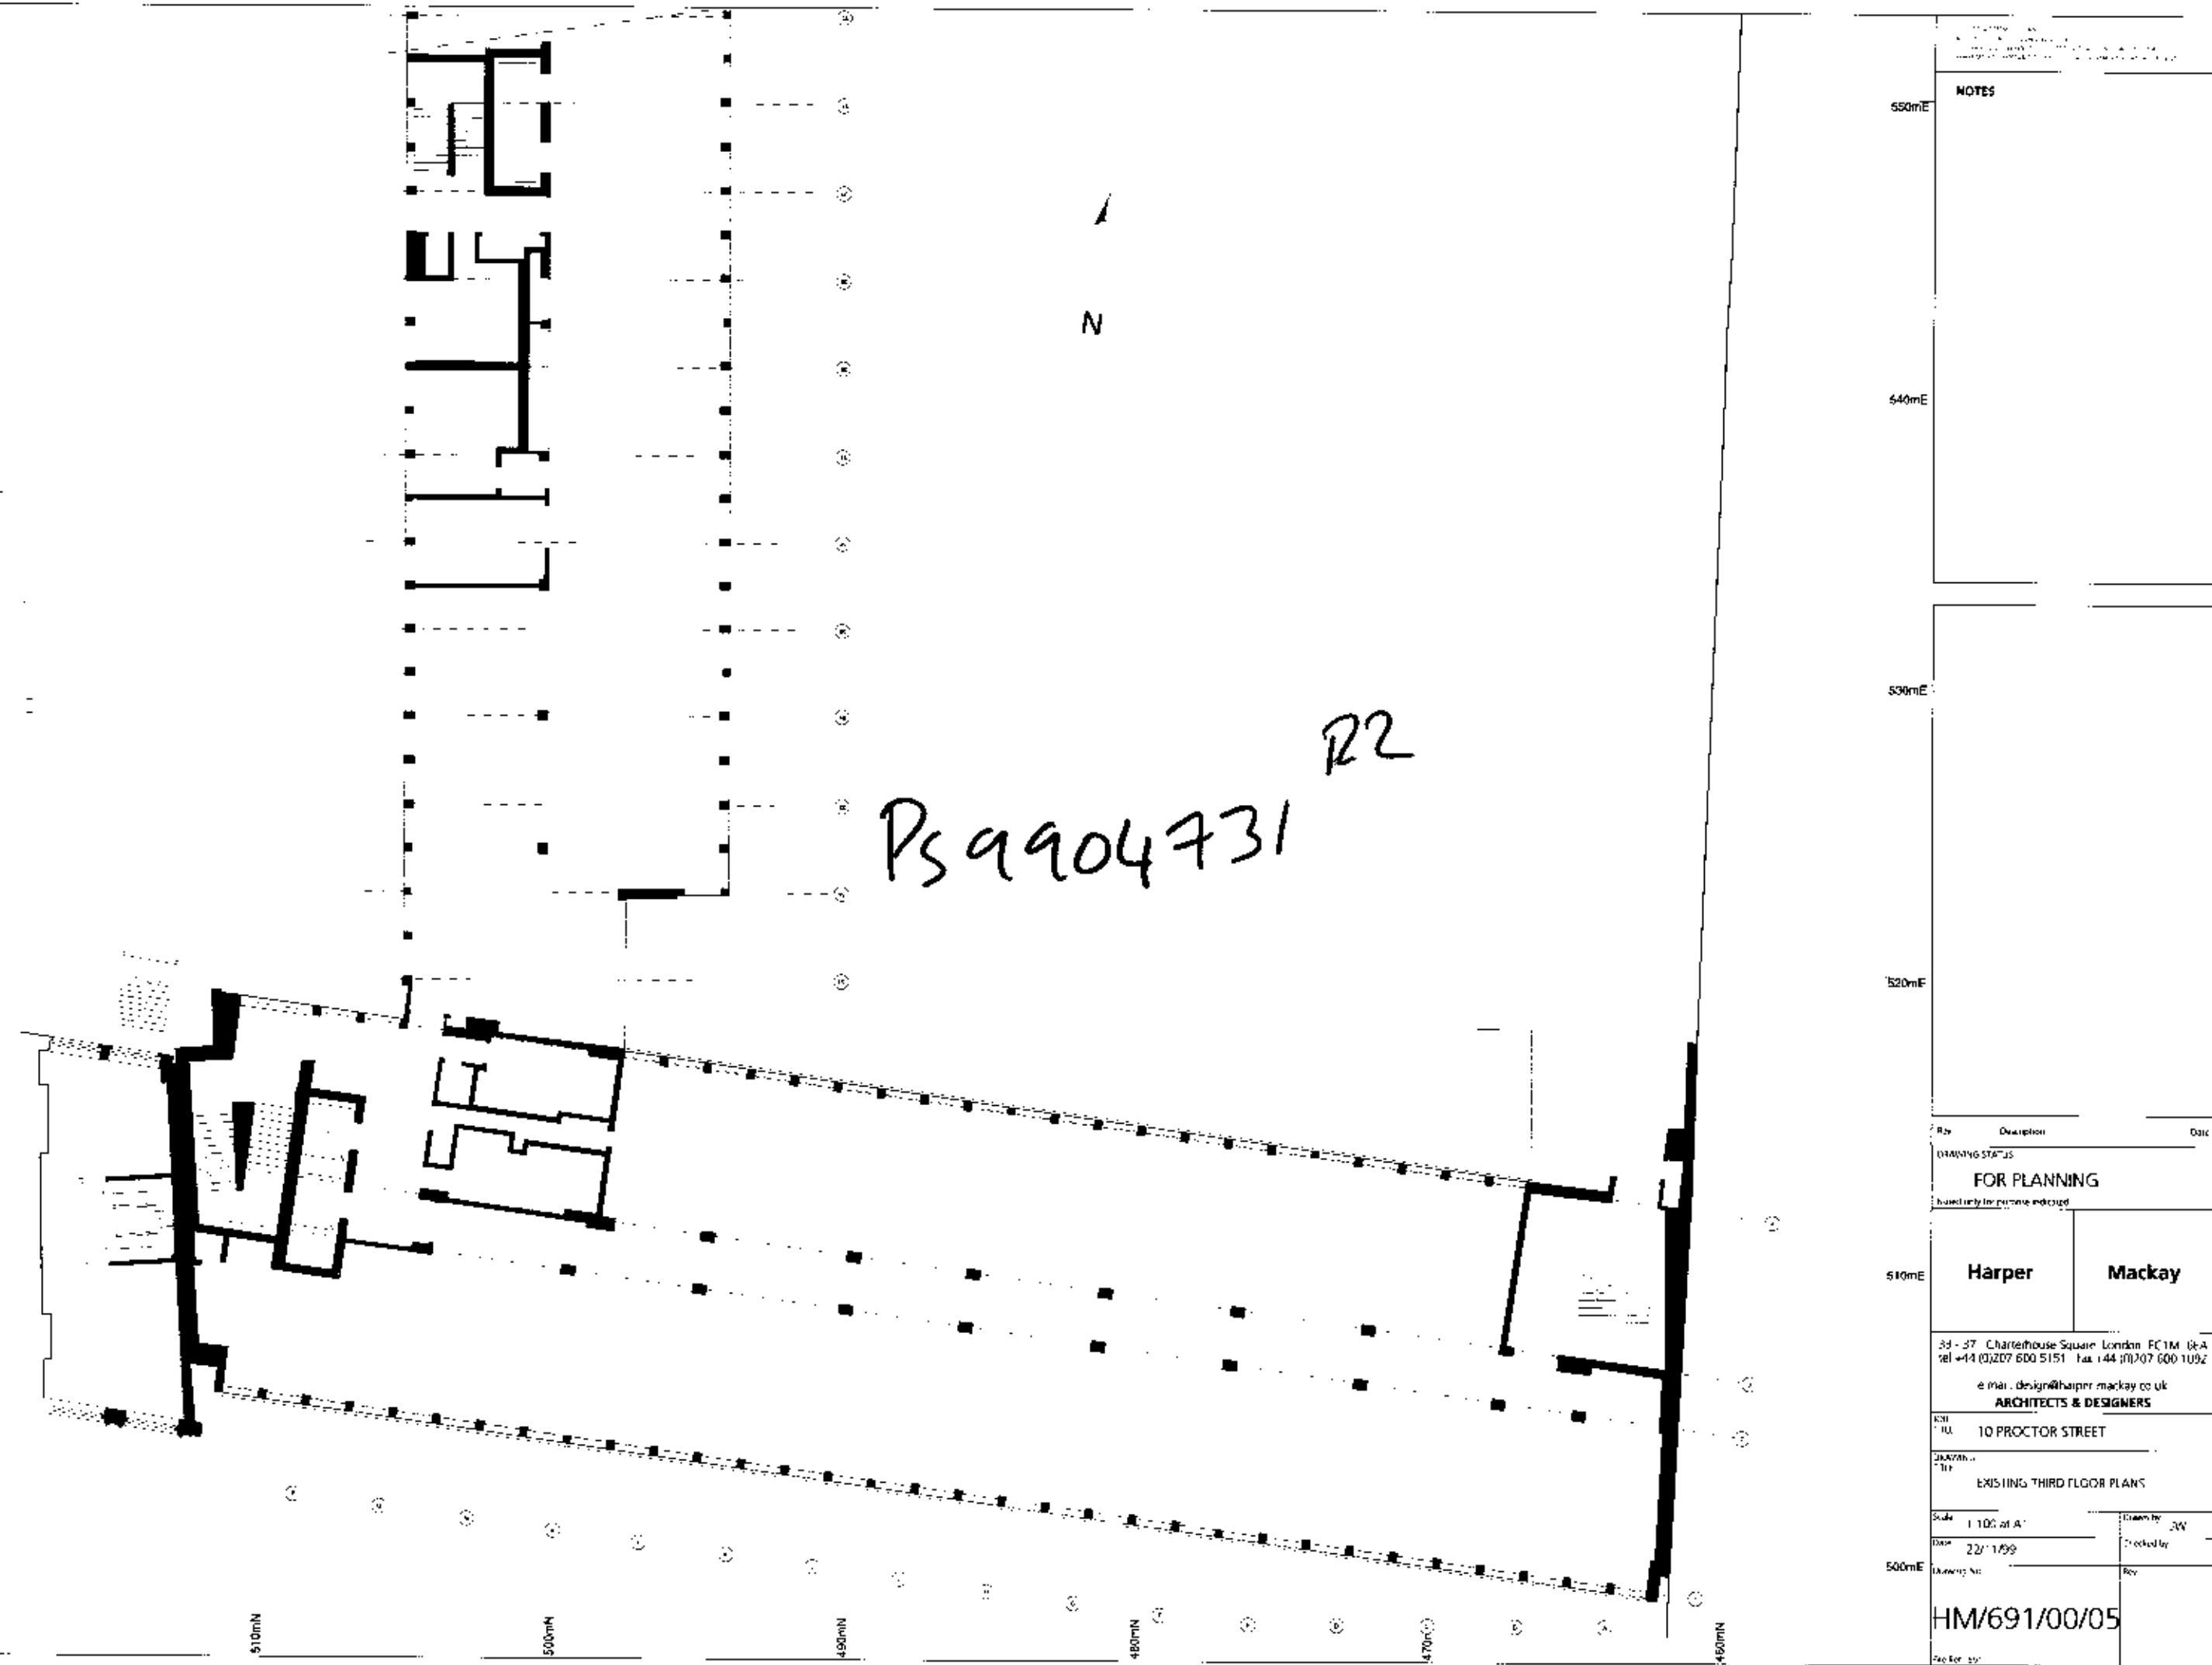
DRAWING
TITLE


EXISTING FIRST FLOOR PLAN

Scale 1:100 at A1	Drawn by JW
Date 22/11/99	Checked by
Drawing No	Rev

HM/691/00/03



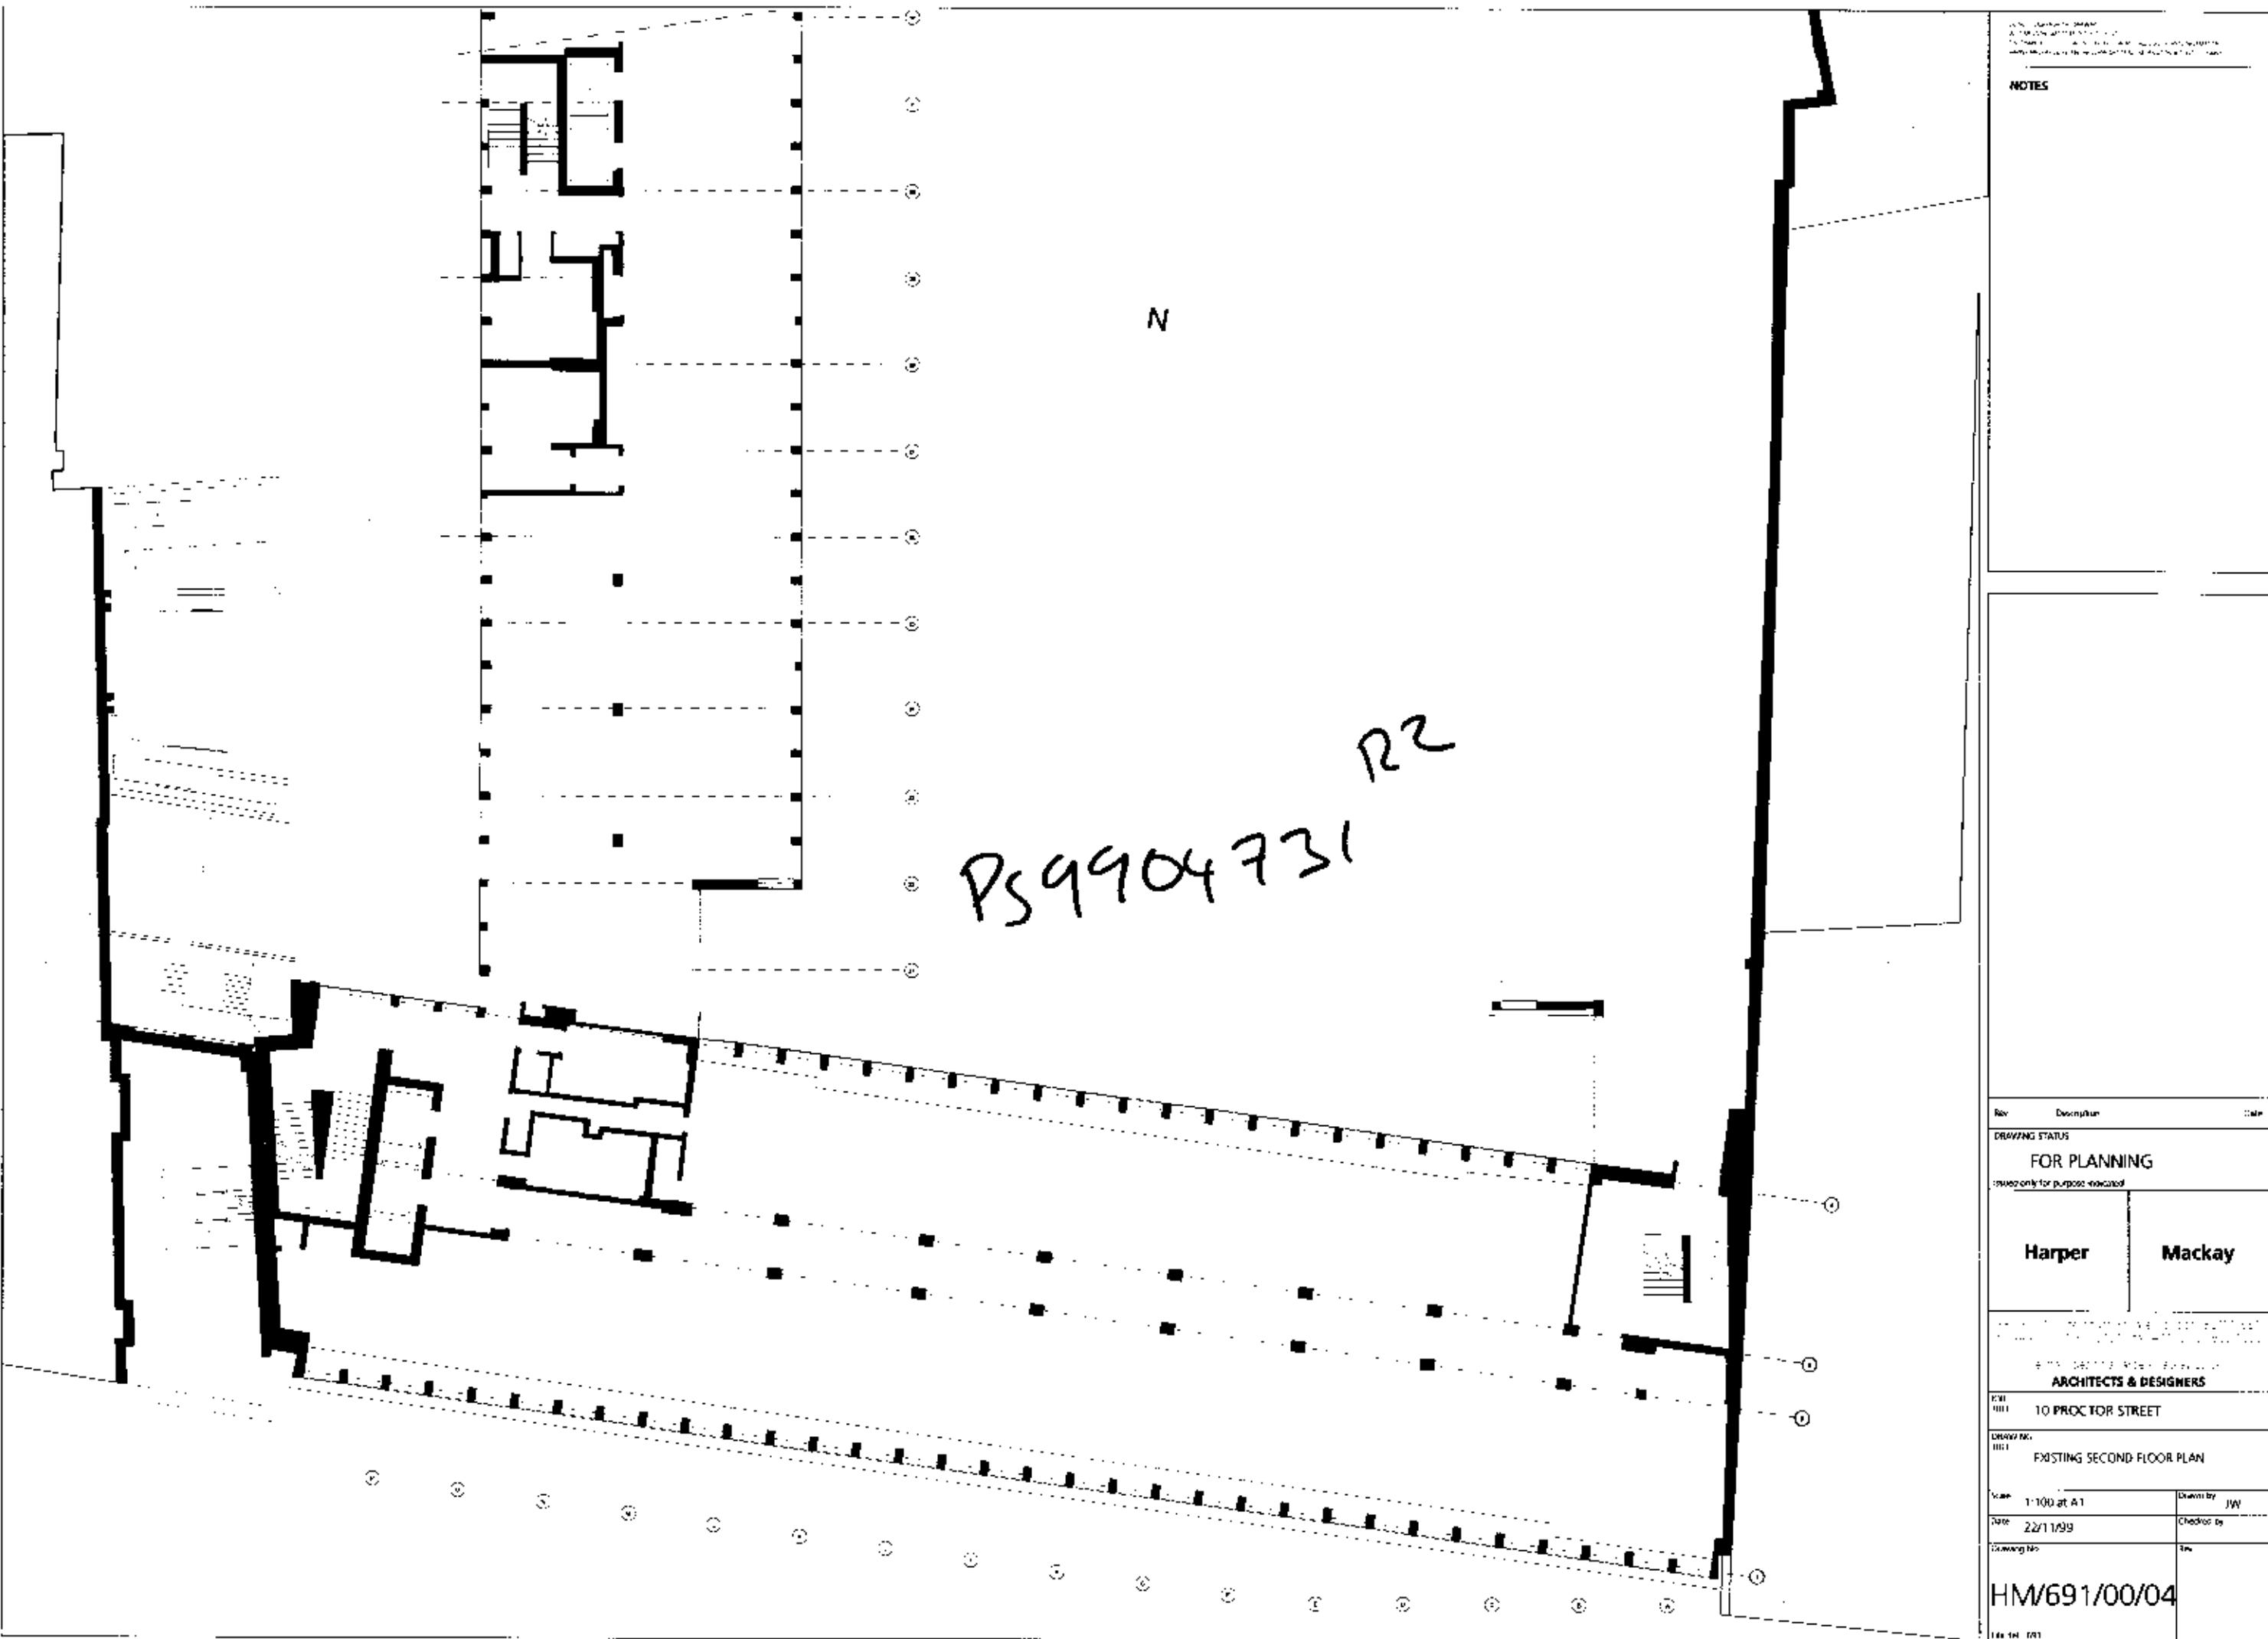

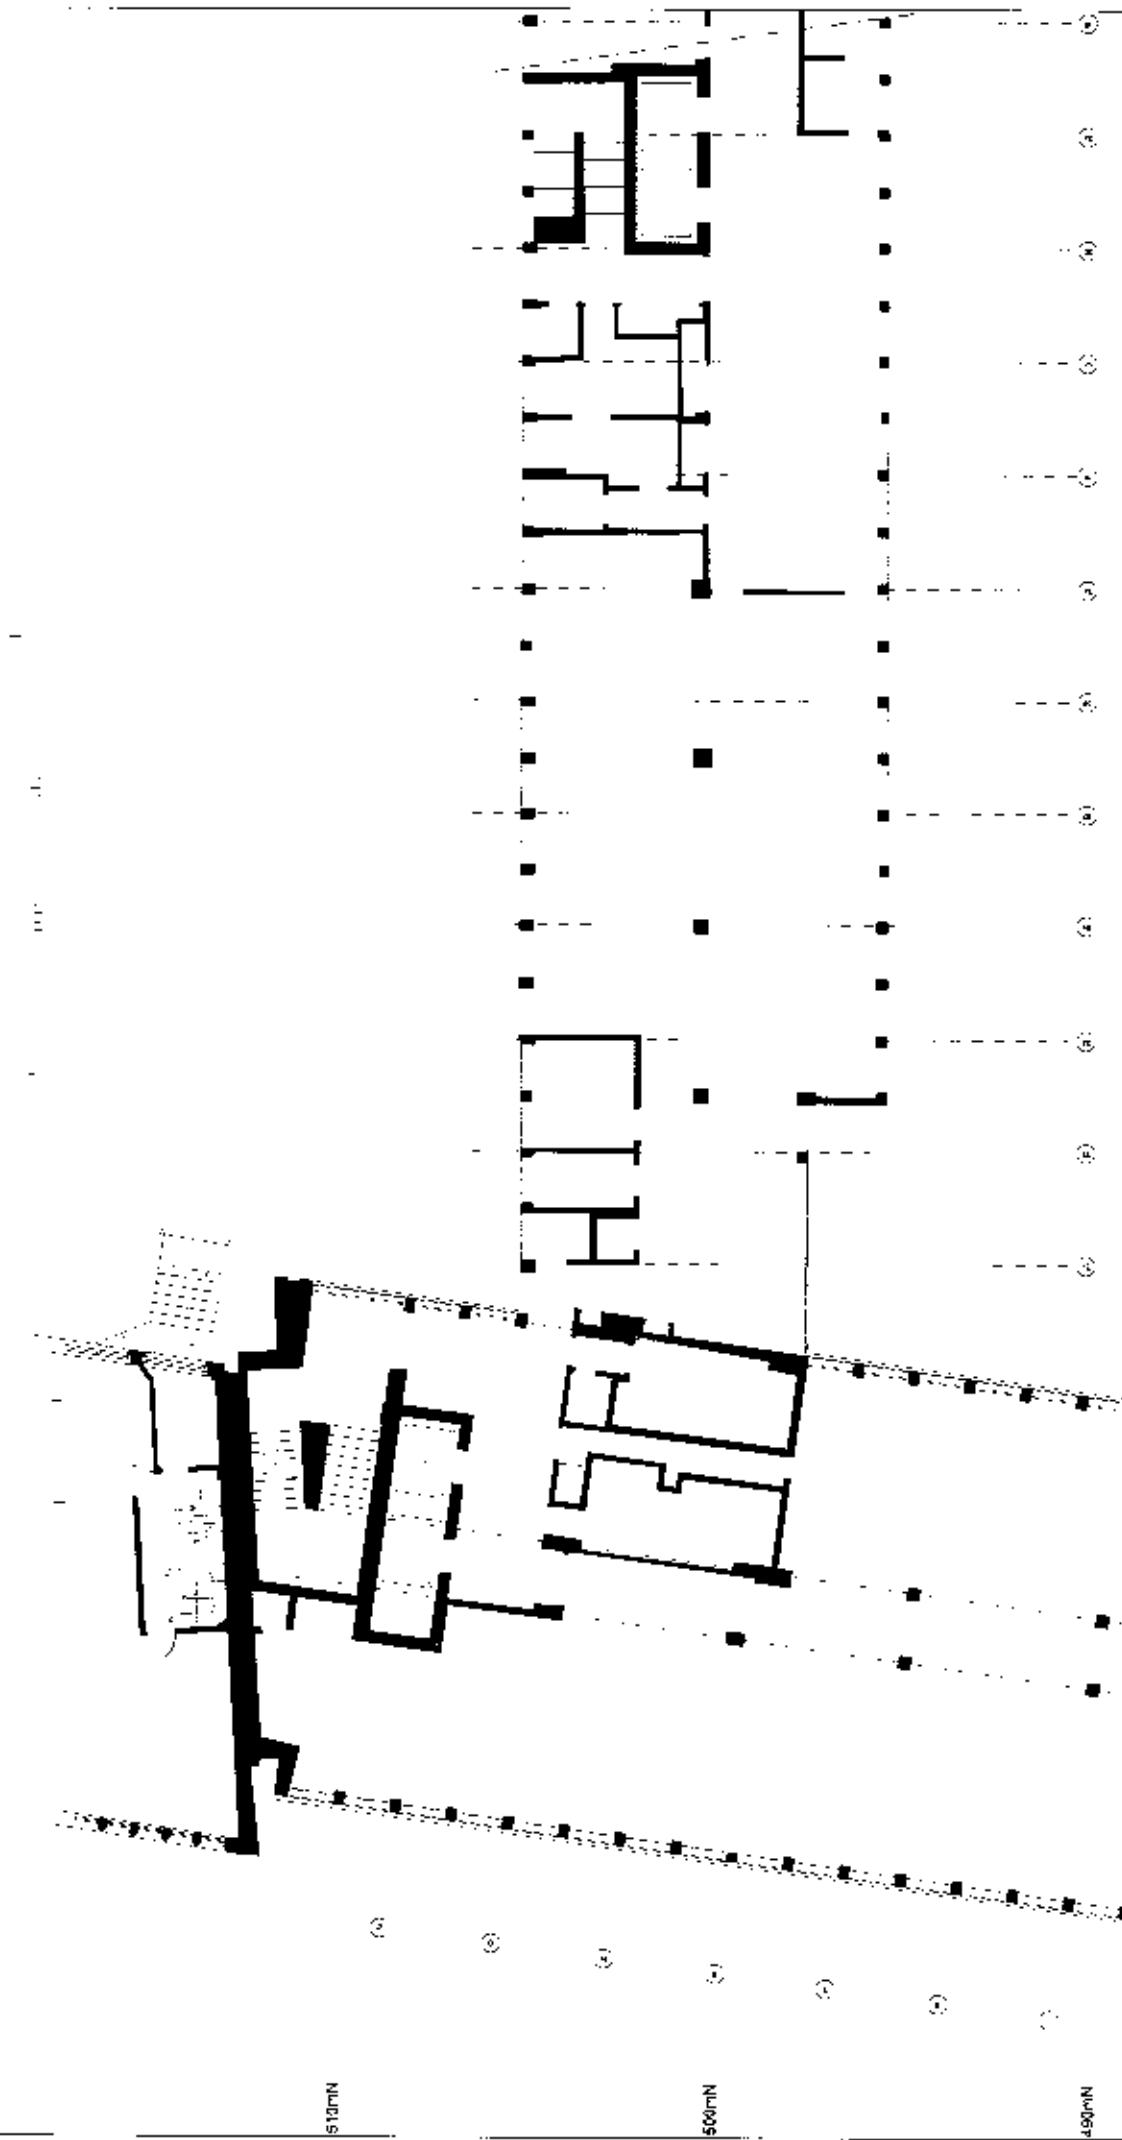

NOTES		
550mE		
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530mE		
520mE		
510mE		
Drawing No. _____ Date _____		
DRAWING STATUS		
FOR PLANNING		
Issued only for purpose intended		
510mE	Harper	Mackay
31-37 Charterhouse Square London EC1M 5EA tel +44 (0)207 600 5151 fax +44 (0)207 600 1092 e-mail: design@harper-mackay.co.uk		
ARCHITECTS & DESIGNERS		
10 PROCTOR STREET		
DRAWING TITLE		EXISTING FOURTH FLOOR PLANS
Scale	1:100 at A1	Permit No. JW
Date	22/11/99	Classified
500mE	Drawing No.	40
HM/691/00/06		
(Ref'd. 99)		

100 Charterhouse Square
London EC1M 6EA
Tel +44 (0)207 600 5151 Fax +44 (0)207 600 1092

NOTES

550mE

540mE

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520mE

510mE

500mE

Rev Description Date

DRAWING STATUS

FOR PLANNING

Approved for planning and load

Harper Mackay

33 - 37 Charterhouse Square London EC1M 6EA
Tel +44 (0)207 600 5151 Fax +44 (0)207 600 1092

E-mail: design@harper-mackay.co.uk

ARCHITECTS & DESIGNERS

Kittell

10 PROCTOR STREET

DRAWING NO.

EXISTING FIFTH FLOOR PLAN

MAP 1:100 sq A'

DATE 23/11/99

DESIGNER JW

PREV. NO.

500mE

REF. NO.

HM/691/00/07

REG. NO.

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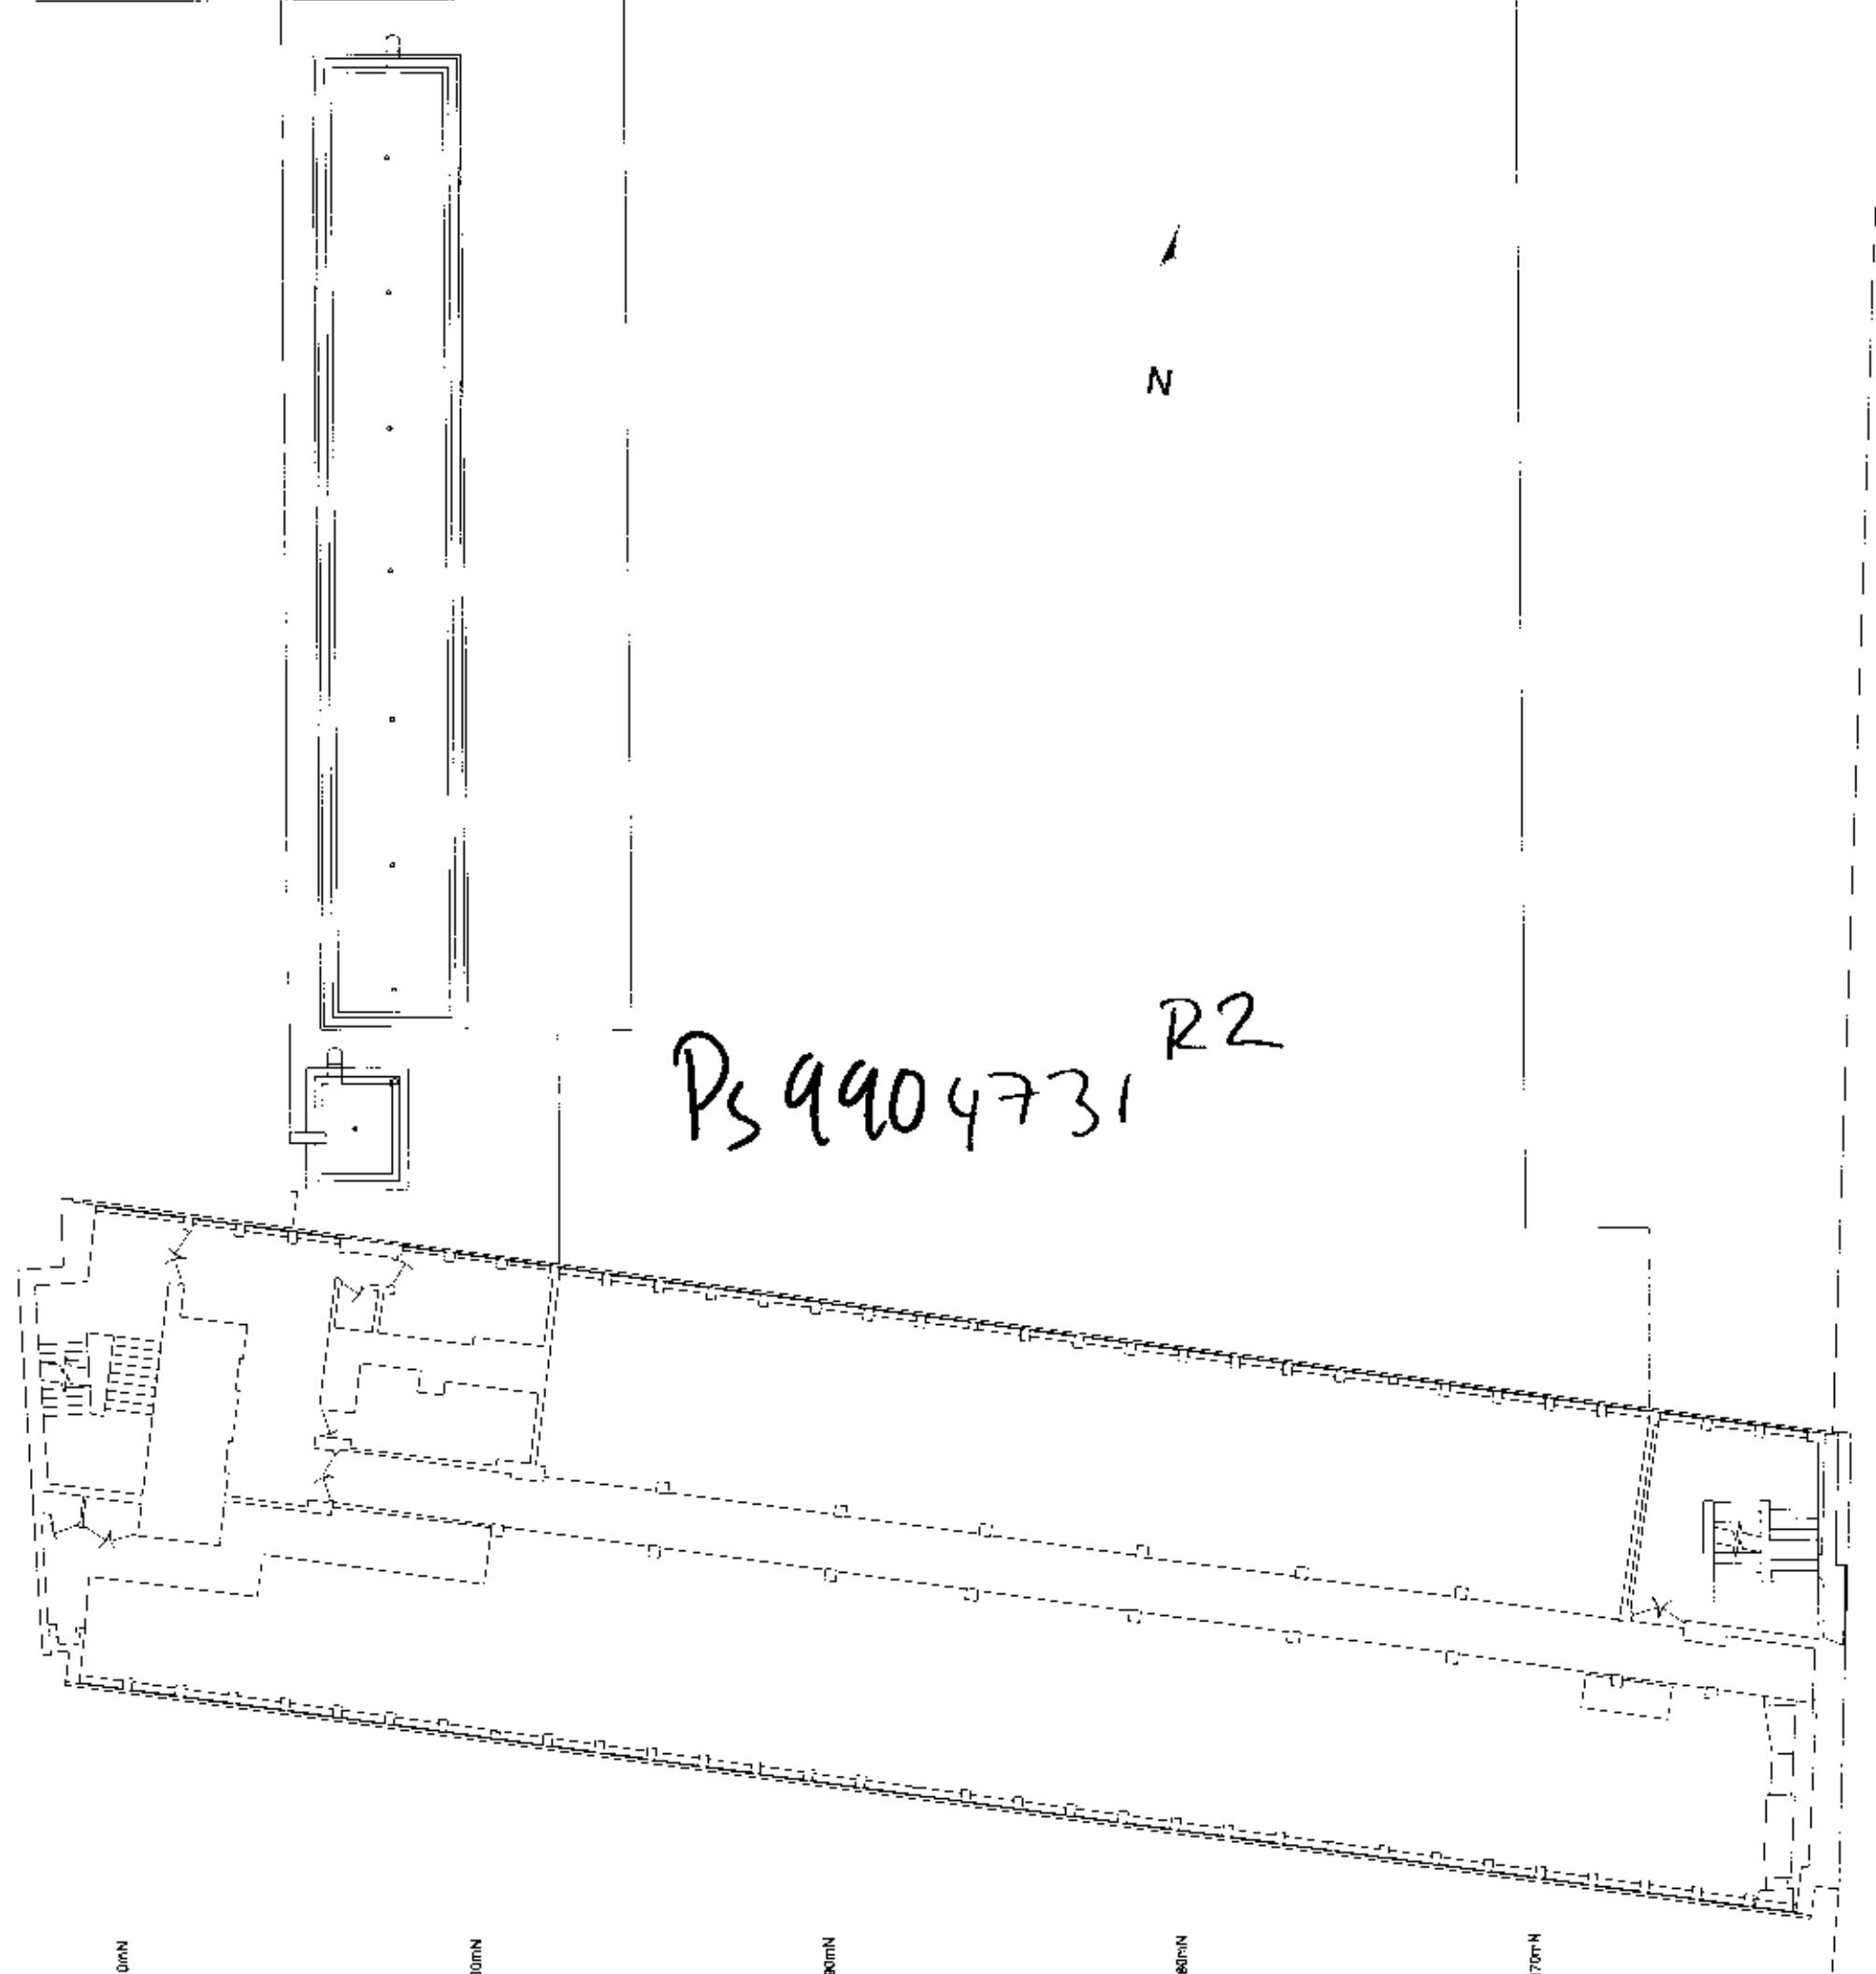
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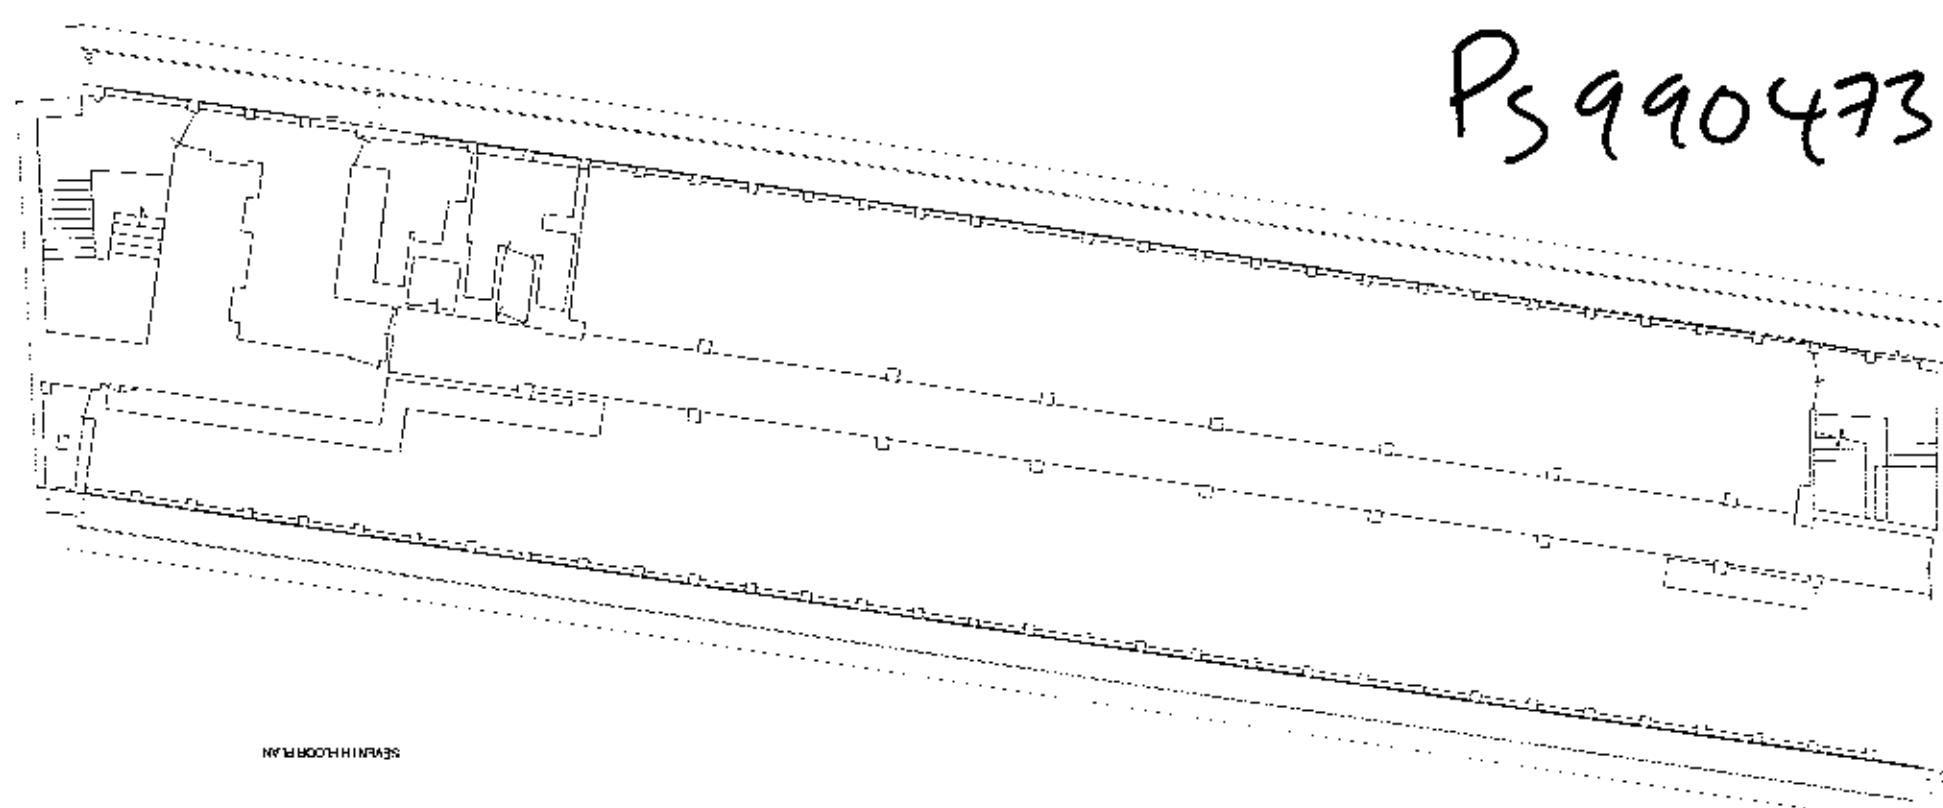
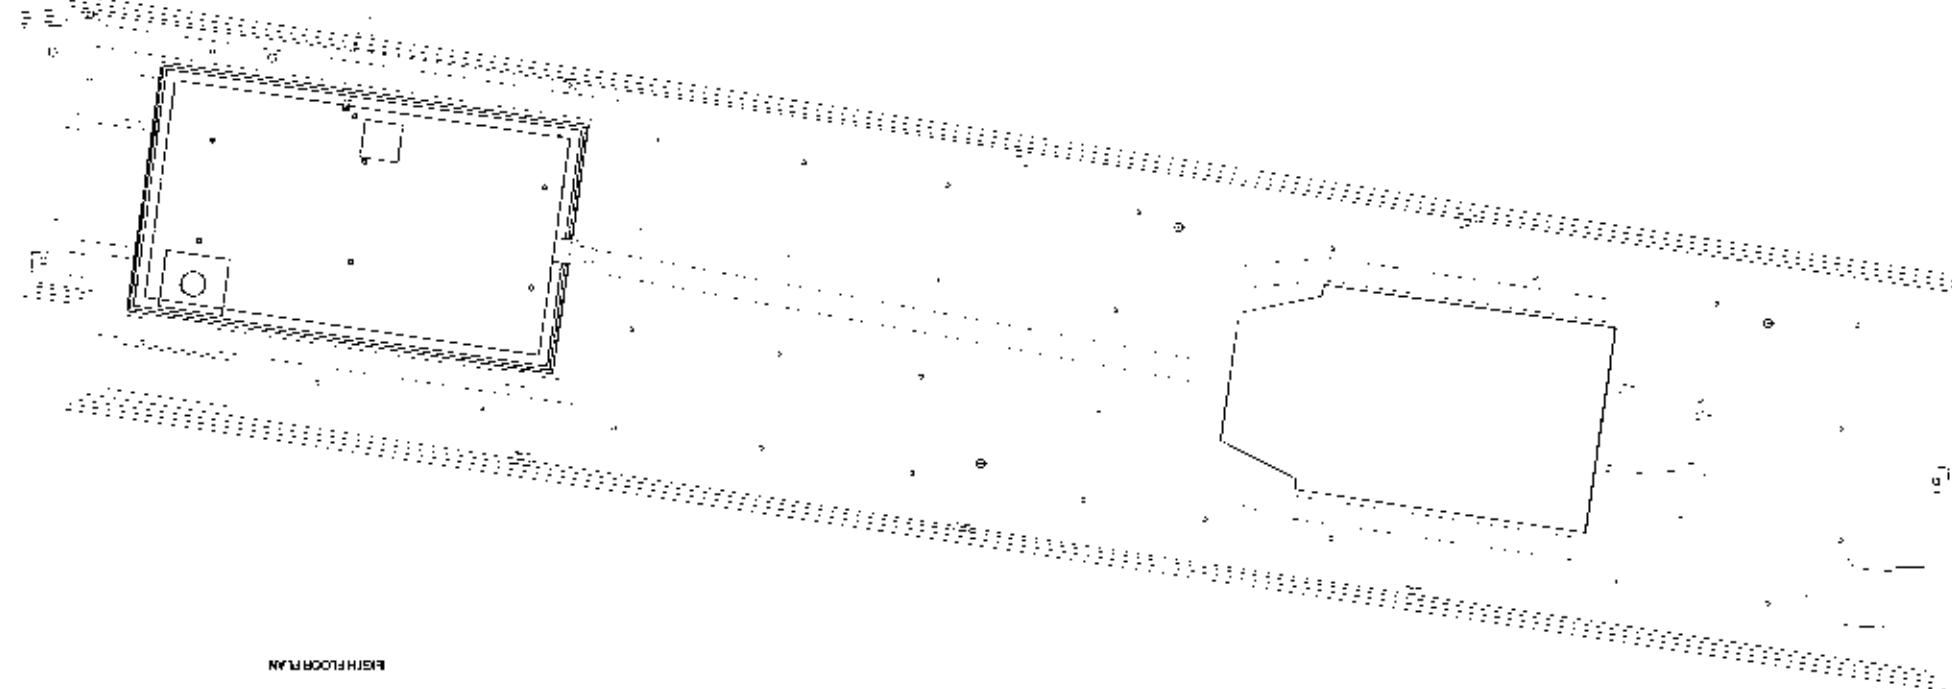
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C:\DRIVE\HARPER\DESIGN\10-PROCTOR-STREET\10-PROCTOR-STREET.DWG		
10 PROCTOR STREET, LONDON, EC1M 6EA		
TEL +44 (0)20 7600 1092 FAX +44 (0)20 7600 1092		
E MAIL design@harper-mackay.co.uk		
ARCHITECTS & DESIGNERS		
Job No.	10 PROCTOR STREET	Date
Ref.	Mackay	Architect
Description		Design
DRAWING STATUS		
Based only for purpose intended		
Rev.	Harper	Date
NOTES		
550mE		
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460mE		
450mE		
FOR PLANNING		
Existing Sixth Floor Plan		
1:100 at A1	Drawn by JW	
30/11/99	Checked by	
Drawing No.	Date	Rev.
HM/691/00/08		
1 sheet 56		

Ps 9904731 R2






PS 9904731 22

DRAWING STATUS		Date
FOR PLANNING		
based only on purpose indicated		
Harper	Mackay	Date
23-37 Charterhouse Square London EC1M 6EA		
tel +44 (0)207 600 5151 fax +44 (0)207 600 1092		
e-mail: design@harper-mackay.co.uk		
ARCHITECTS & DESIGNERS		
10 PROCTOR STREET		
DRAWINGS		
Title		
EXISTING SEVENTH & EIGHTH FLOOR PLANS		
Scale	1:200 at A1	Date by
Date	23/1/99	Drawn by
Drawing No.	Box	Rev.
HM/691/00/09		
10000 IN'		

PLANT ROOM AND 27TH/Floor
TO BE DEMOLISHED

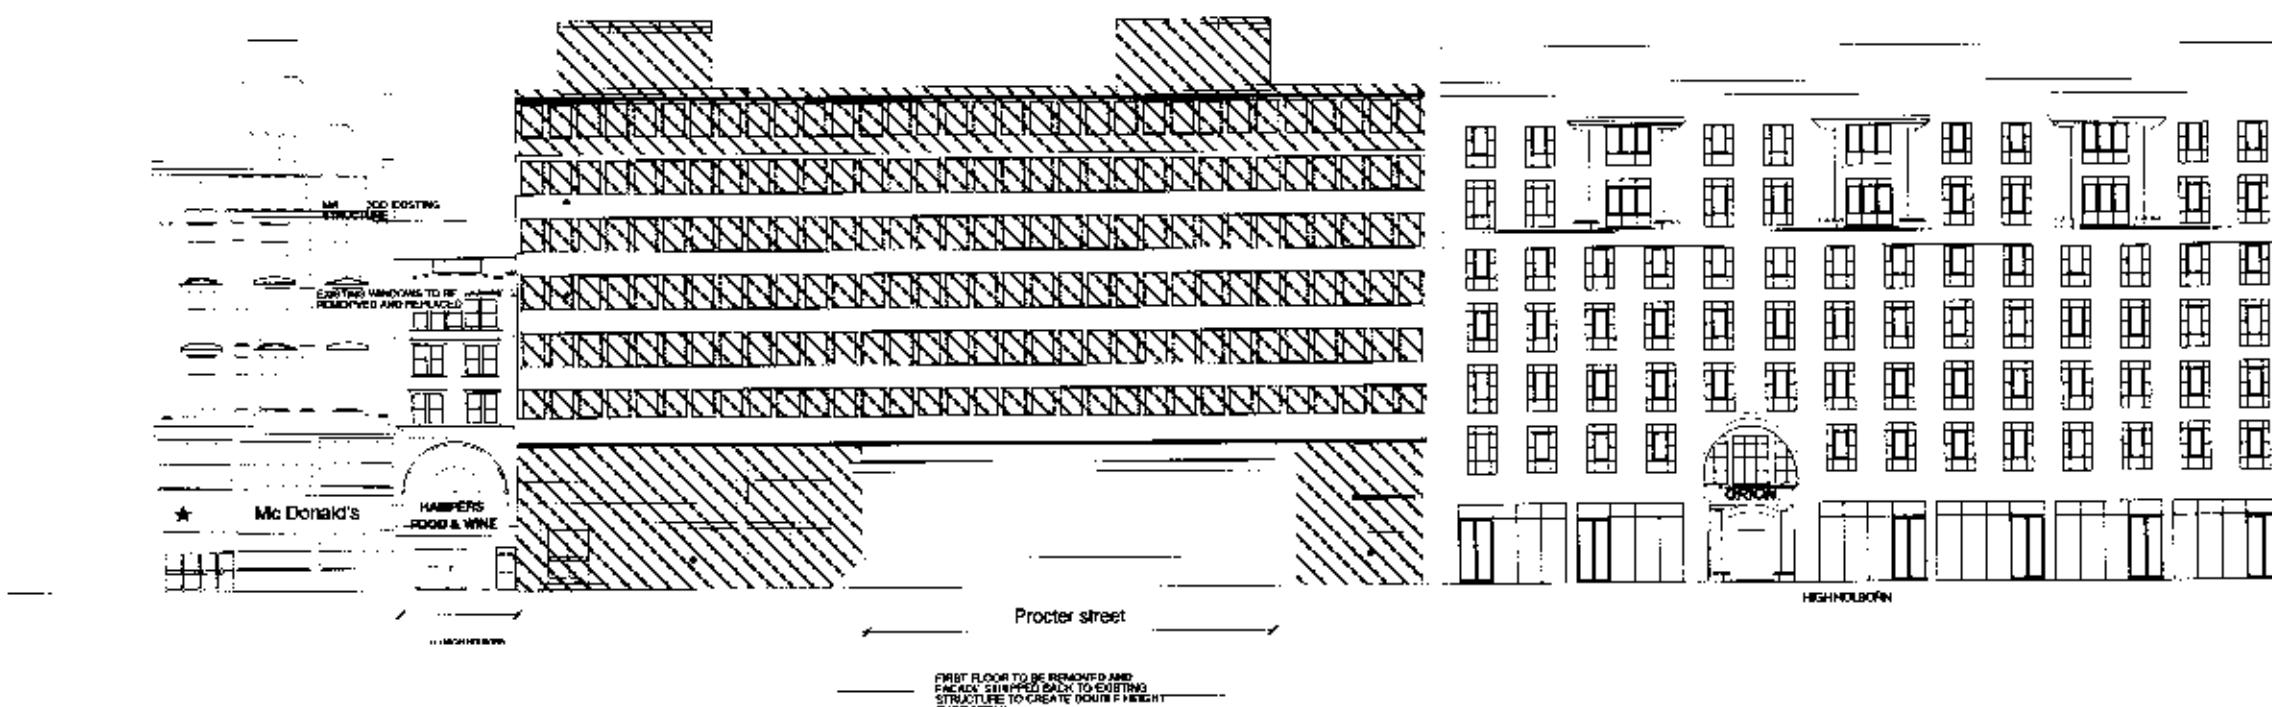

KEY PLAN

NOTES

Ref Description Date

(Drawings STATE)

FOR PLANNING

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Harper Mackay

33 - 37 Charterhouse Square London EC1M 8EA
tel (44) 0171 600 5151 fax (44) 0171 600 1082
e-mail: design@harper-mackay.co.uk

ARCHITECTS & DESIGNERS

JOB TITLE 100-111 HIGH HOLBORN

DRAWING TITLE SOUTH ELEVATION
DEMOLITION

Scale 1:200 @ A1 DRAWN BY MK

Date 14.07.99 ISSUED BY SA


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HM/691/00/11

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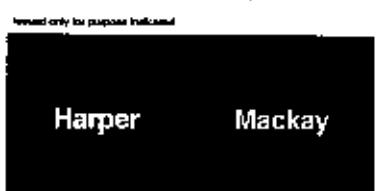
KEY PLAN

NOTES



Ref. Description Date
DRAWING STATUS

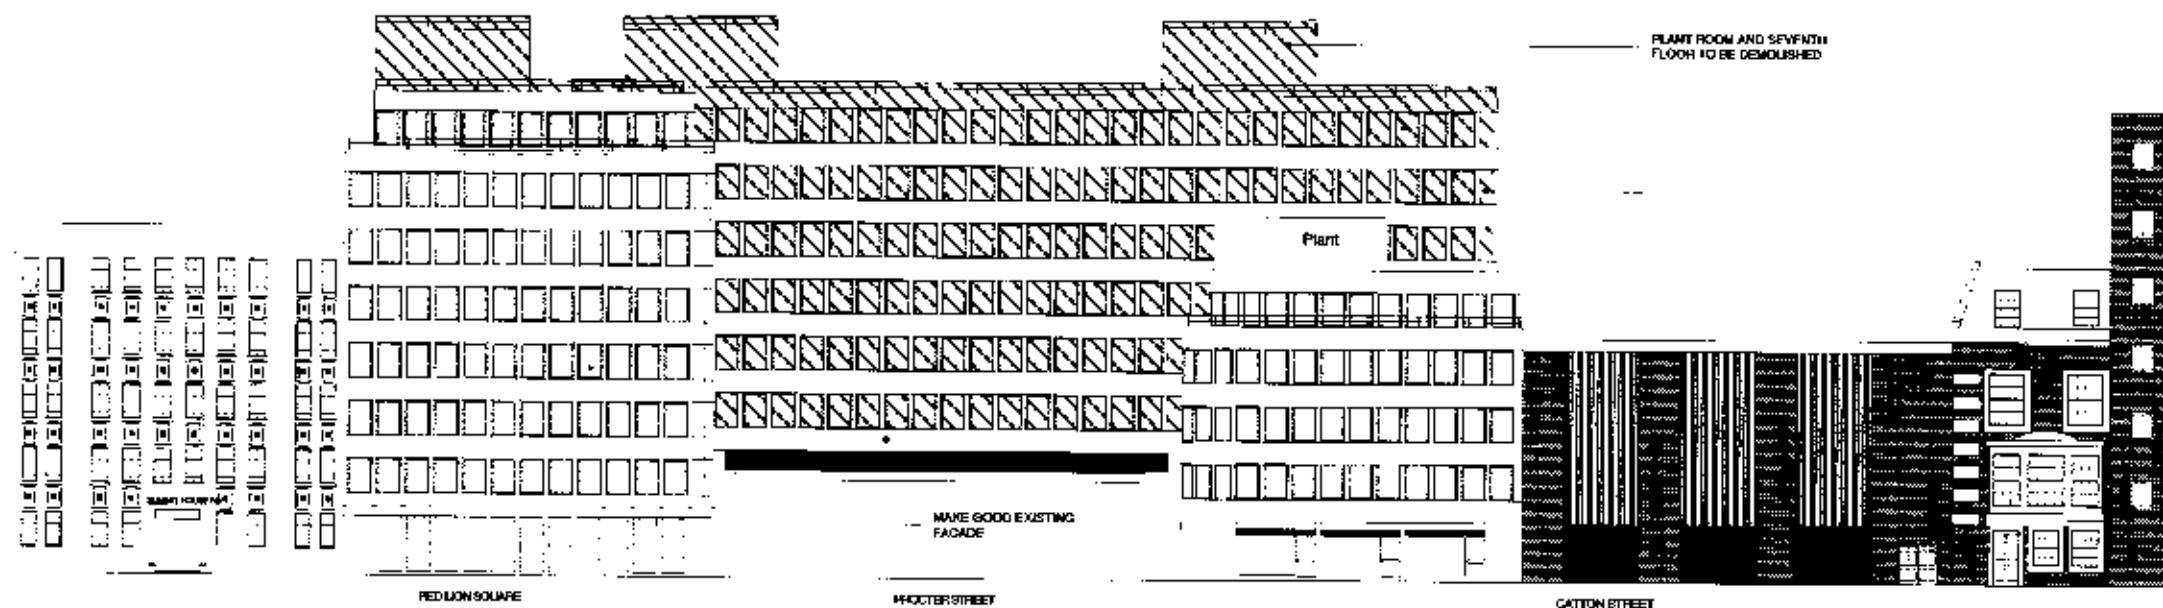FOR PLANNING



33-37 Chancery Lane London EC1M 6EA
tel (44) 0171 600 5151 fax (44) 0171 600 1092
e-mail: design@harper-mackay.co.uk

ARCHITECTS & DESIGNERS


JOB TITLE 100-111 HIGH HOLBORN

DRAWING TITLE NORTH ELEVATION
DEMOLITION

Scale 1:200 @ A1 DRAWN BY MK
Date 14.07.99 CHECKED BY SA
Drawing No. Rev.

Ps 9904731 22

HM/691/00/12

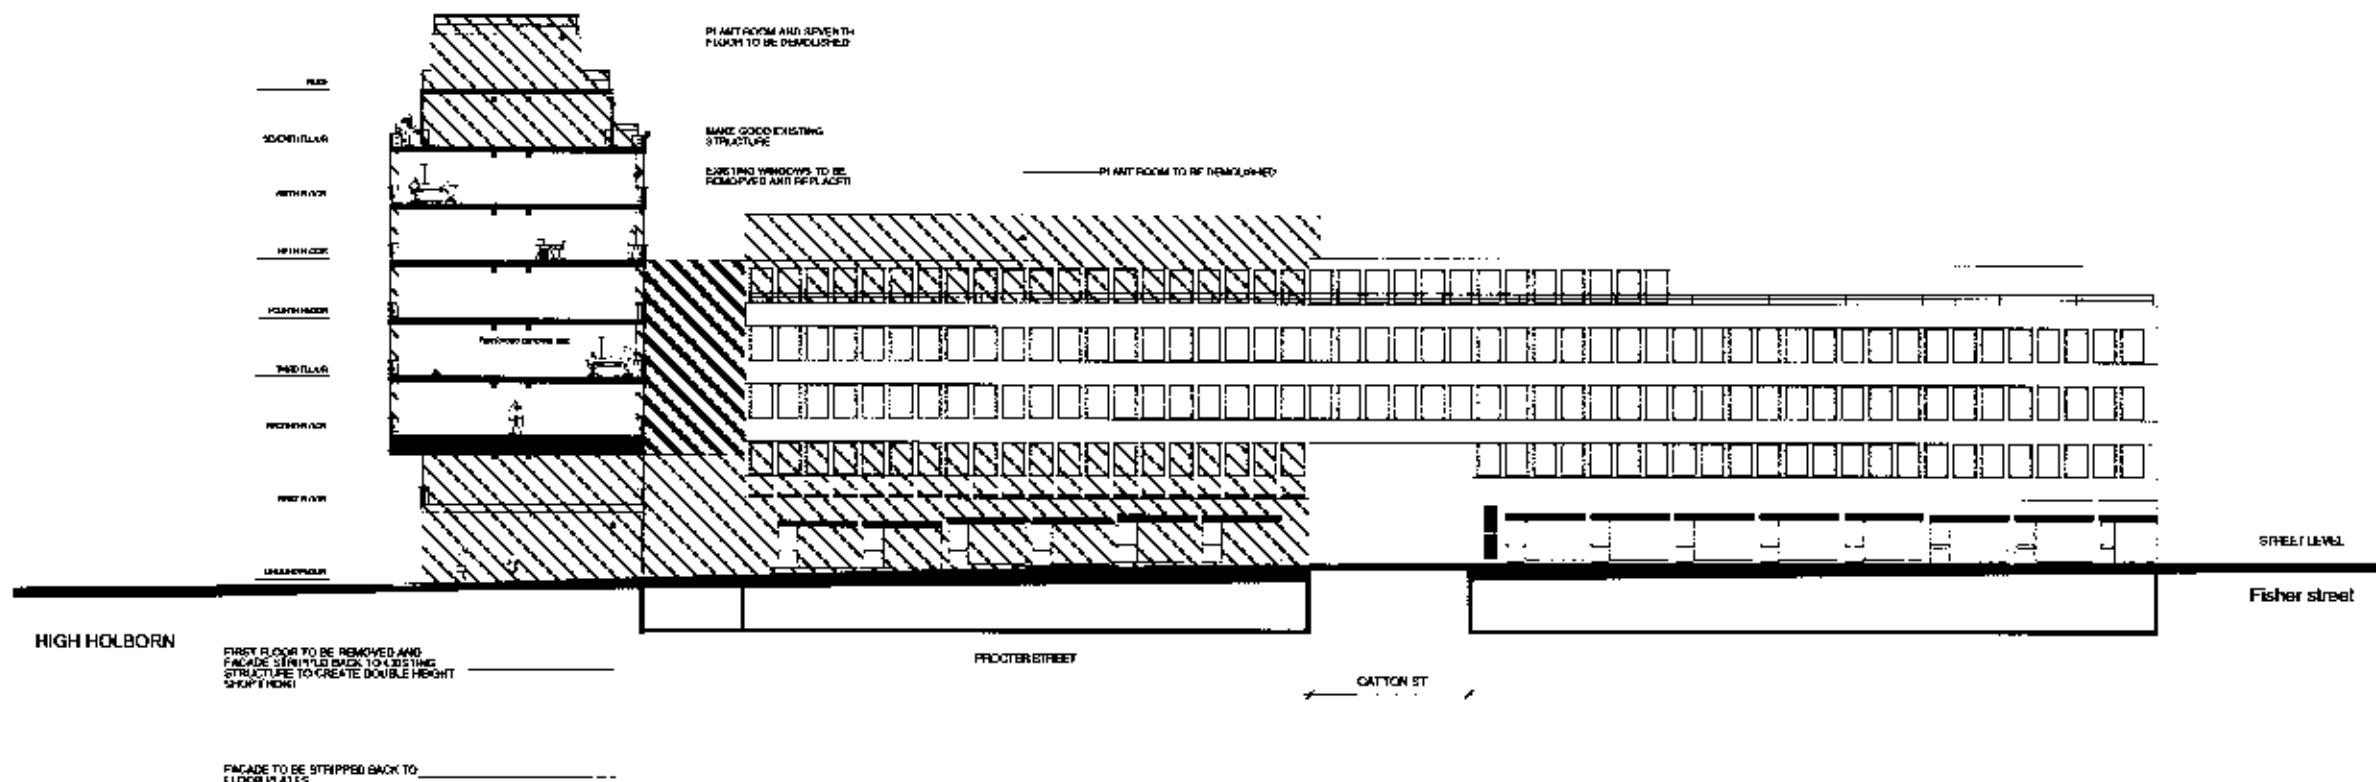

PS9904731

22

33-37 Charterhouse Square London EC1M 6

第二章

Hansen Mackay

33 - 37 Charterhouse Square London

tel (44) 0171 600 5151 fax (44) 0171 600 1092
e-mail: design@harper-mackay.co.uk

ARCHITECTS & DESIGNERS

卷二 100-111 HIGH HOLBORN

四聲圖說

DEMOLITION


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14.07.99

PRIMERAS VERSIÓN

KEY PLAN

NOTES

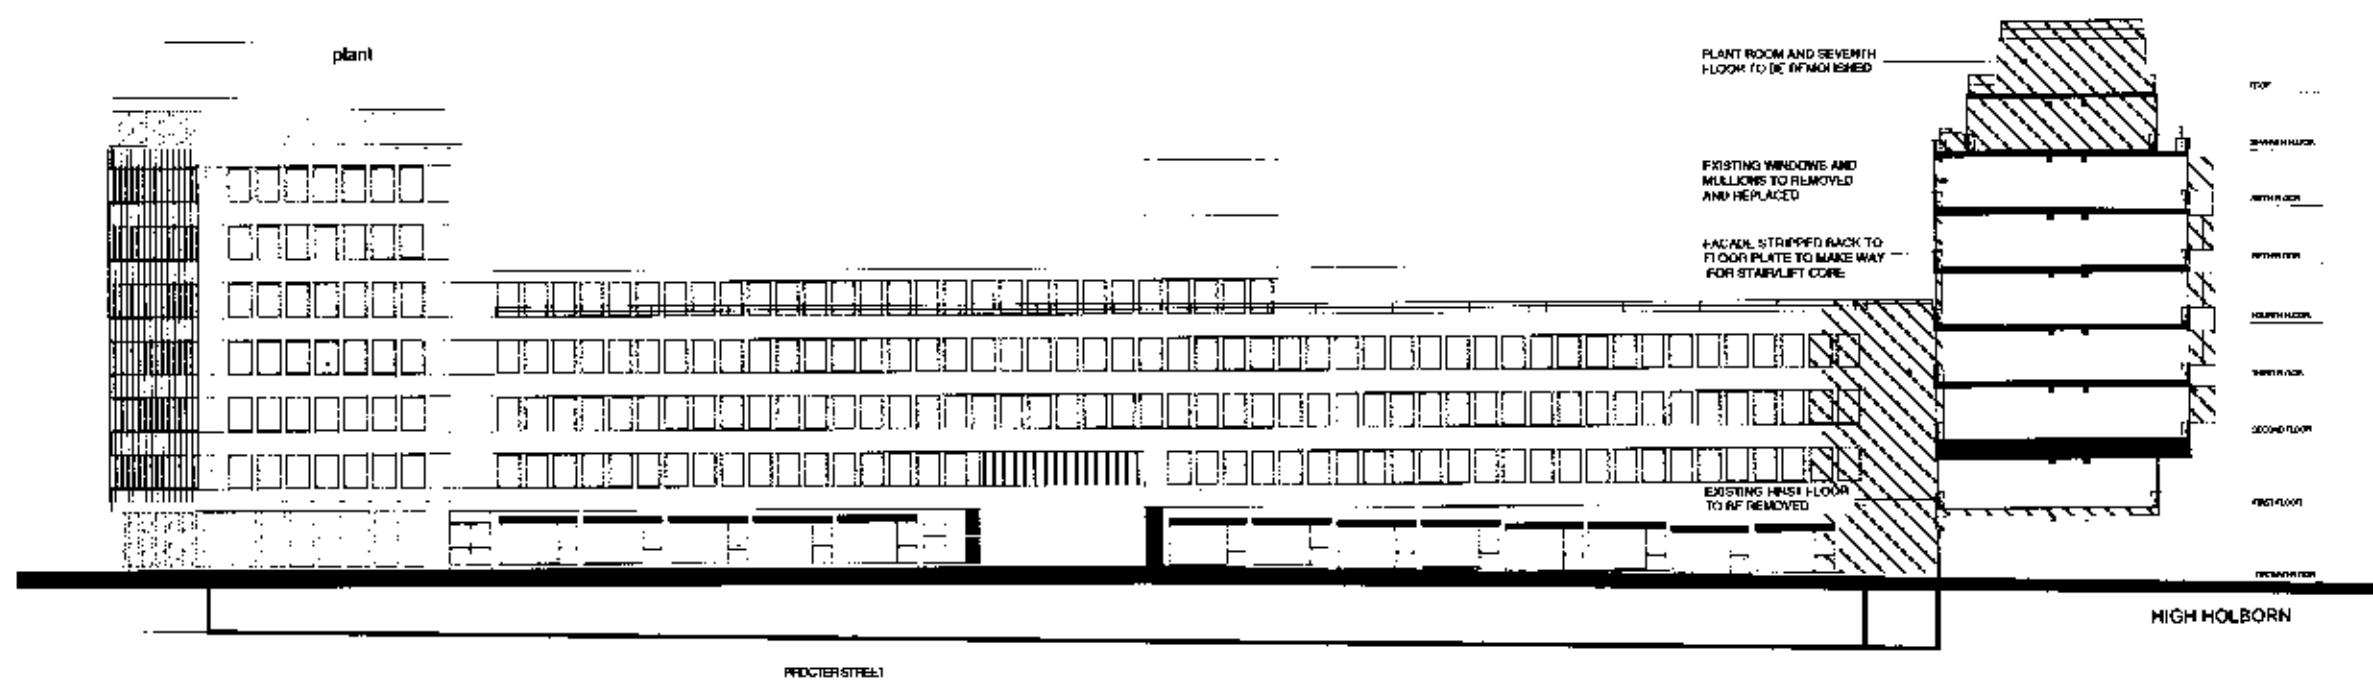

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38 - 37 Chamberhouse Square London EC1M 6EA
tel (44) 0171 600 5151 fax (44) 0171 600 1092
e-mail: design@harper-mackay.co.uk

ARCHITECTS & DESIGNERS

100-111 HIGH HOLBORN

EAST ELEVATION
DEMOLITION

Scale: 1:200 @ A1 DRAWN BY MK
Date: 14.07.99 CHECKED BY SA
Drawing No. Ref.

HM/691/00/14

FILE _____ JOB NUMBER 691

Ps9904731 R2



DO NOT SCALE DRAWING
No Scales or Units Indicated
Dimensions Given in MILLIMETRES
Architectural Drawing by HARPER & MACKAY LTD

NOTES

FOR PLANNING
Noted only for purpose indicated


Harper Mackay


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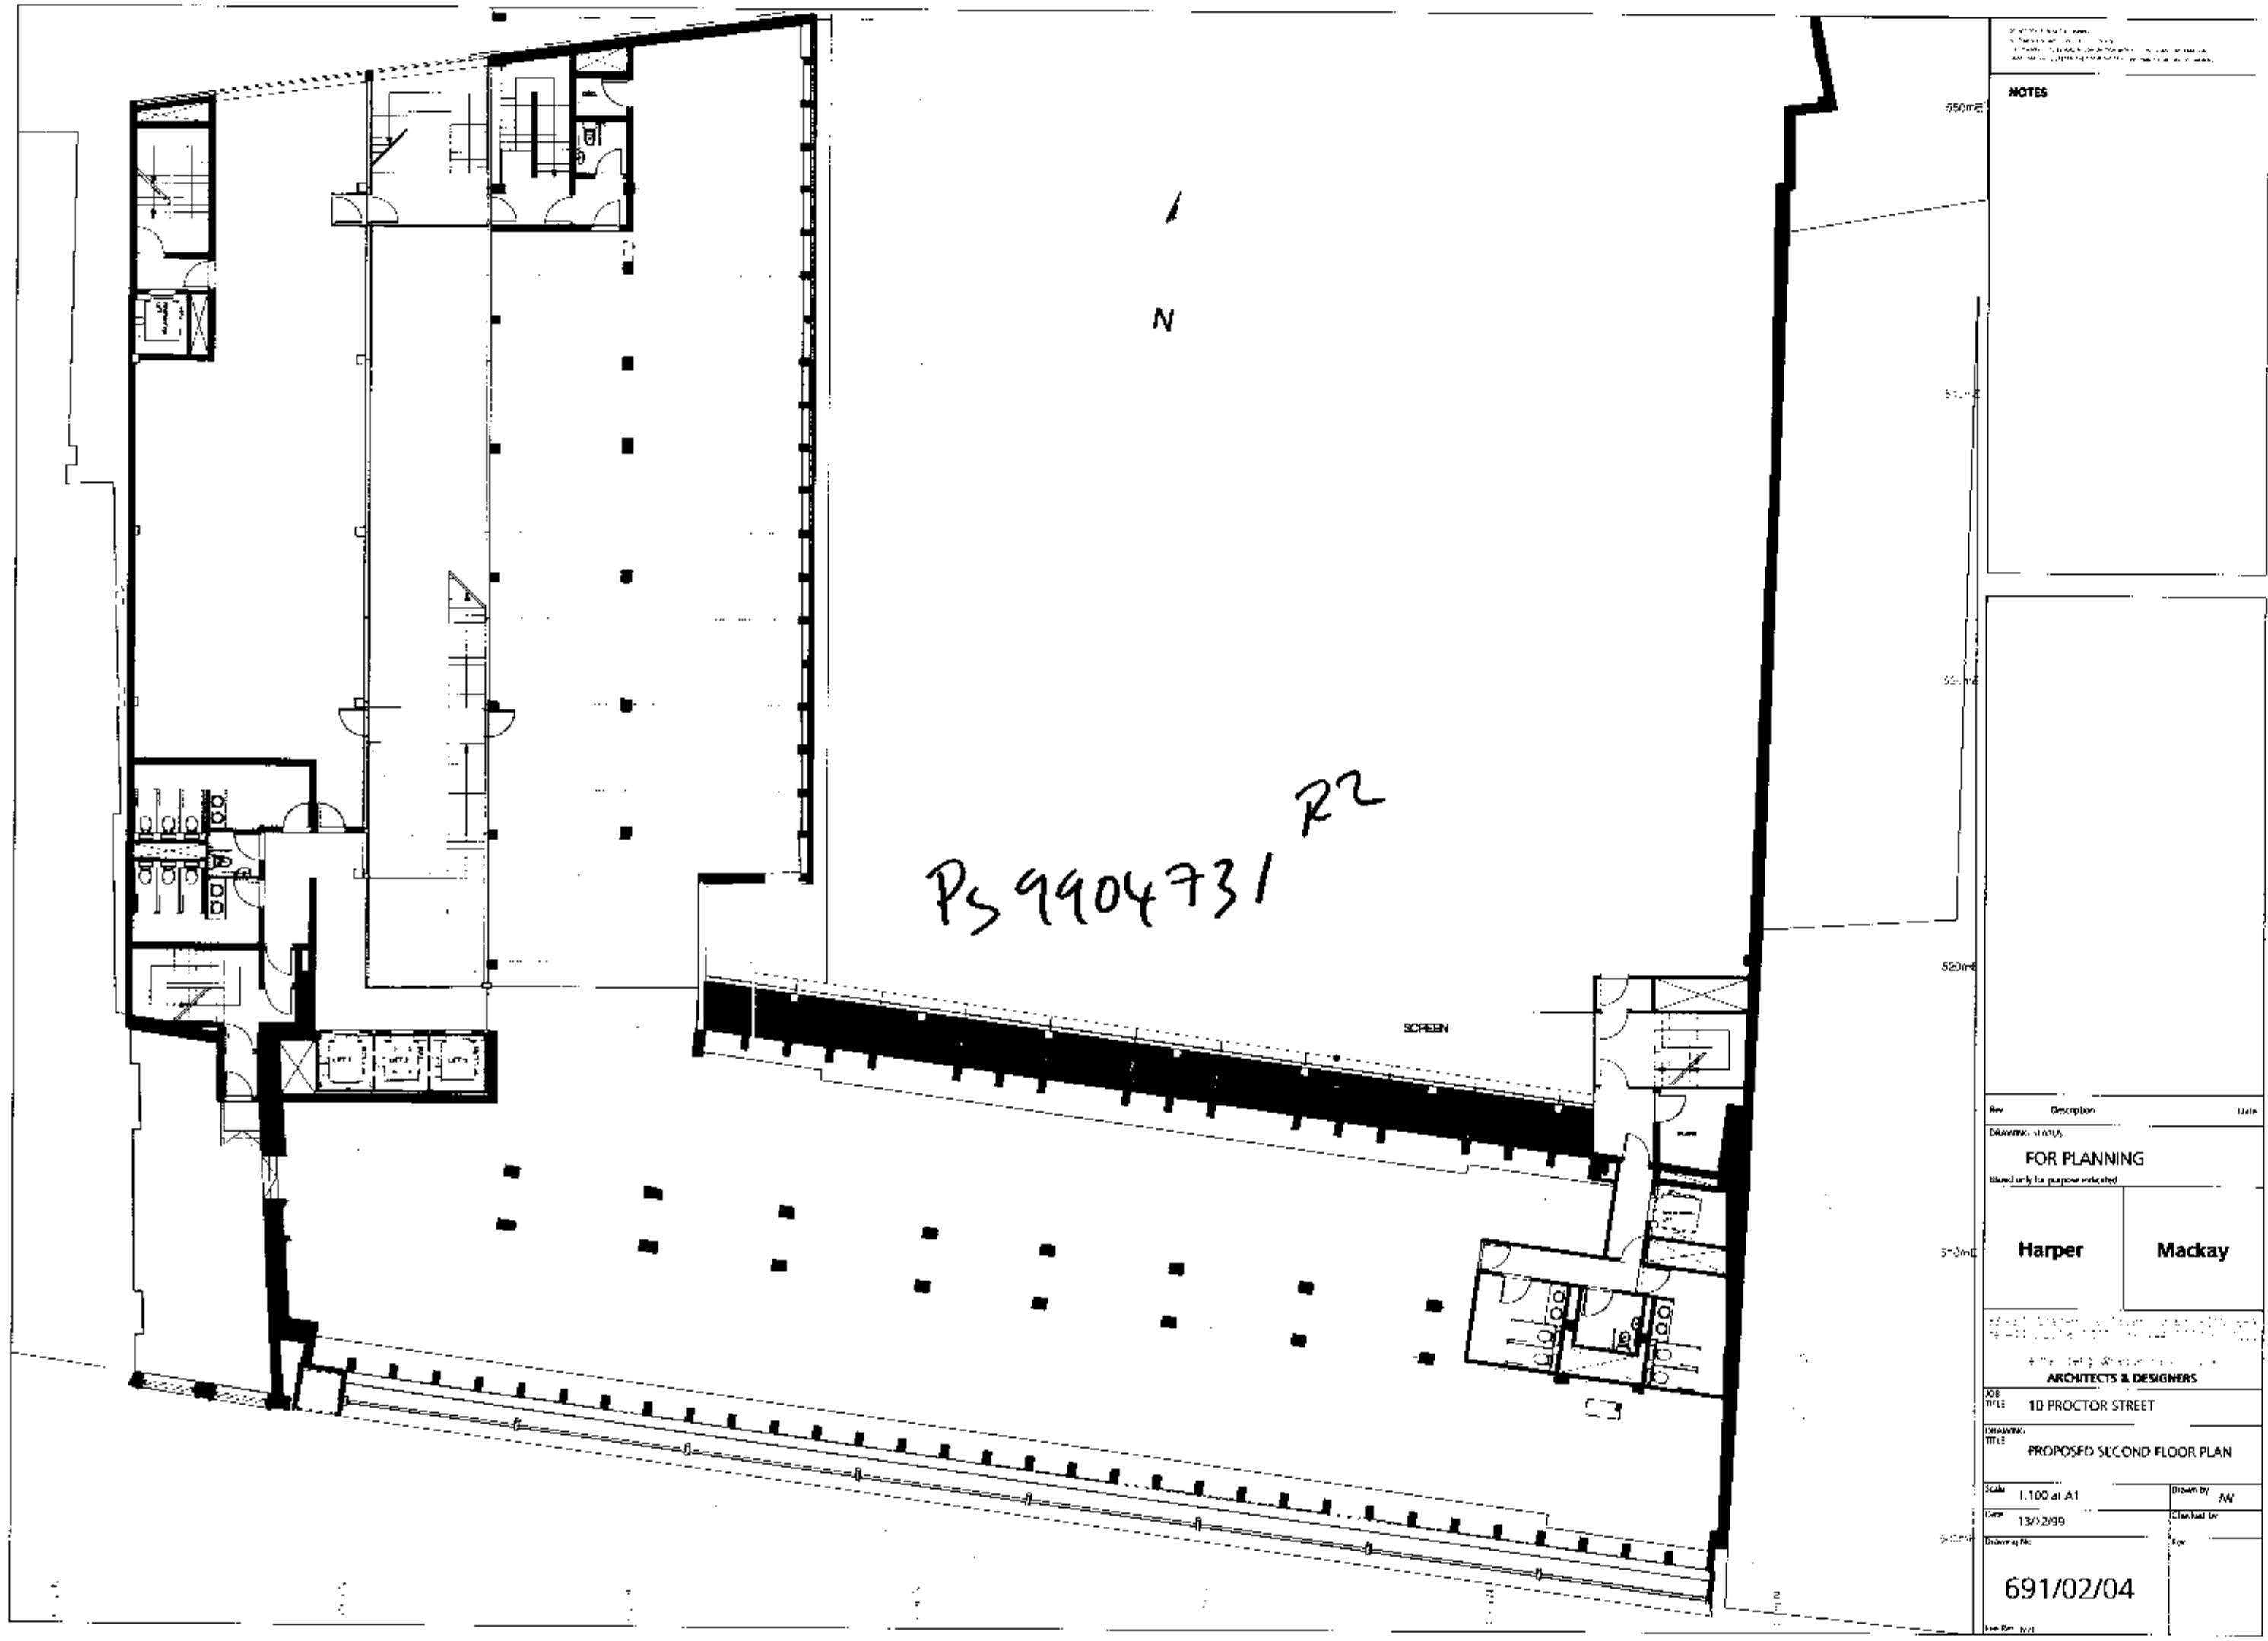
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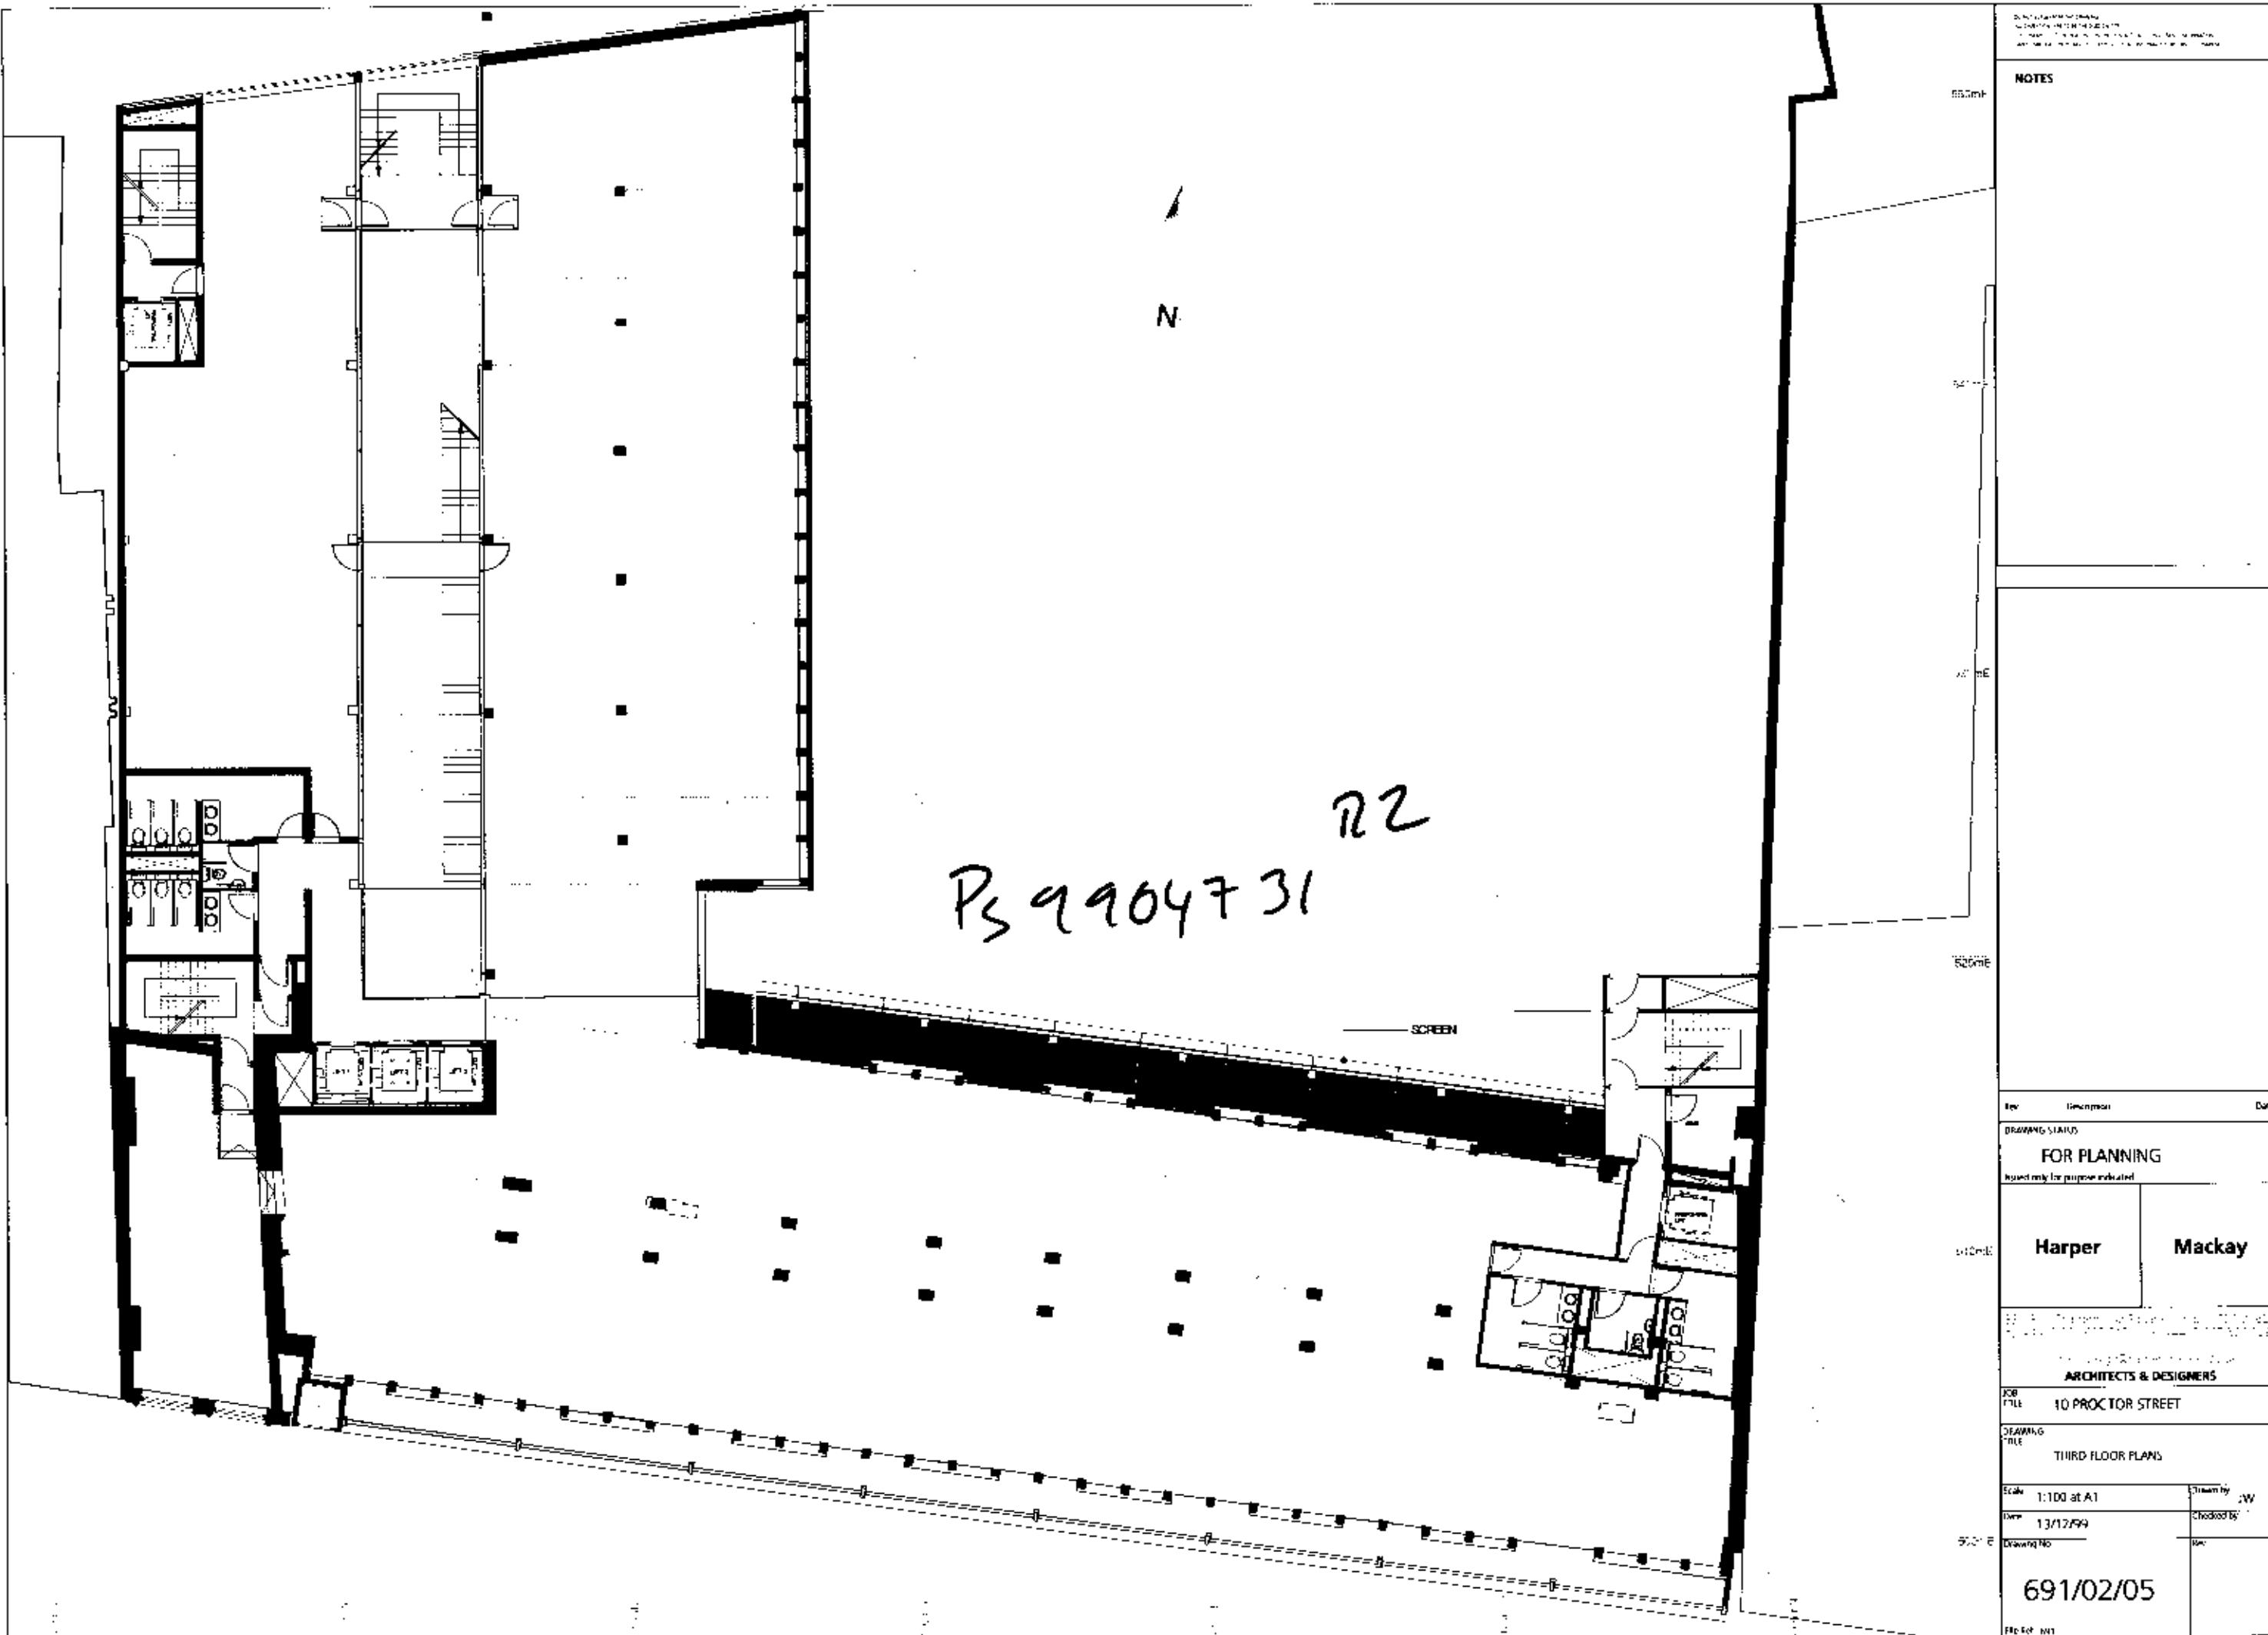
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Date	13/12/99	Checked by	XX
Drawing No	691/02/01	File Ref.	4/21


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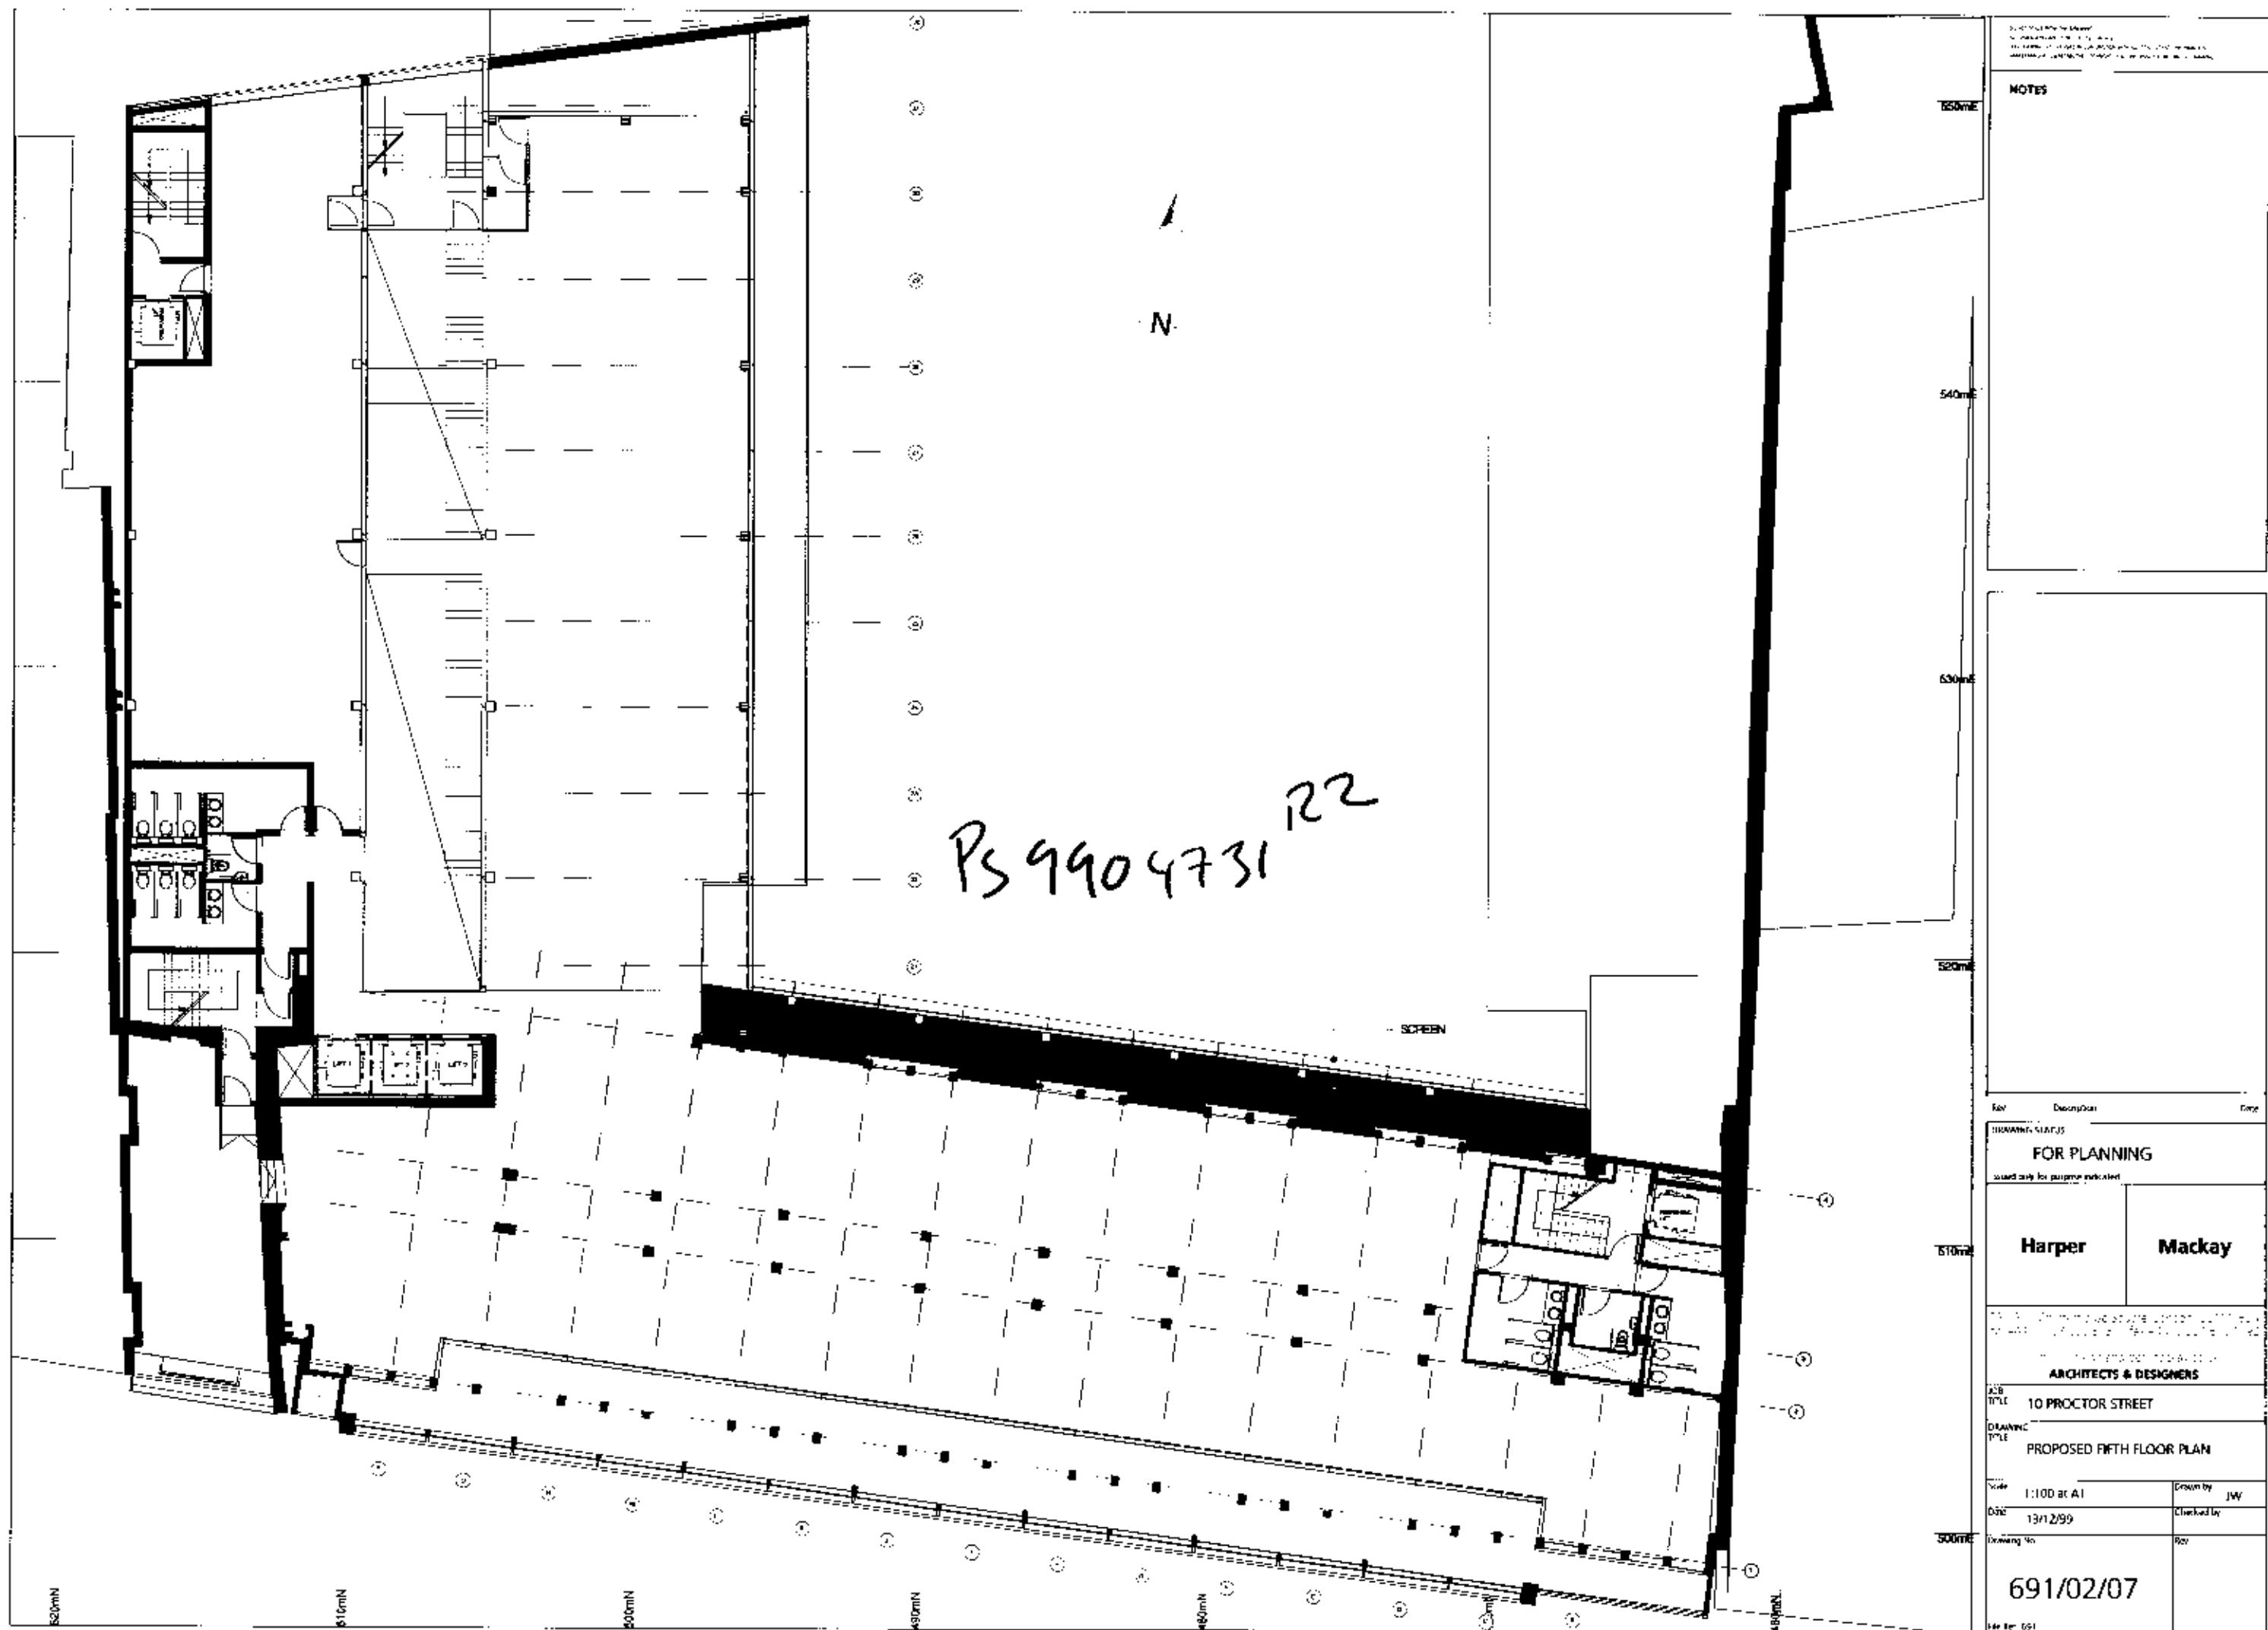








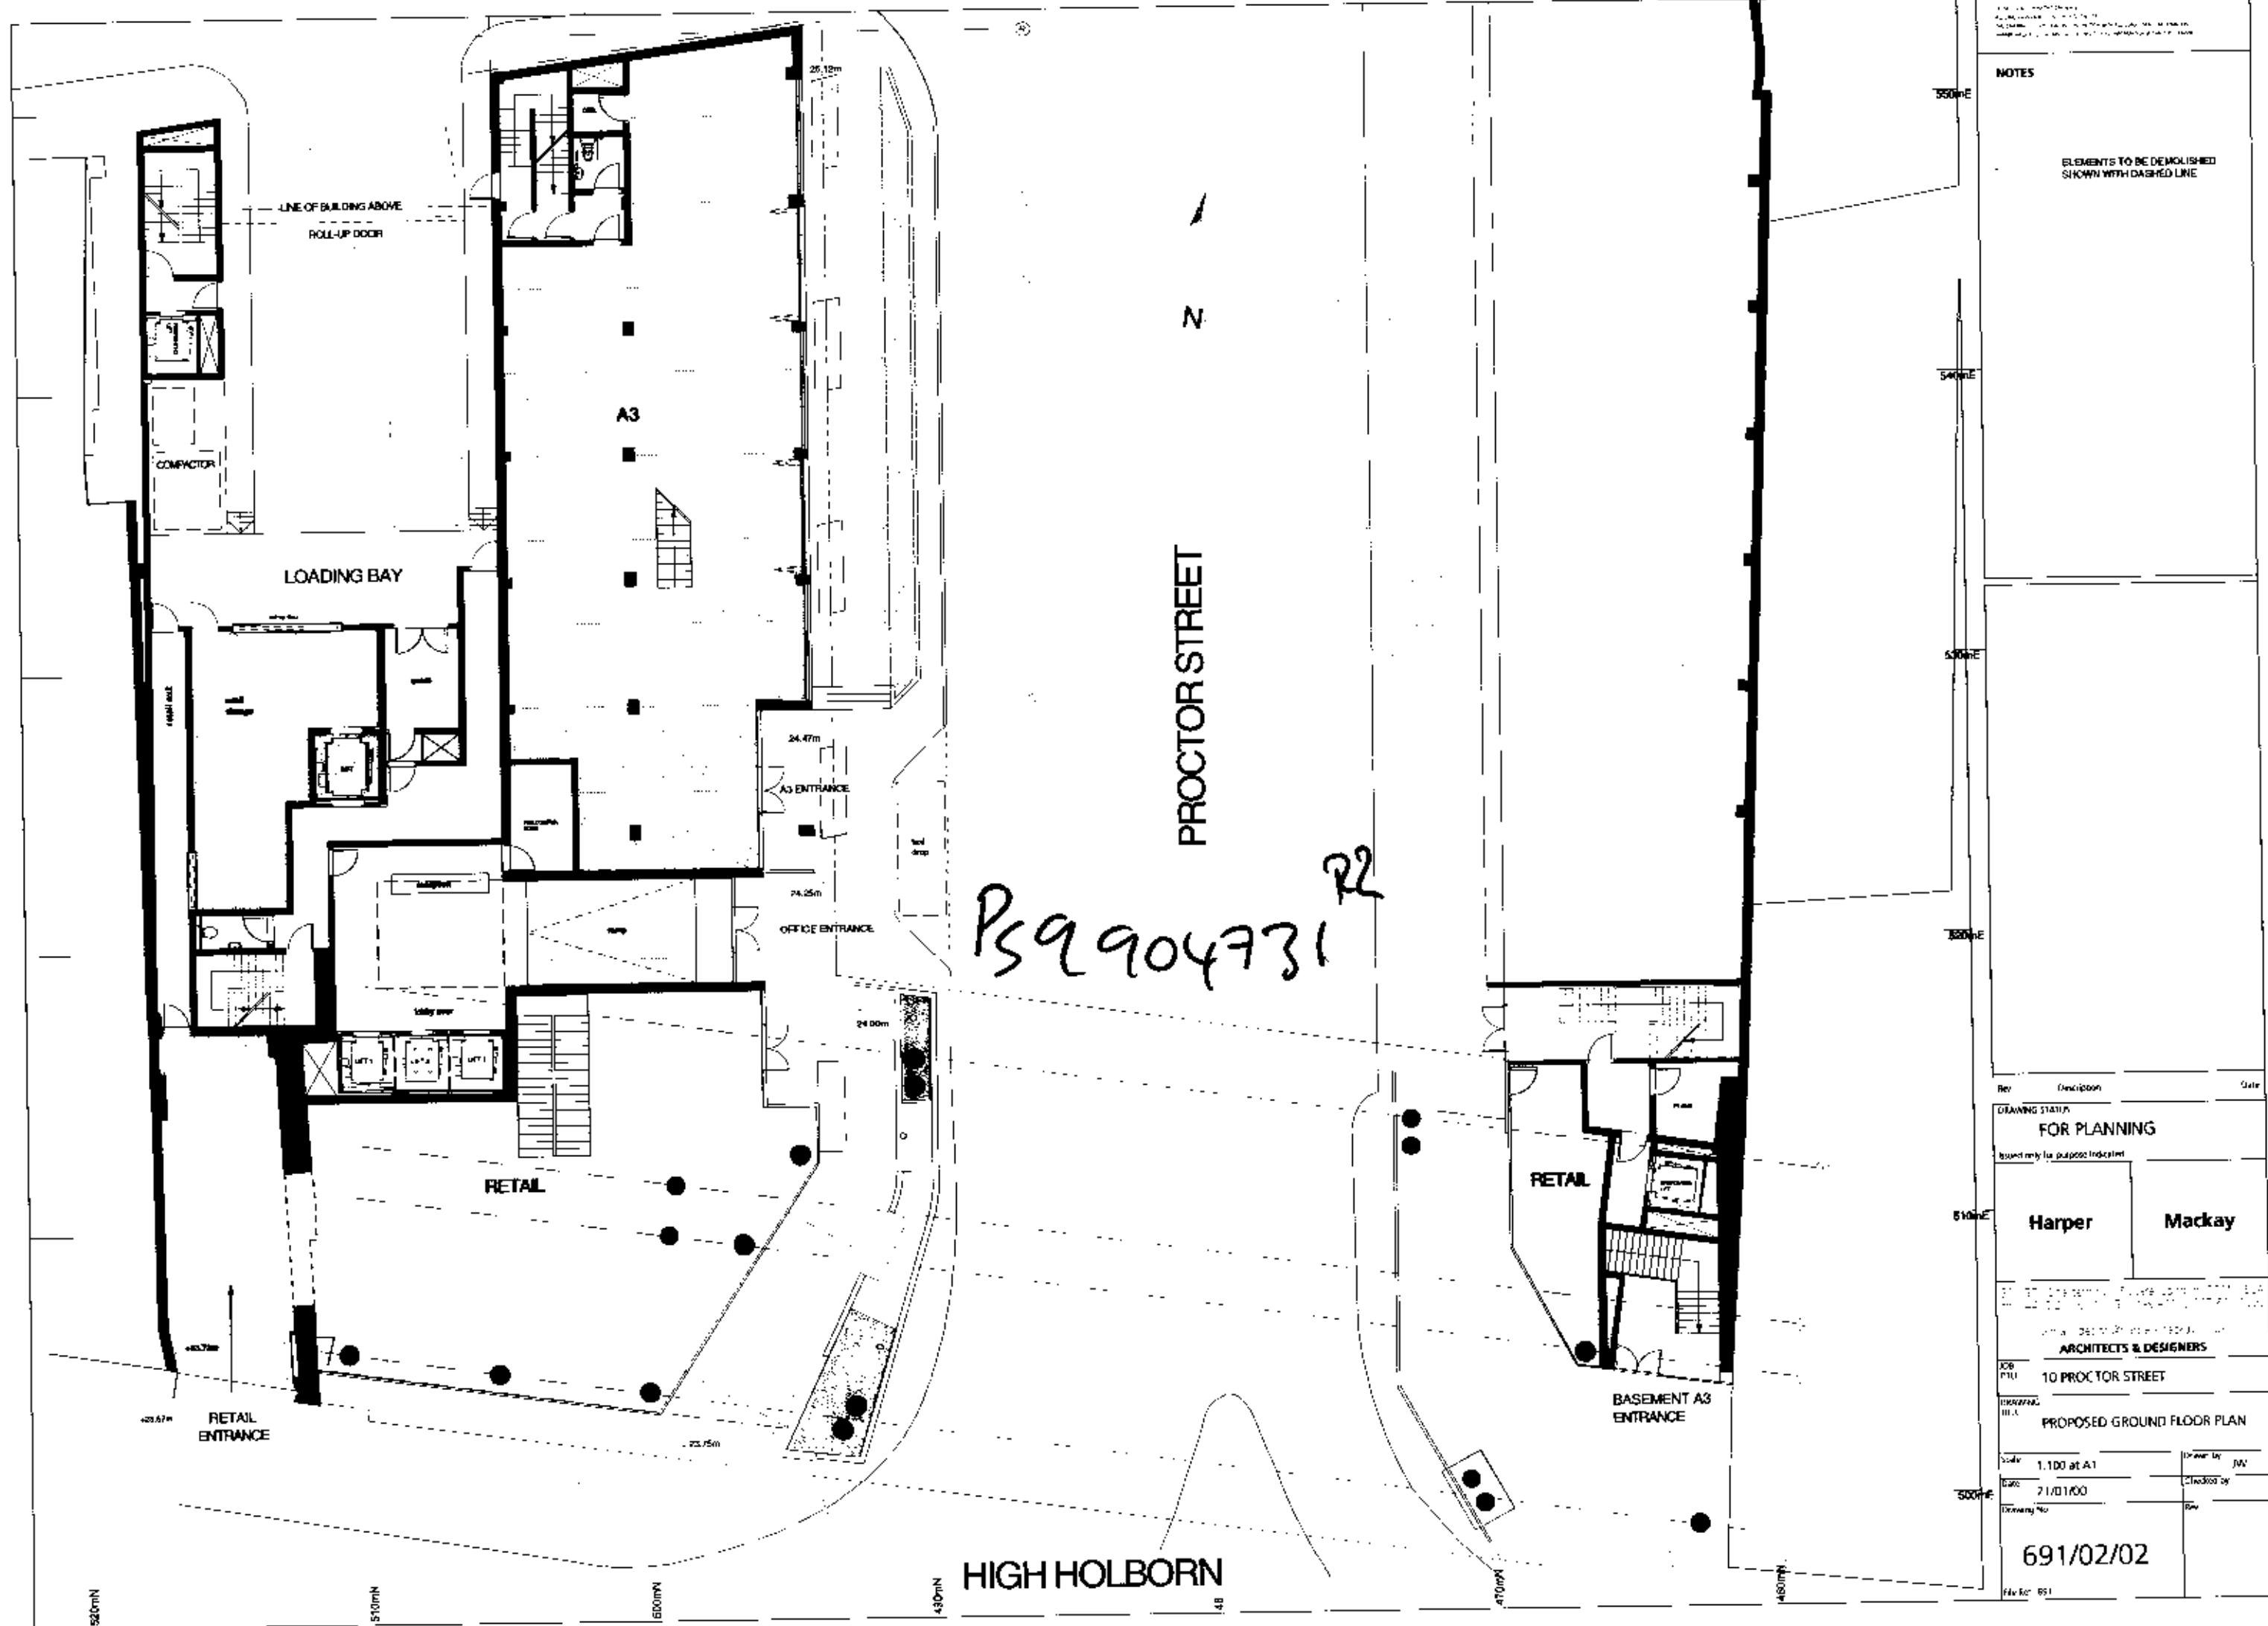


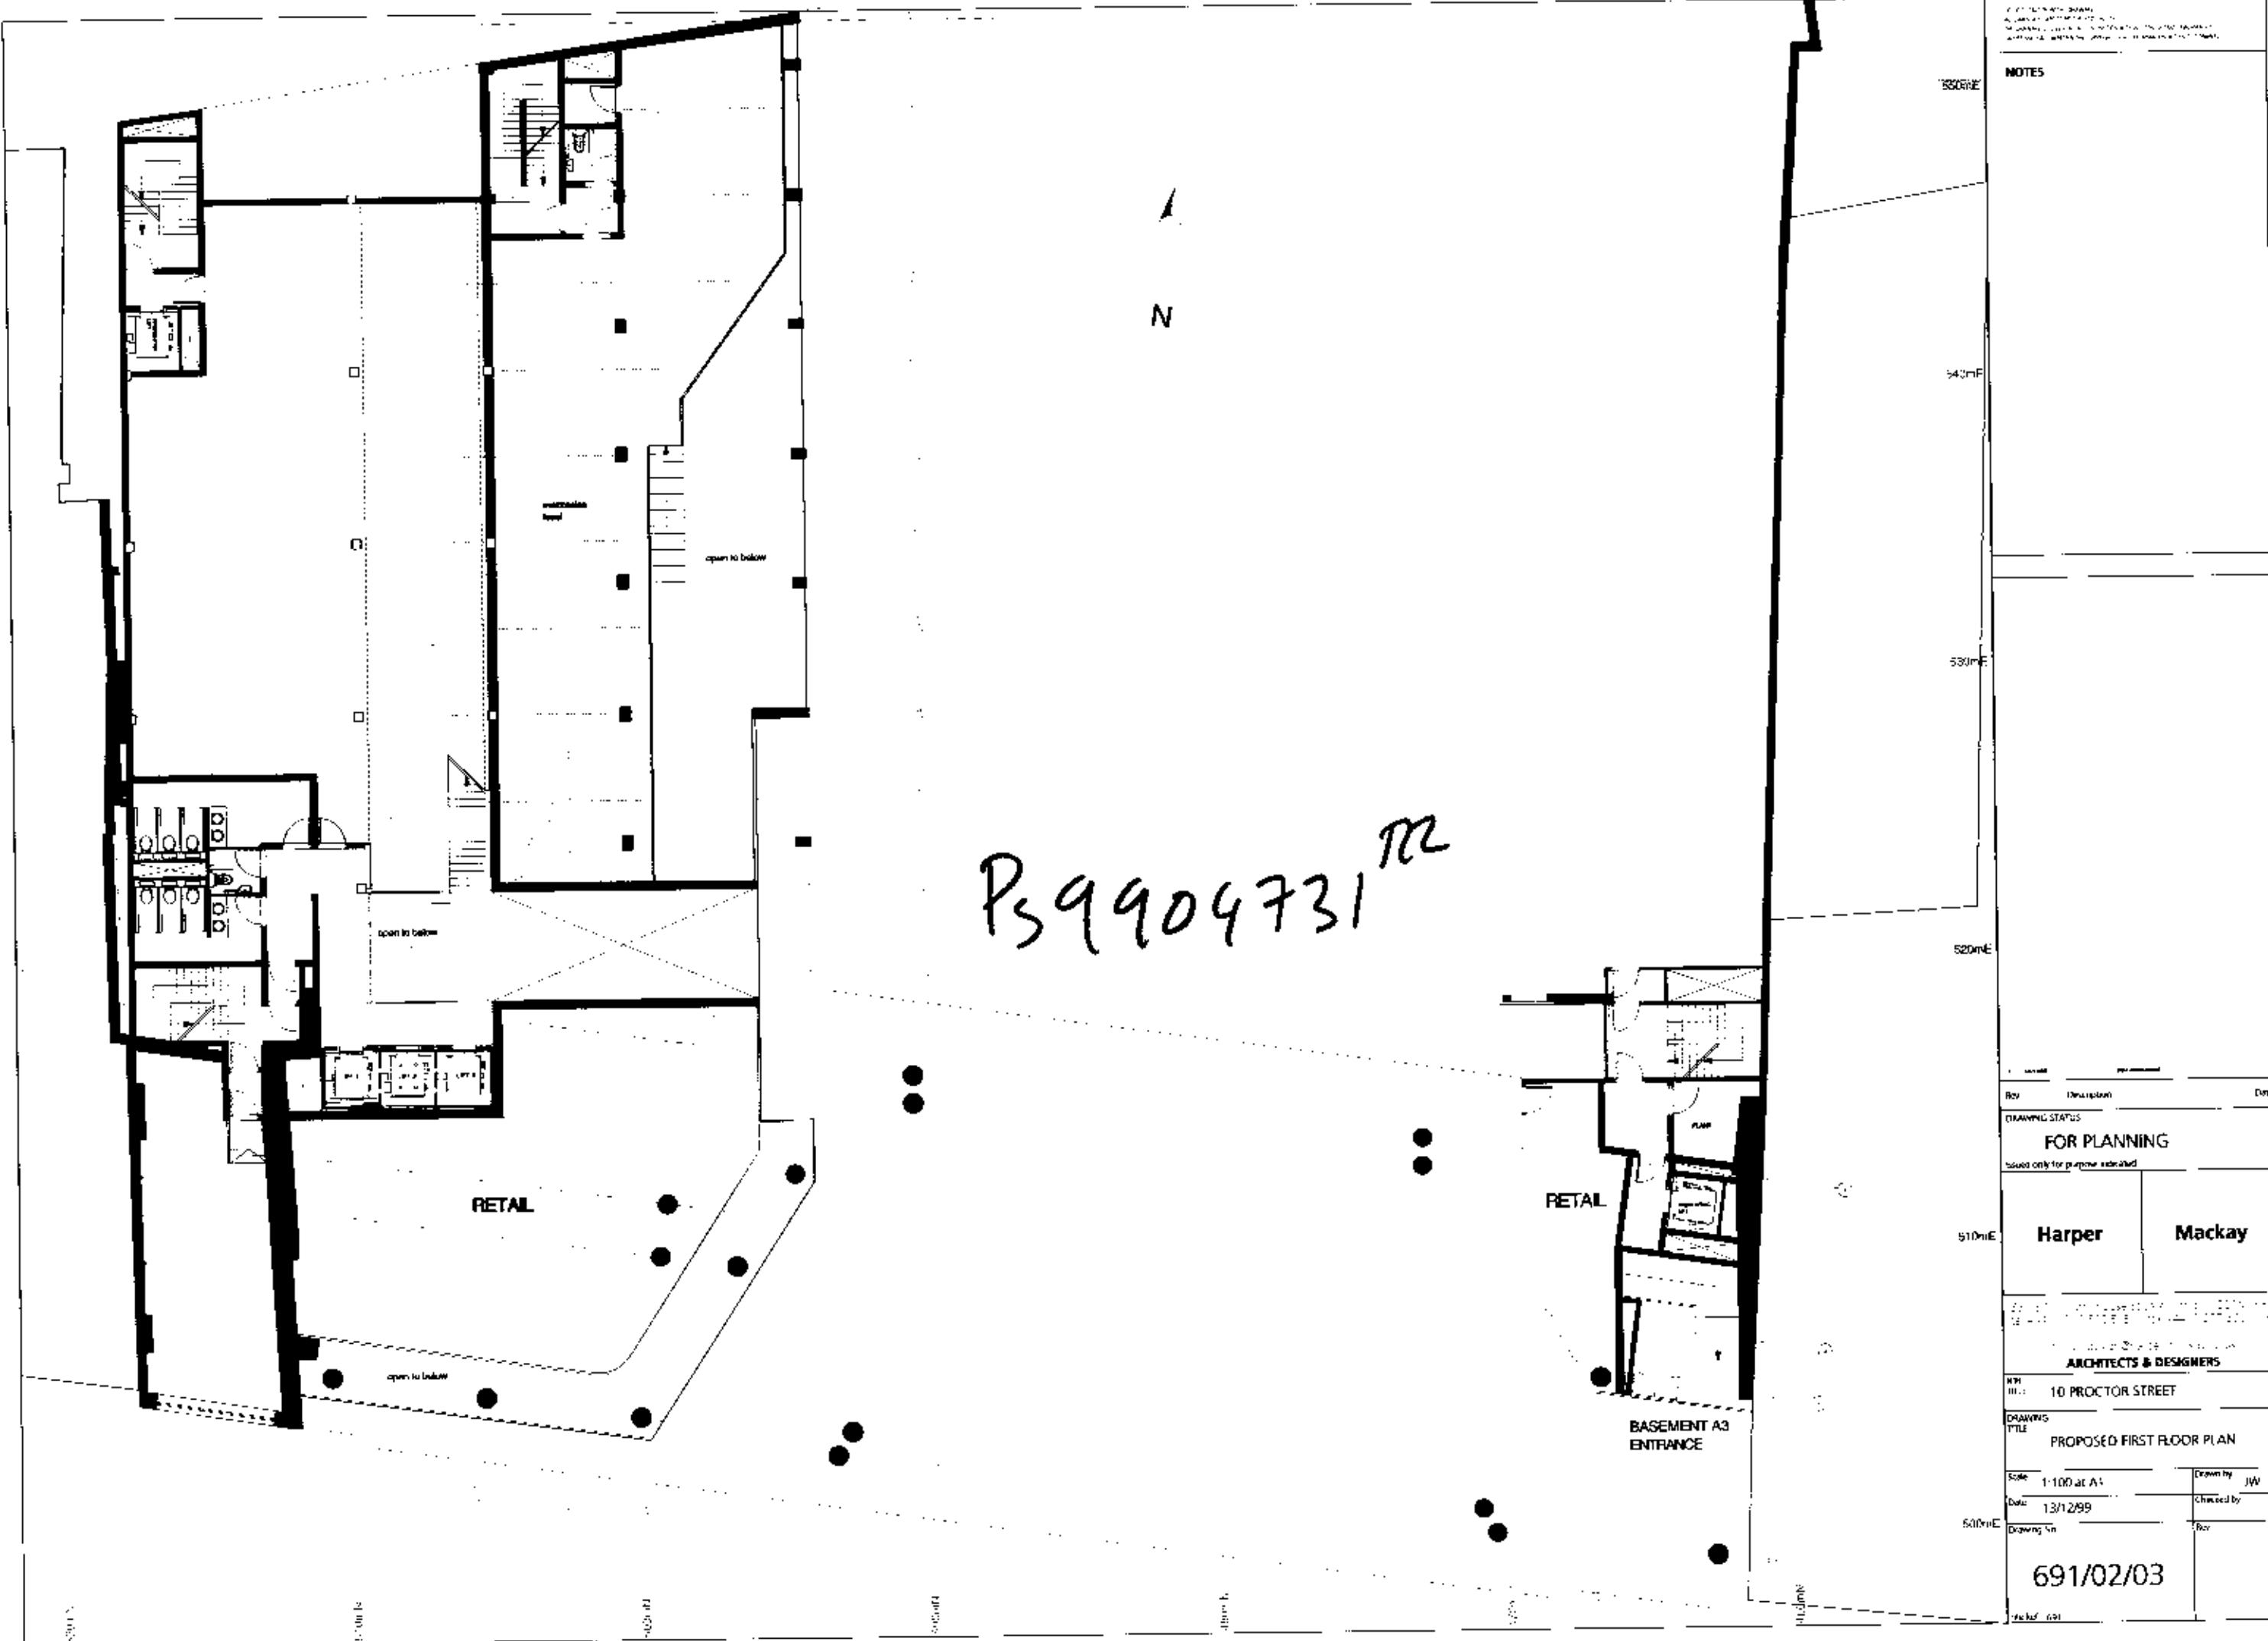

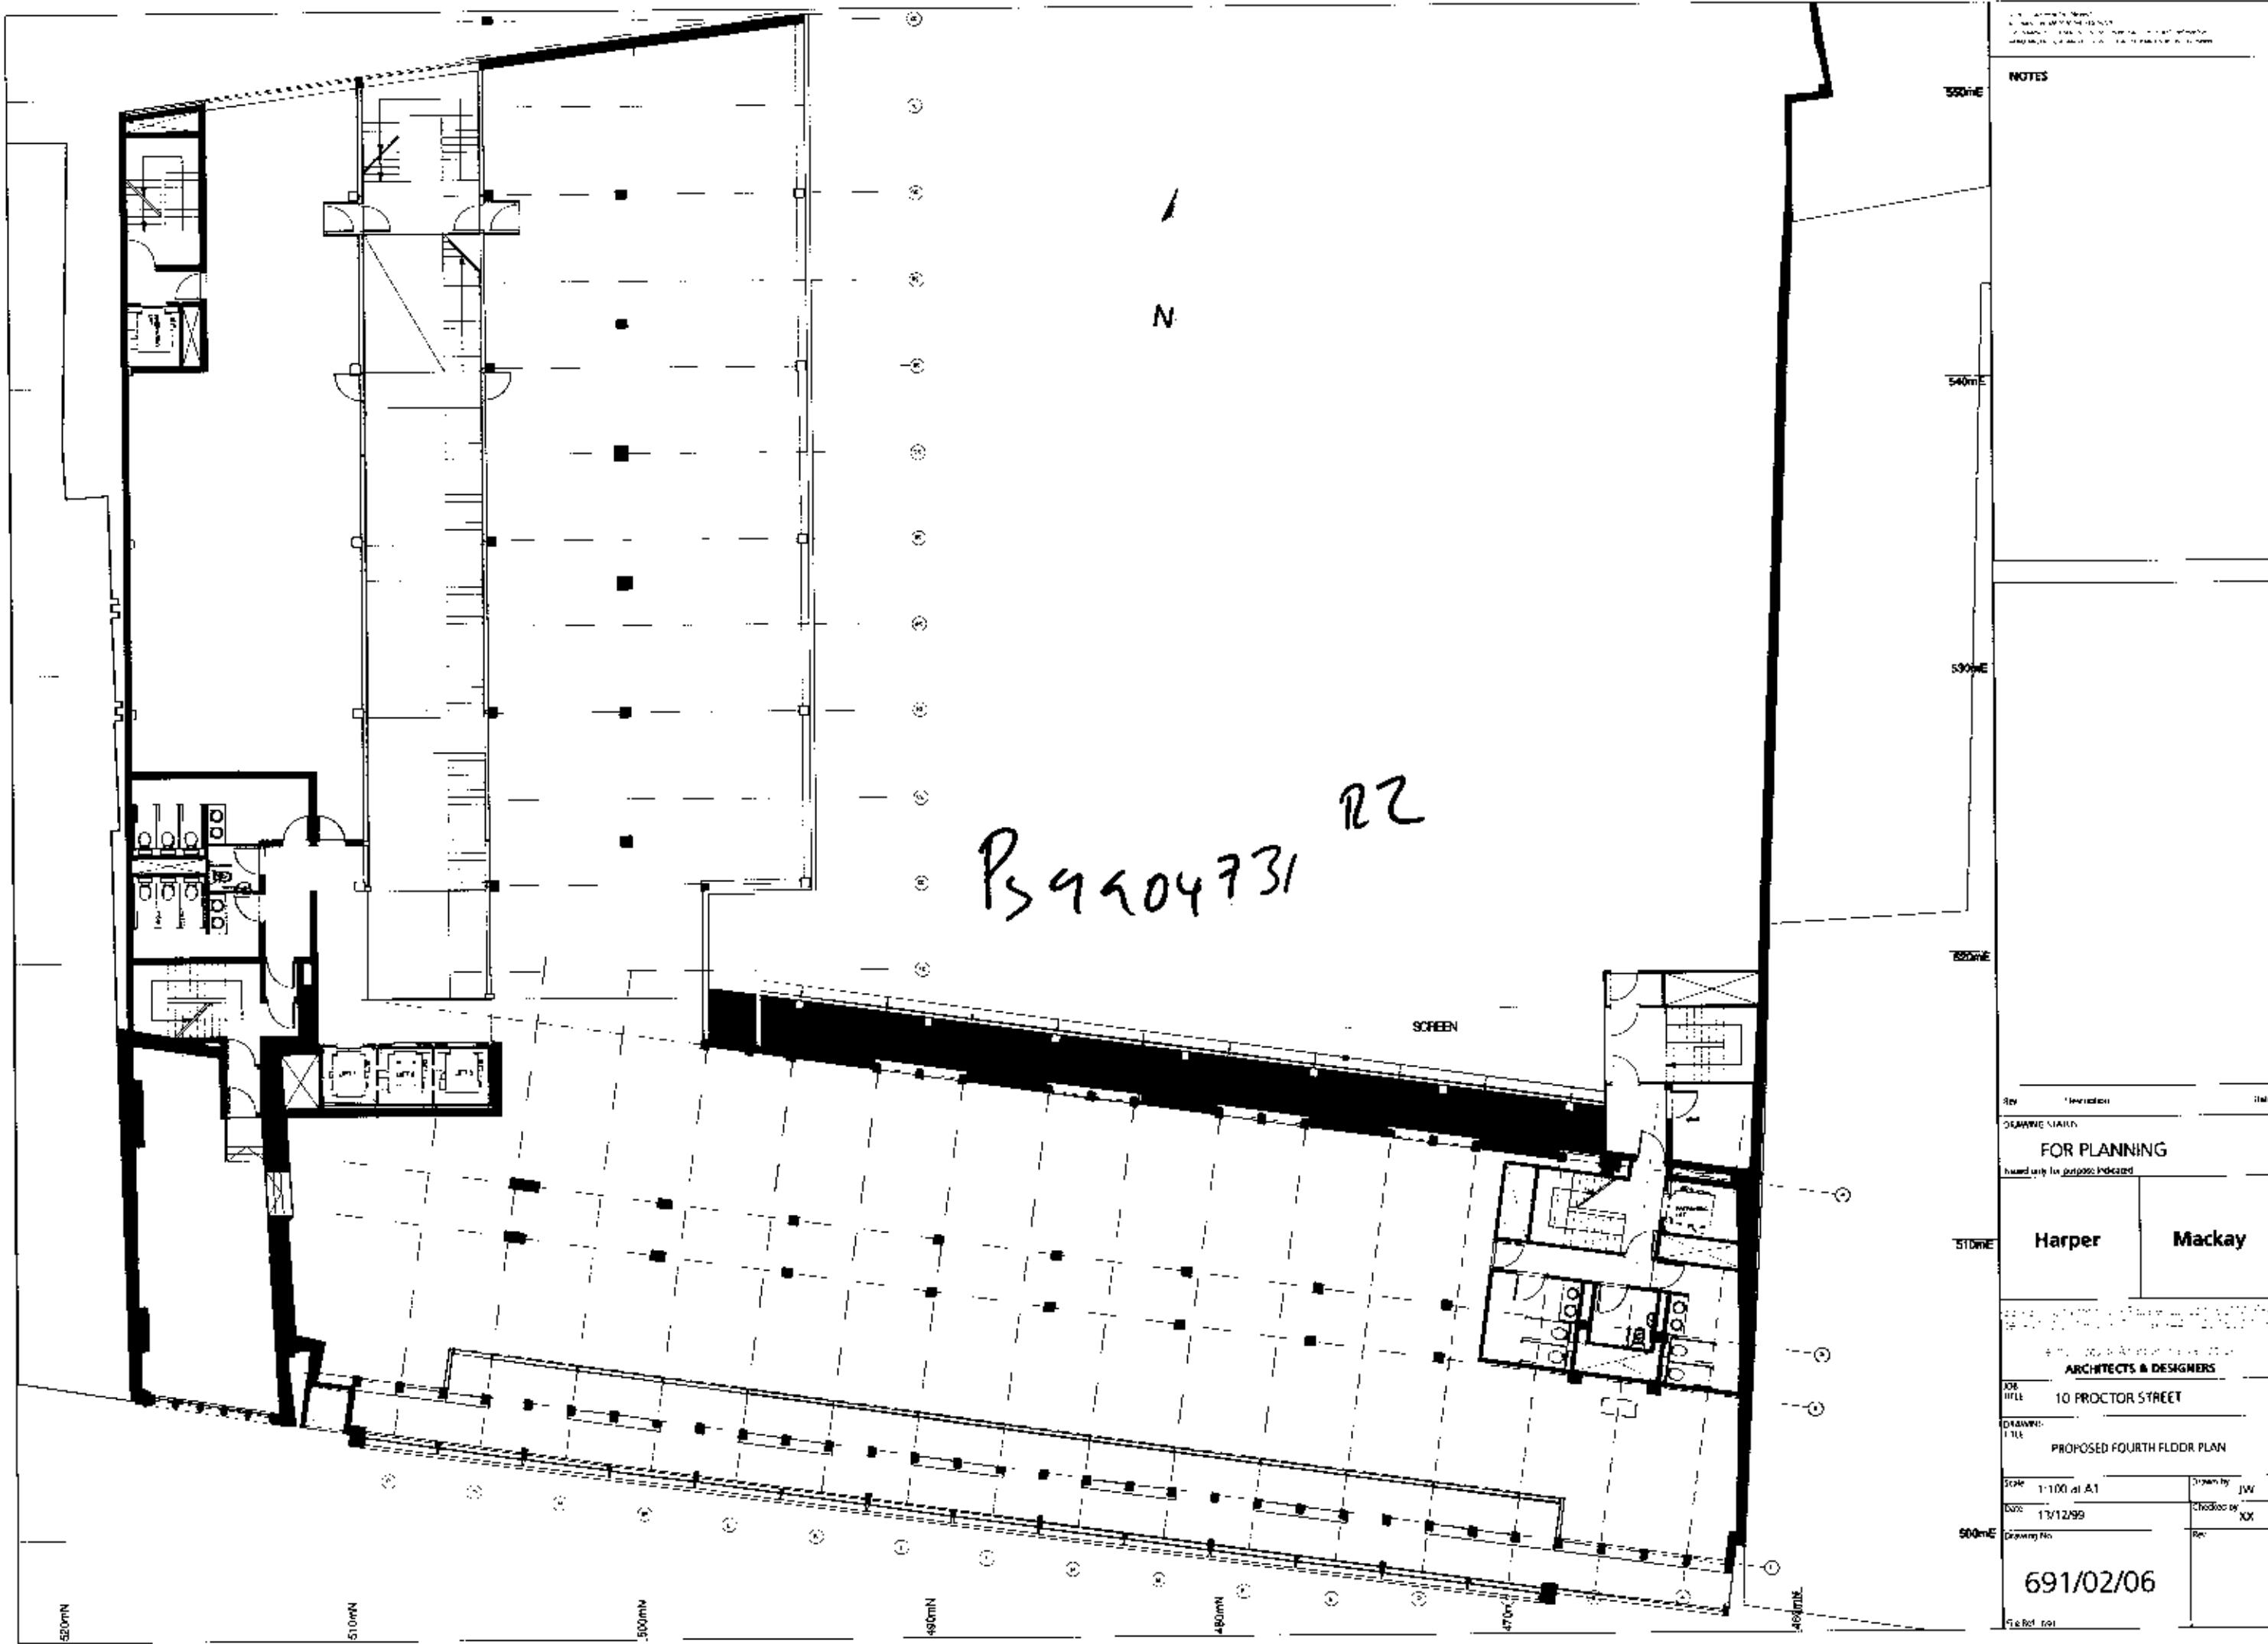

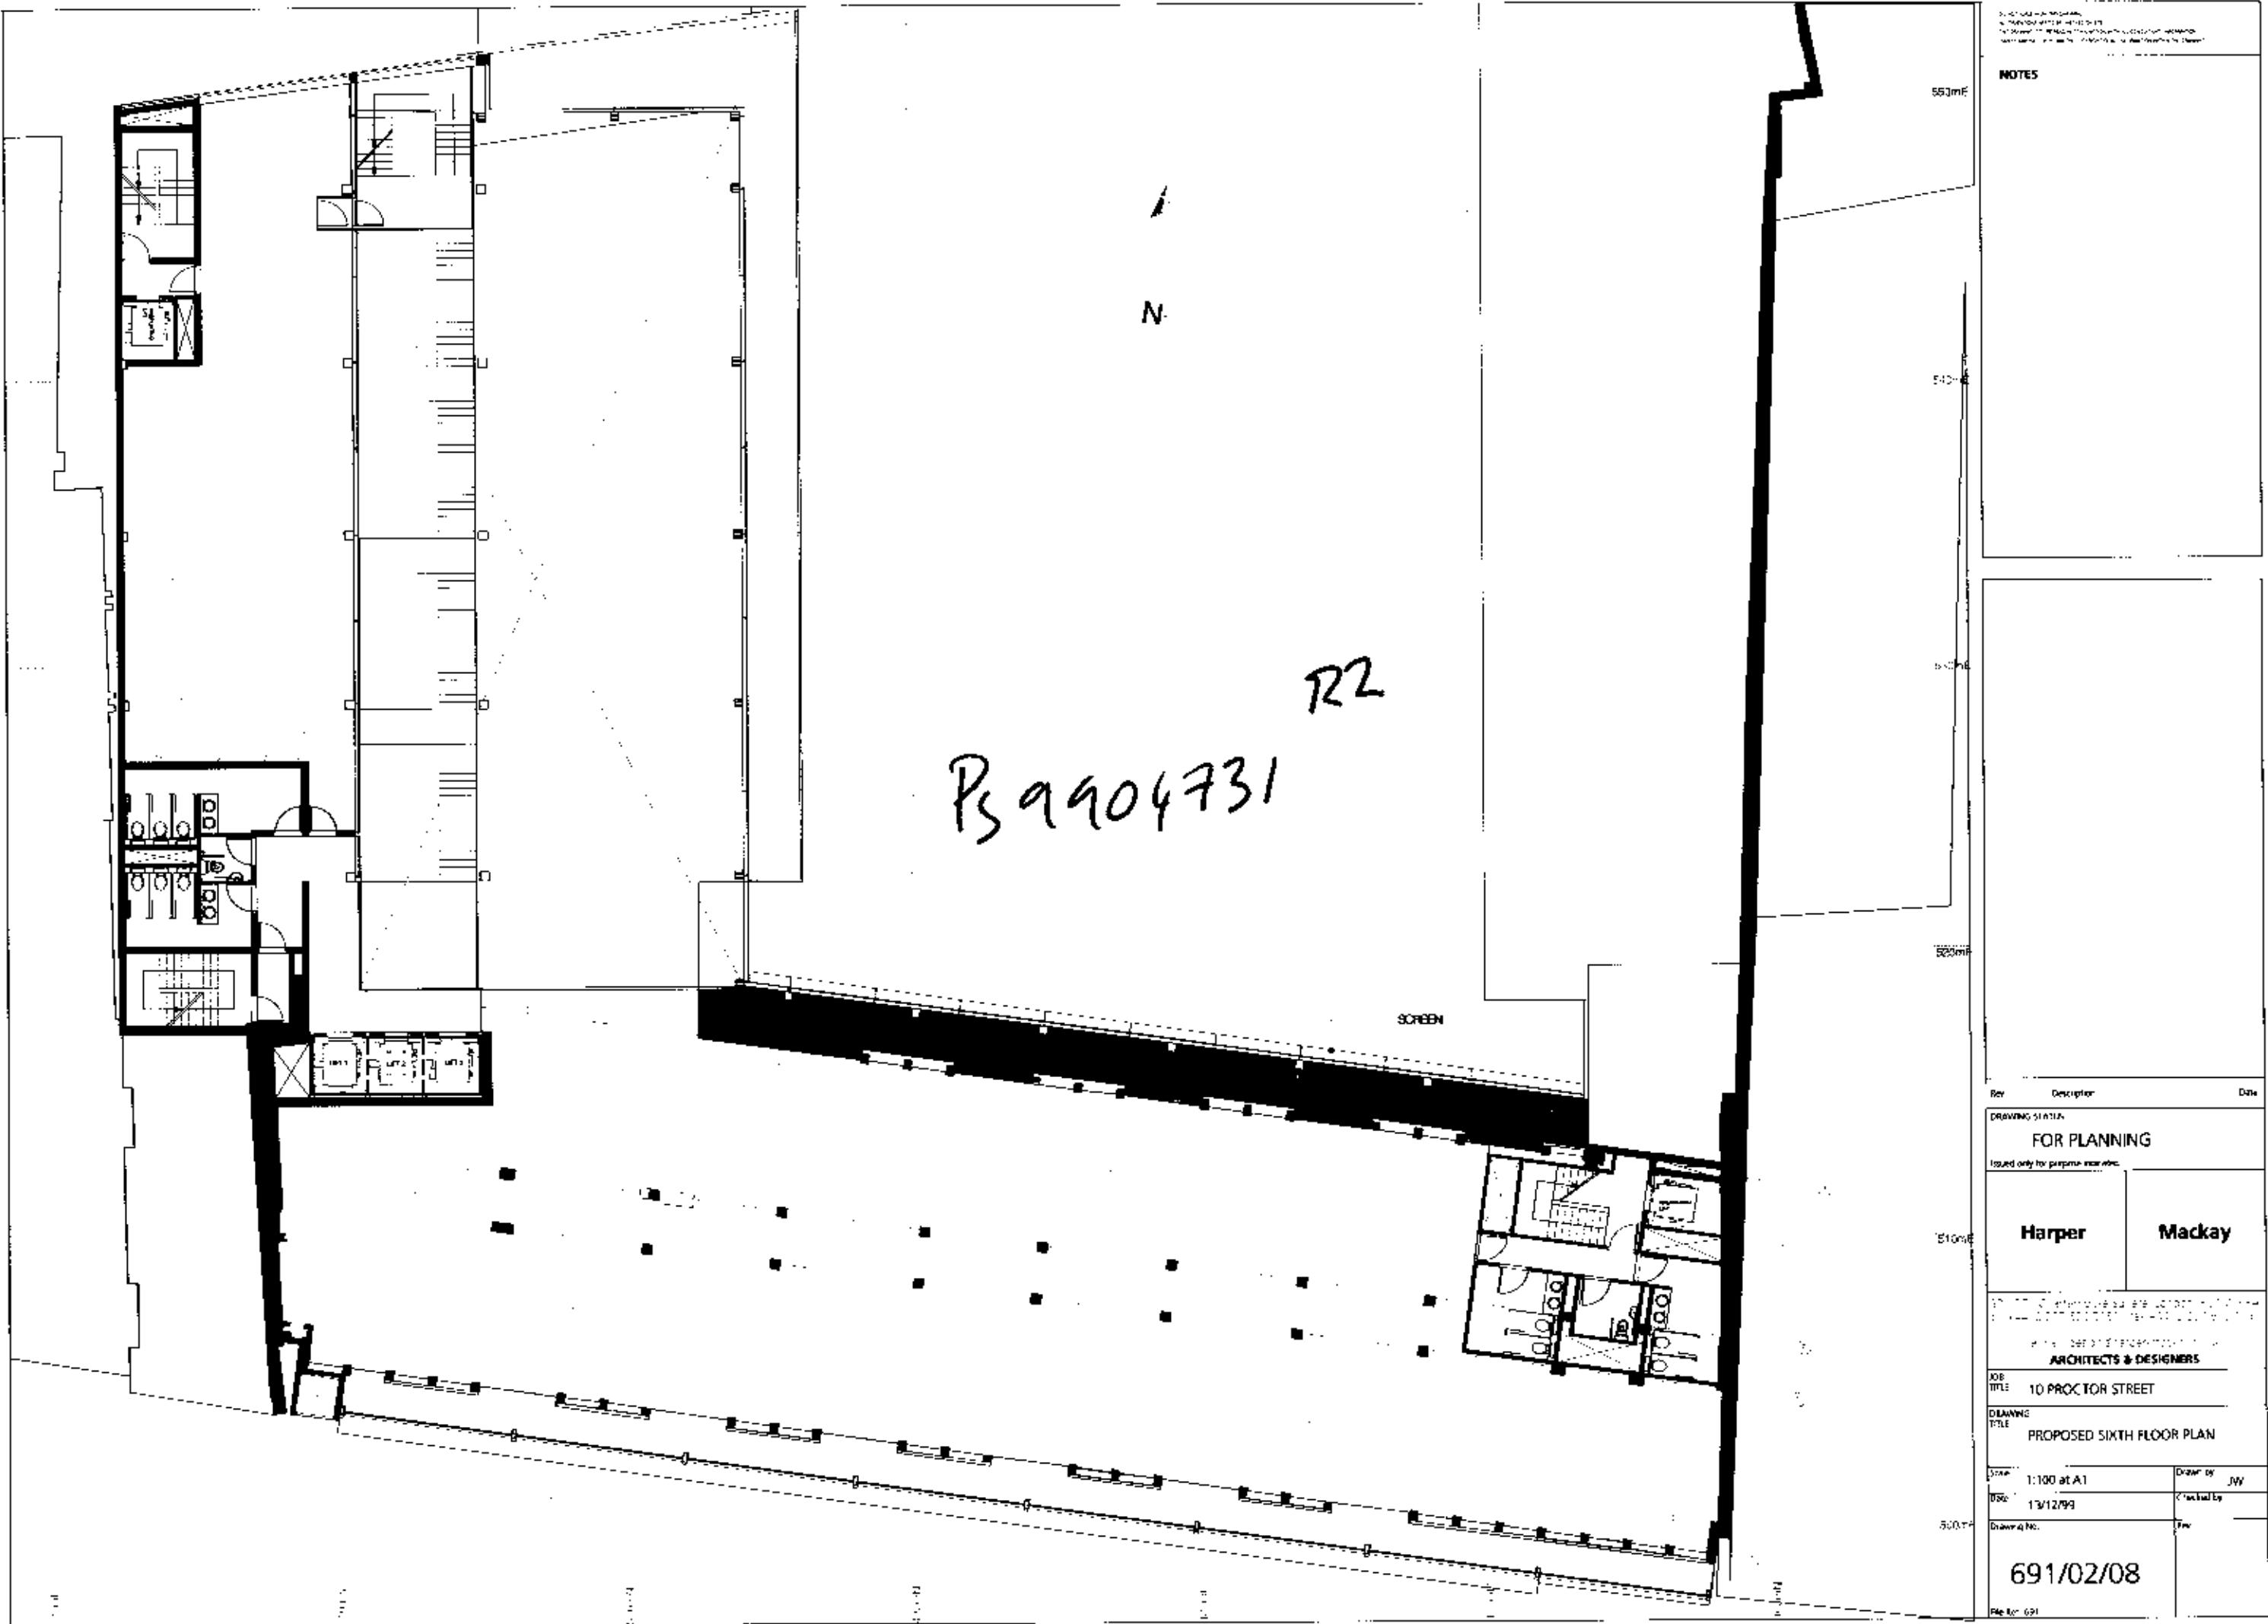

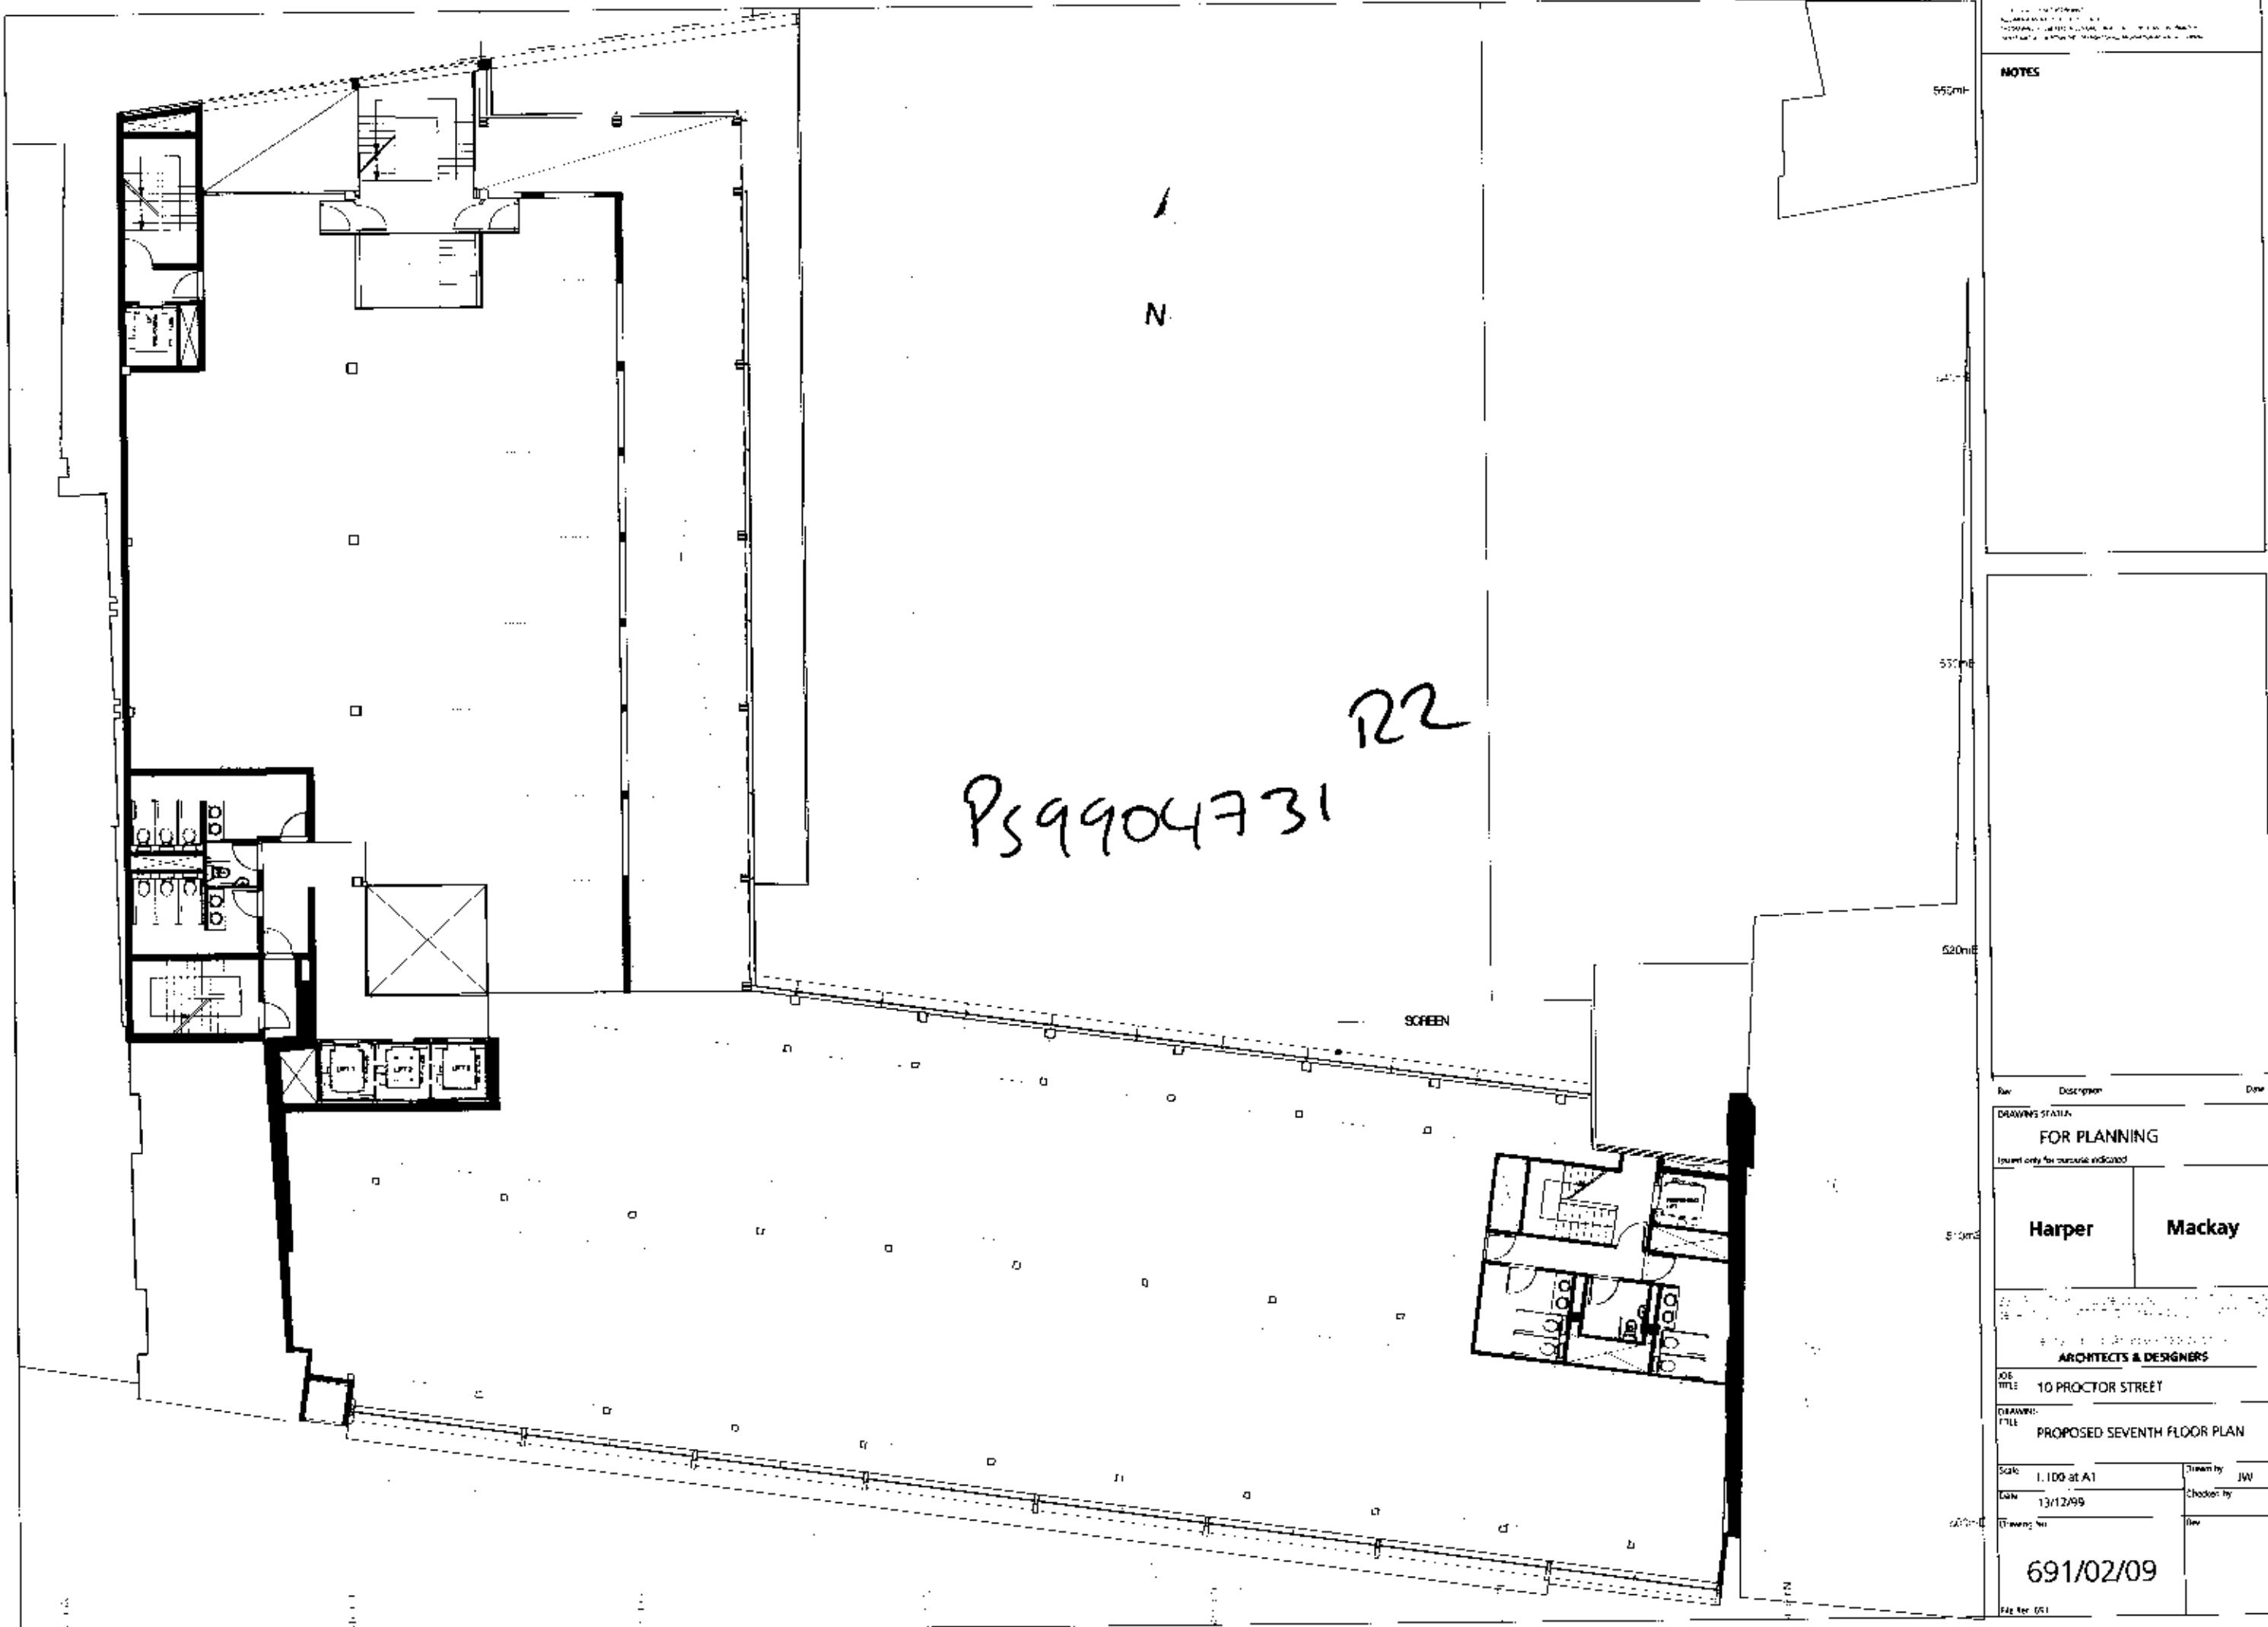

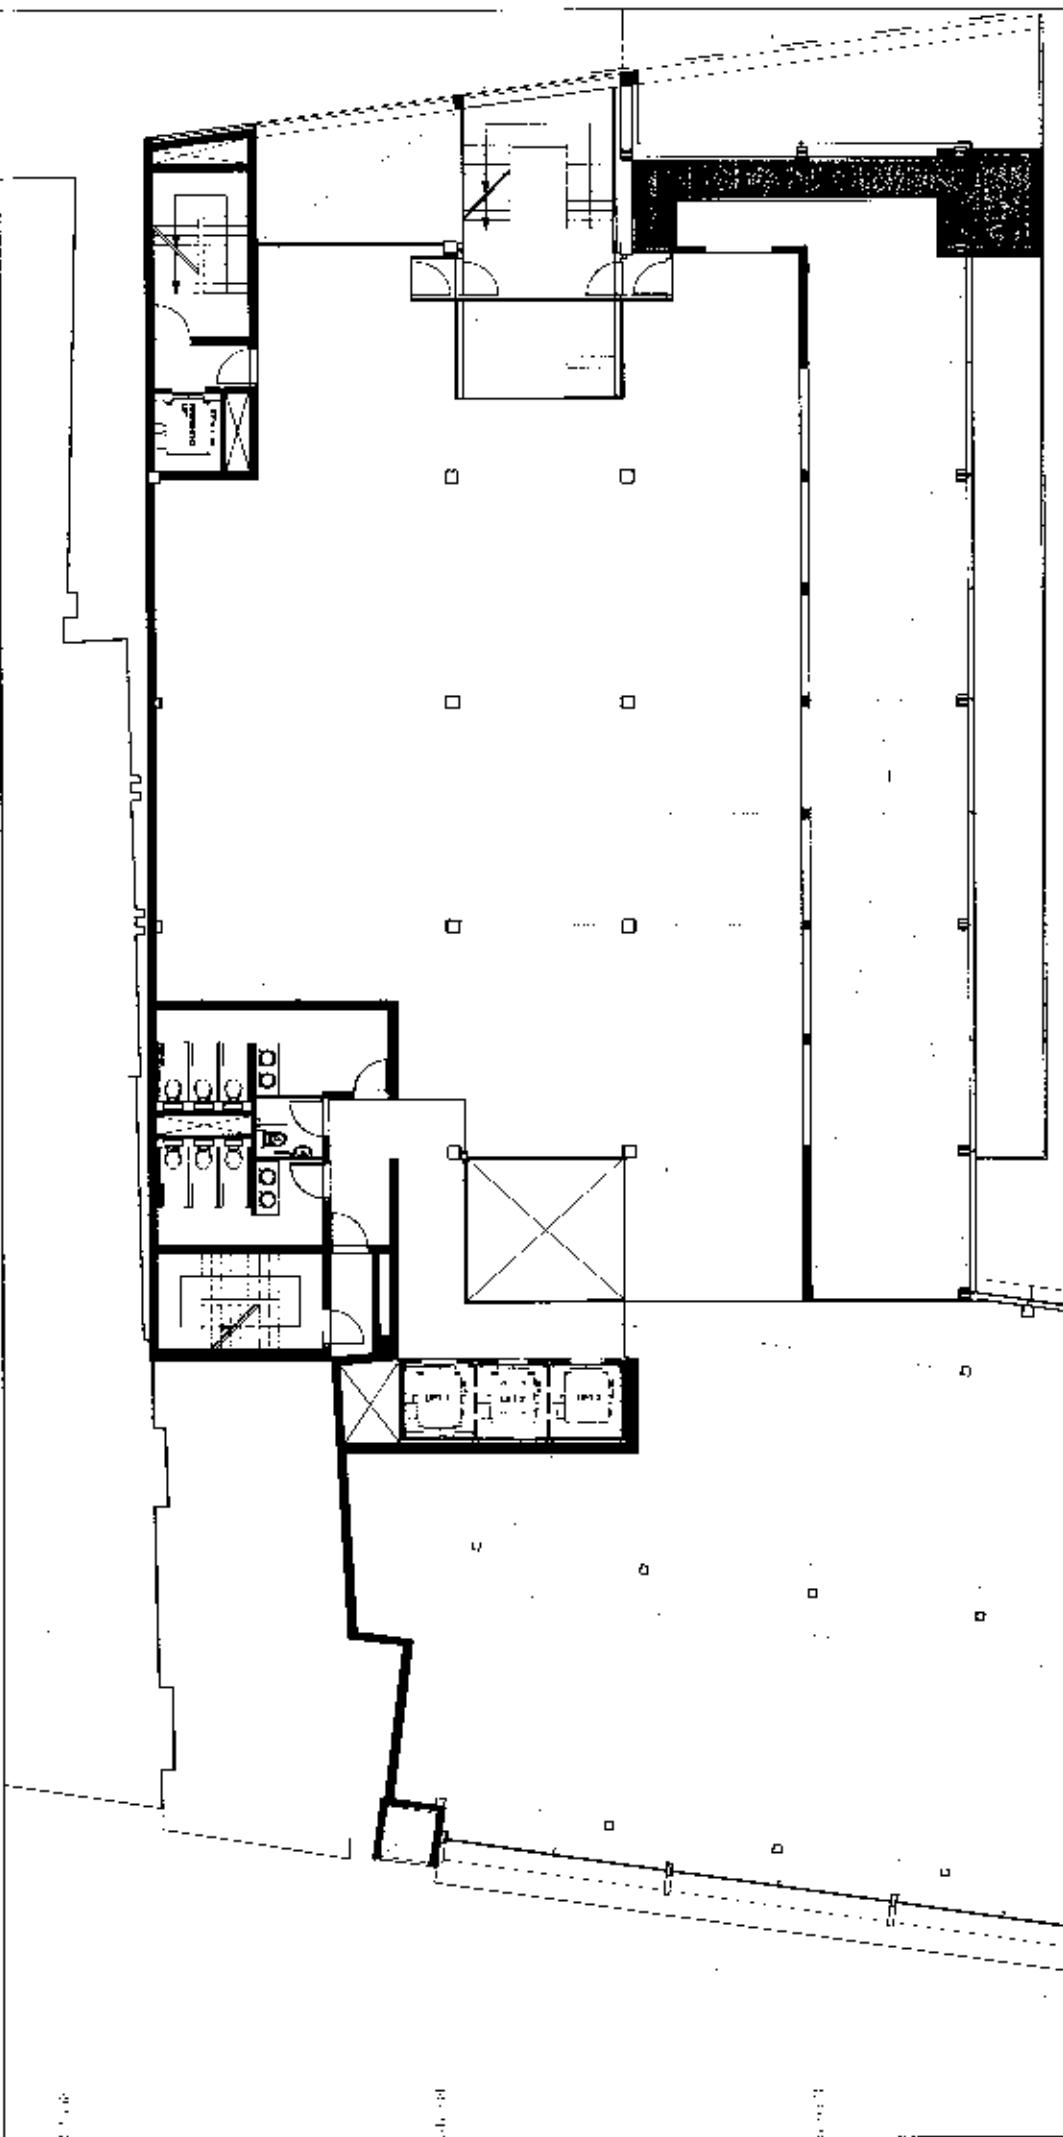

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5270mW

5280mW

5290mW

5300mW

5310mW

5320mW

5330mW

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5350mW

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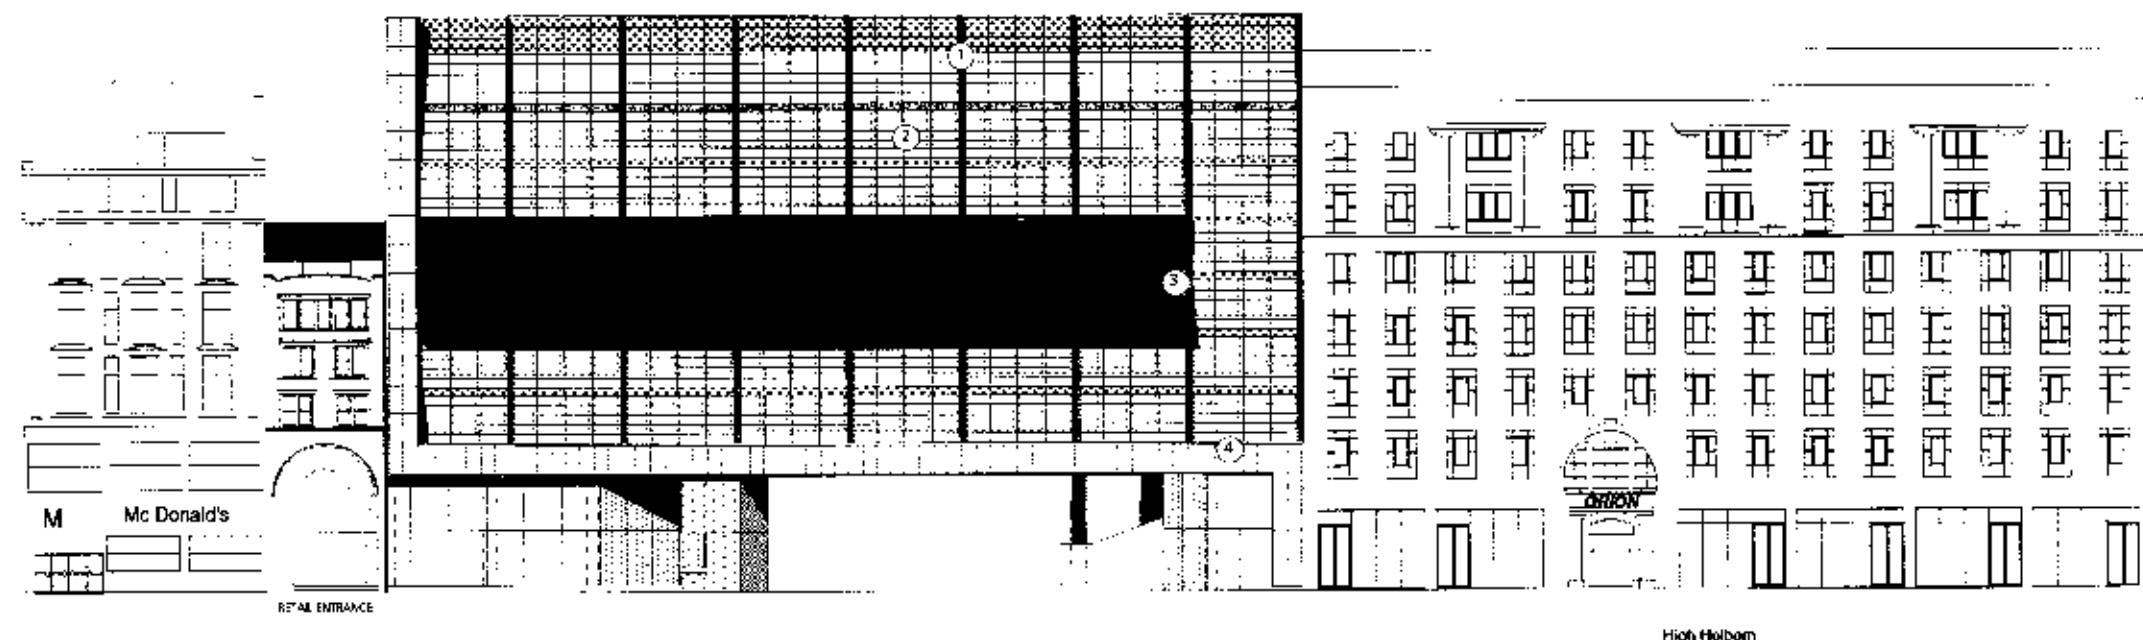
6310mW

- 1 TIMBER GLULAM MULLIONS
- 2 CURTAIN WALLING
- 3 TIMBER FRAME & TIMBER LOUVERS
- 4 BACK LIT GLAZED SCREEN

KEY PLAN

NOTES

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Date 11/01/00 CHECKED BY RS


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London Street

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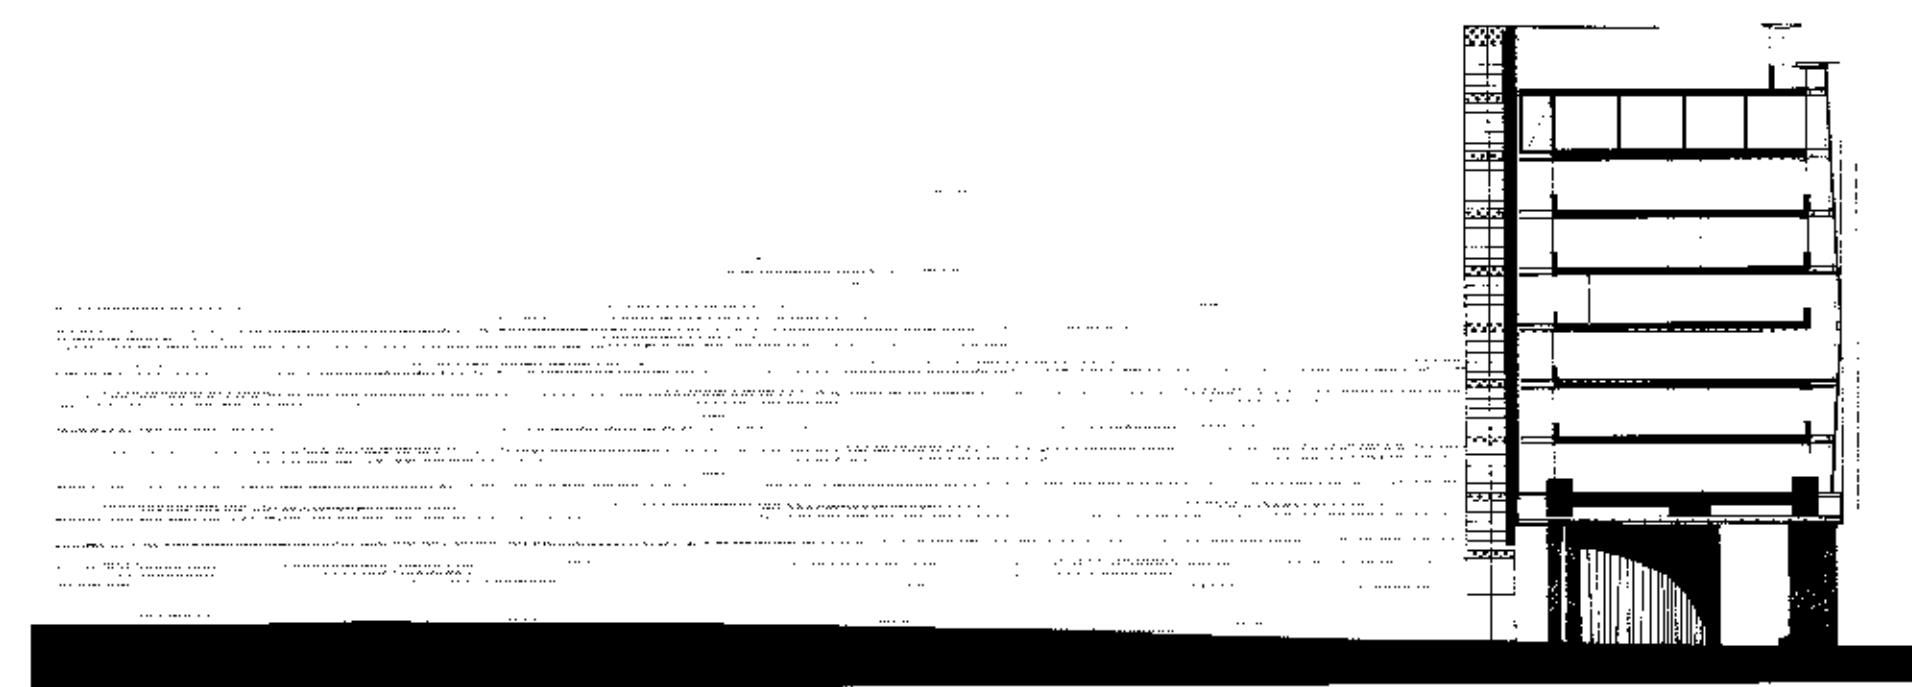
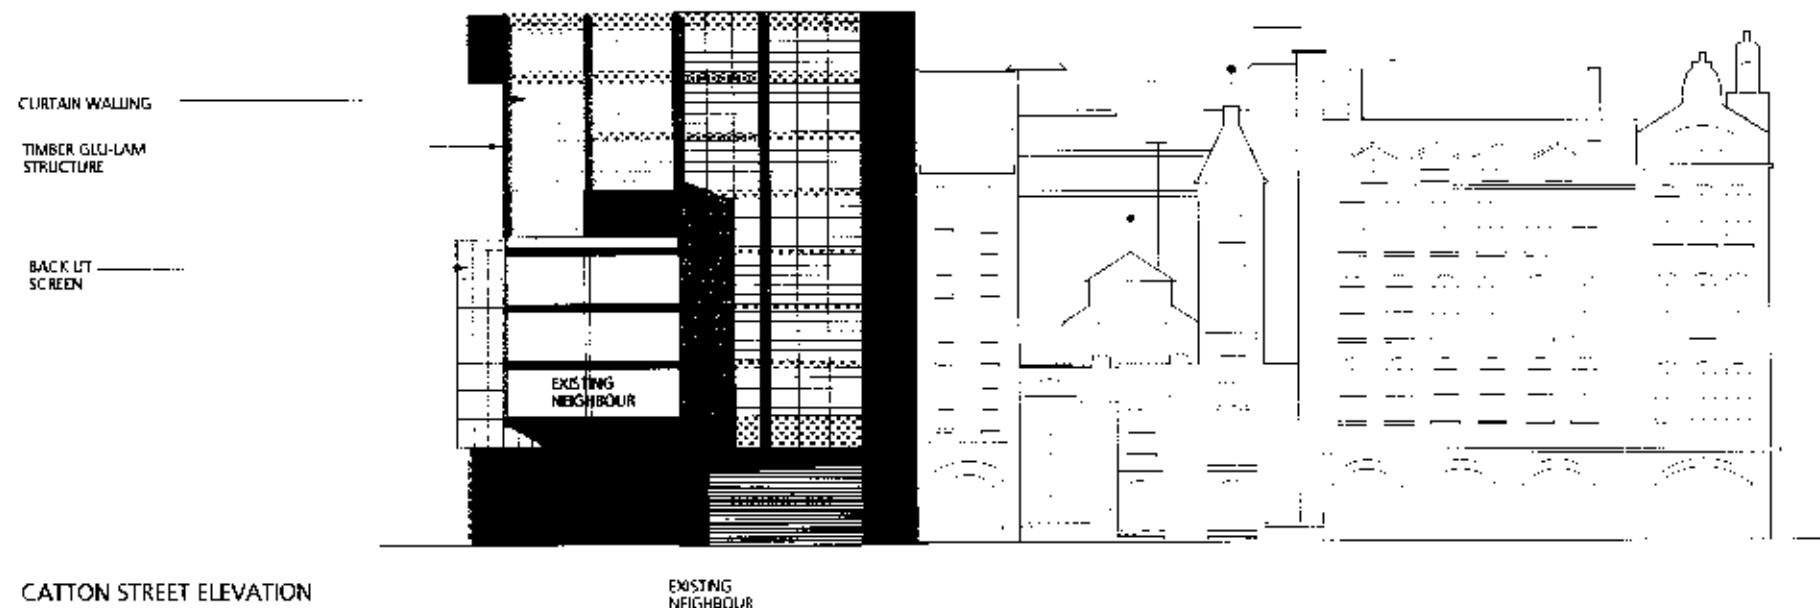
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HM/691/21/03



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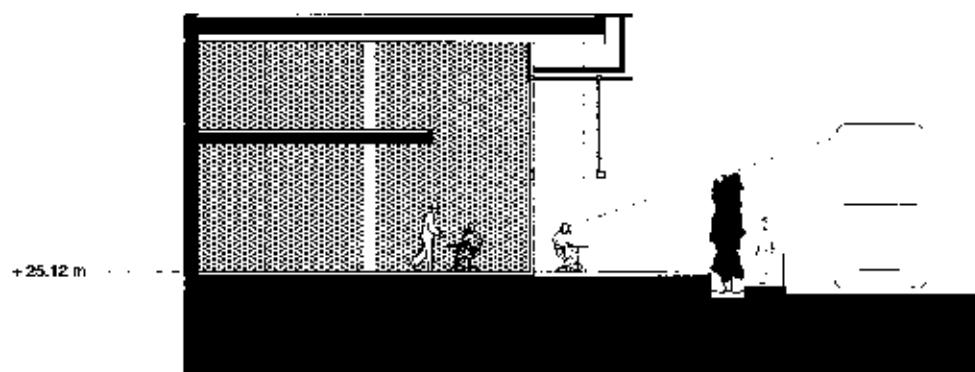
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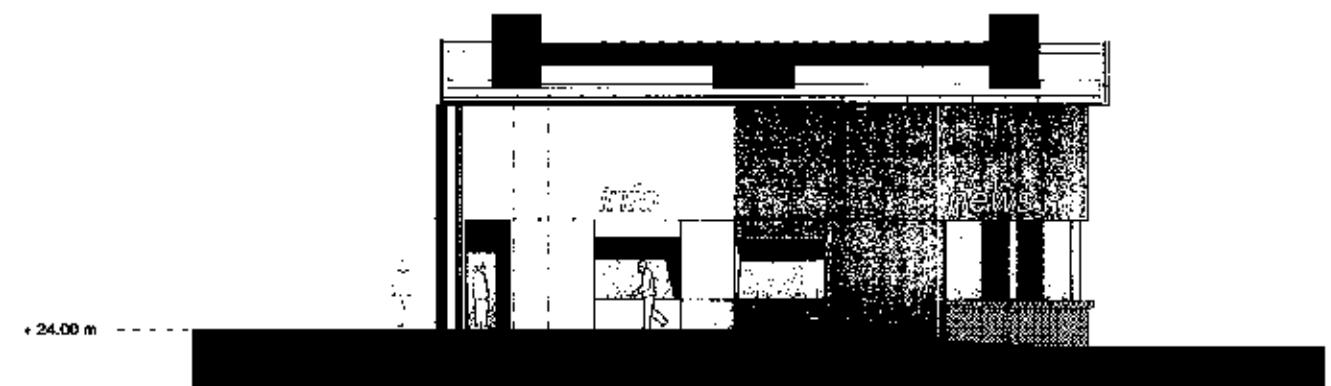


west elevation [street level]

PS 9904731^{R2}

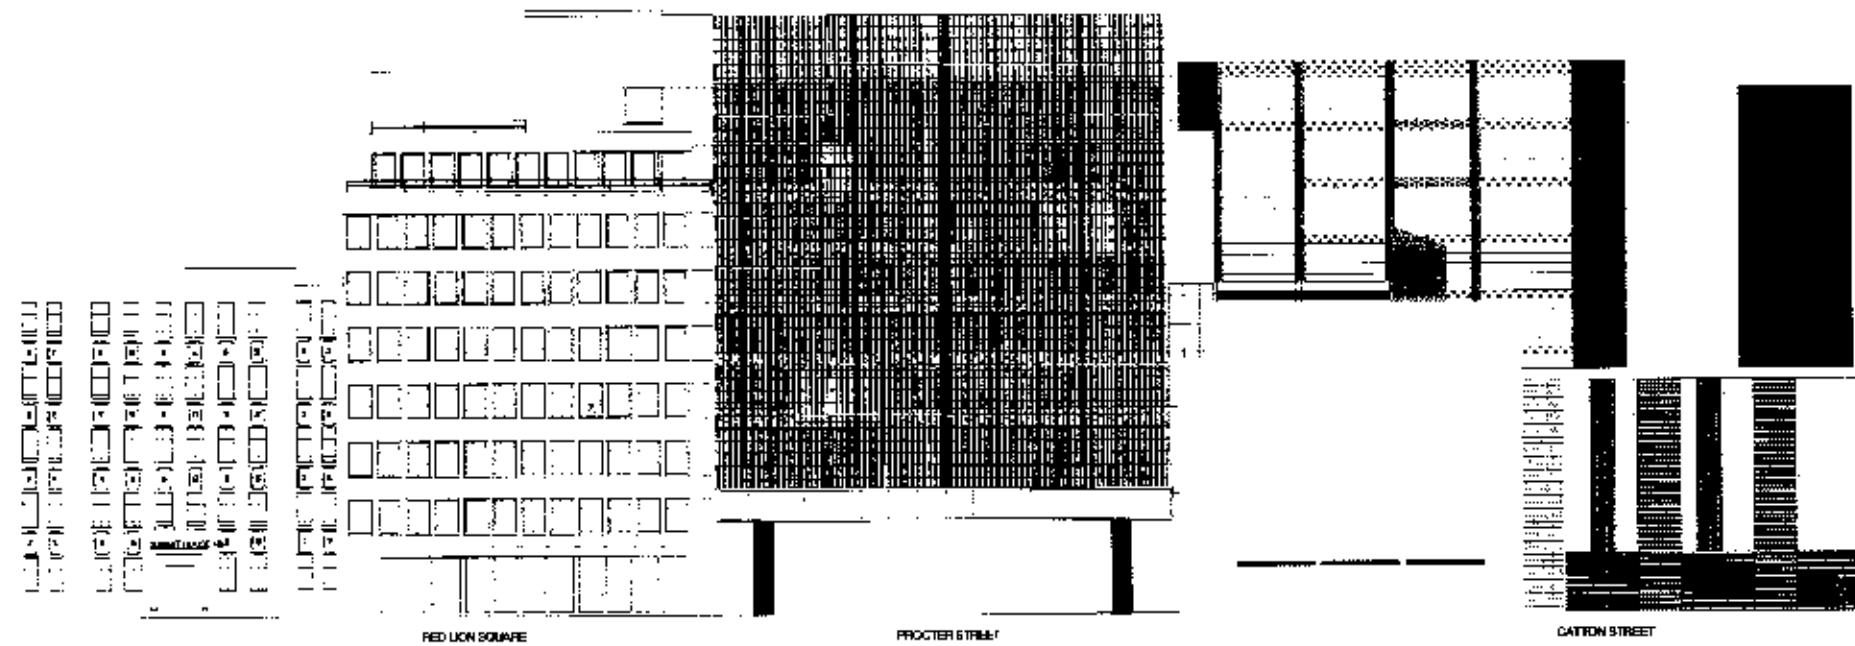

street level section [S1]

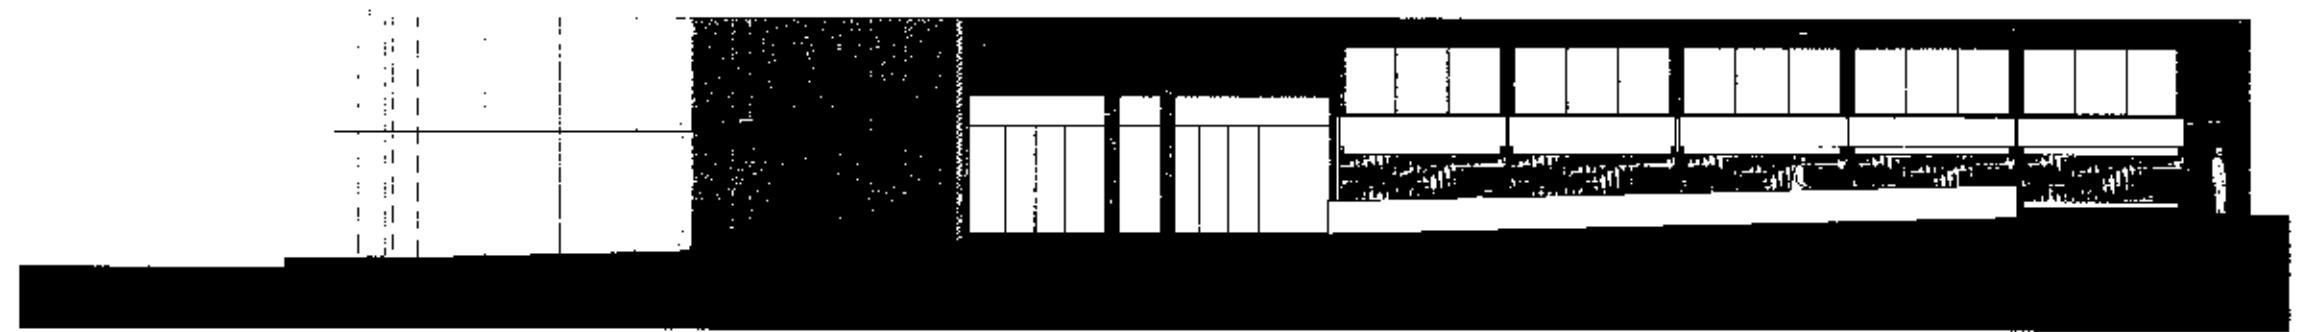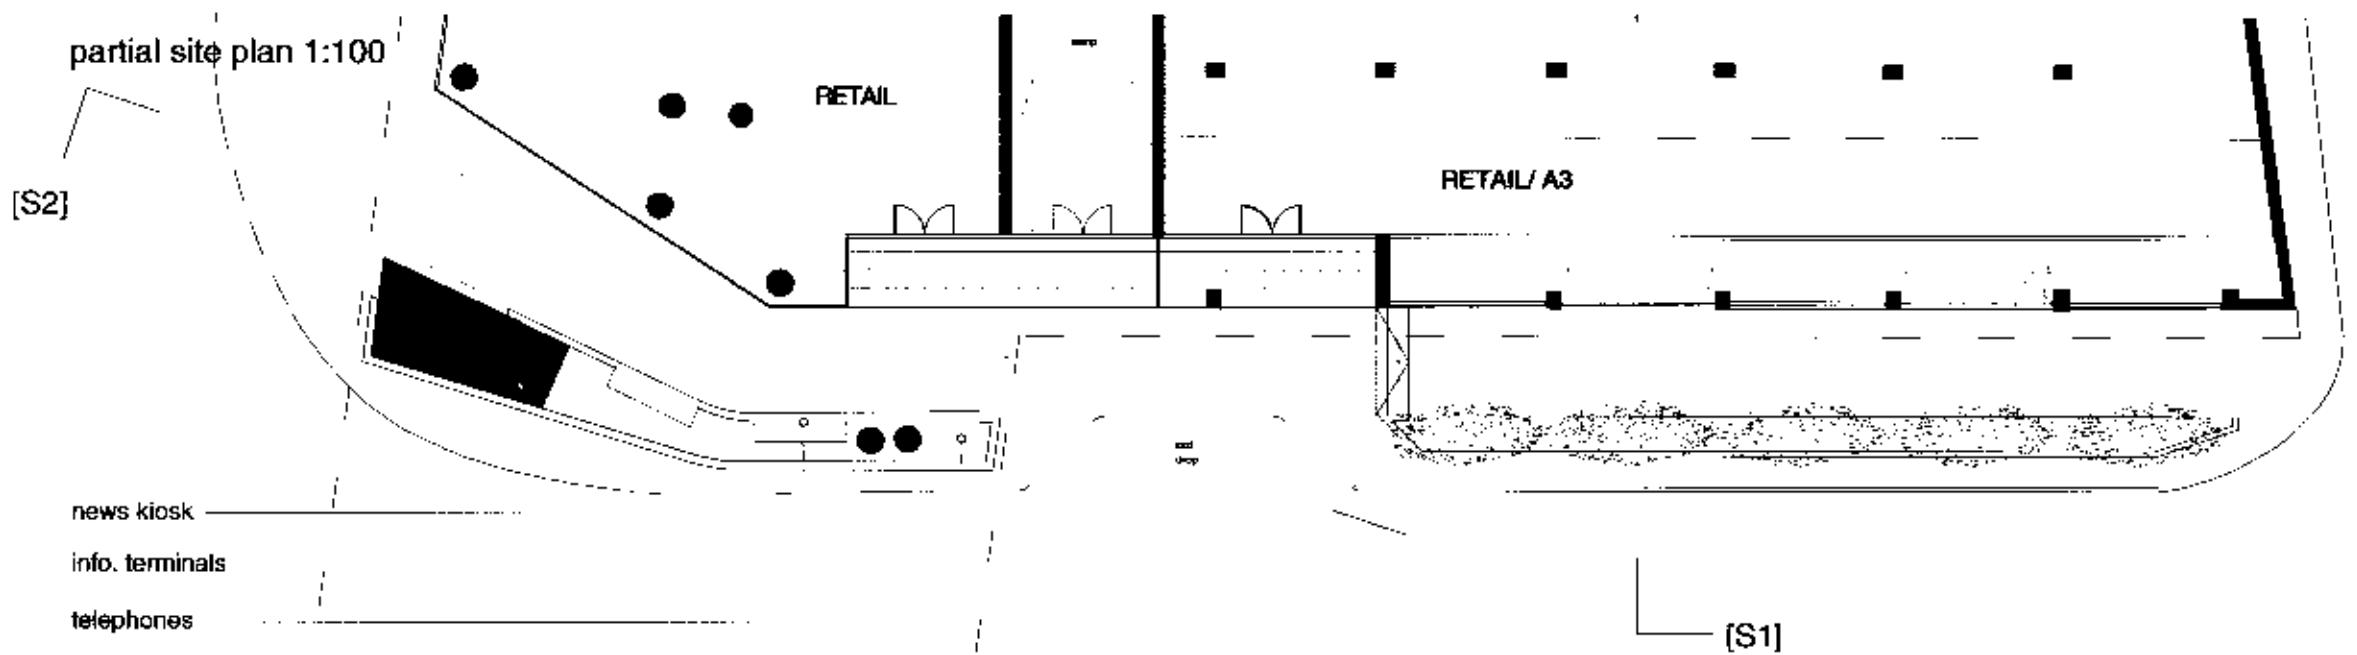

internal street elevation [S2]



10 PROCTER STREET
Landscape Works Detail Scale 1:200

PLANT BEYOND

NEW FLOOR

ROOFING

STEEL FRAME

ROOFING

ROOFING

ROOFING


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ROOFING

ROOFING


BACK LUMBER

BACK LUMBER

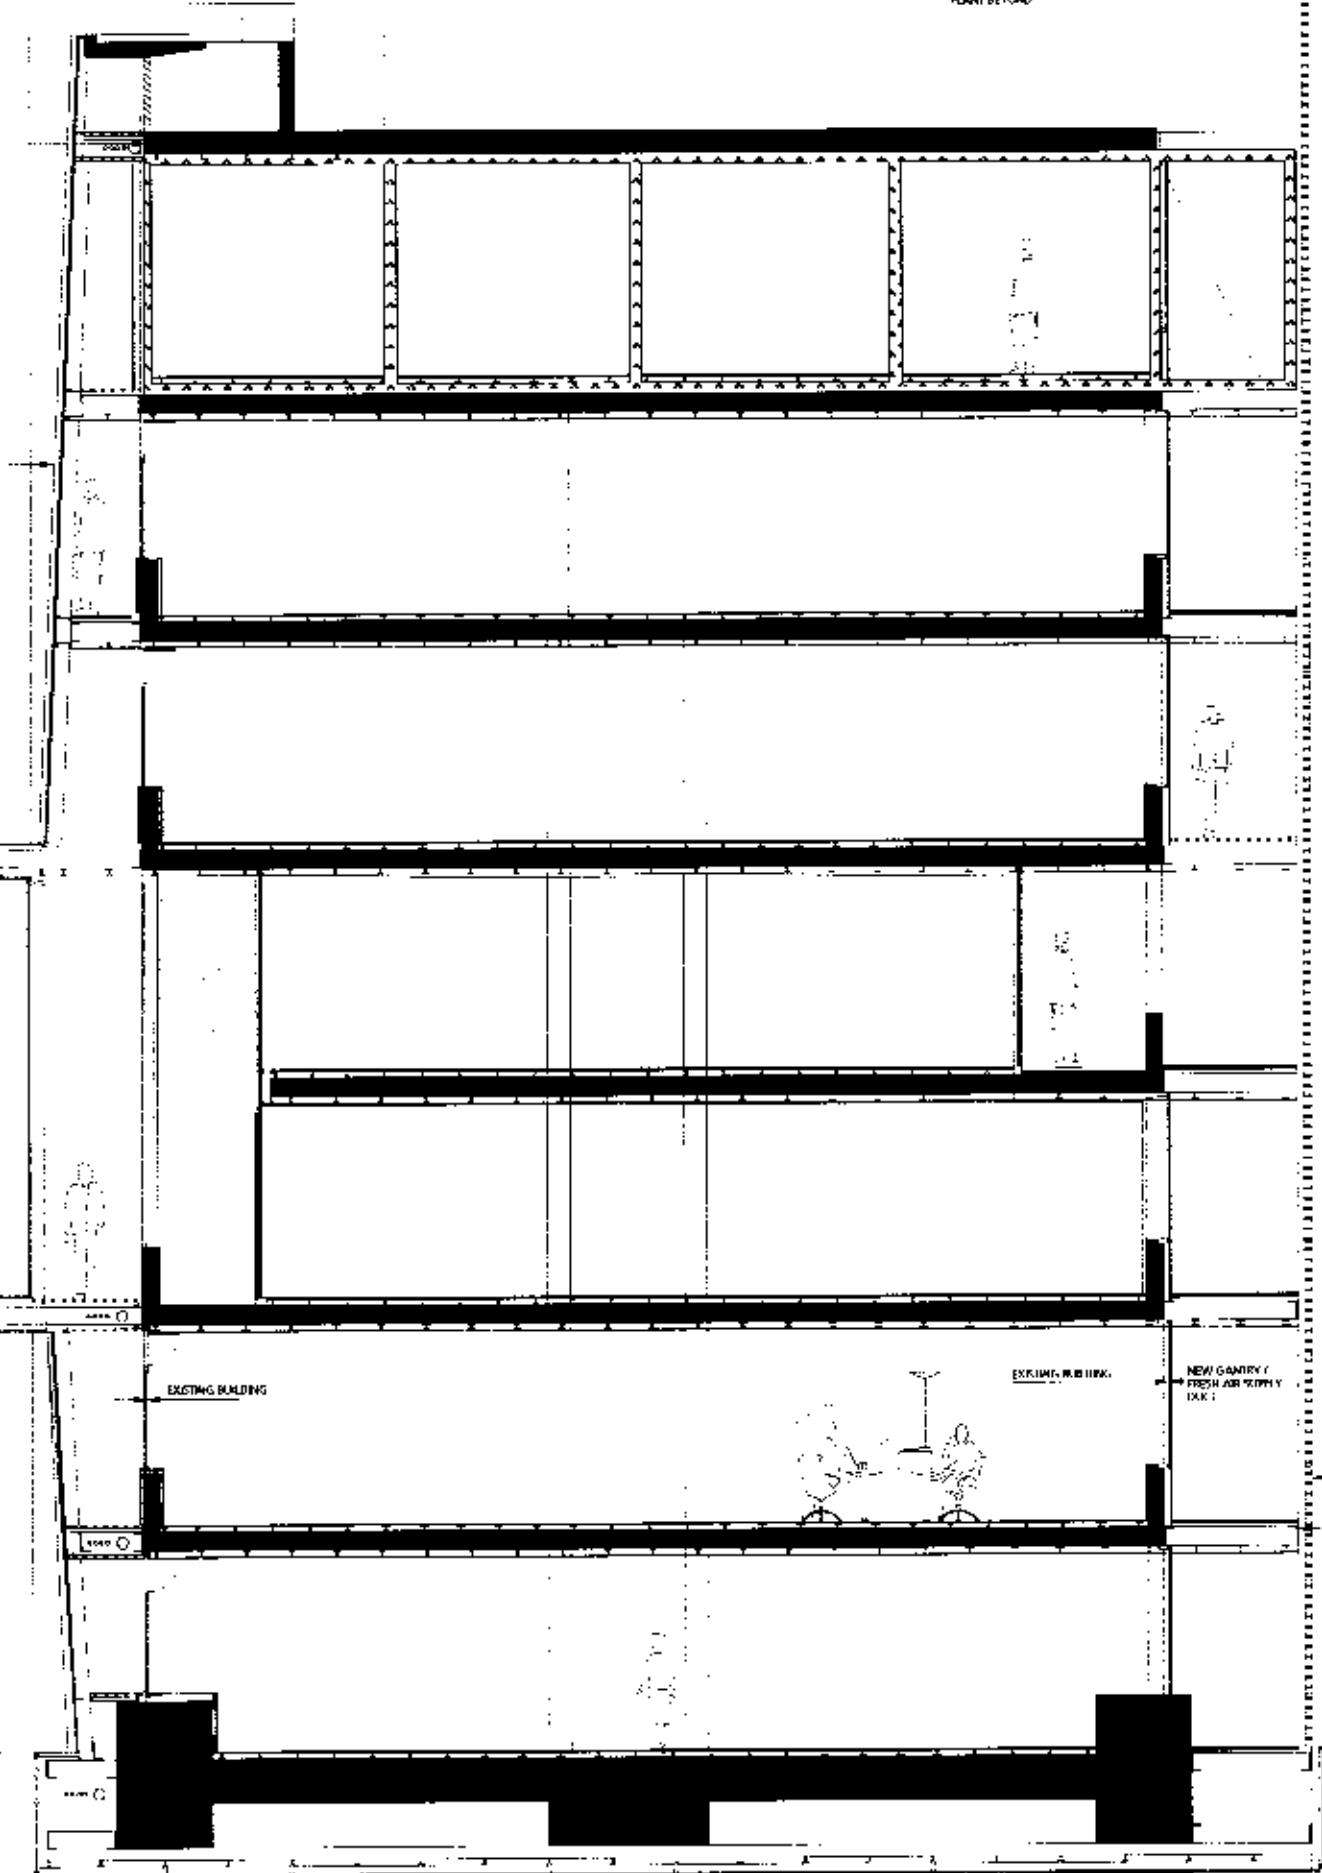

PS9904731 22

PROCTER STREET

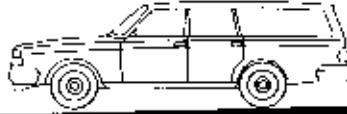

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Tel: (44) 0171 600 5151 Fax: (44) 0171 600 1062
e-mail: design@harper-mackay.demon.co.uk



Harper Mackay
ARCHITECTS & DESIGNERS
10 FLOOR
SECTION AA
TOP FLOOR
10 PROCTER STREET

Revd 1/12/99
Dwg No. 131299
Rev. 01

HW691/22/01
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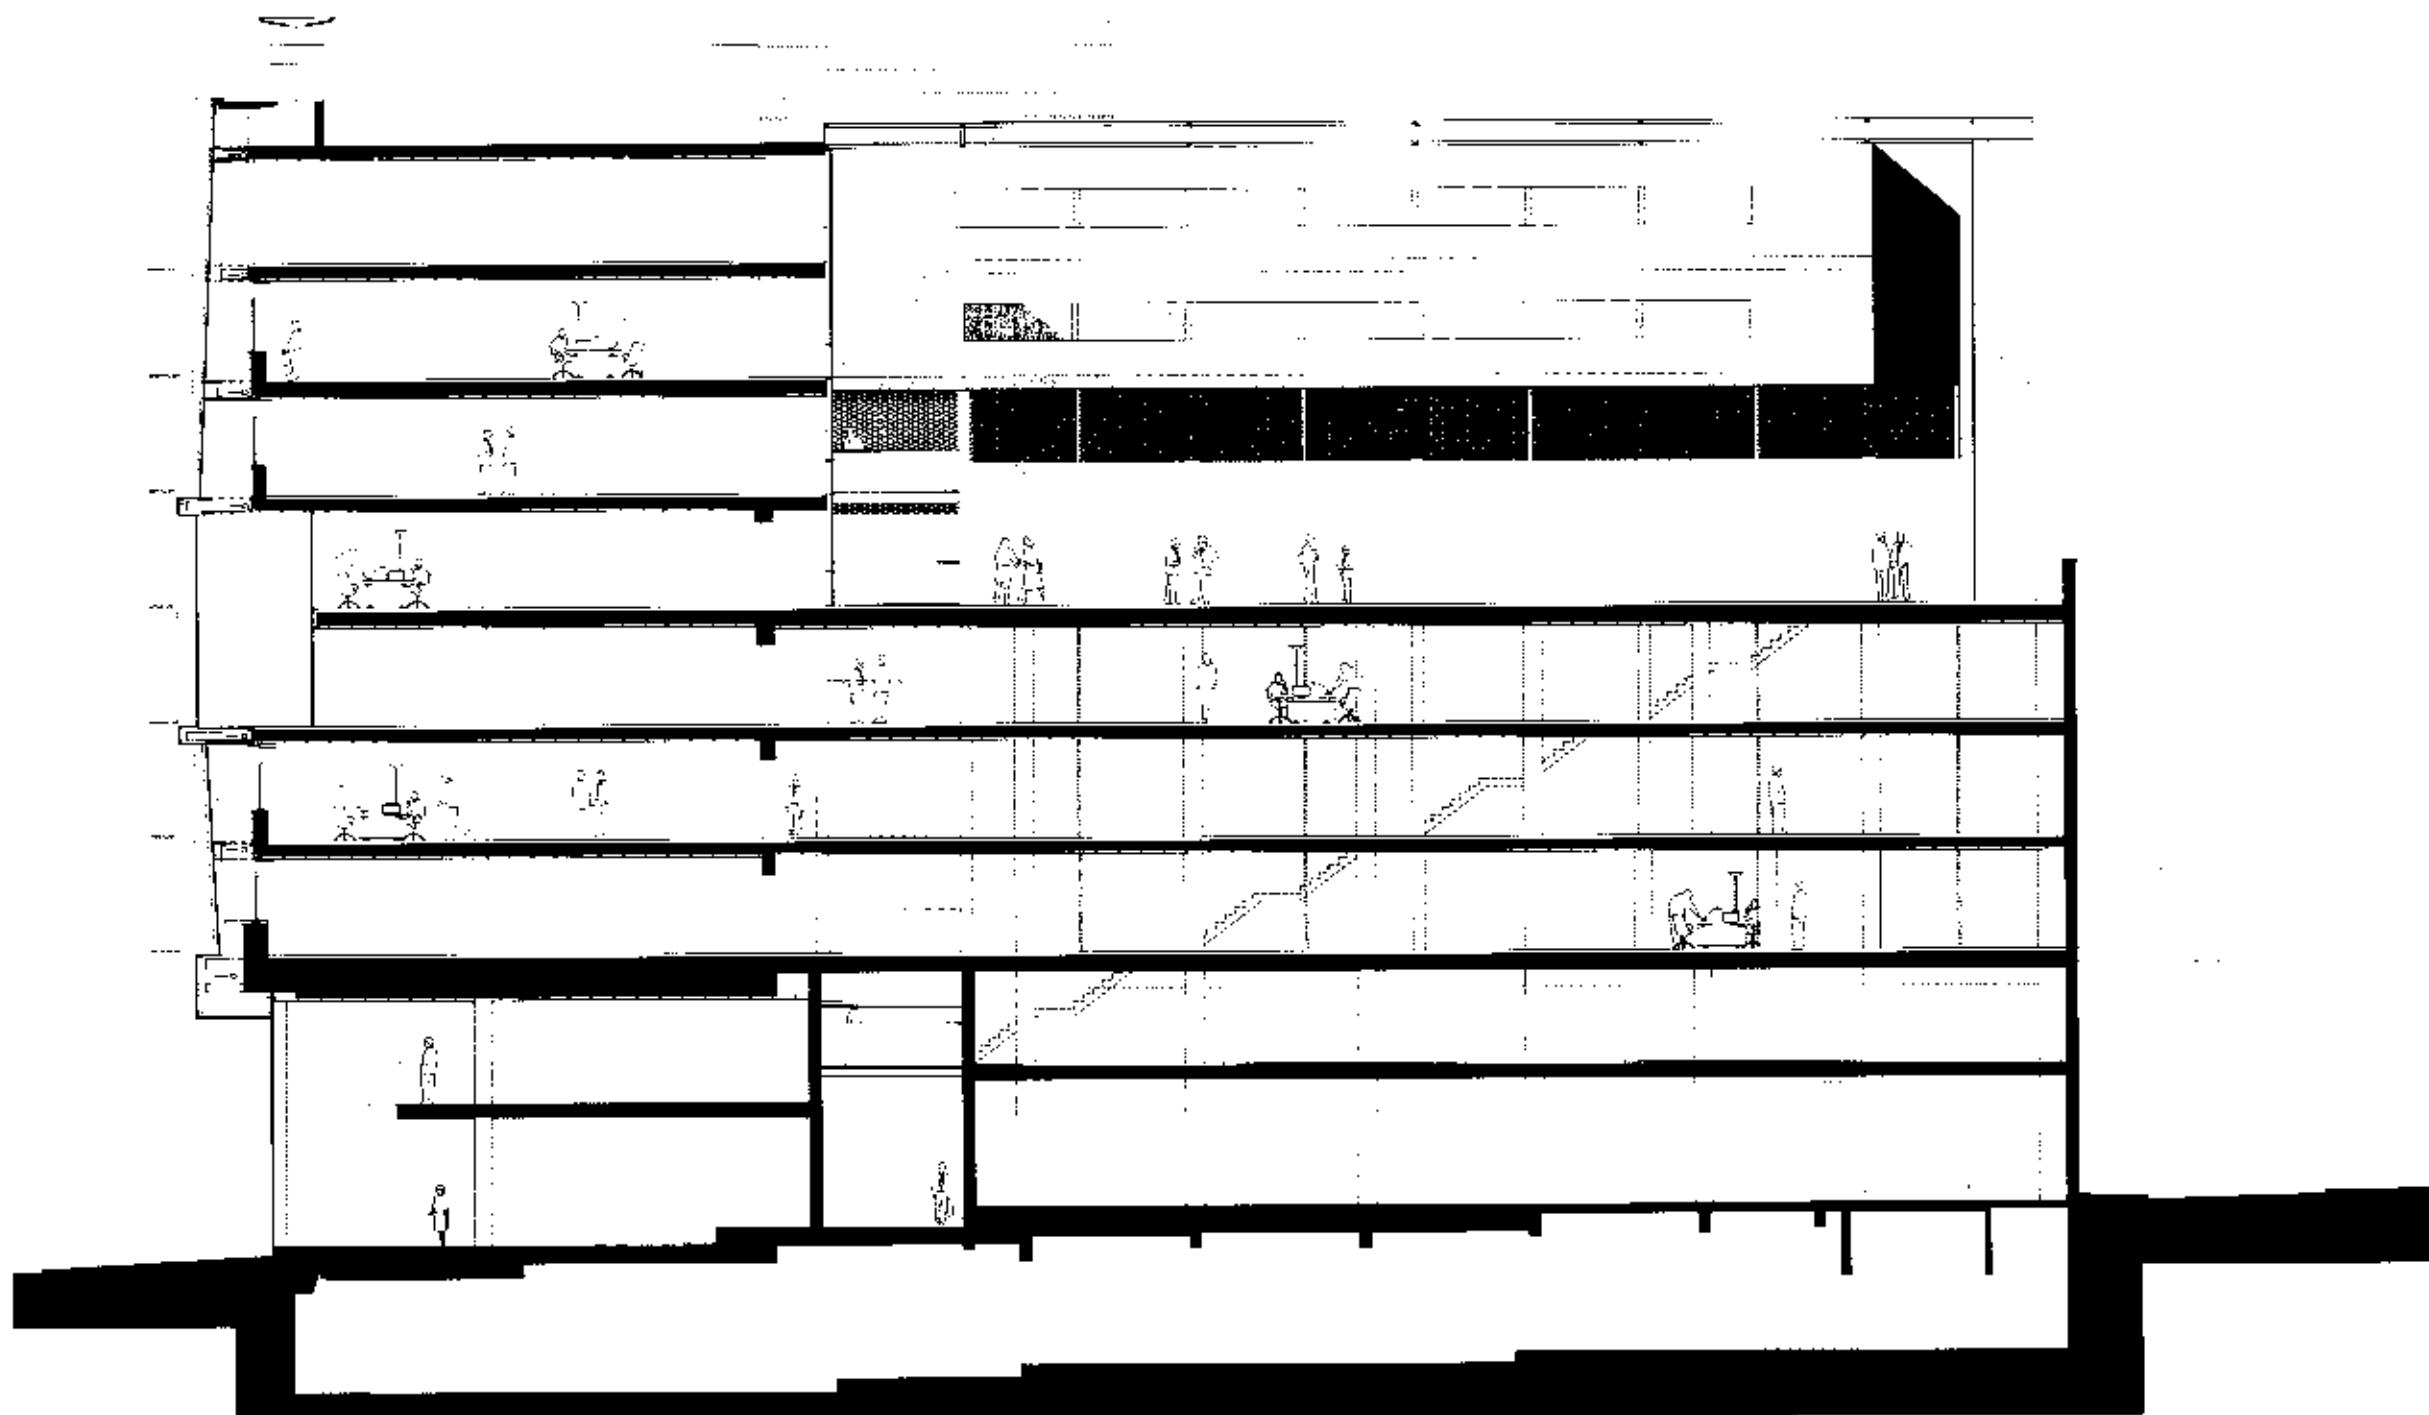
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Drawing No. Date
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KEY PLAN
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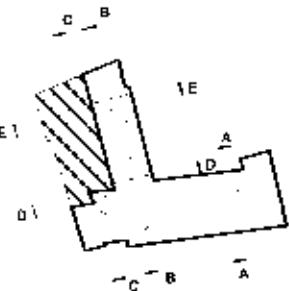
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HM/691/22/03		

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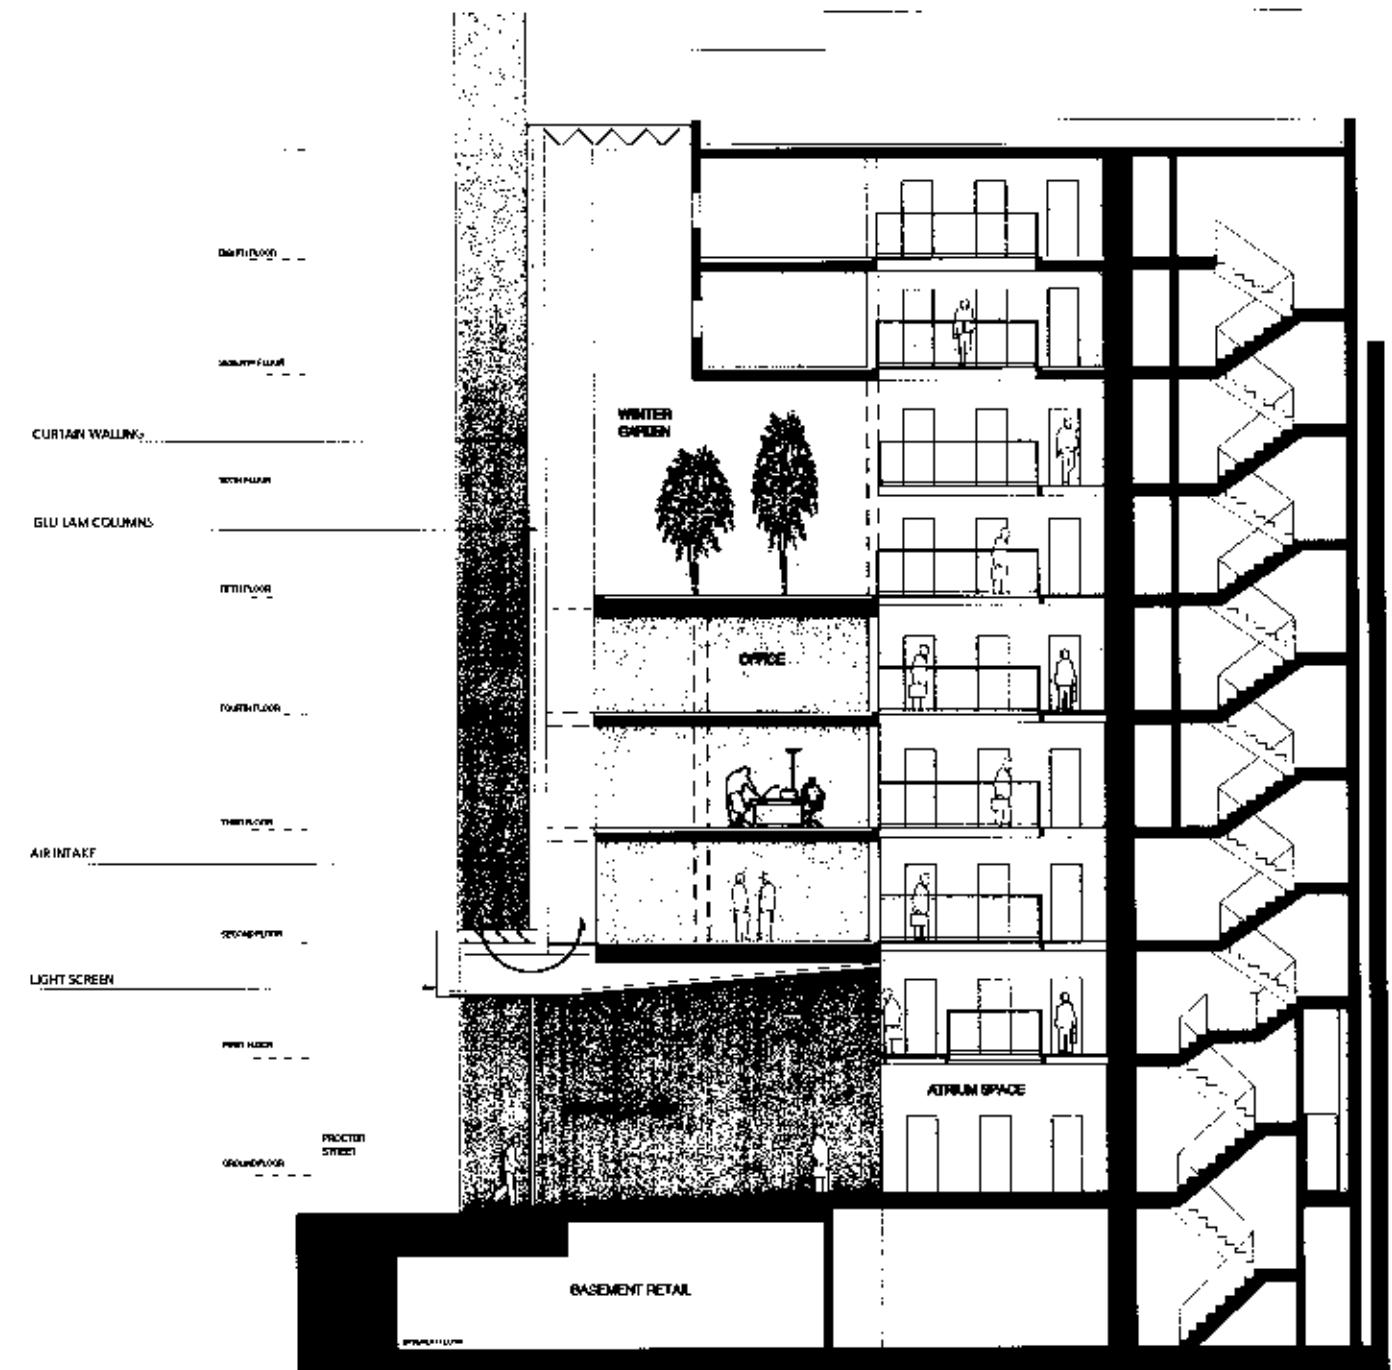
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12345 - Residential Building - Site Plan		
Architects & Designers		
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Drawing No.	Rev.	
File Ref:		

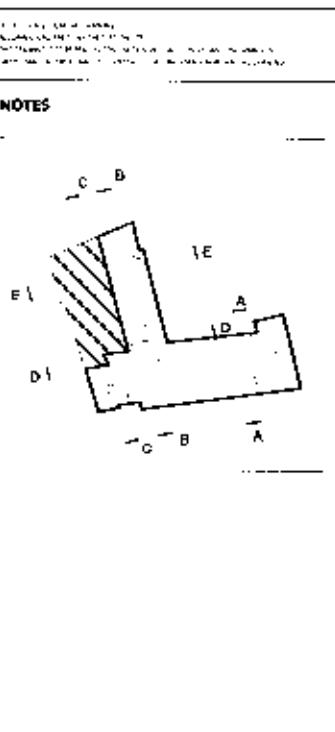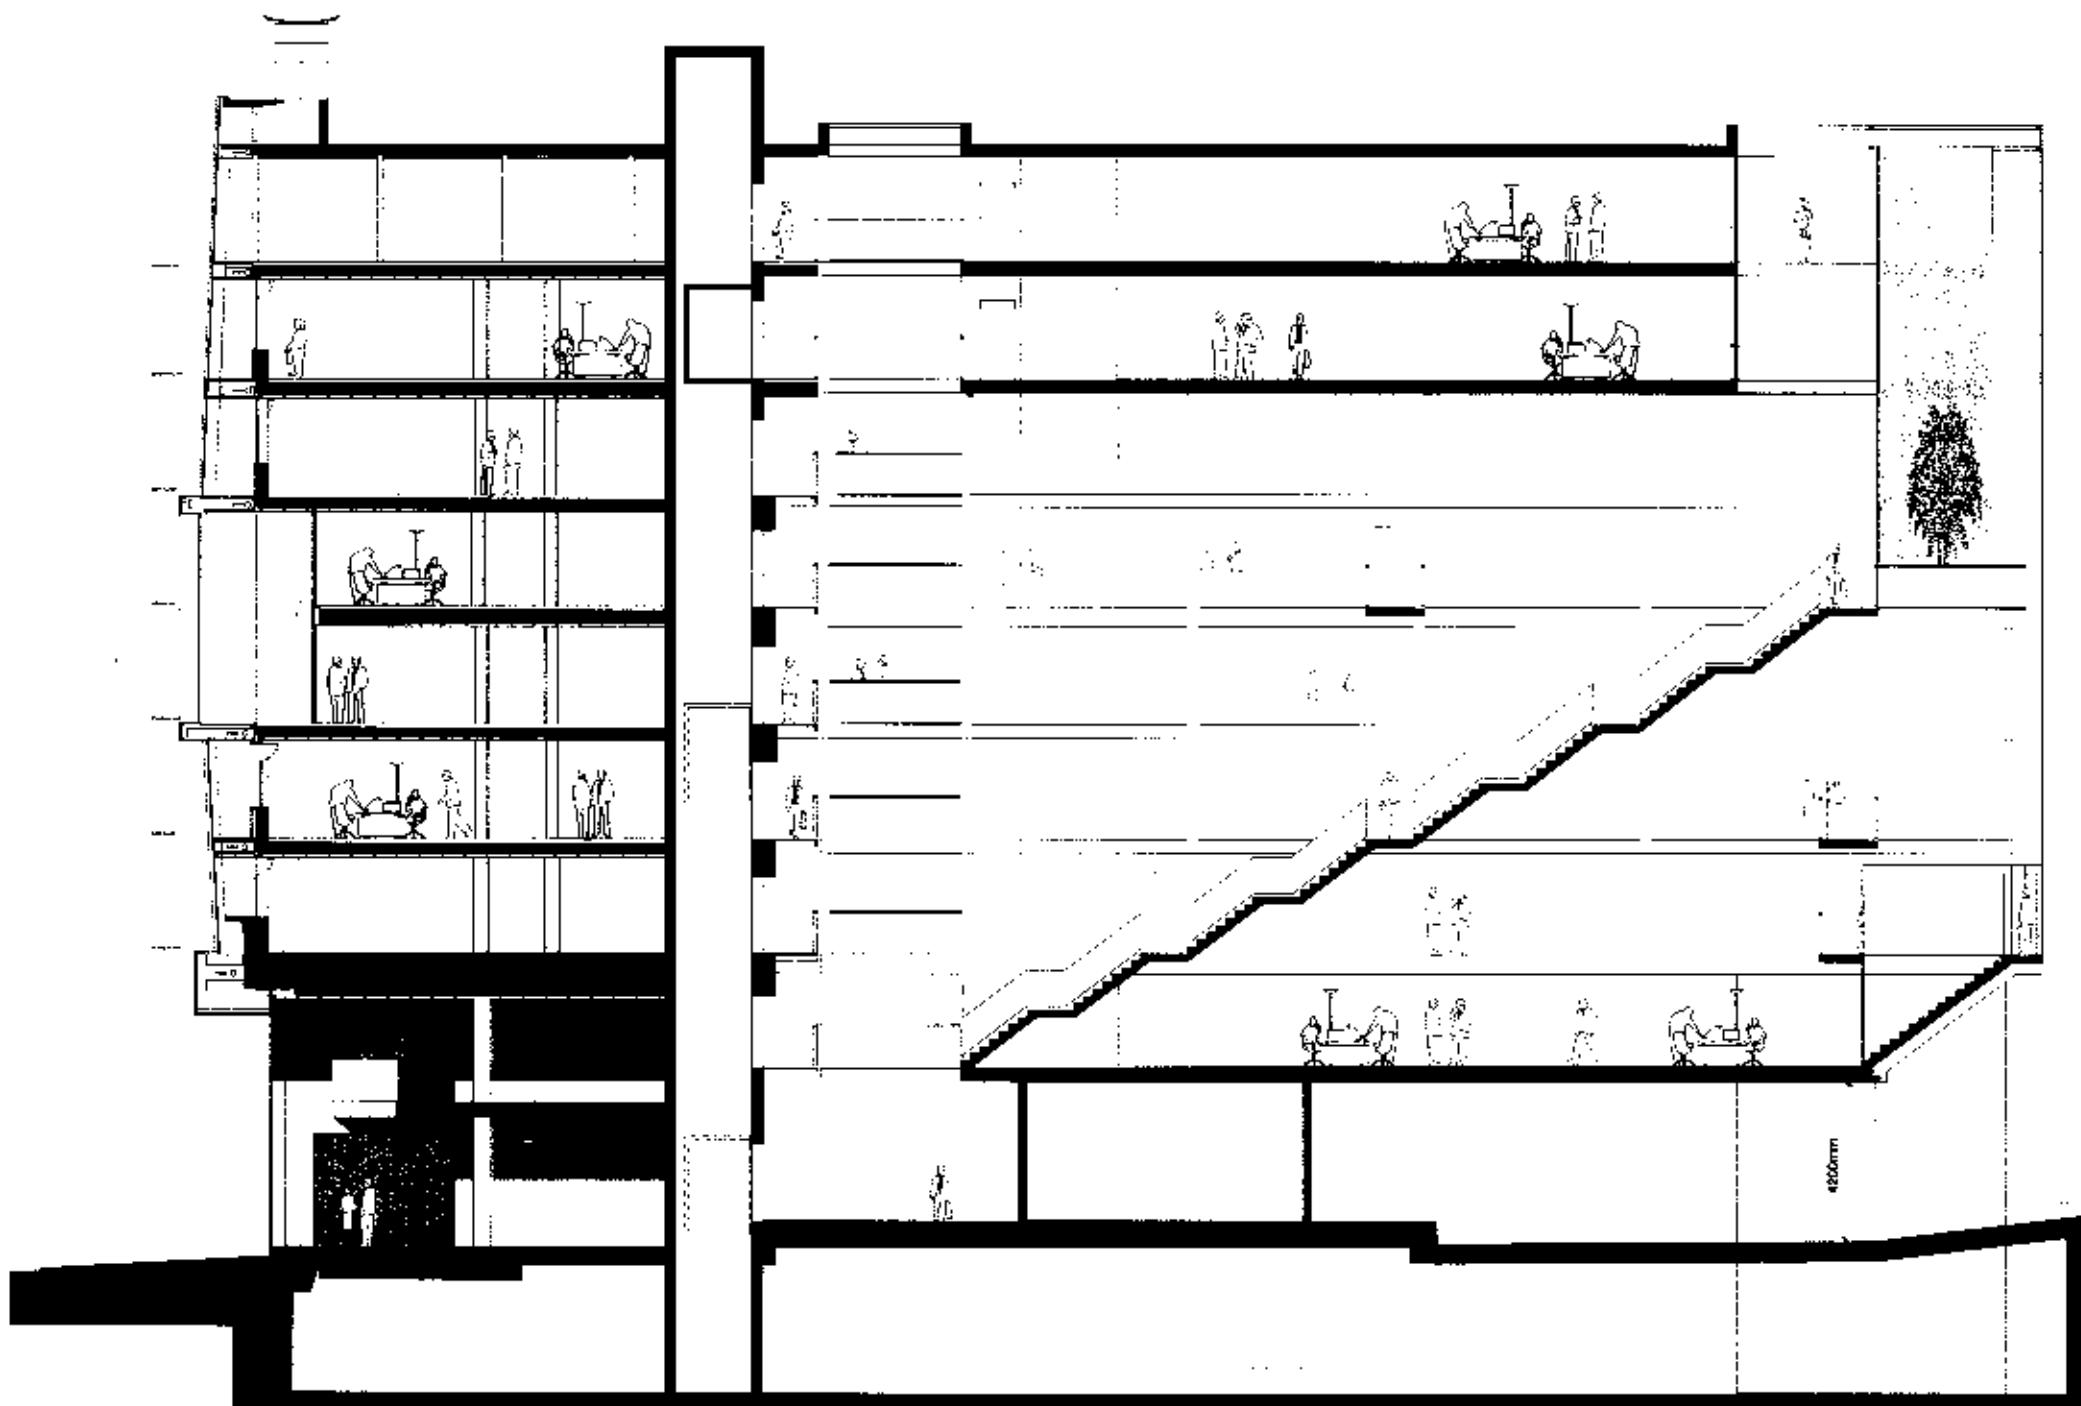


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Date	11/01/00	Checked by RS
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HM/691/22/04		
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KEY PLAN					
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ARCHITECTS & DESIGNERS: JOB TITLE 10 PROCTER STREET DRAWING TITLE SECTION DD Date: 11/01/00 DRAWN BY RS Drawing No. Checked By RS H.M./691/22/05					
<small>Page</small> 1 <small>Job Number</small> 691					

1.0 AIM

The aim of the proposed environmental strategy for the building is to:-

- i) Improve the thermal environment of the occupants – particularly in the Summertime.
 - ii) Improve the visual environment of the occupants.
 - iii) Improve the acoustic environment of the occupants.
 - iv) Reduce the energy consumption of the building.
 - v) Ensure that the new mechanical and electrical engineering systems work within the existing constraints of the building.
 - vi) Improve the visual appearance of the building.
 - vii) Improve, if possible, the external environment created by the building, particularly in the underpass.

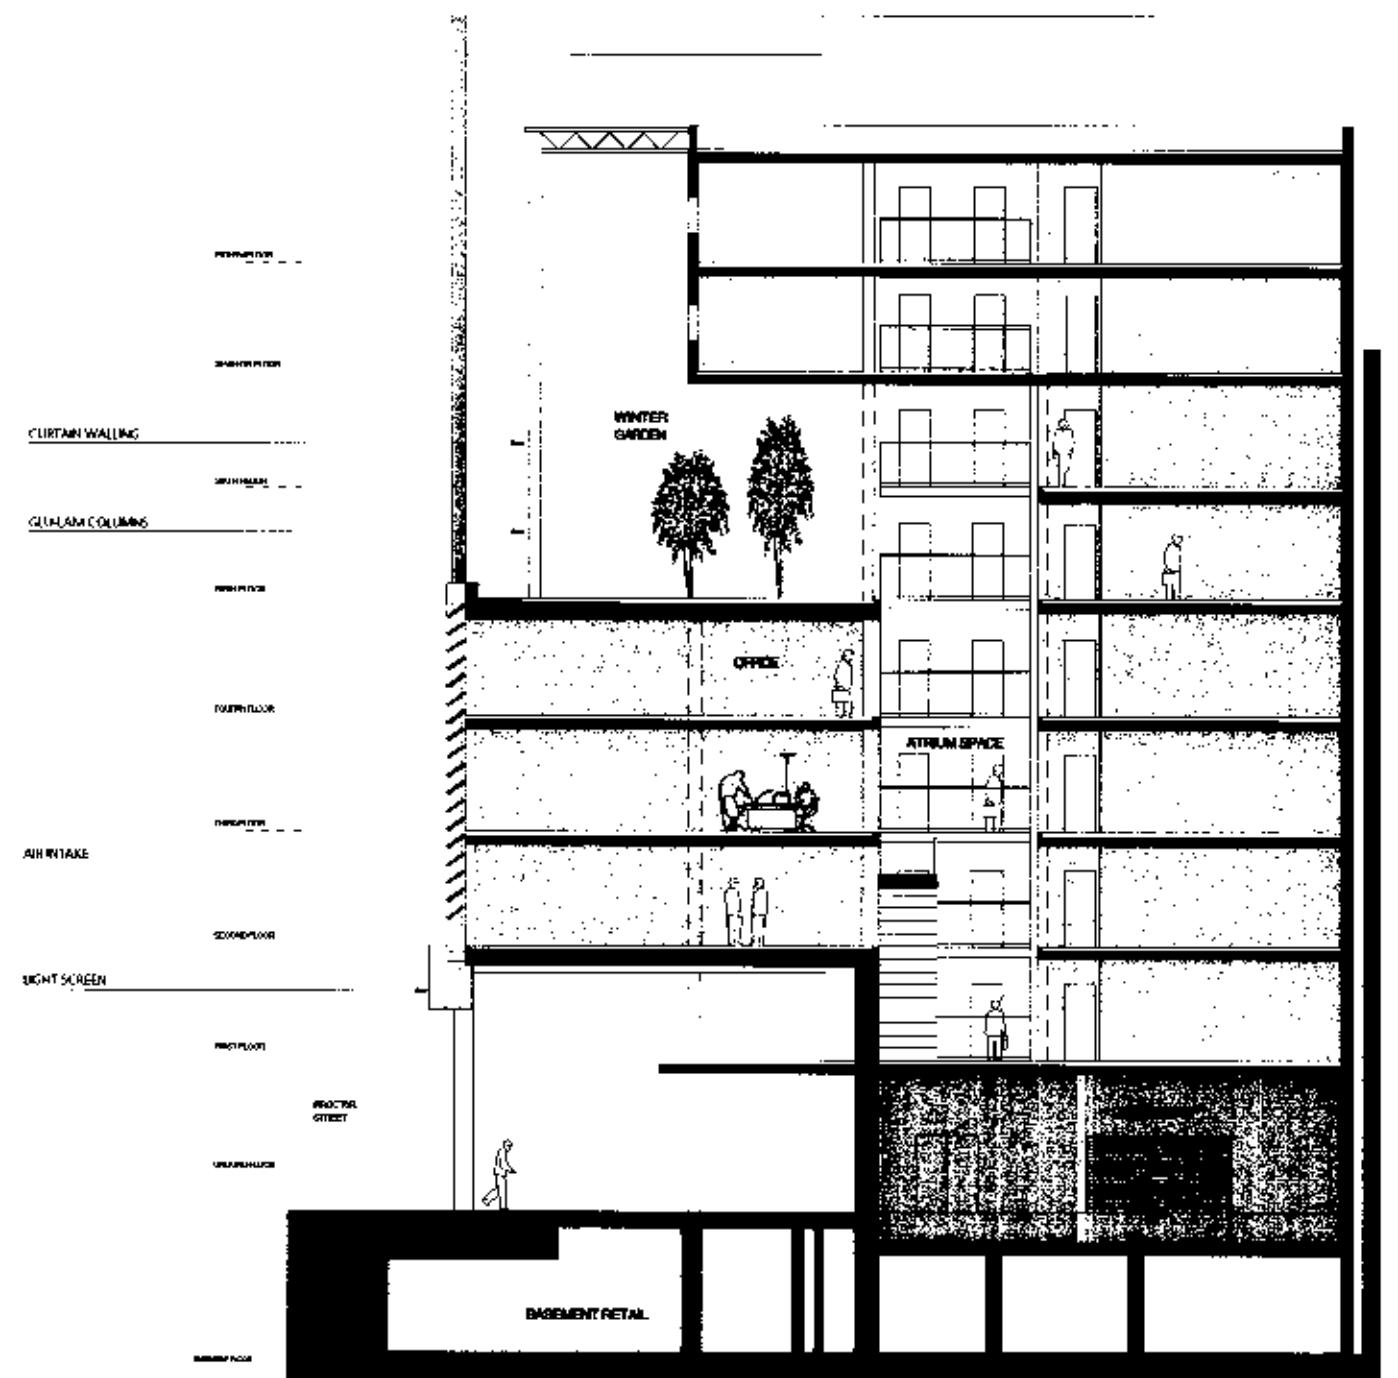PS 9904731 R2

2.0 KEY ELEMENTS OF THE STRATEGY

There are a number of key individual elements in the environmental strategy which combined will be designed to meet the criteria set above.

2.1 DOUBLE FACADE

The recladding of the external building envelope with a new "skin" will result in:

- i) Reducing heat loss in the Wintertime by improving the thermal performance of the building.
 - ii) Reducing Solar heat gain in the Summertime by again improving the thermal performance of the building.
 - iii) Improve the acoustic environment within the building by dramatically reducing the level of external noise entering the building.
 - iv) Create a path for outside air to be supplied and extracted from the office space.

2.2 NATURAL VENTILATION

Natural ventilation to the offices will be achieved by:-

- i) Stack effect resulting difference in height between the air inlet above Proctor Street and the air outlet at roof level (approximately 20m).
 - ii) Wind effect resulting from the prevailing wind travelling over the double façade outlet at roof level. This outlet will be designed with an aerofoil to enhance the suction effect; and to ensure that this effect will occur whatever the wind direction. Incoming air will be filtered to remove particulate pollution.

2.3 CHILLED CEILING

A chilled ceiling will be installed within the office space. This will be designed to ensure that whatever the external thermal conditions the temperatures within the office space will be controlled to within a comfortable zone (24-26°C). the chilled ceiling will be designed to occupy a minimal ceiling zone thus maximising floor to ceiling height. The chilled ceiling system will be designed on the basis of elevated chilled water temperatures of approximately 14°C. This will result in an energy efficient thermal control system.

Air cooled chillers at roof level will generate the required chilled water for the ceiling

2.4 HEATING

A new heating system will be installed within the building to ensure comfortable conditions especially during the Winter.


Heating will be introduced into the double façade zone to ensure that both this space and the internal office space are kept comfortable. New, energy efficient, low NO_x fired boilers will be installed to generate the required low temperature hot water.

2.5 LIGHTING

Energy consumption on artificial lighting will be reduced by:-

- i) Adopting a lighting control system which switches off artificial lights when sufficient daylighting is available.
 - ii) Maximising daylighting entering the space – achieved partly by eliminating existing perimeter facade.

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3.0 ENERGY SAVINGS

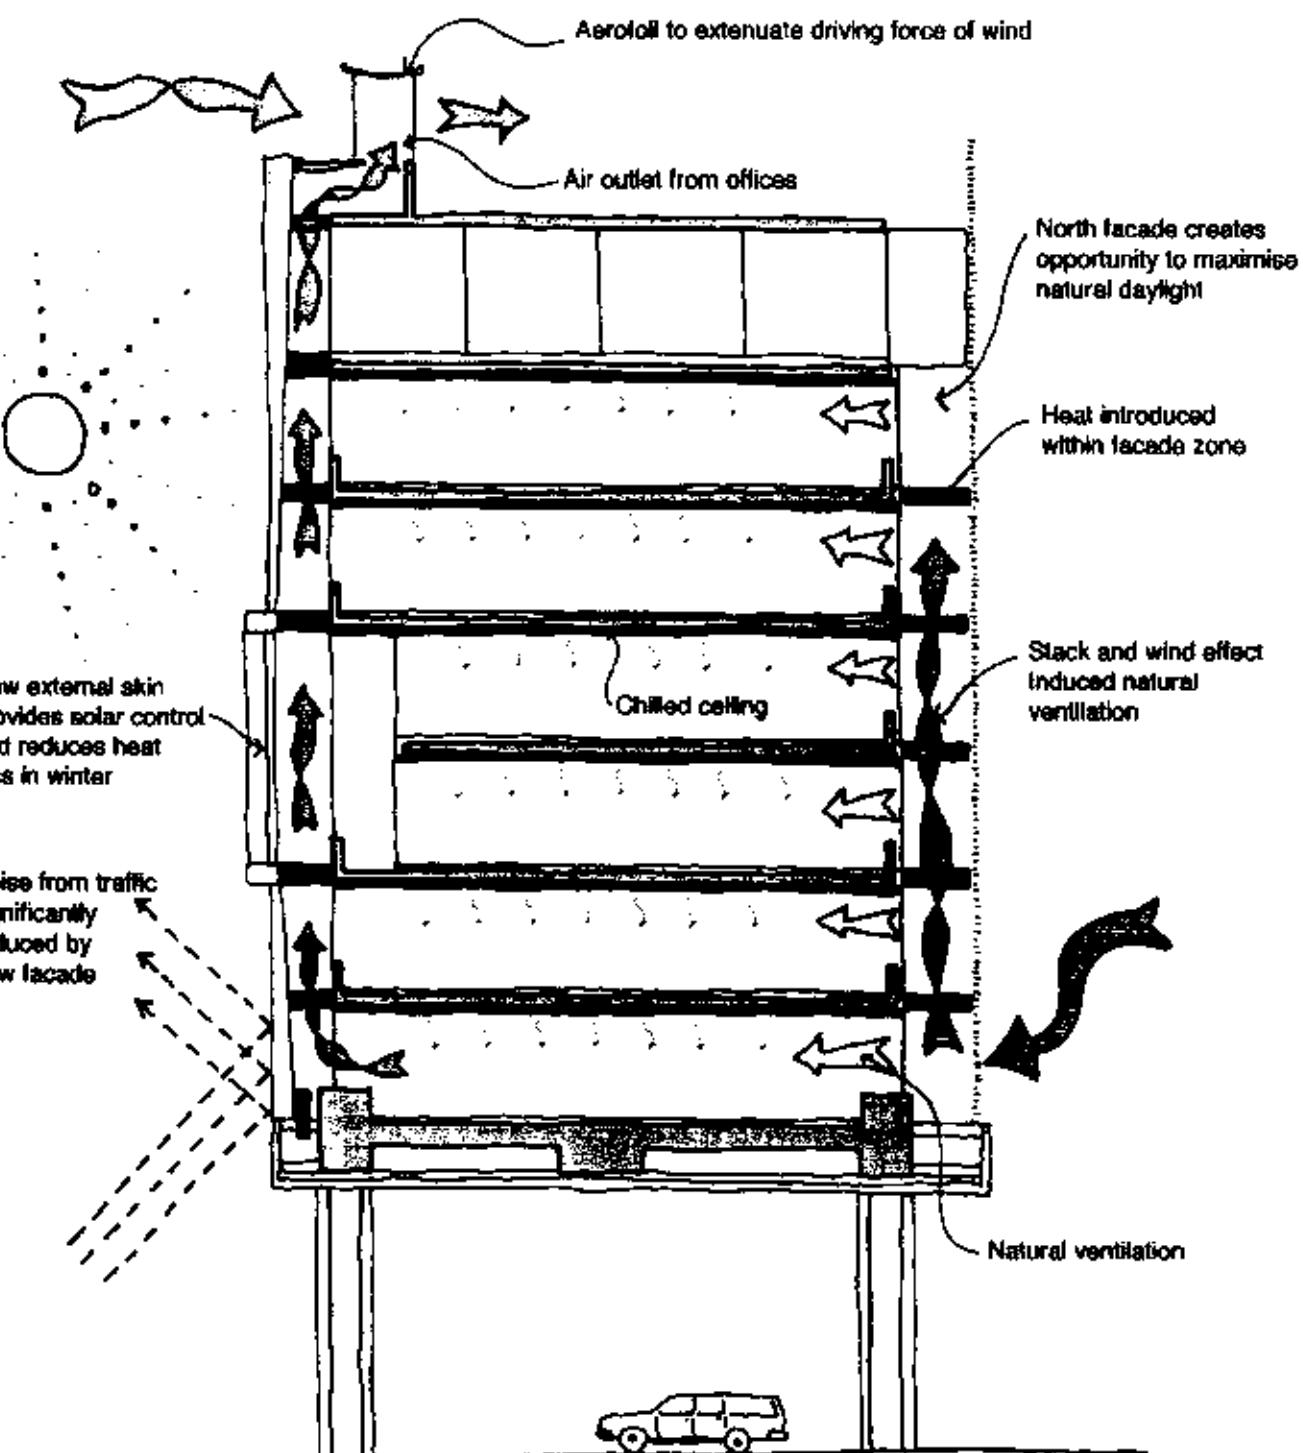It is difficult to quantify exactly the nature of the energy saving resulting from this design.

Suffice to say that a combination of:-

- high efficient thermal façade
- natural ventilation system
- efficient heating and cooling system
- efficient artificial lighting system

will significantly reduce the building energy consumption.

A target figure for this building should be in the order of 150-175kWhr/m². This compares to 430 kWhr/m² for a typical air conditioned building.


4.0 SEMINAL NATURALLY VENTILATED BUILDINGS IN THE UK

- Gateway 2 – Basingstoke
- Powergen Headquarters – Coventry
- Ionica Headquarters – Cambridge
- Solar office – Doxford, Sunderland
- Nottingham
- Inland Revenue office

NOTES	
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Job Title 10 PROCTER STREET	DRAWN BY
DRAWING TITLE ENVIRONMENTAL PROPOSAL	CHEKED BY
Date:	Date:
Drawing No:	Pic:
FILE:	JOB NUMBER: 1001


22
PS 9904731

COOLING INTAKE: SECTION THROUGH NORTH FAÇADE

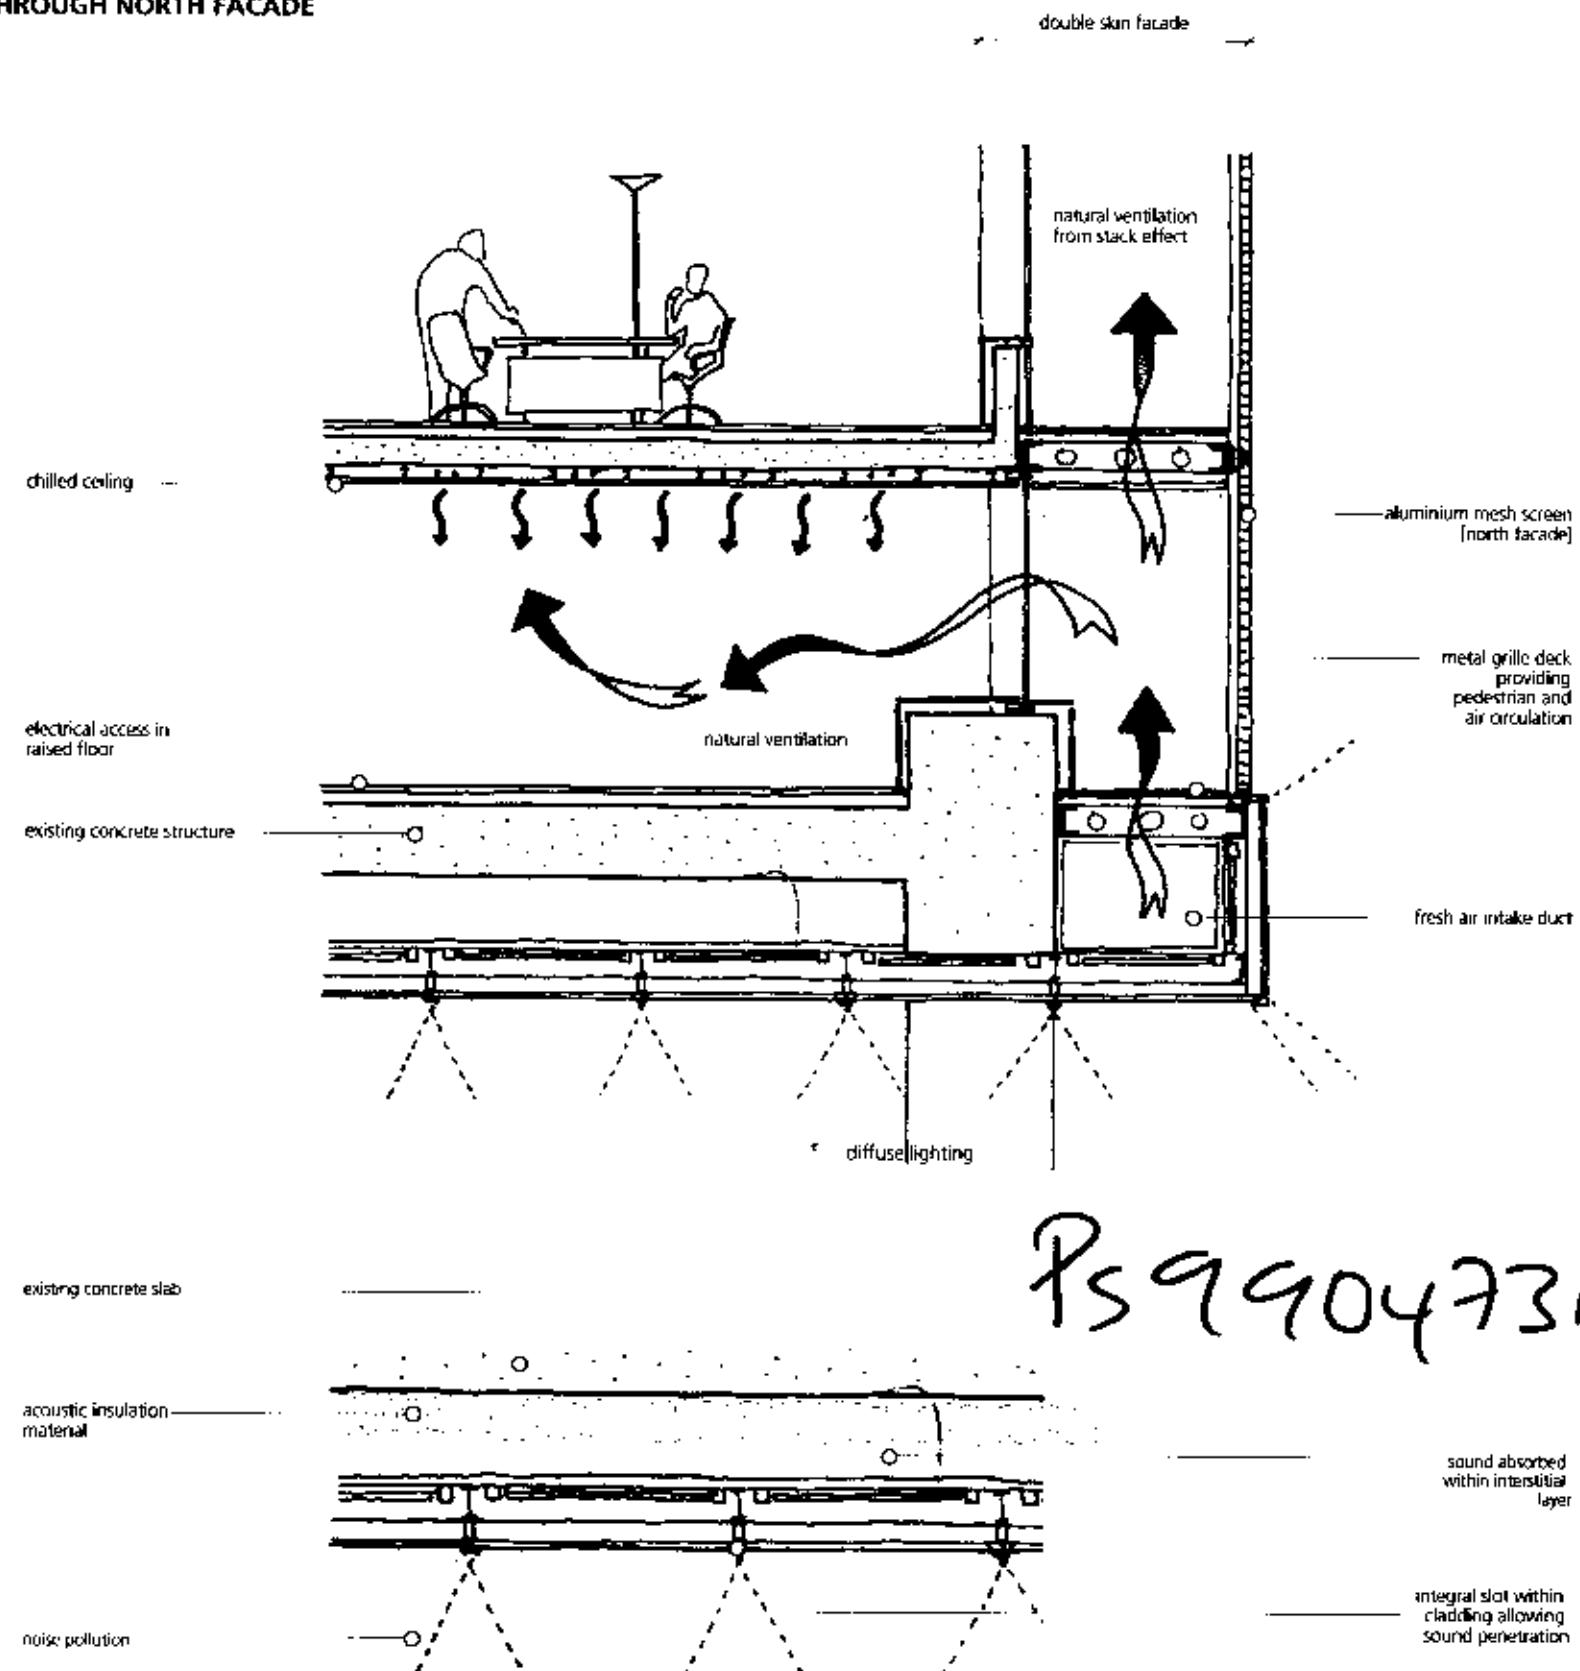

LIGHTBOX DETAIL

DRAWING NUMBER 10 PROCTER STREET COOLING/SONIC ABSORPTION		
Scale:	1:50	DRAWN BY RB
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Drawing No.:	Rev. 1	
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Date:	21.01.00	Checked By SA
Drawing No.:	Rev. 1	
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F.P.	JOB NUMBER 101	

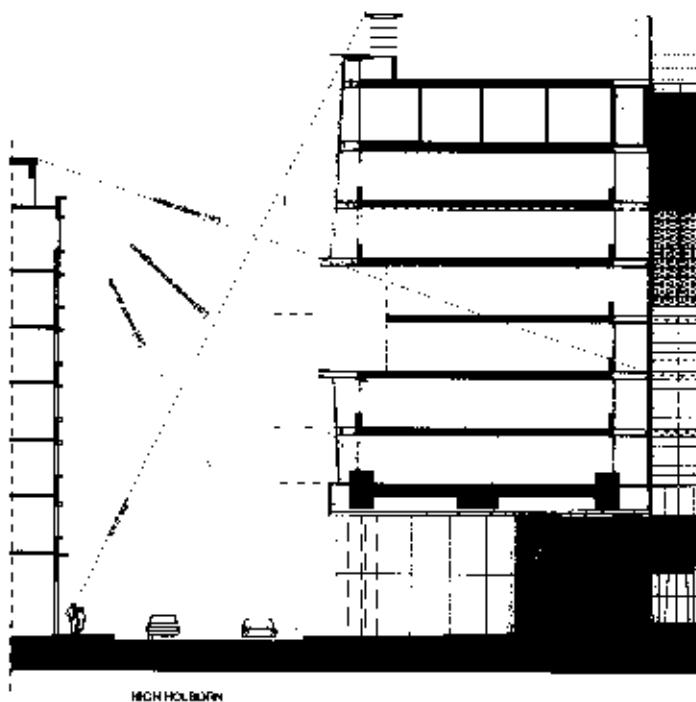

HIGH HOLBORN

PSA 104731 R2

SOUTH FACADE- ENVIRONMENTAL CONDITIONS


Environmentally, the task of the additional 'skin' of the building is to provide an enhanced environment through the implementation of a double facade, through natural ventilation and a chilled ceiling.

DOUBLE FACADE

Louvres and glazing within the articulated double facade help to reduce Summertime solar gain whilst also reducing heat loss in the winter months. This also enables outside air to be supplied and extracted, with the assistance of an aerofoil wind baffle placed at roof level. However by positioning the baffle away from the facade edge it remains invisible at street level.

Left: 1:200 section showing max. seasonal solar angles.
Below: Sketch section of south facade

DOUBLE SKIN FACADE

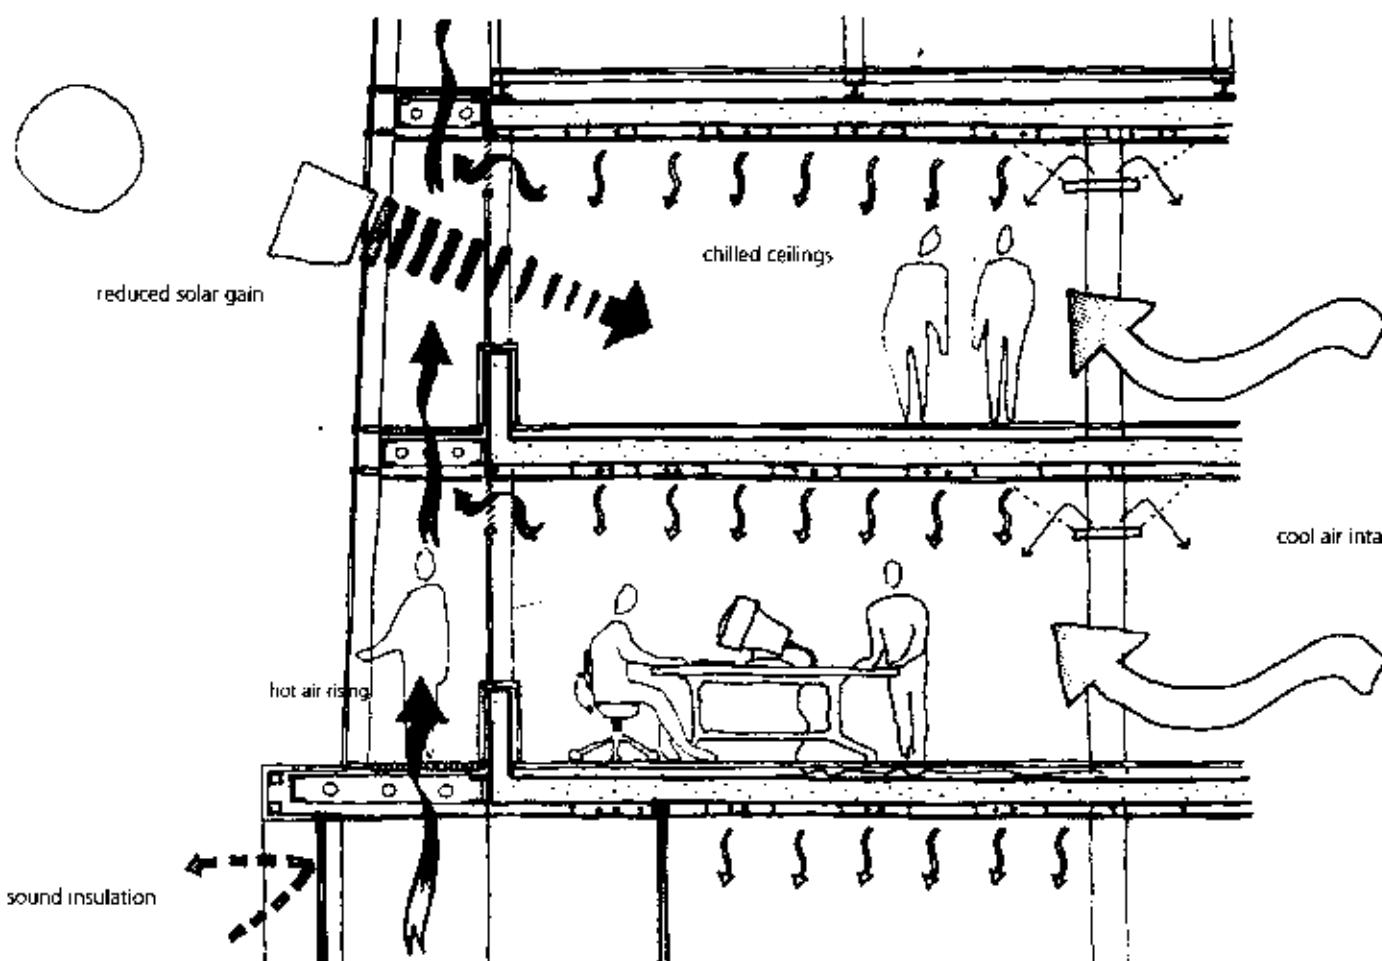

CONTINUATION
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TO BE CHECKED BY CONTRACTOR

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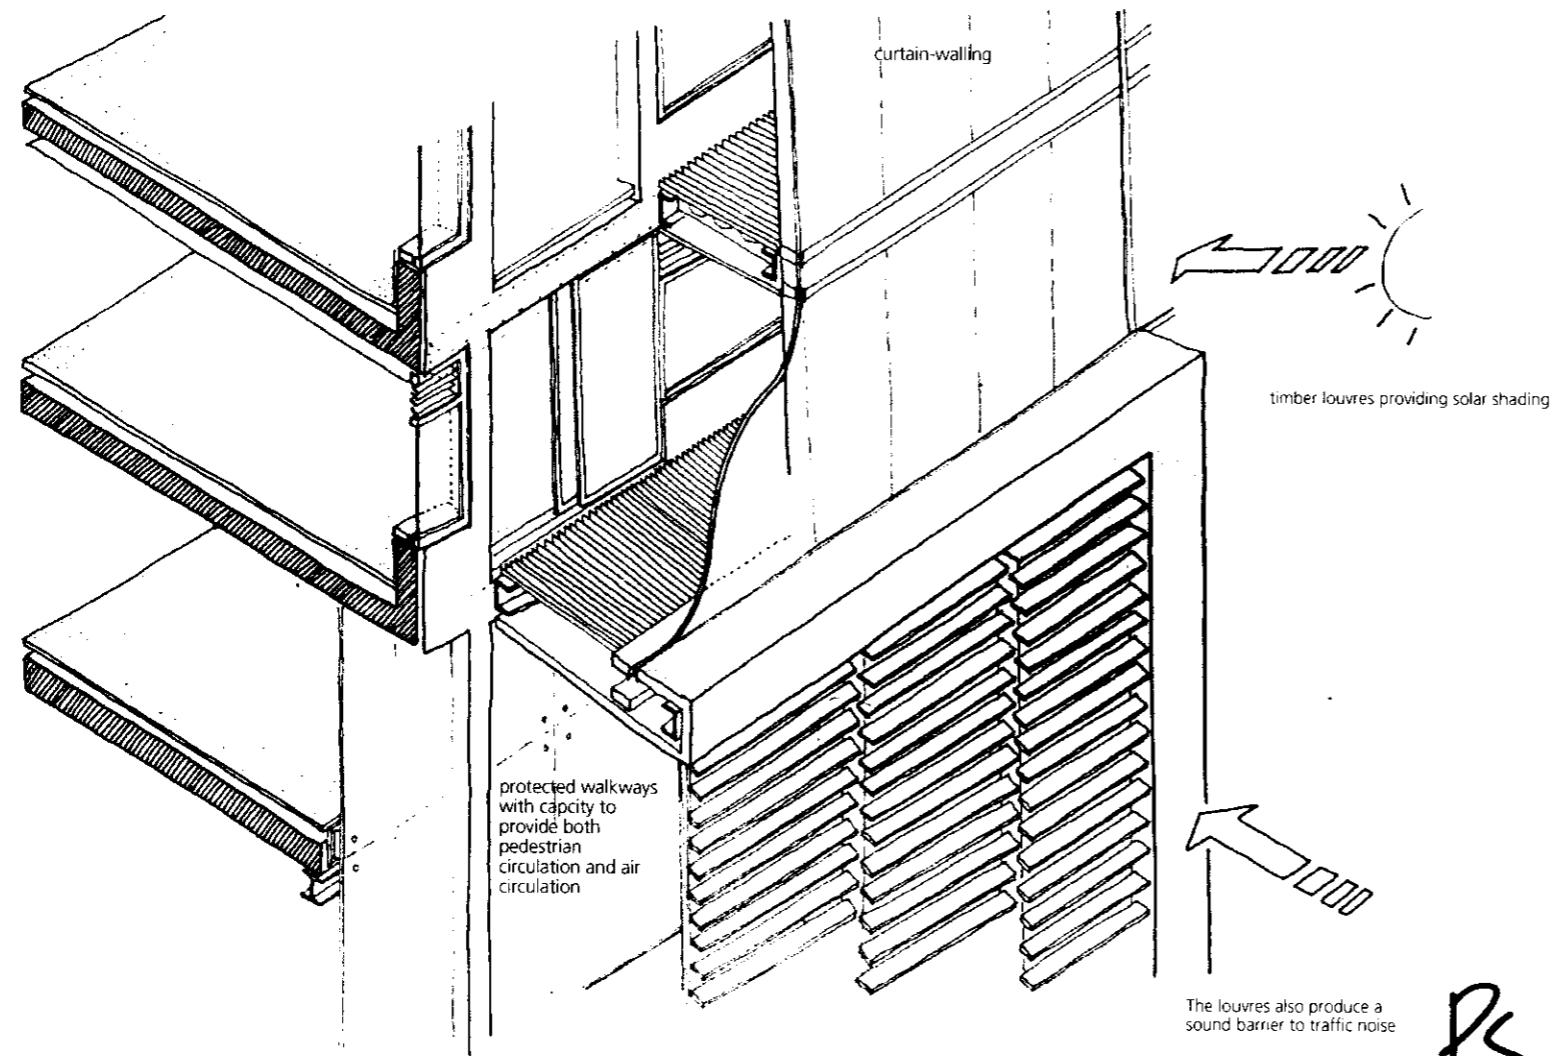
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DRAWING TITLE SOUTH FACADE
ENVIRONMENTAL CONDITIONS

Date: 21.01.00 DRAWN BY

Drawing No. Rev

RIP. JOB NUMBER psa



DOUBLE-SKIN FACADE

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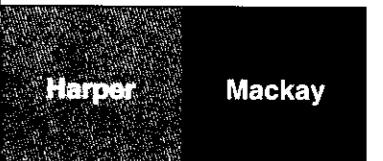
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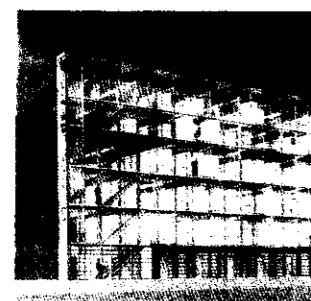
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DRAWING TITLE 3D RENDER - ARIAL VIEW


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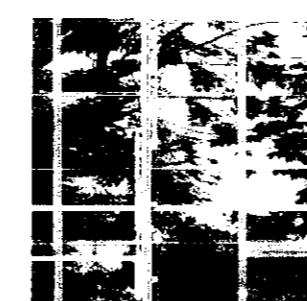
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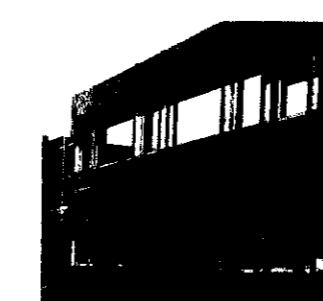
Operability



Shading




curtain-walling

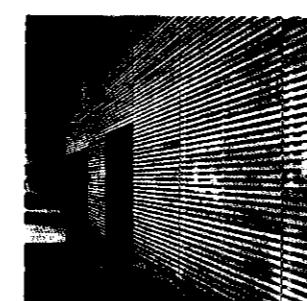

second skin

HM/691/05/01

FILE: JOB NUMBER 691

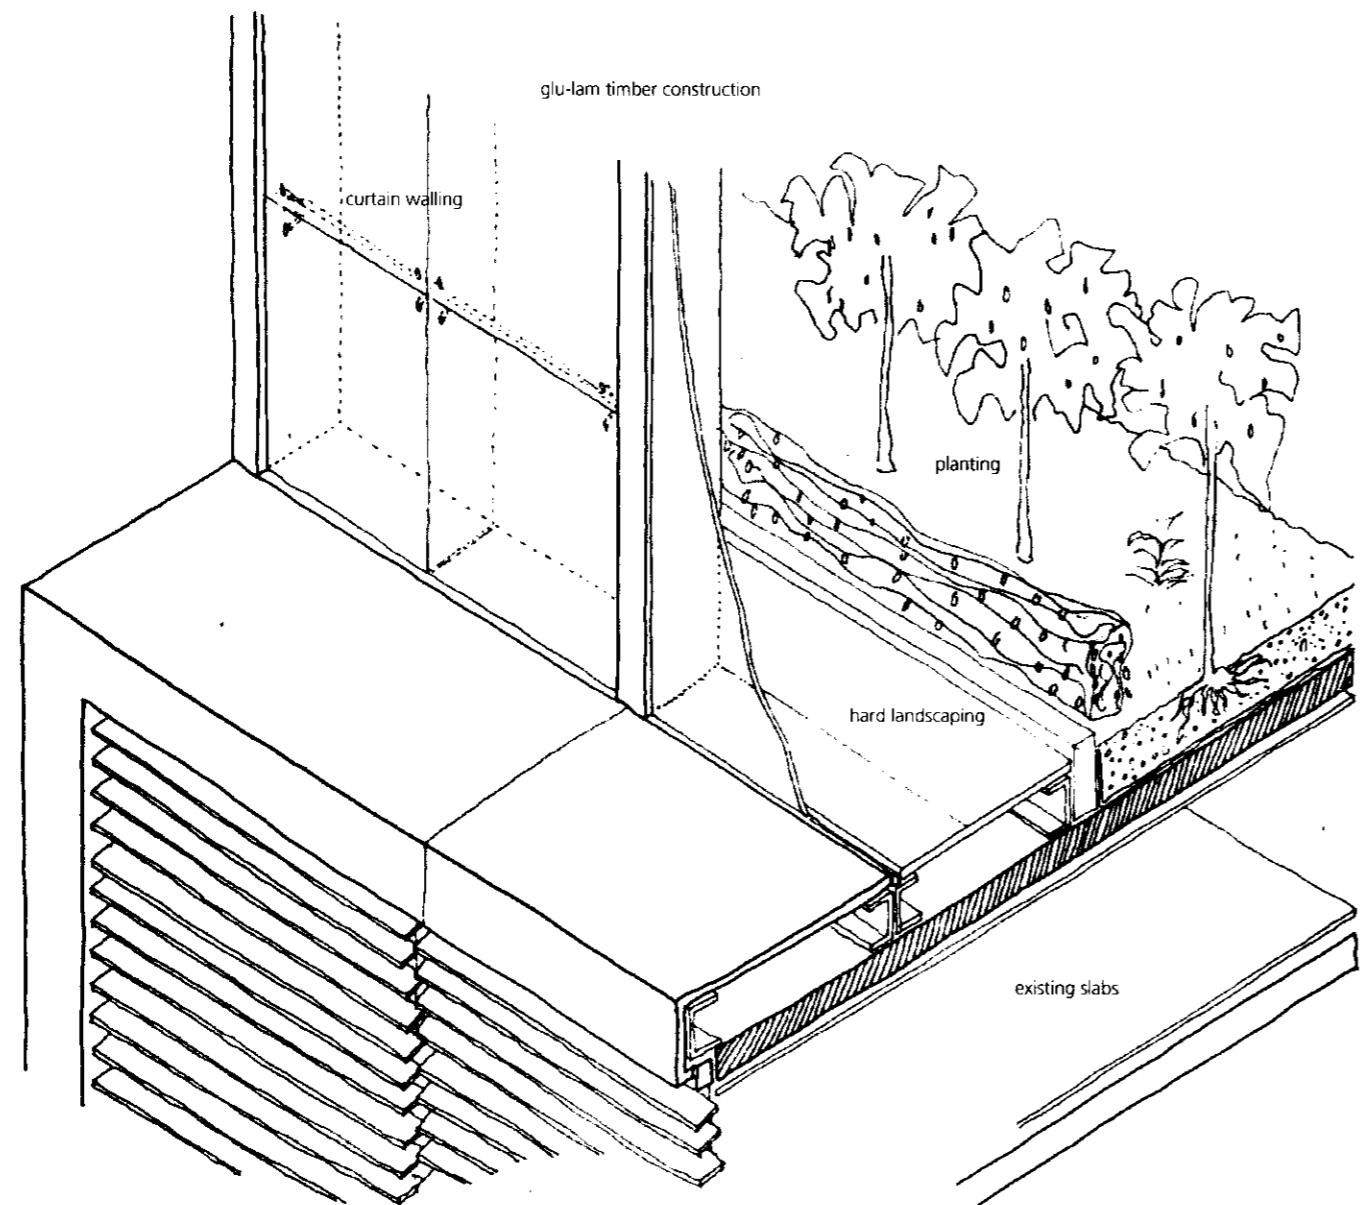

WINTERGARDEN

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KEY PLAN

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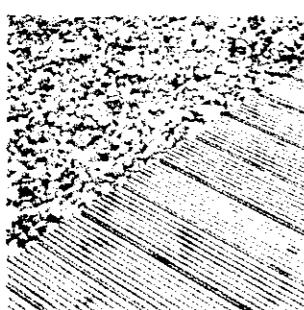
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DRAWING TITLE WINTERGARDEN

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Hard Landscaping



Planting



Foliage



seating



tranquility

FILE: JOB NUMBER 691



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Wind Engineering Consultant

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Mr Jonathan Dawes
Harper Mackay Architects
33-37 Charterhouse Square
London EC1M 6EA

HARPER MACKAY		REF
REC'D	26 JAN 2000	
DR.	✓	RK
ACTION		RS/AN

24 January 2000

Dear Jonathan,

10 Procter Street

This letter is to confirm our conversations on the effect of height changes on the wind through the Procter Street underpass.

The development forms an L shape, with the Procter Street underpass in the foot of the L. Wind flow through the underpass depends on the bulk of the building that forms the foot of the L. Changes to the height of the building that forms the leg of the L, marked "Retail/A3" on the site plans, will make no discernible changes to the flow through the Procter Street underpass.

I trust this statement meets your needs.

Yours sincerely,

N.J.Cook

N.J.Cook



Nicholas J Cook
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London EC1M 6EA

HARPER MACKAY		REF
REC'D	09 FEB 2000	
DR.	✓	RK
ACTION		RS

7 February 2000

Dear Jonathan,

10 Procter Street

This letter is to confirm our conversations regarding the proposed screened-off pedestrian walkway through the Procter Street underpass.

While the changes to the façade of the main building will make no noticeable difference to the wind flow through the underpass, the proposed screens will act to direct more of the wind through the roadway and so reduce nuisance to pedestrians in the walkway. The particular improvements I suggested to the scheme for the western walkway:

1. avoiding the narrowing Venturi effect at the southern entrance by keeping the screen parallel to the building façade, and
 2. angling the screen parallel to the edge of the vehicle pull-in at the northern entrance to direct wind into the roadway,
- are expected to give the best reductions in nuisance practicable without obstructing pedestrians or vehicles.

I trust this statement meets your needs.

Yours sincerely,

N.J.Cook

N.J.Cook

r2

PS 9904731



10 PROCTER STREET

Architectural Engineers Report