

Notes

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Figured dimensions shall be used in preference to scaled dimensions. All dimensions shall be checked on site before commencing works.

All work shall comply with the latest Building Regulations and be to the satisfaction of the Local Authority.

Workmanship and methods of construction shall be at least to the standard prescribed by the relevant Codes of Practice.

Materials shall be suitable for the purpose for which they are used and the quality shall not be lower than that defined in the relevant British or Continental Standard so designated.

General Specifications

1. All drainage shown on this drawing is assumed only and it is the contractors responsibility to check the exact depths and locations prior to the commencement of the works.

2. Any new or proposed drains found under the proposed extension are to be enclosed in 150mm concrete and reinforced concrete lintels are to be provided in the walls above the drain run.

3. Existing sub-floor ventilation is to be maintained (if necessary) by providing 100mm dia pipe ducts extending from the existing air bricks to new 225 x 150mm air bricks in new external walls.


4. All glazing is to be double glazed and to be to BS5206 and any glazing below 1 m from ground floor level is to be toughened or laminated.

5. All new habitable rooms are to be provided with permanent ventilation of 8000m³, and this is to be achieved by providing either trickle vents in the door/window design or by air bricks within the room.


6. Provide vertical and horizontal apertures and all lintels are to have a minimum end bearing of 150mm.

7. All steel beams are to be enclosed in 2 layers of 12.5mm plaster board and skim coat of plaster to achieve a fire rating of 1/2 hour.

8. All timbers used in the construction of this project are to be SG3 grade.

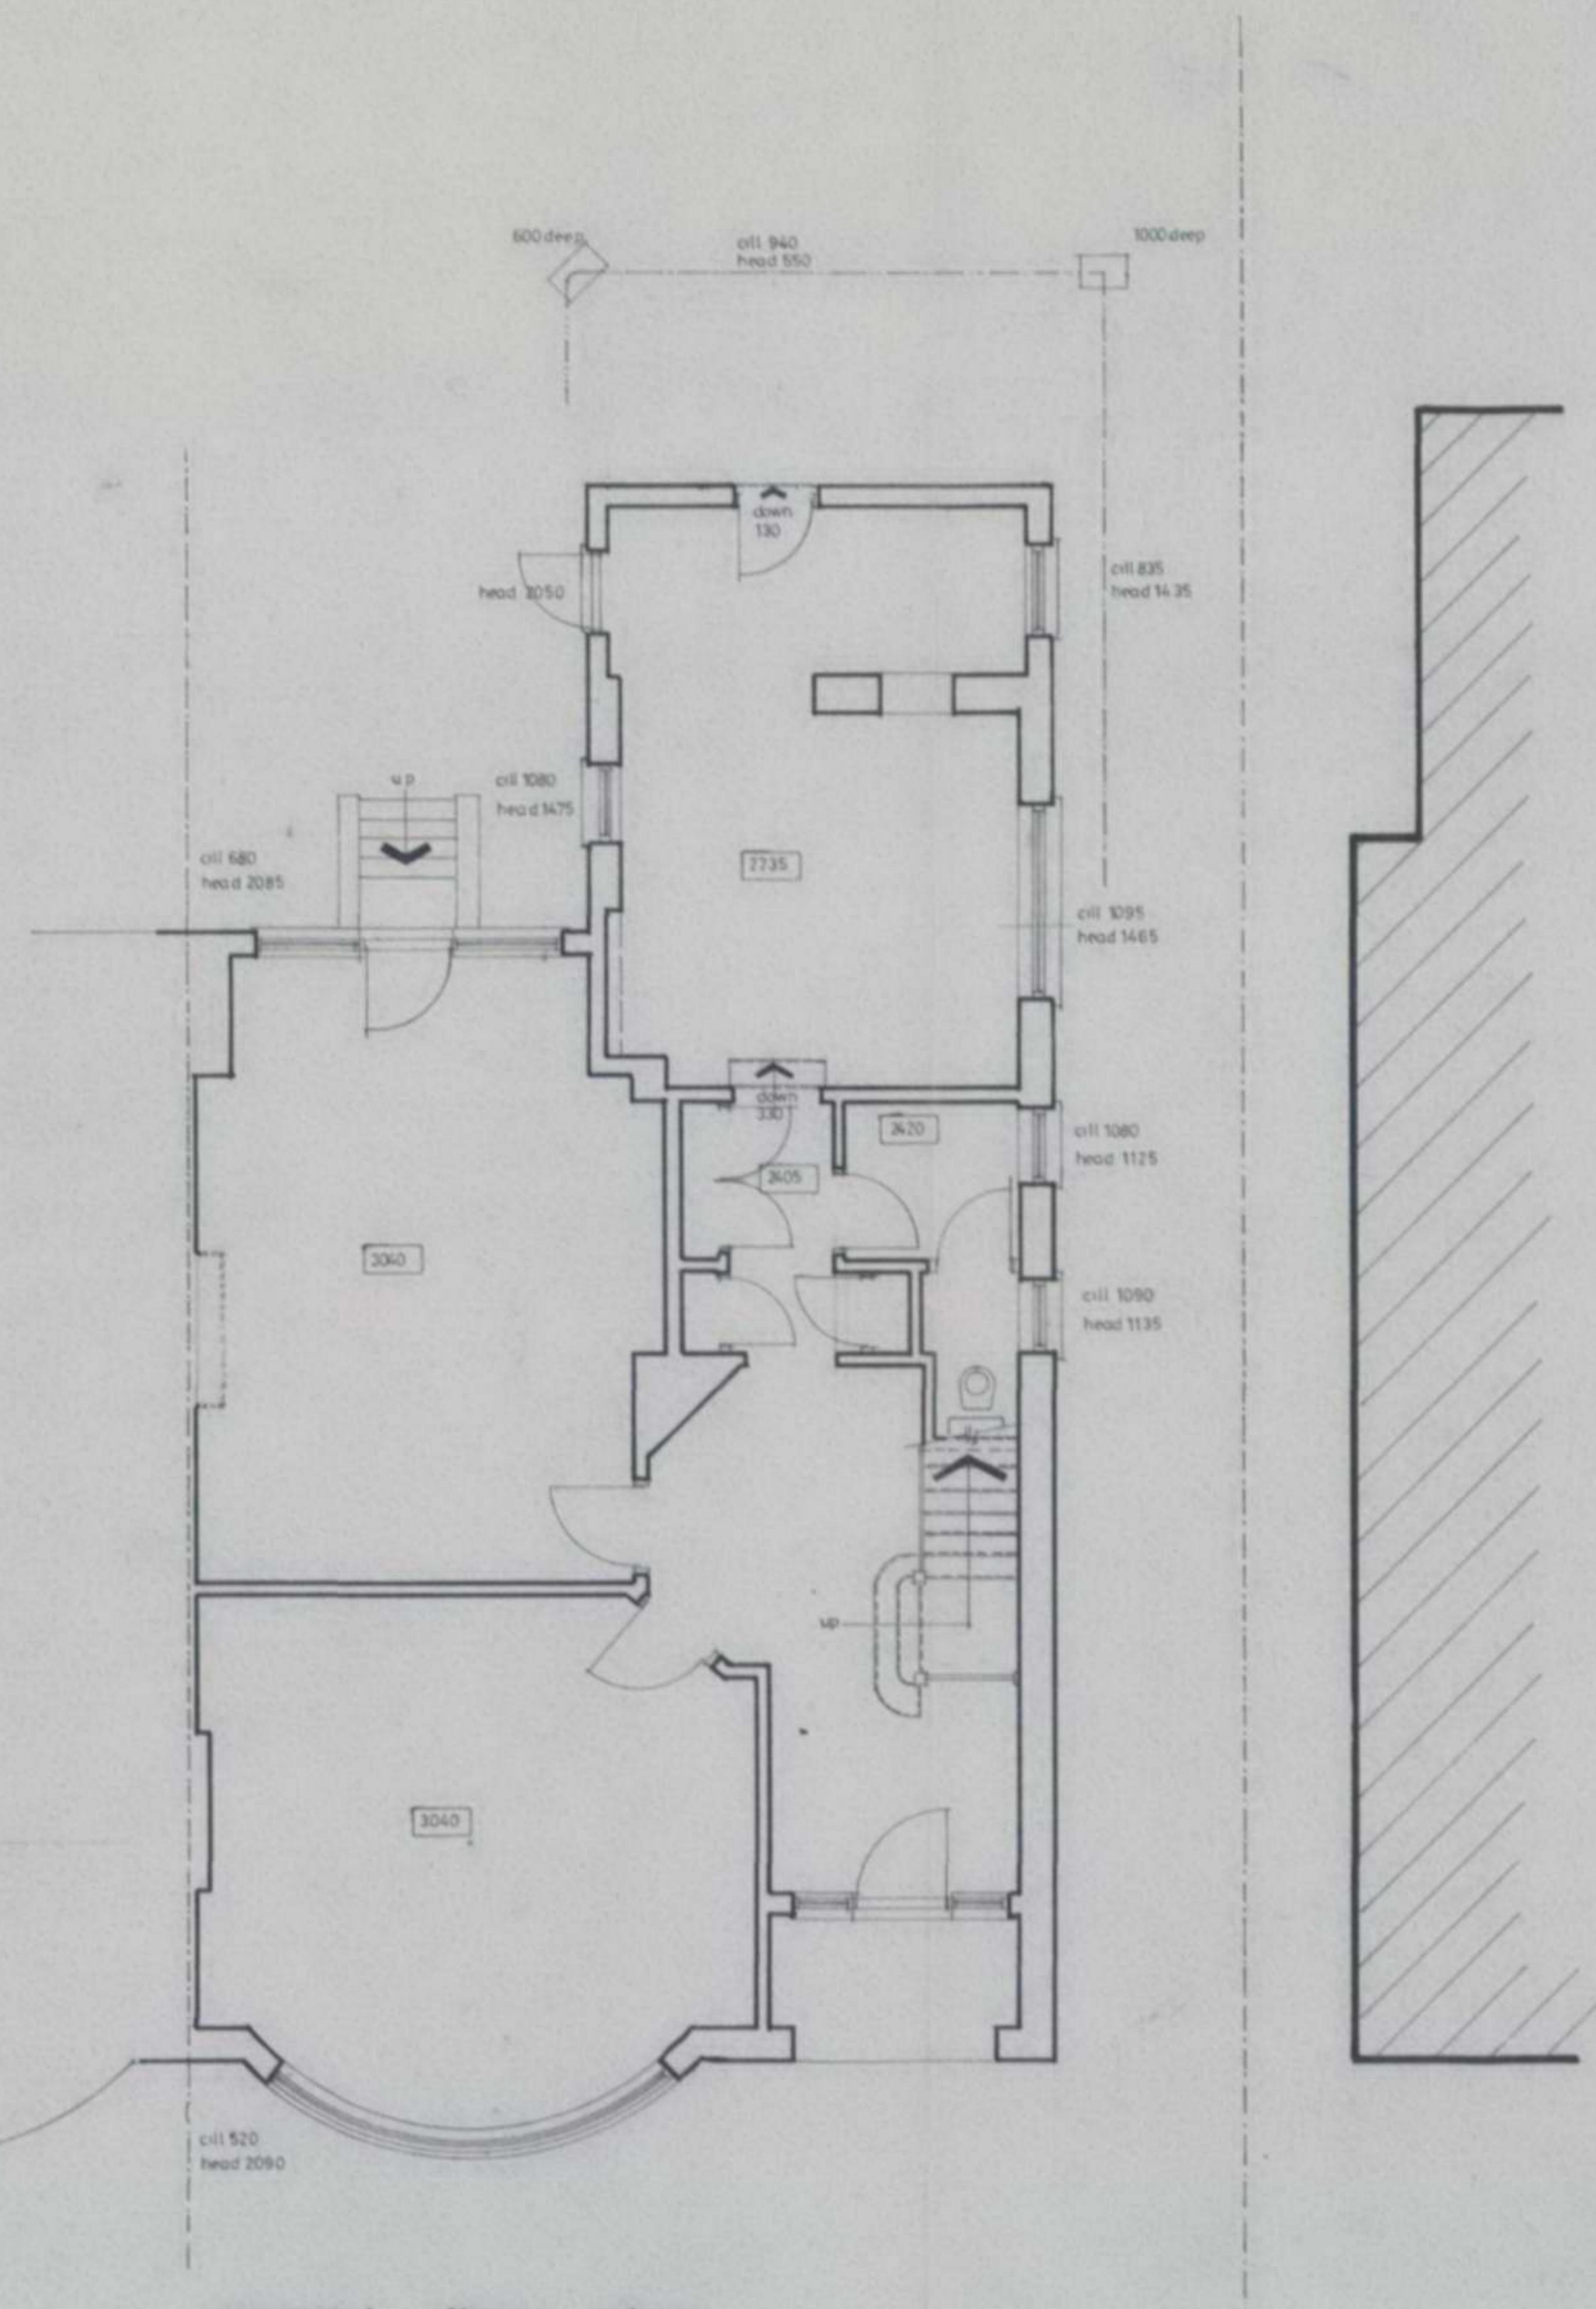

ground floor plan

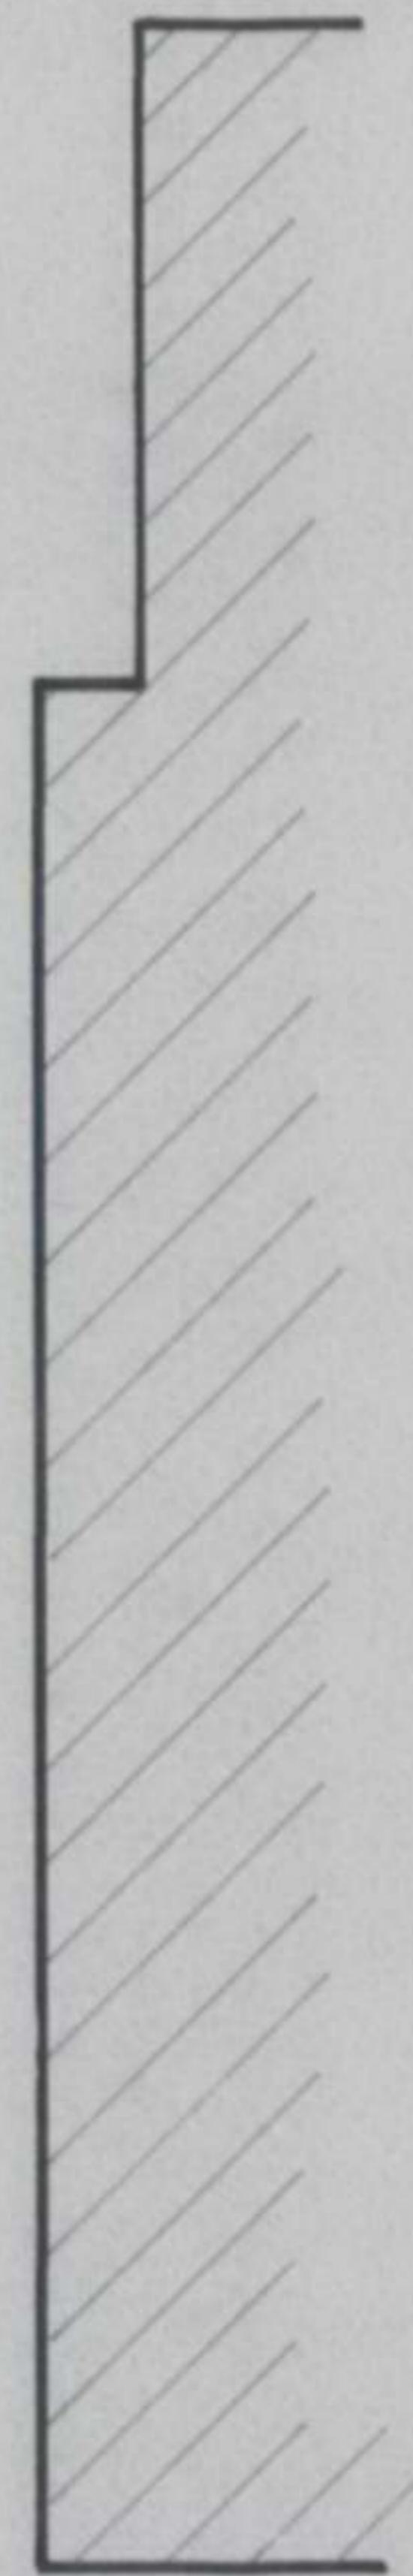

first floor plan

as existing

Revisions

Project

Proposed alterations
9 Platts Lane.
Hampstead NW3.

Anthony J Blyth & Co

17 Sequoia Park,
Hatch End, Pinner
Middlesex HA5 4DG
Telephone: 020 8428 6888



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29 AUG 2006

Scale 1:50.
Date June 2006.
Drawn By AJBlyth.

DRAWING NO PMB/06/137/1

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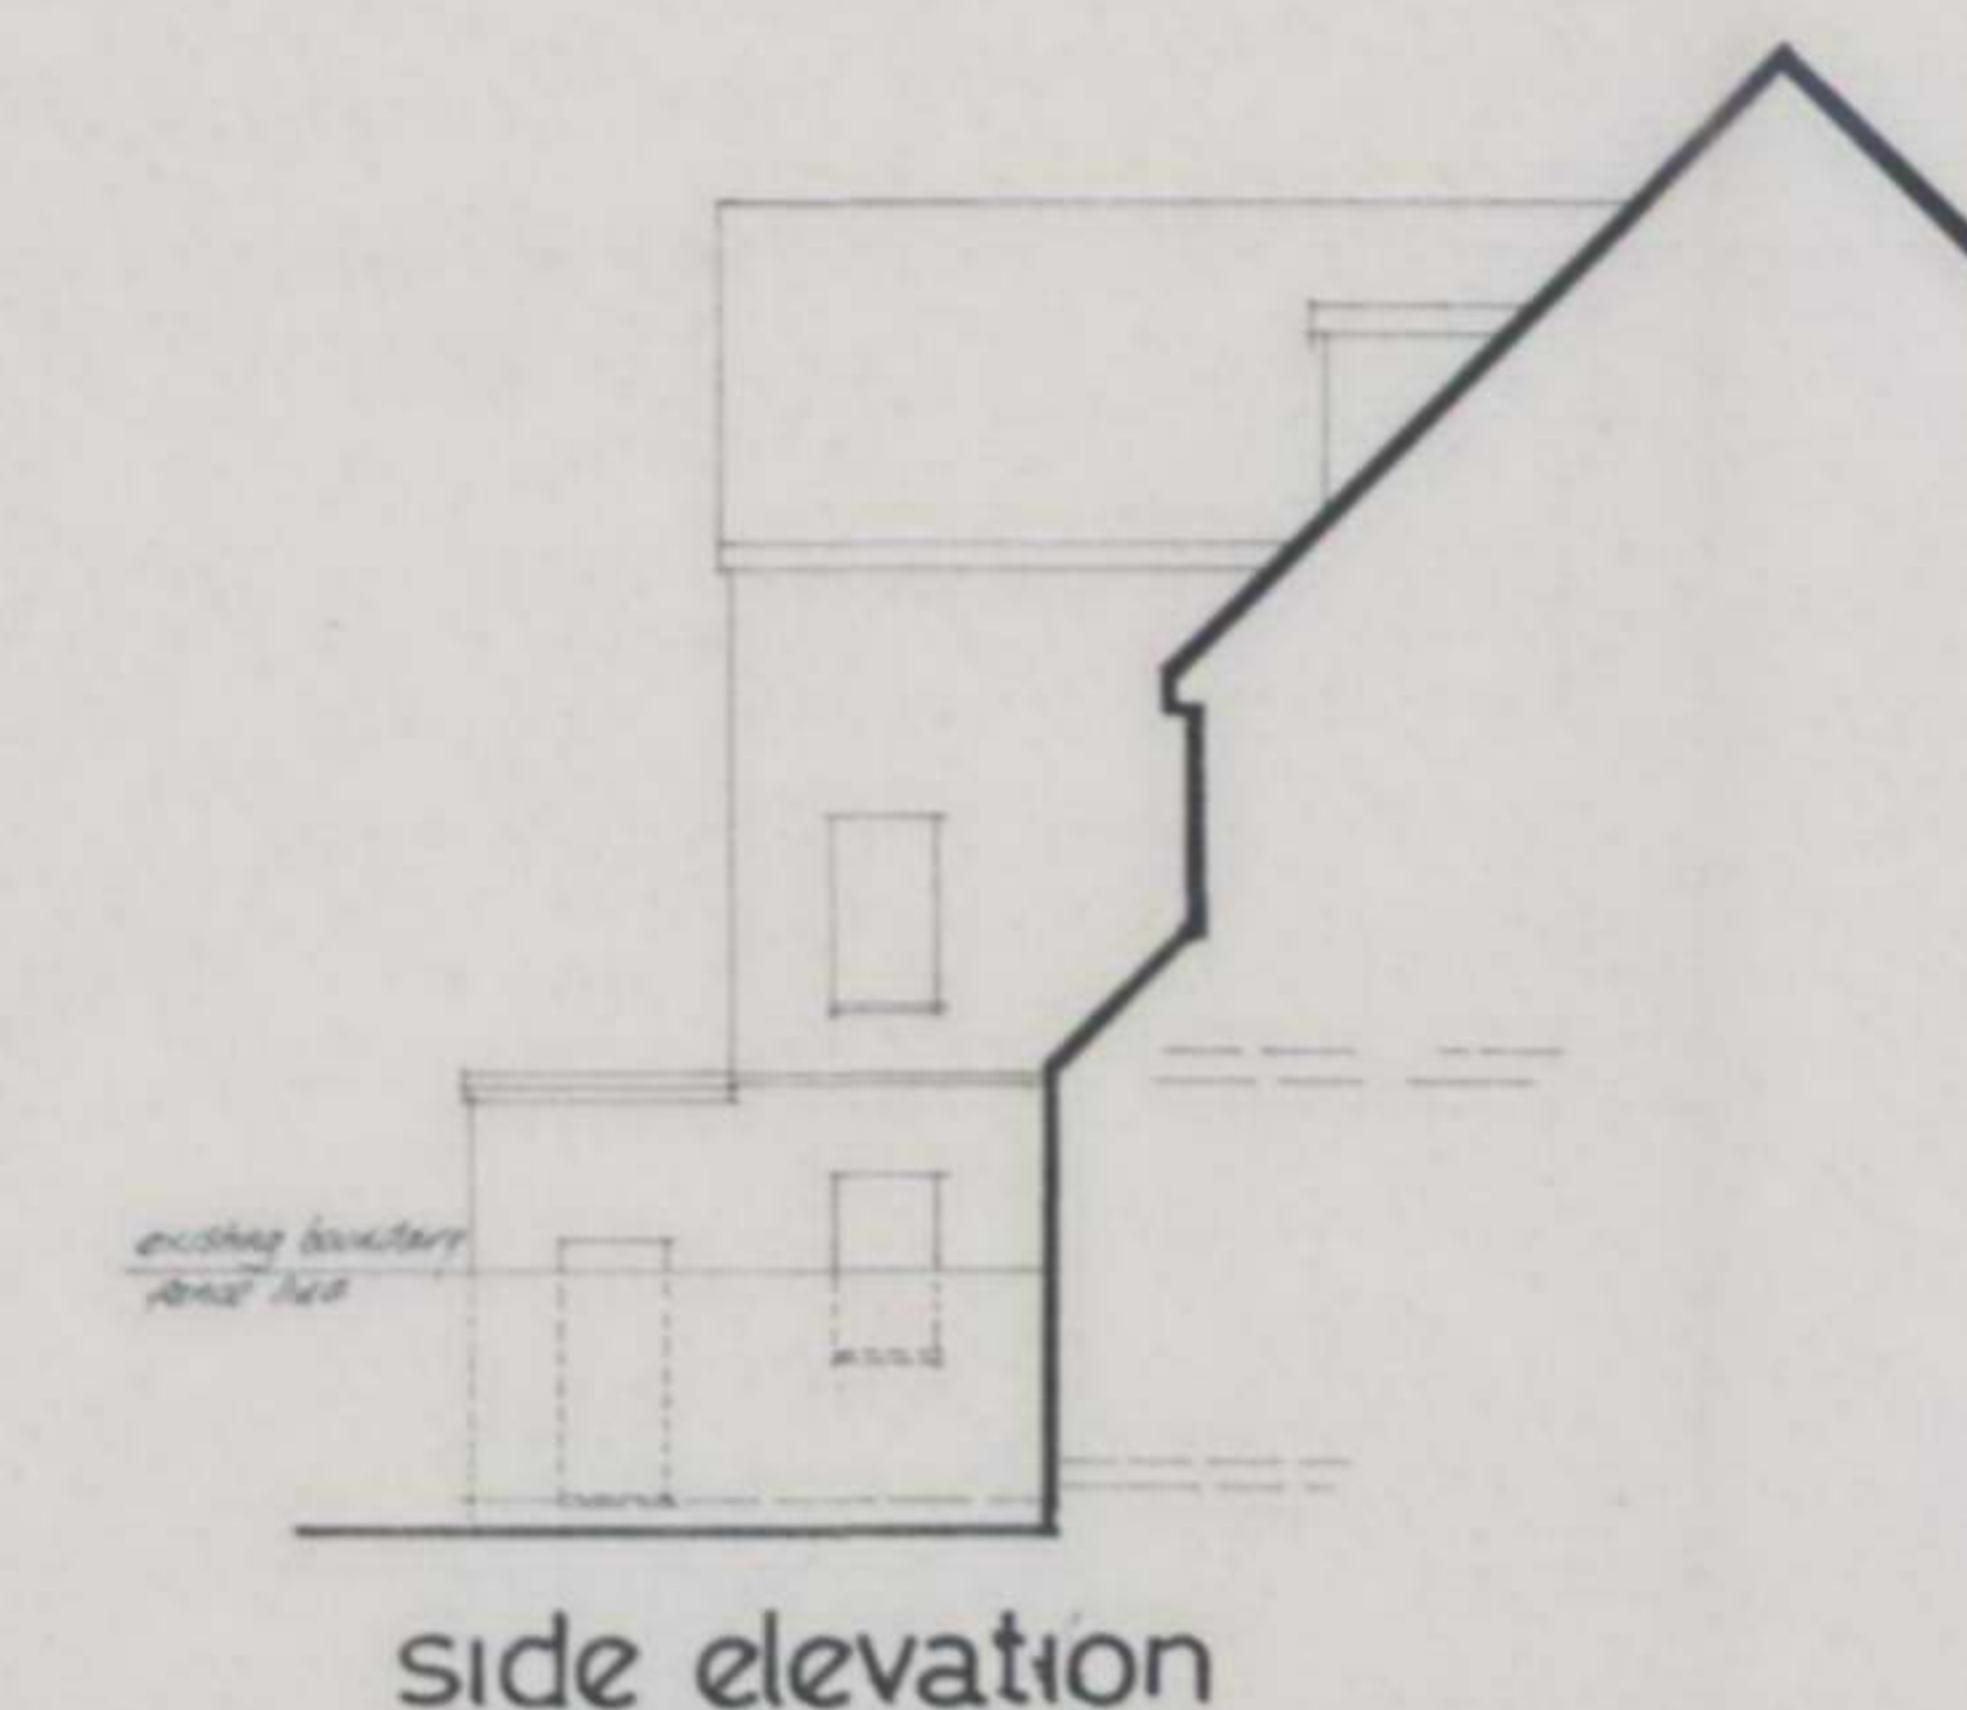
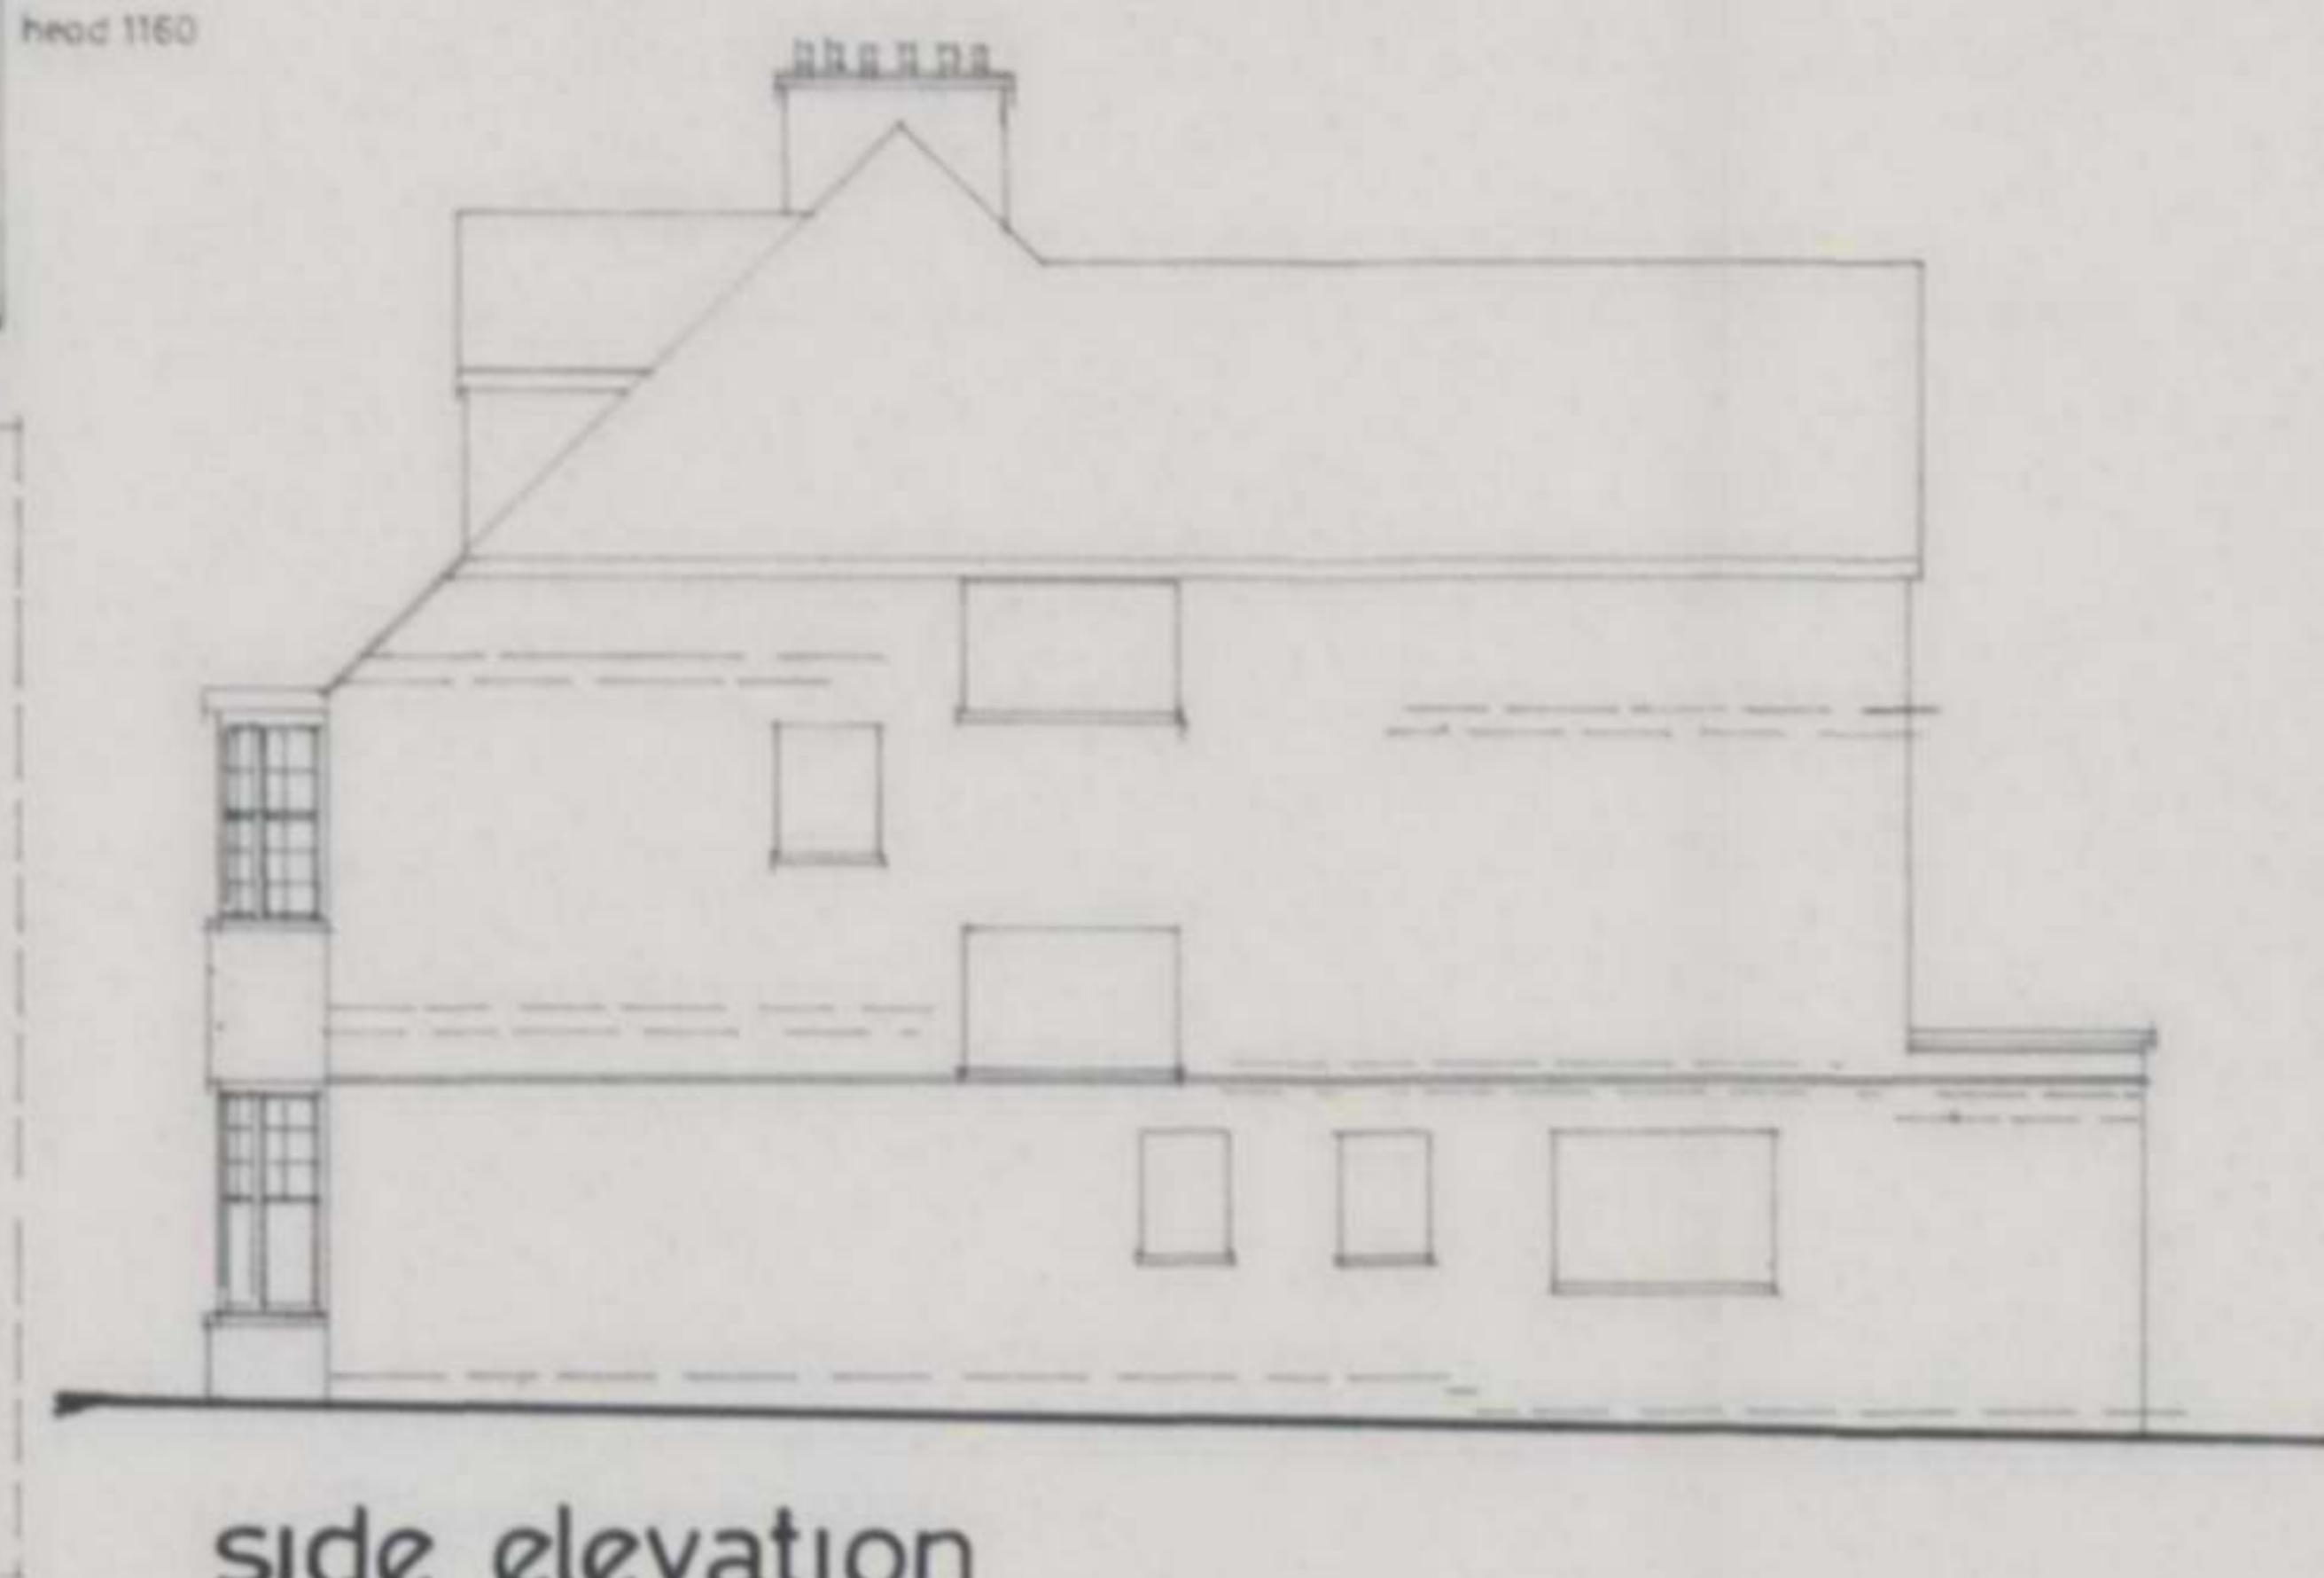
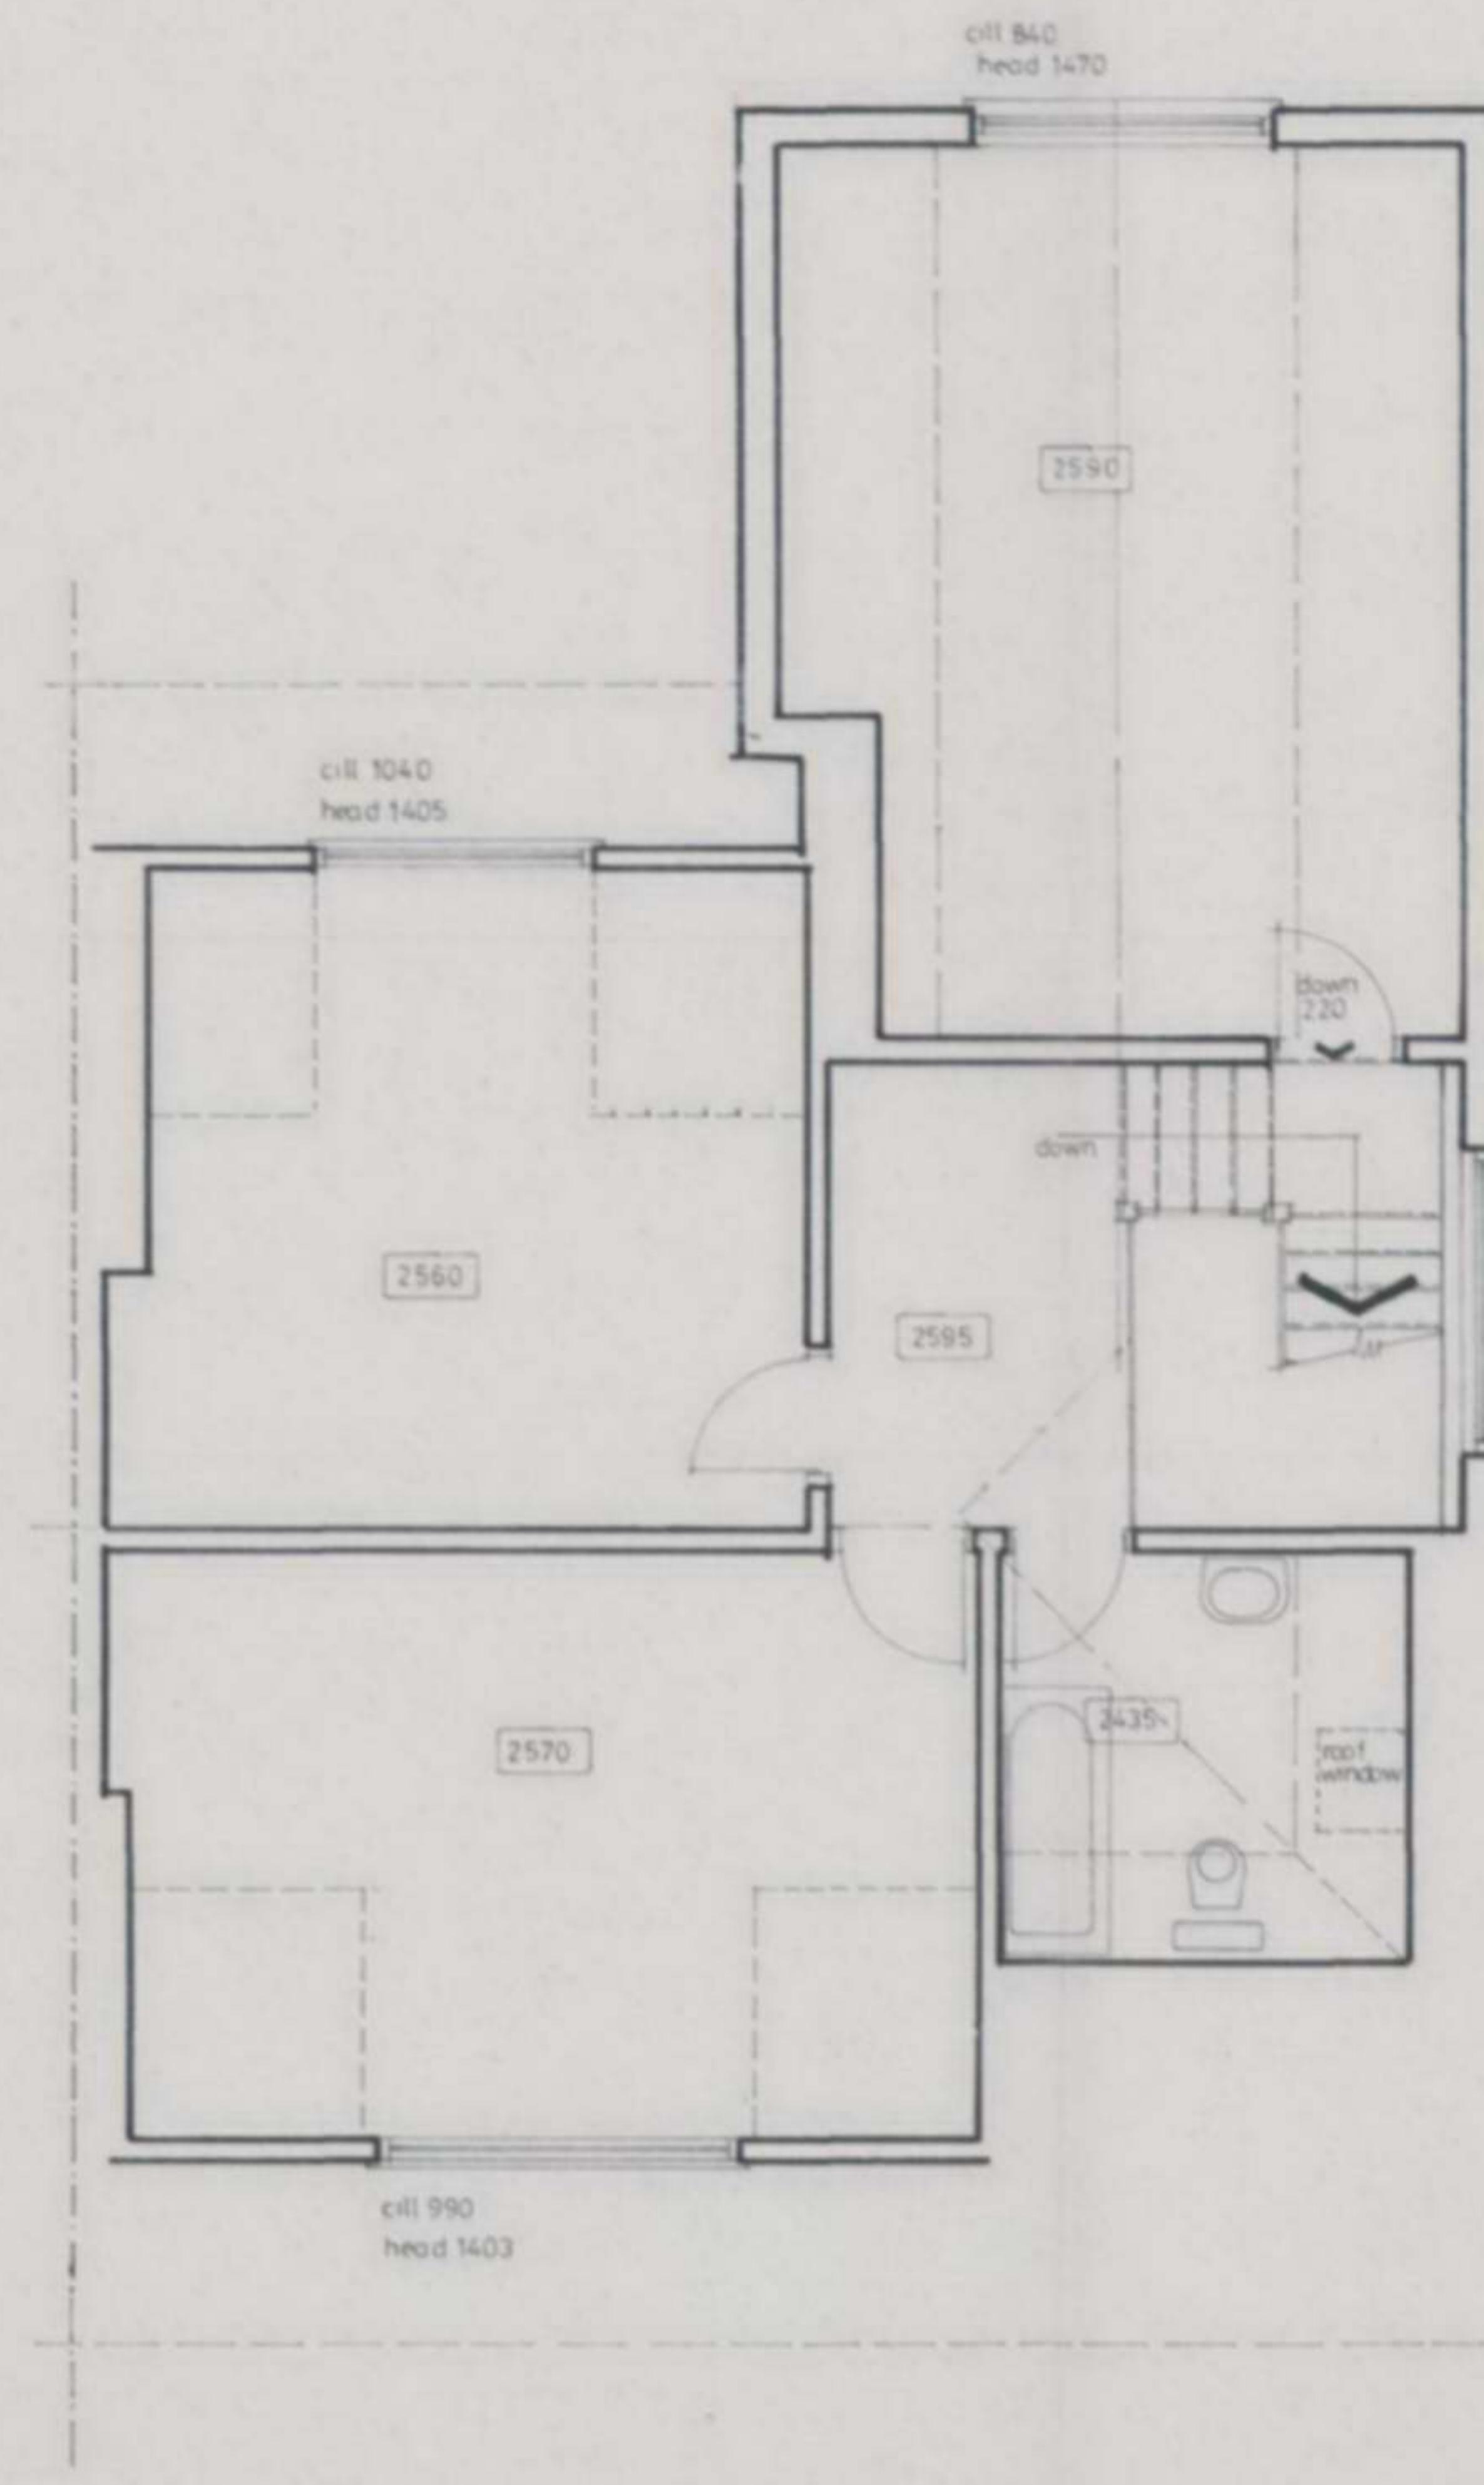
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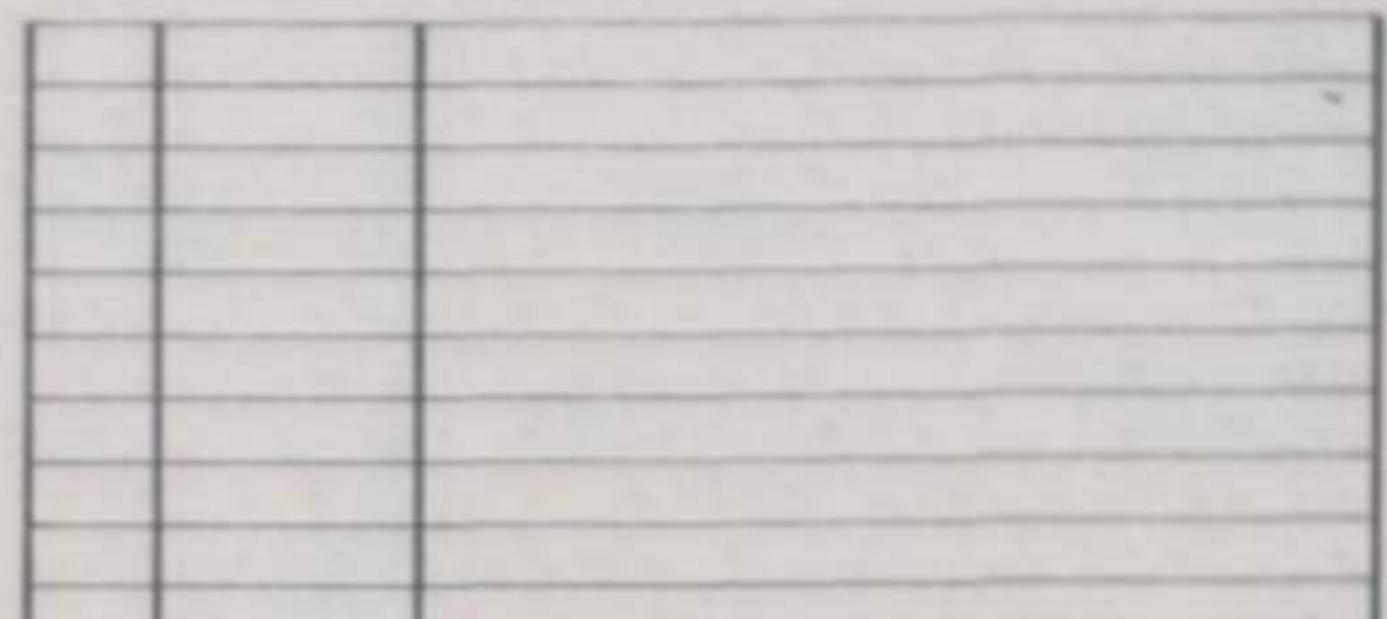
Materials shall be suitable for the purpose for which they are used and the quality shall not be lower than that defined in the relevant British or Continental Standard so designated.

General Specifications

1. All drainage shown on this drawing is assumed only and it is the contractors responsibility to check the exact depths and locations prior to the commencement of the works.
2. Any new or proposed drains found under the proposed extension are to be encased in 150mm concrete and reinforced concrete lintels are to be provided in the walls above the drain run.
3. Existing roof-floor ventilation is to be maintained (if necessary) by providing 100mm dia pvc vent pipes from the existing air bricks to new 225 x 150mm brick air bricks in the new external walls.
4. All plastering is to be double glazed and to be to BS6208 and any glazing below 1.1m from ground floor level is to be toughened or laminated.
5. All new habitable rooms are to be provided with permanent ventilation of 8000mm², and this is to be achieved by providing either trickle vents in the door/window design or by air bricks within the room.
6. Provide vertical and horizontal dpc's at all reveals, and all lintels are to have a minimum end bearing of 150mm.
7. All steel beams are to be encased in 2 layers of 12.5mm plaster board and skim coat of plaster to achieve a fire rating of 1/2 hour.
8. All timbers used in the construction of this project are to be to SG3 grade.



as existing



Revisions

Project
Proposed alterations
9 Platts Lane,
Hampstead NW3.

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29 AUG 2006

Scale 1:50.
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Drawn By A.J.Blyth.

DRAWING No PMB/06/137/2

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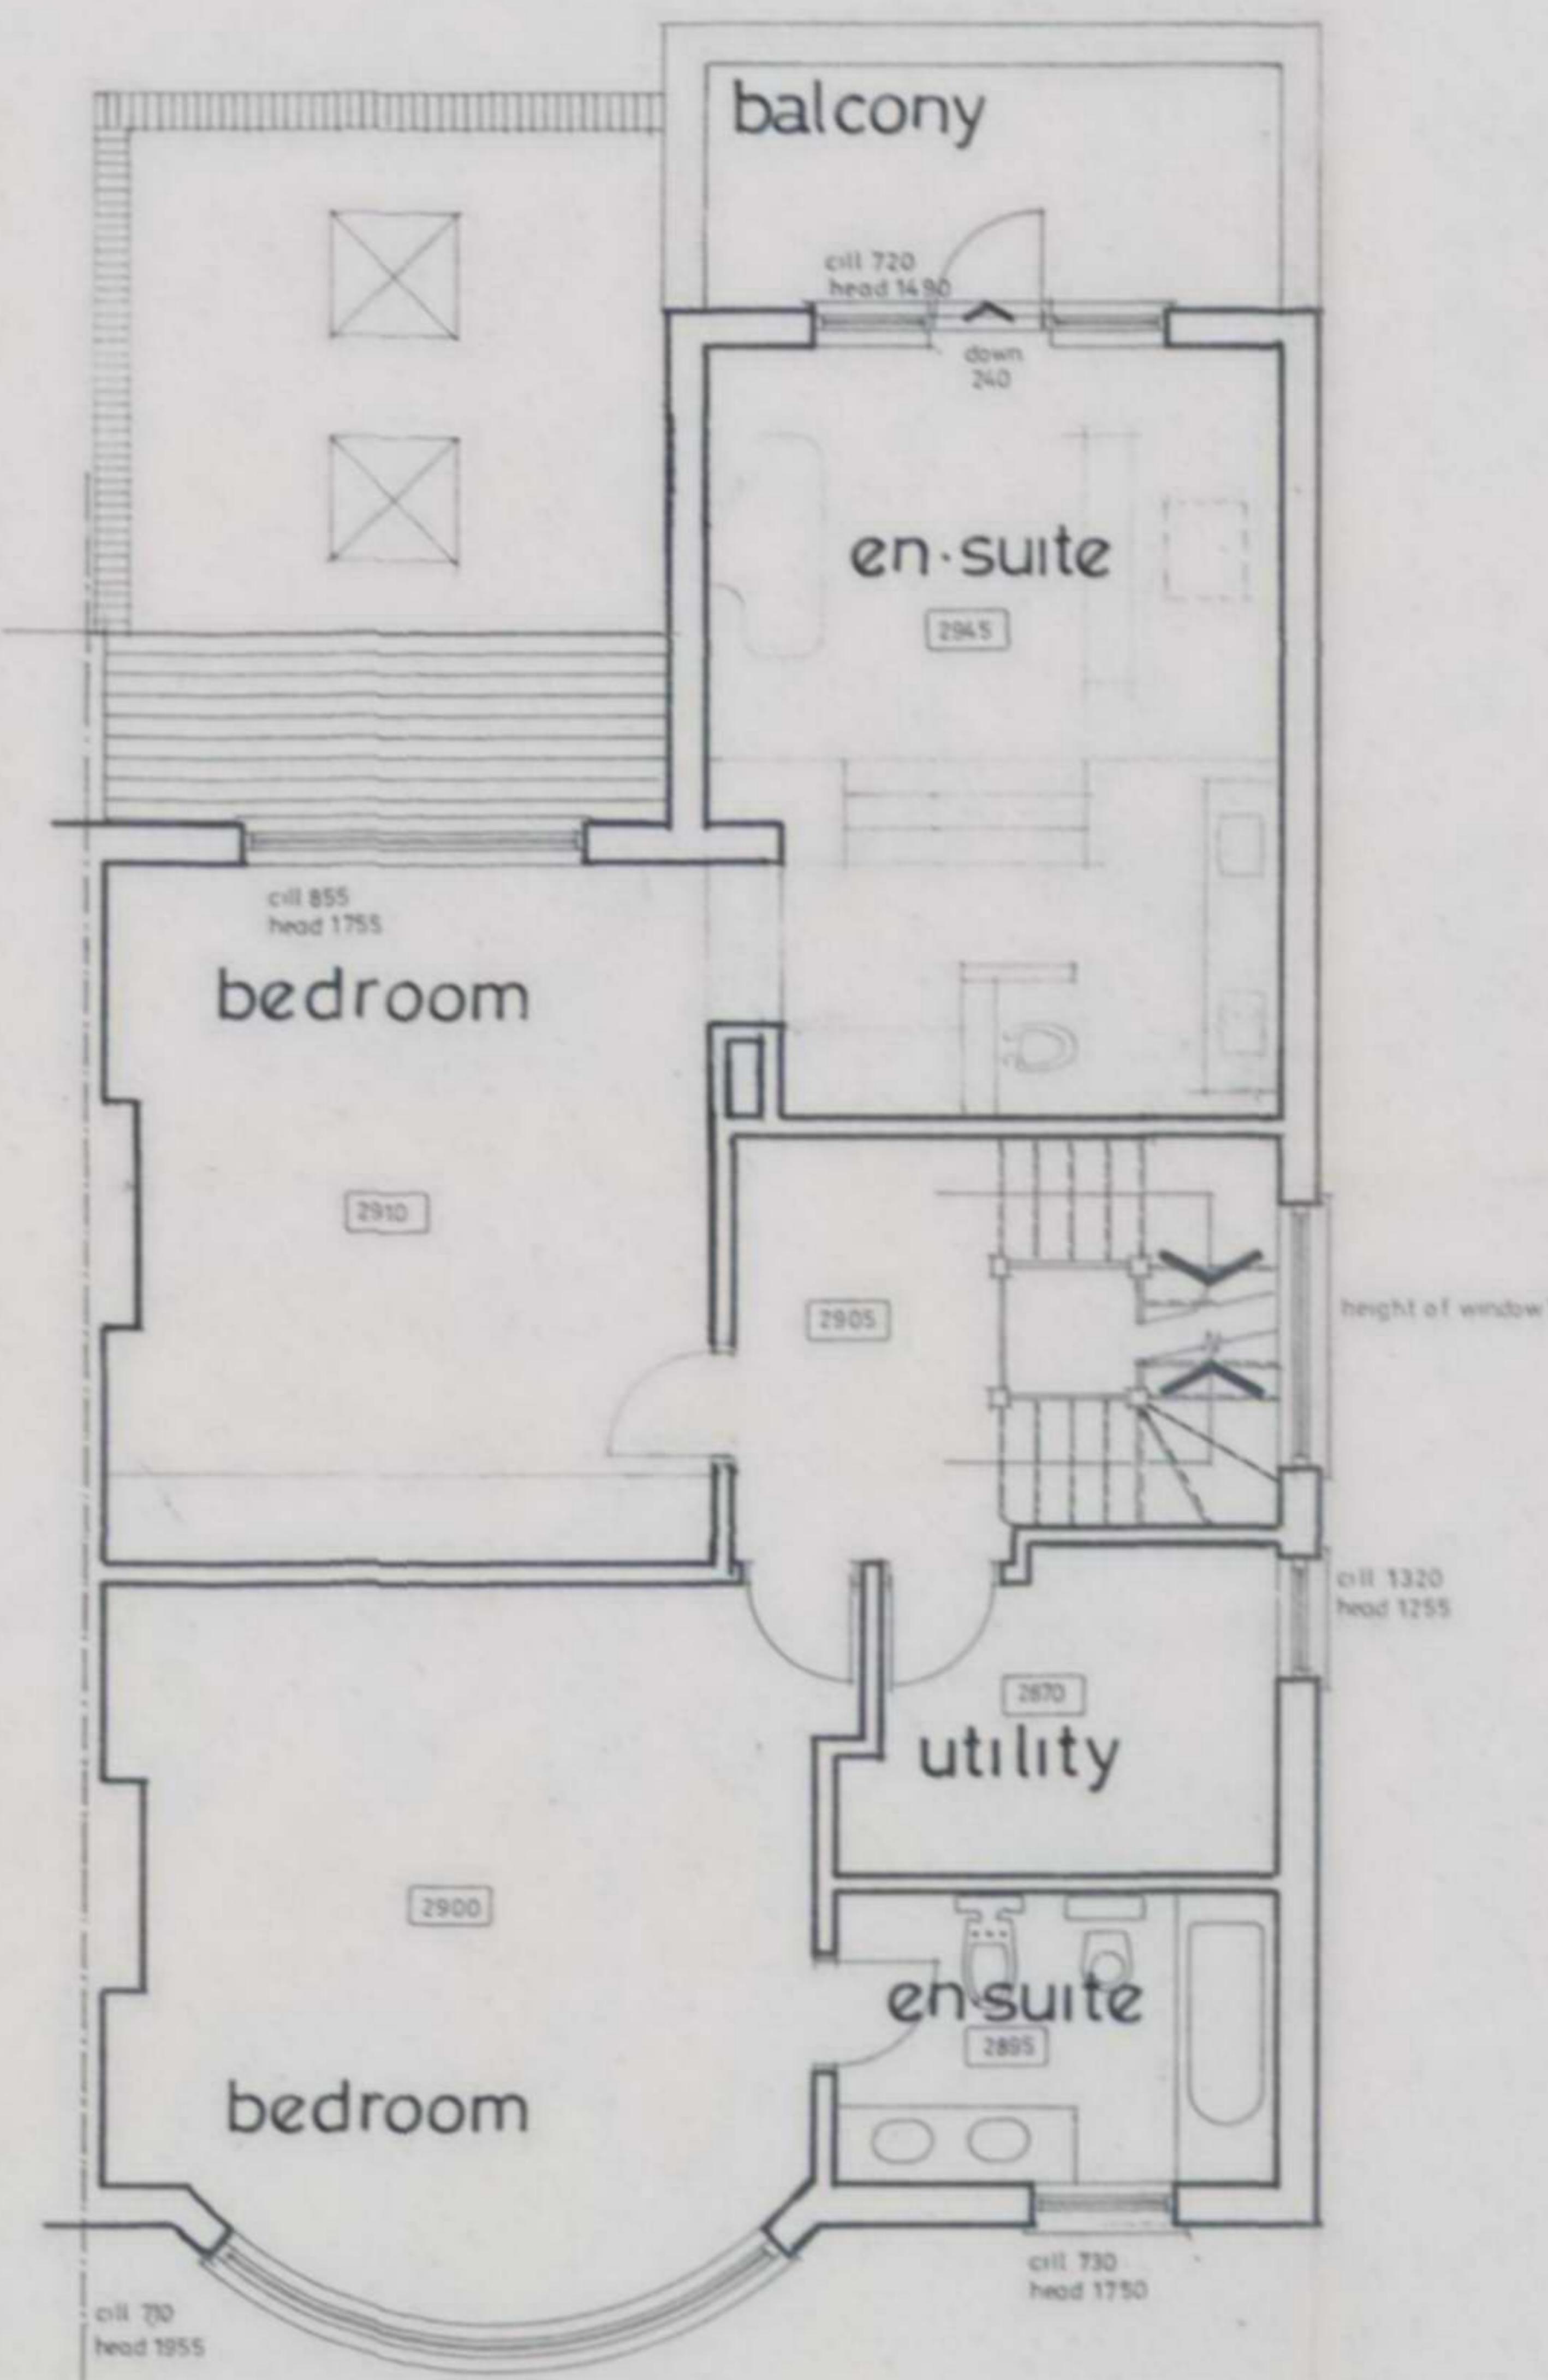
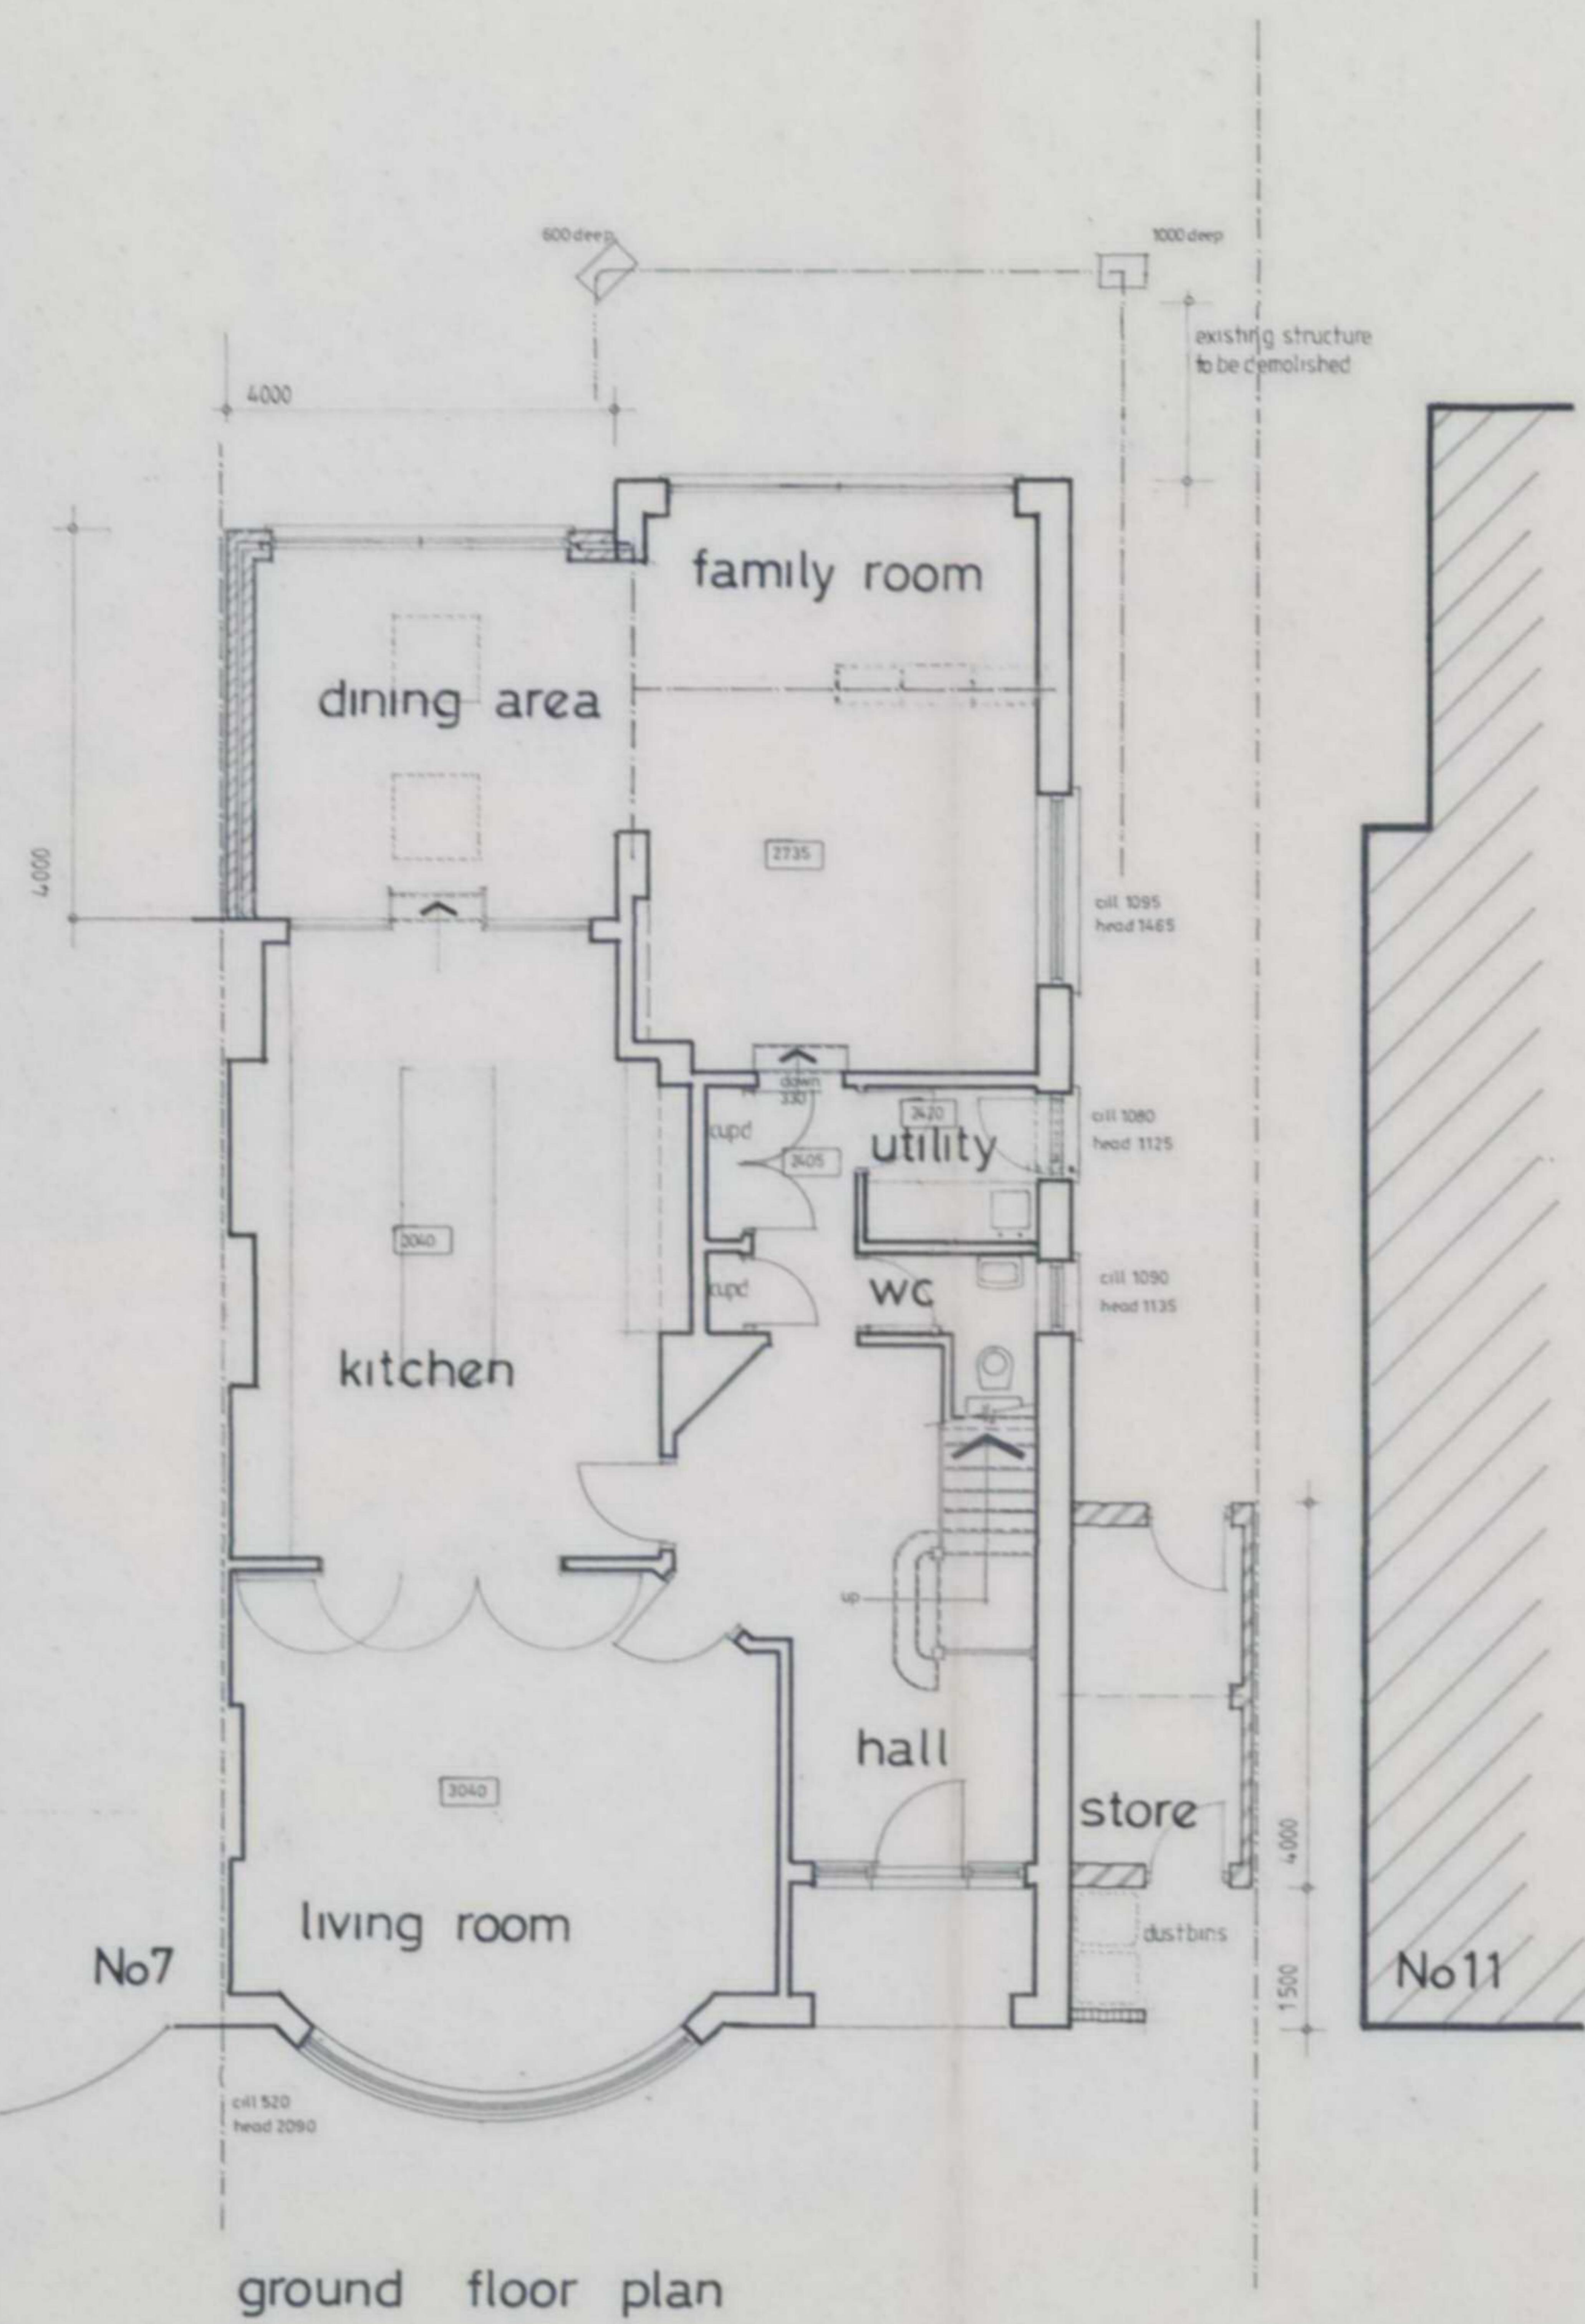
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General Specifications

1. All drainage shown on this drawing is assumed only and it is the contractors responsibility to check the exact depths and locations prior to the commencement of the work.
2. Any new or proposed drains for under the proposed extension are to be encased in 150mm concrete and reinforced concrete limits are to be provided in the walls above the drain run.
3. Existing sub-floor ventilation is to be maintained (if necessary) by providing 100mm dia pvc ducts extending from the existing air bricks to new 225 x 150mm air bricks in the new external walls.
4. All glazing is to be double glazed and to be to BS6208 and any glass below 1.1m from ground floor level is to be toughened or laminated.
5. All new habitable rooms are to be provided with permanent ventilators of 8000mm², and this is to be achieved by providing either trickle vents in the door/window design or by air bricks within the room.
6. Provide vertical and horizontal dpc's at all reveals, and all lintels are to be set in a minimum bearing of 150mm.
7. All steel beams are to be encased in 2 layers of 12.5mm plaster board and skim coat of plaster to achieve a fire rating of 1/2 hour.
8. All timbers used in the construction of this project are to be to SG3 grade.




PERMITTED DEVELOPMENT

Rear extension 56cubm
side extension 22cubm
total 78cubm

Cubic capacity of existing house
1030cubm
Allowance for 'PD' 10% or 115cubm
Therefore proposals are within PD.

as proposed

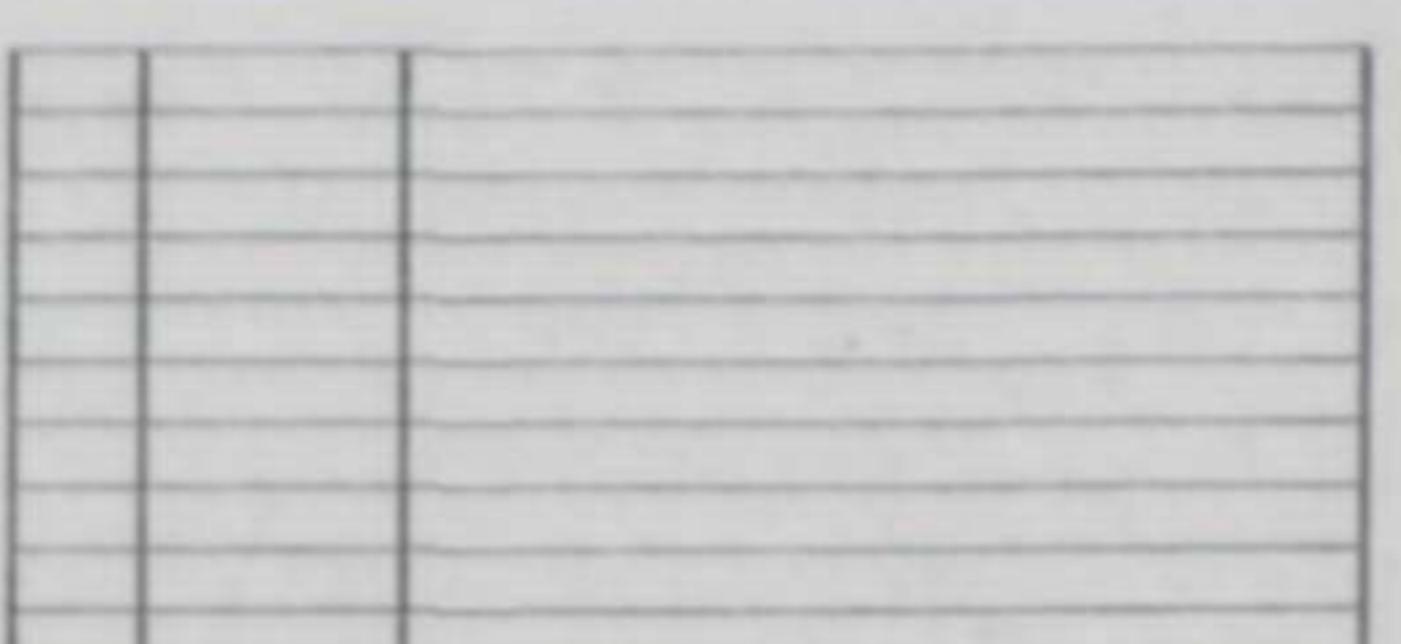

Project
Proposed alterations
9 Platts Lane,
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Scale 1:50.
Date June 2006.
Drawn By A.J.Blyth.
DRAWING No PMB/06/137/3

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General Specifications



1. All drainage shown on this drawing is assumed only and it is the contractor's responsibility to check the exact depths and locations prior to the commencement of the works.
2. Any new or proposed drains found under the proposed extension area or in the existing walls or foundations or concrete areas are to be provided in the walls above the drain runs.
3. Existing sub-floor ventilation is to be maintained (if necessary) by providing 150mm dia pvc ducts extending from the existing air bricks to new 225 x 150mm air bricks in the new external walls.
4. All glazing is to be double glazed and to be to BS6206 and any glazing below 1.1m from ground floor level is to be toughened or laminated.
5. All new habitable rooms are to be provided with permanent ventilation of 6000mm², and this is to be achieved by providing either trickle vents in the doorframe design or by air bricks within the room.
6. Provide vertical and horizontal soffit's at all reveals, and all soffits are to have a minimum end bearing of 150mm.
7. All brickwork areas are to be rendered in 2 layers of 12.5mm plaster board and render coat or plaster to achieve a fire rating of 1½ hour.
8. All timbers used in the construction of this project are to be to SD3 grade.




front elevation



rear elevation

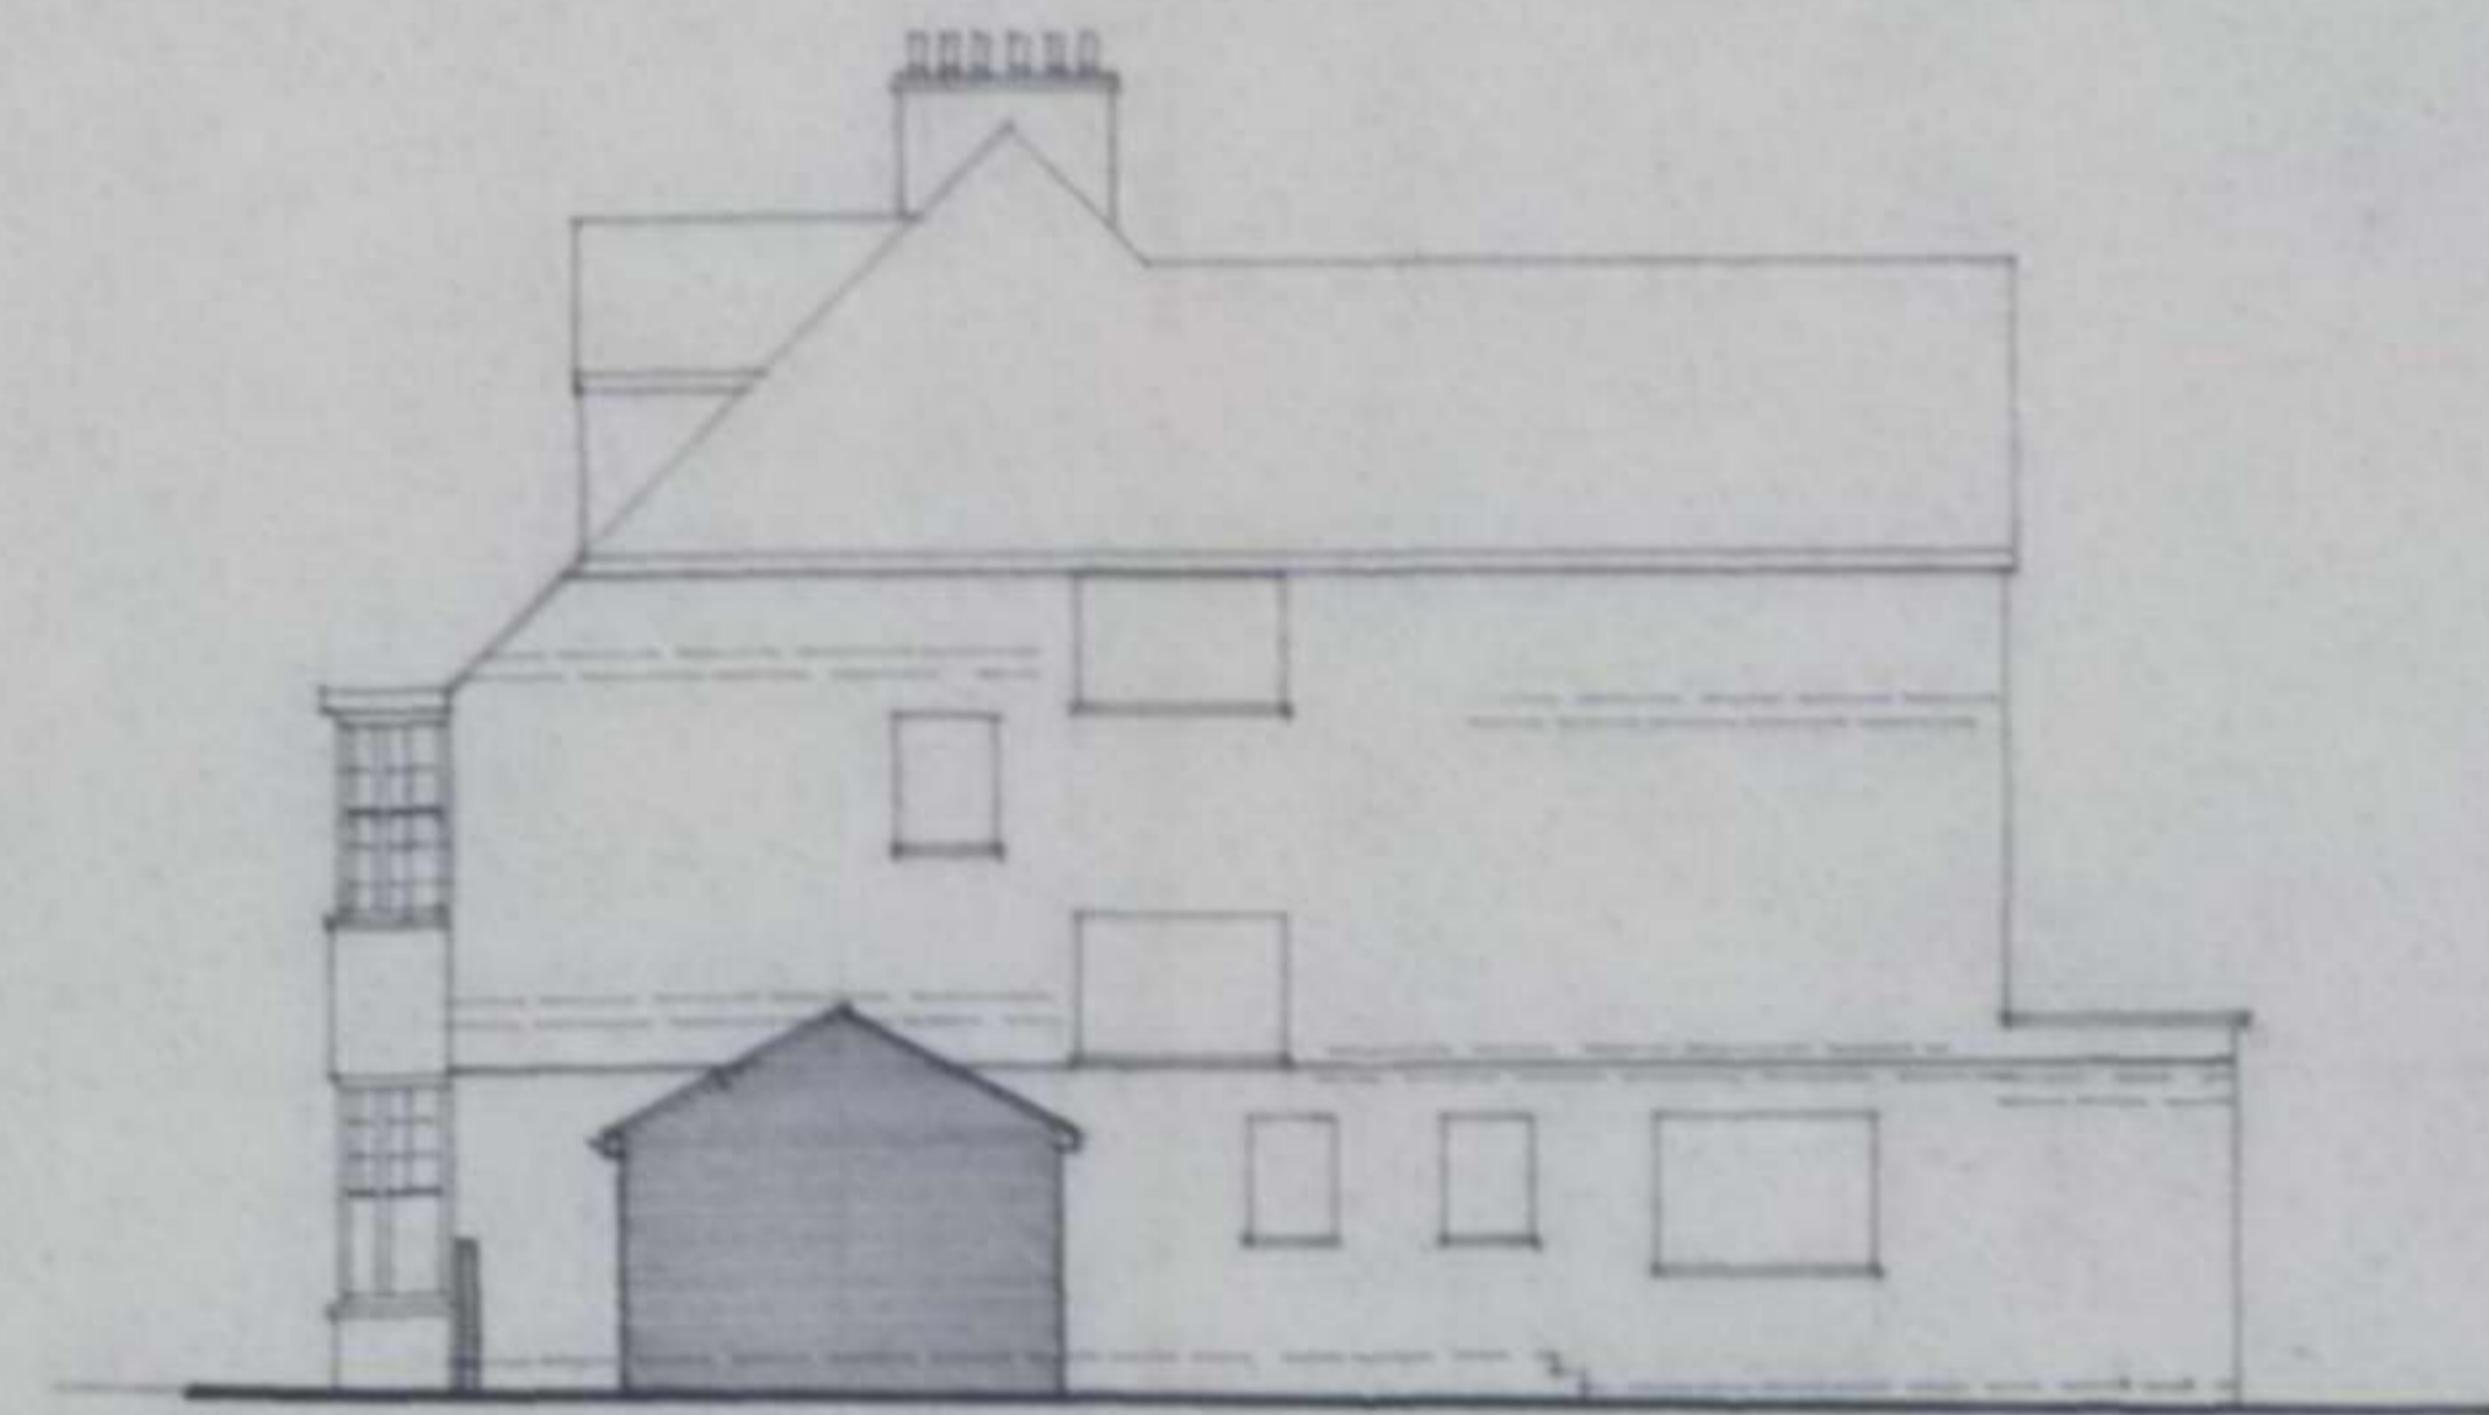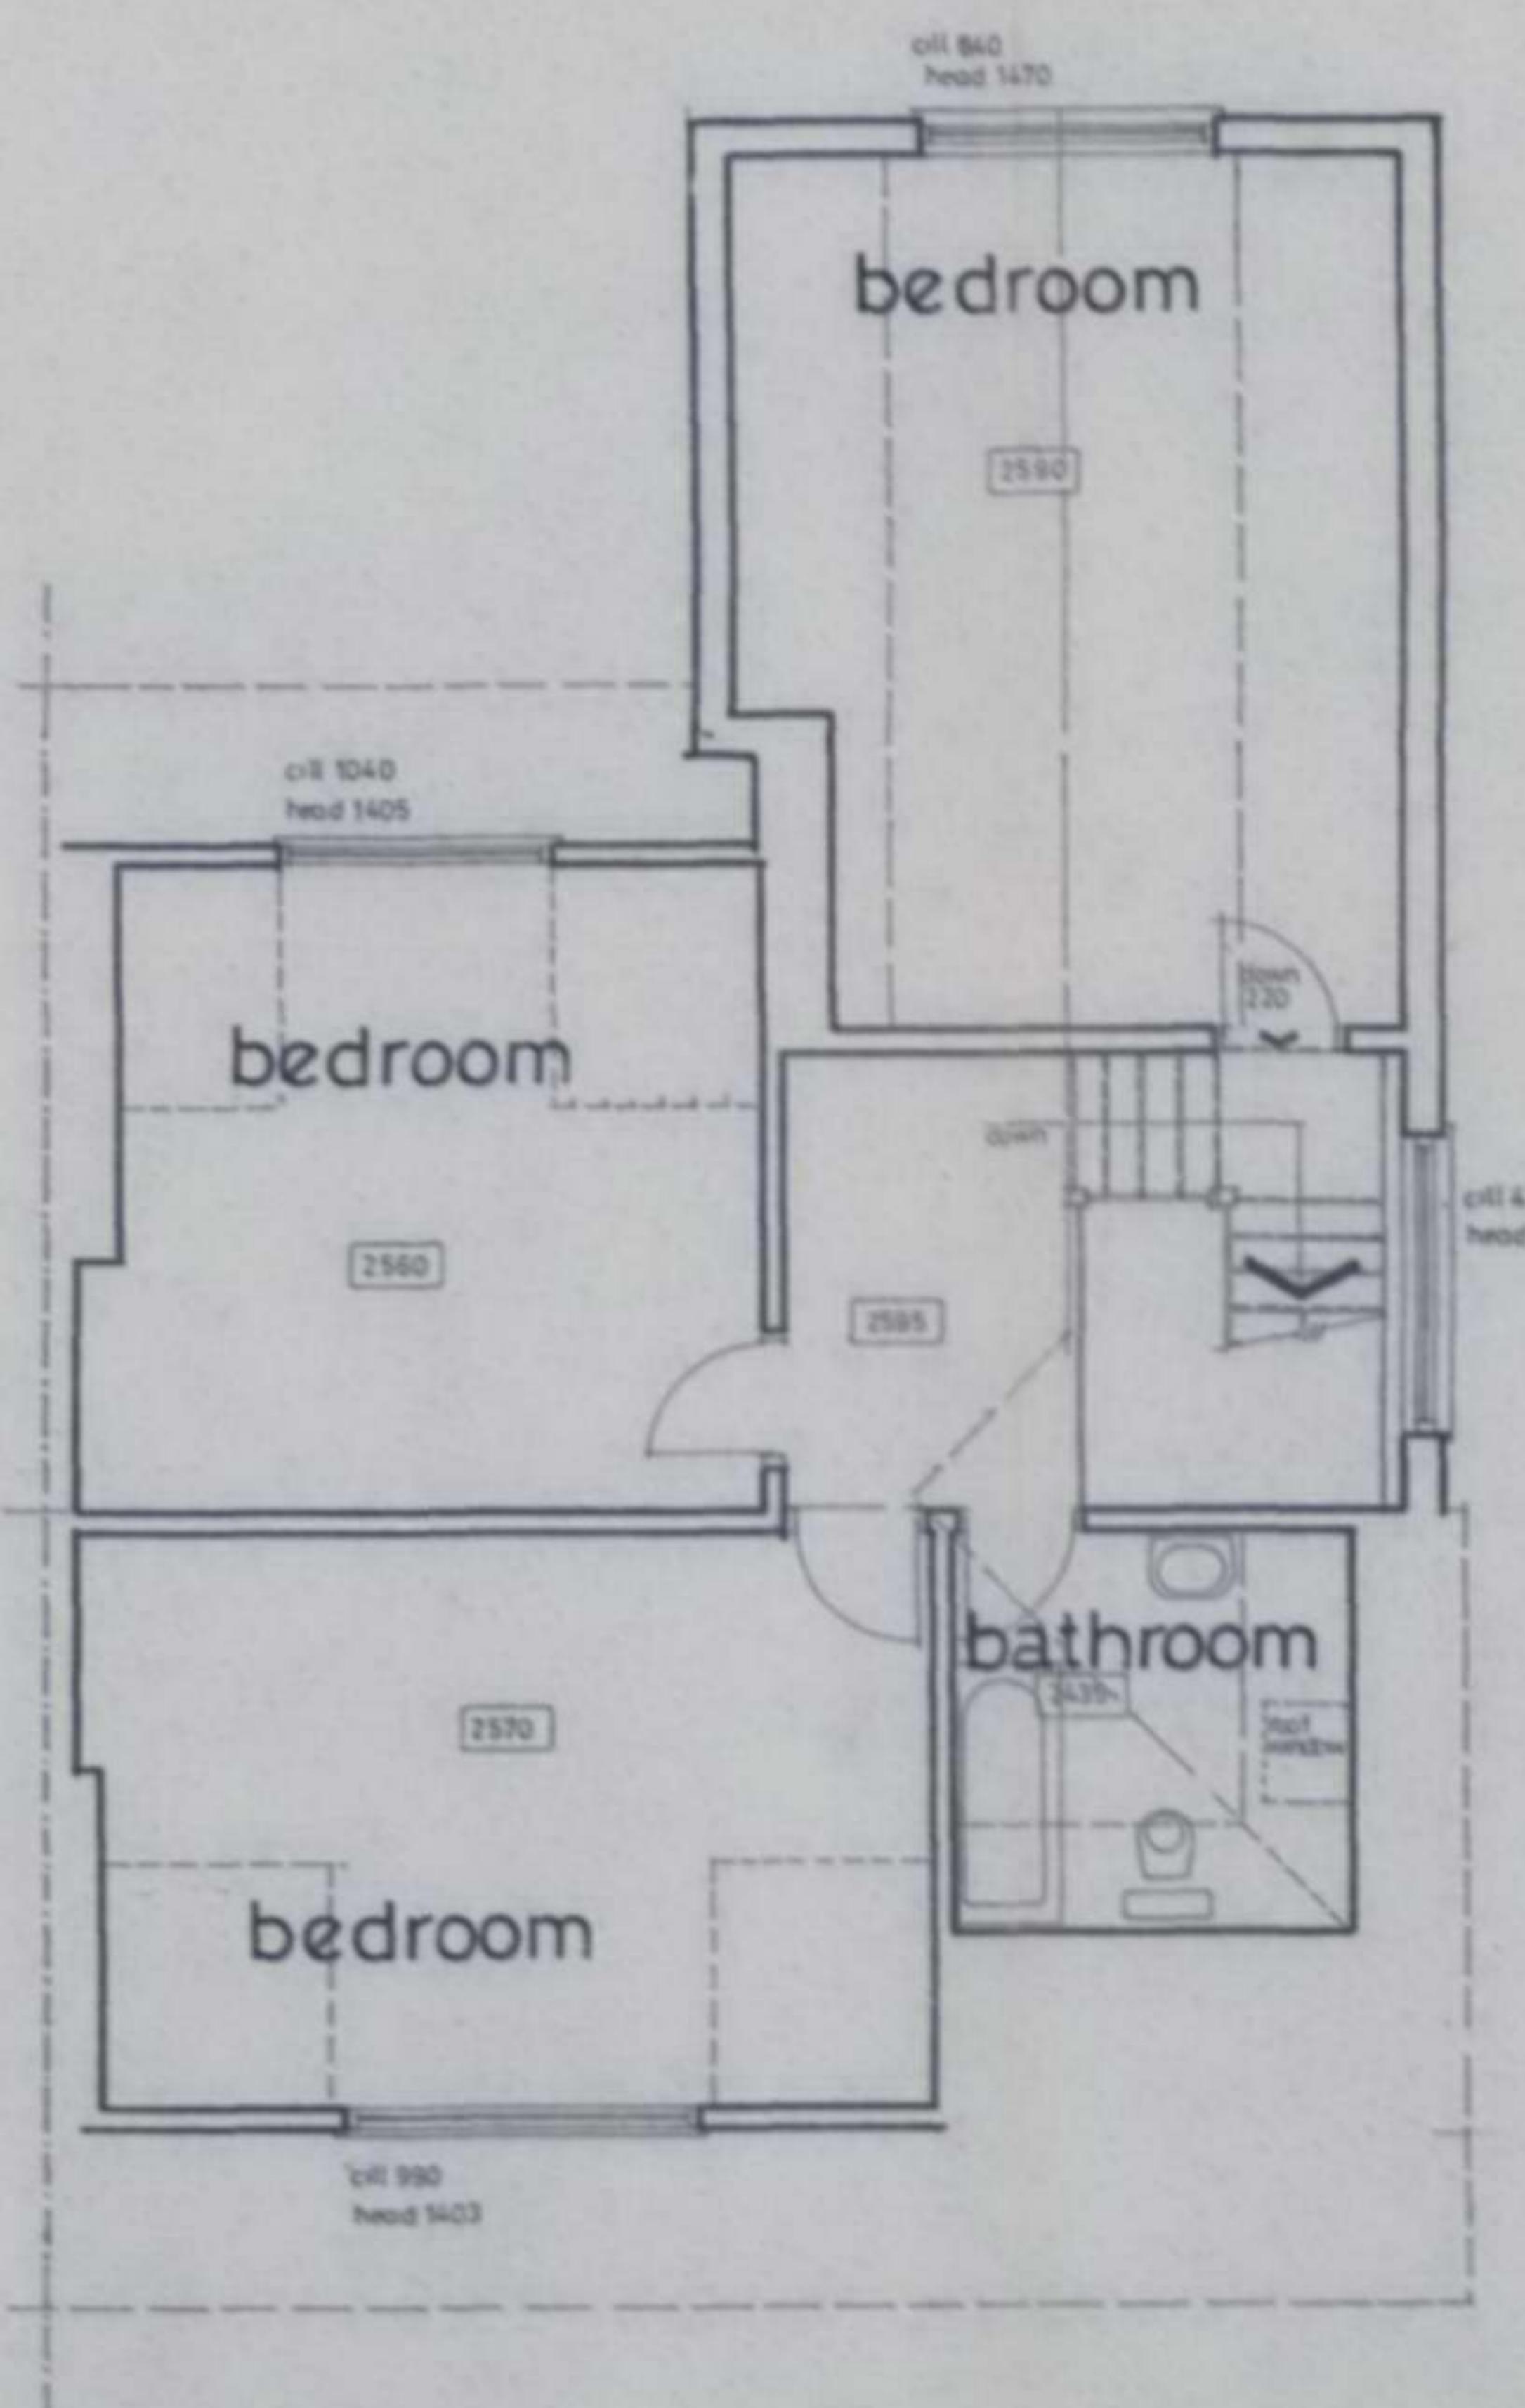

side elevation

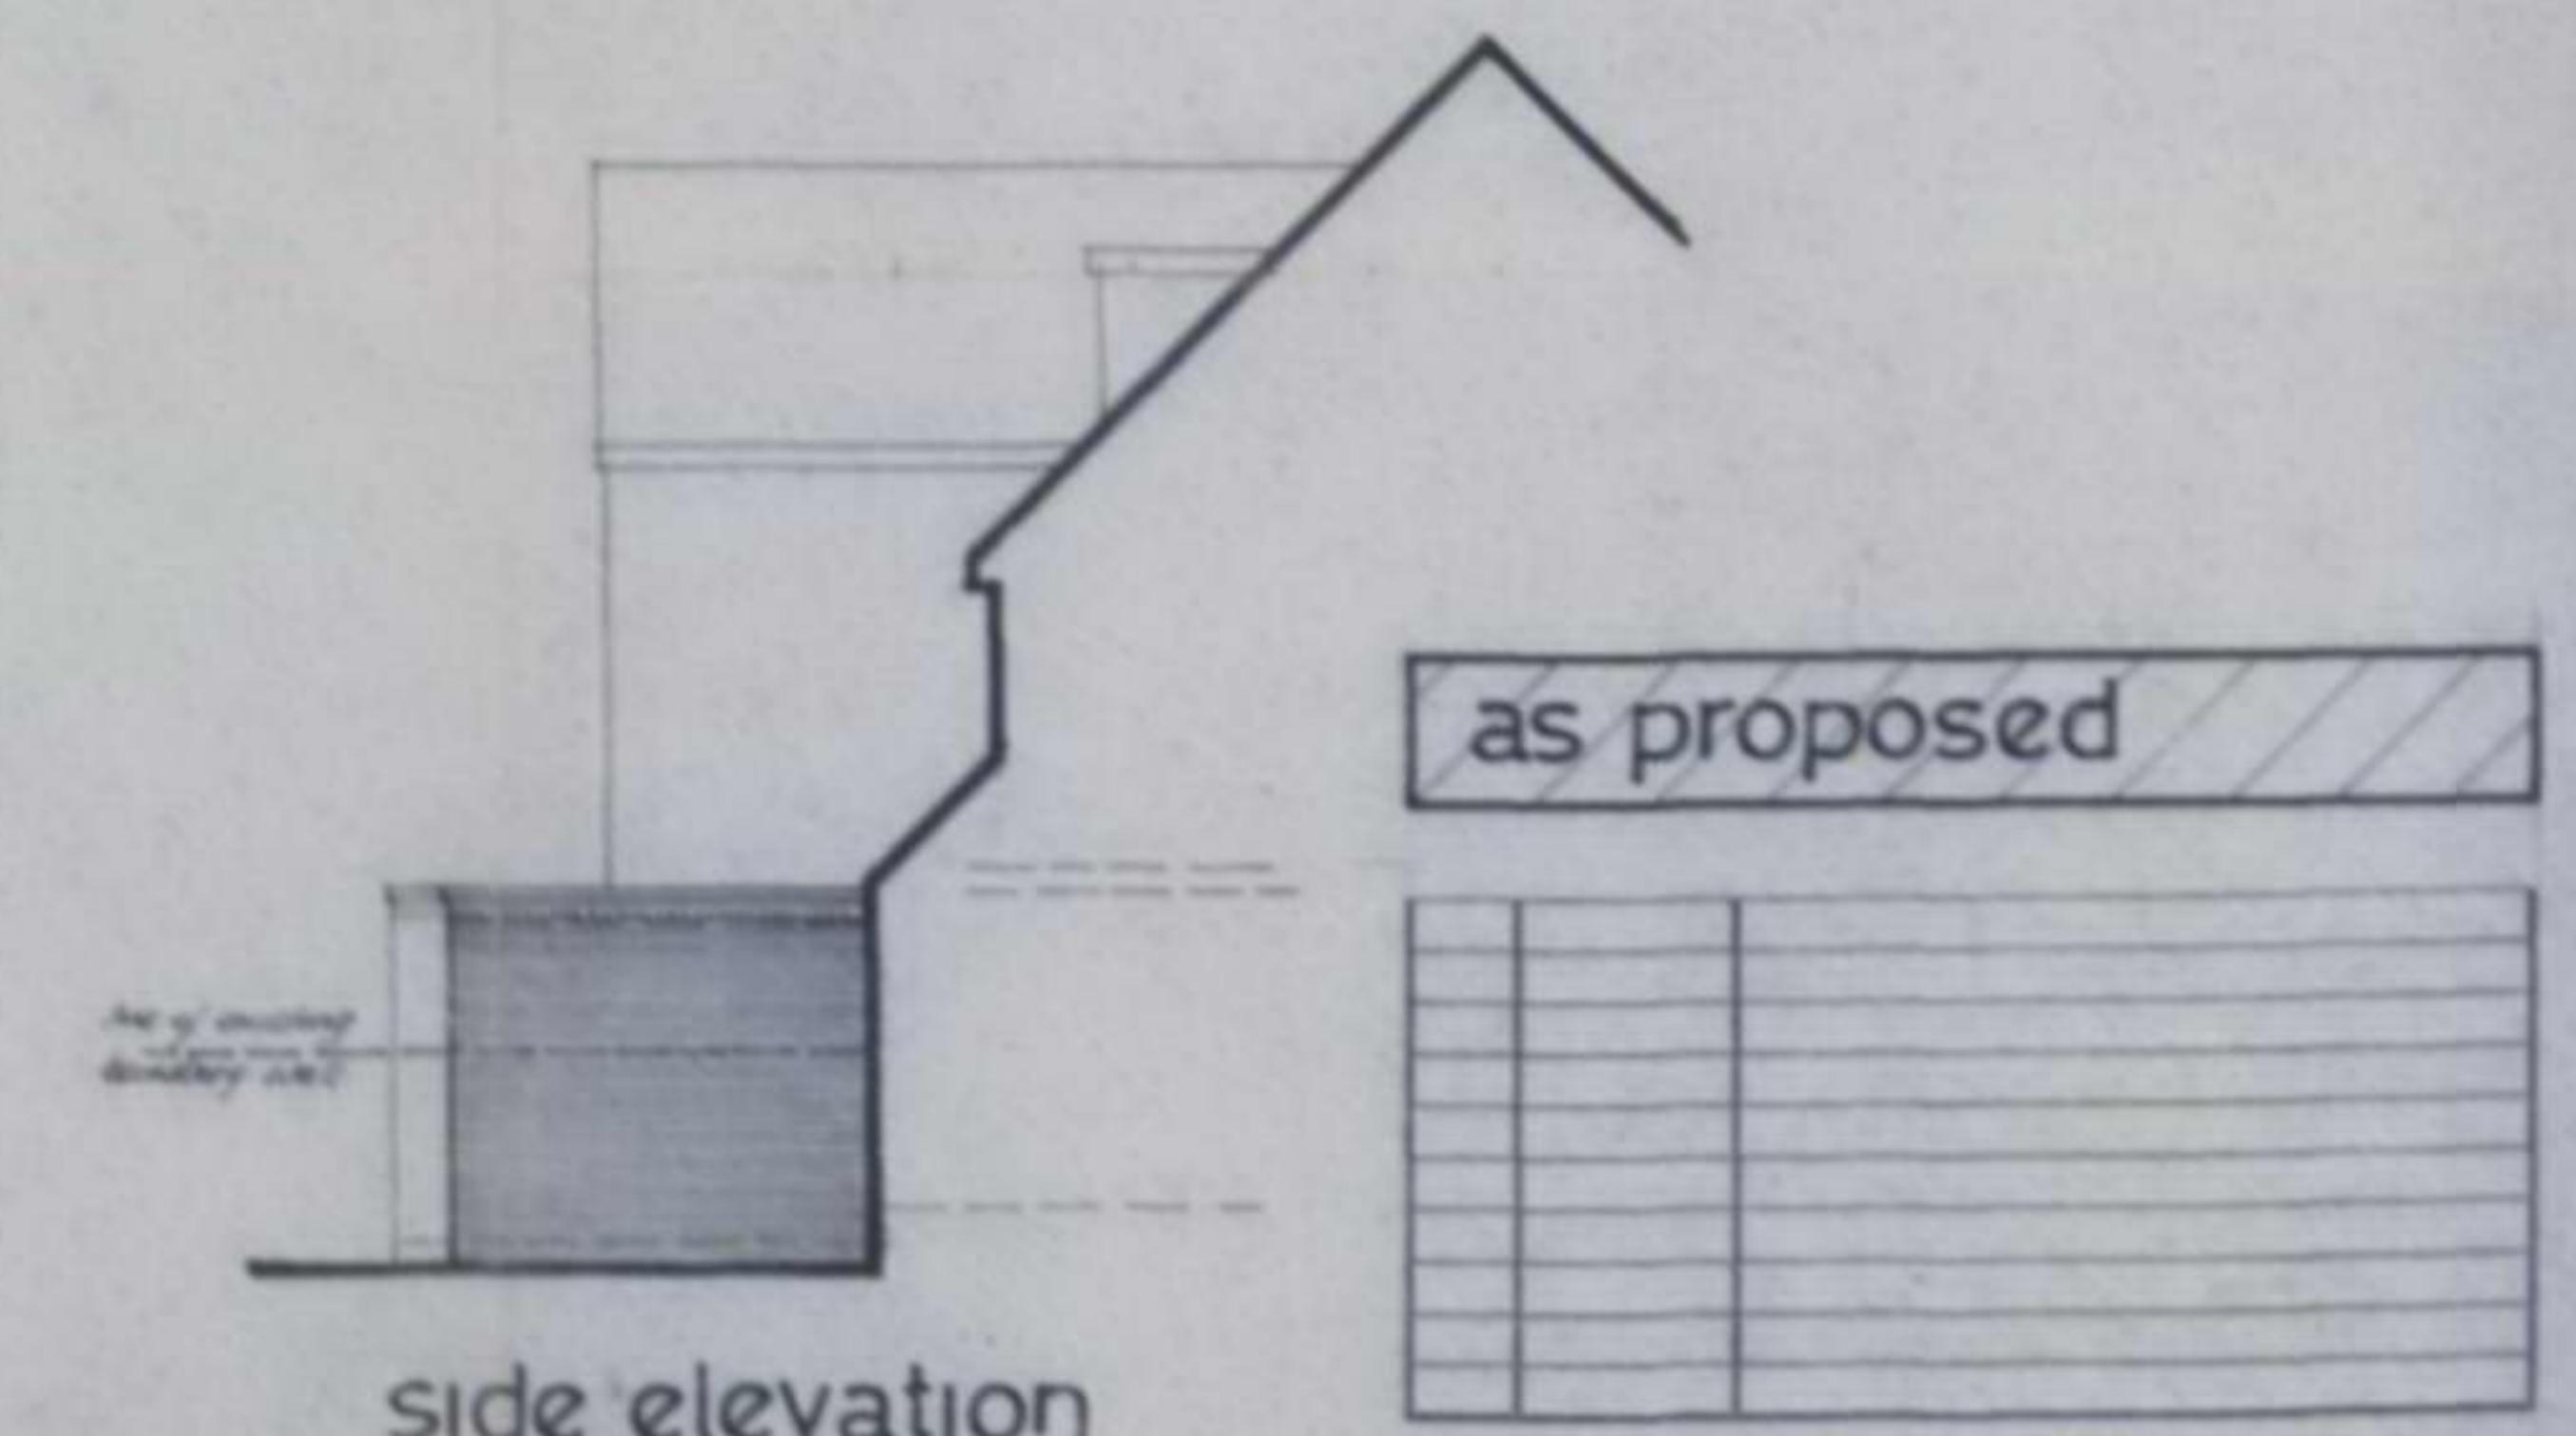

as proposed

Revisions

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Scale 1:50.
Date June 2006.
Drawn By AJ.Blyth.
DRAWING No PMB/06/137/4