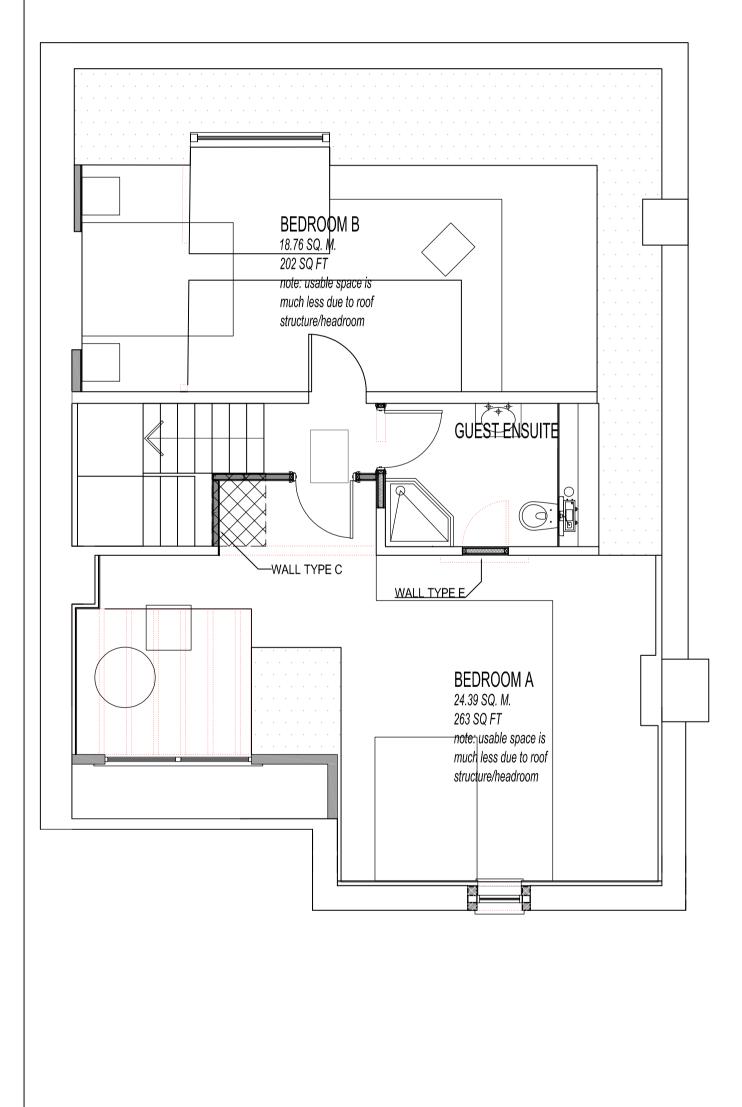
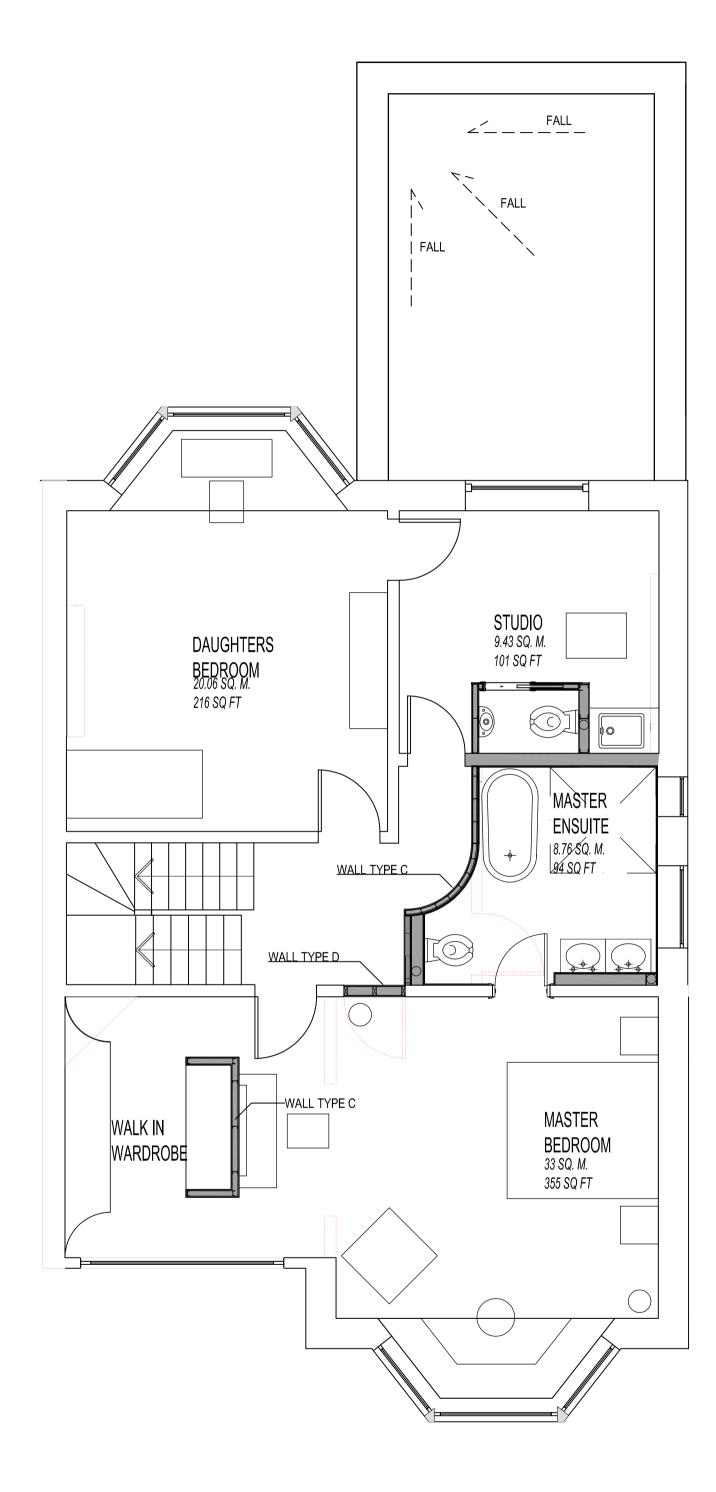



01 SCALE 1:50	GROUND FLOOR


All work is to be constructed in accordance with the relevant Building Regulations and to the satisfaction of the Building Inspector. All work is to comply with the relevant British Standards and codes of practice. Fire Alarm installed in accordance with current edition of BS 5839 Drainage work is to be in accordance with current edition of BS 8301. 1985 CP 301 and manufacturers instructions. Emergency lighting is to be installed in accordance with current edition of BS 5266 Pt 1 Signs and notices are to be installed in accordance with current edition of BS 5499 Pt 1 Foundations, structure and below slab drainage are to be detailed by structural engineer. Drawings and calculations are to be submitted to the Local Authority for approval. Walls to core areas are to provide one hour fire resistance to protected shafts (extent shown in hatched) and all services etc. passing through the walls or floors are to be adequately fire stopped. All structural steelwork is to be protected to one hour fire resistance (new and existing). All existing floor soffits are to be removed and new plaster board lining provided to provide one hour fire resistance. New constructions forming extension to rear of building are to achieve a minimum 'U' - values of 0.45W/m sq.K These include external walls, roofs, exposed and semi exposed walls. Surface spread of flame to circulation areas and protected is to be class 'O' wall and ceilings. All other areas are to be class '1' walls and ceilings. Dimensions are to be checked on site before fabrication and construction. Any discrepancies are to be notified to the designers. Structural measurements are to be taken from the structural engineers drawings. Do not scale.					
Copyright re	eserved by Paul I	Daly Design Stuc	io.		
DEV	DATE	BY	СОММЕ		
REV.	DATE	ВТ	COMME		
PRO	JECT:	41 CR	EDTION	HILL, NW6 1HS.	
CLIENT: MR & MRS SRIVASTAVA				IVASTAVA	
DRAWING TITLE:		EXISTING FLOOR PLANS Ground, first and second floors.			
DRAWING		0809/100 DATE:			
NO. SCALE:		1:50 @) A1	17/03/2009	
SCALE:		1:50 @ A1 TENDER			
AUTHOR:					
Paul Daly Design Studio Unit 7 11 Hoxton Square London N1 6NU					
Tel +44 (0) 207 613 4855 Fax +44 (0) 207 613 5848 email studio@pauldaly.com www.pauldaly.com					





03 SCALE 1:50	SECOND FLOOR	02 SCALE 1:50	FIRST FLOOR

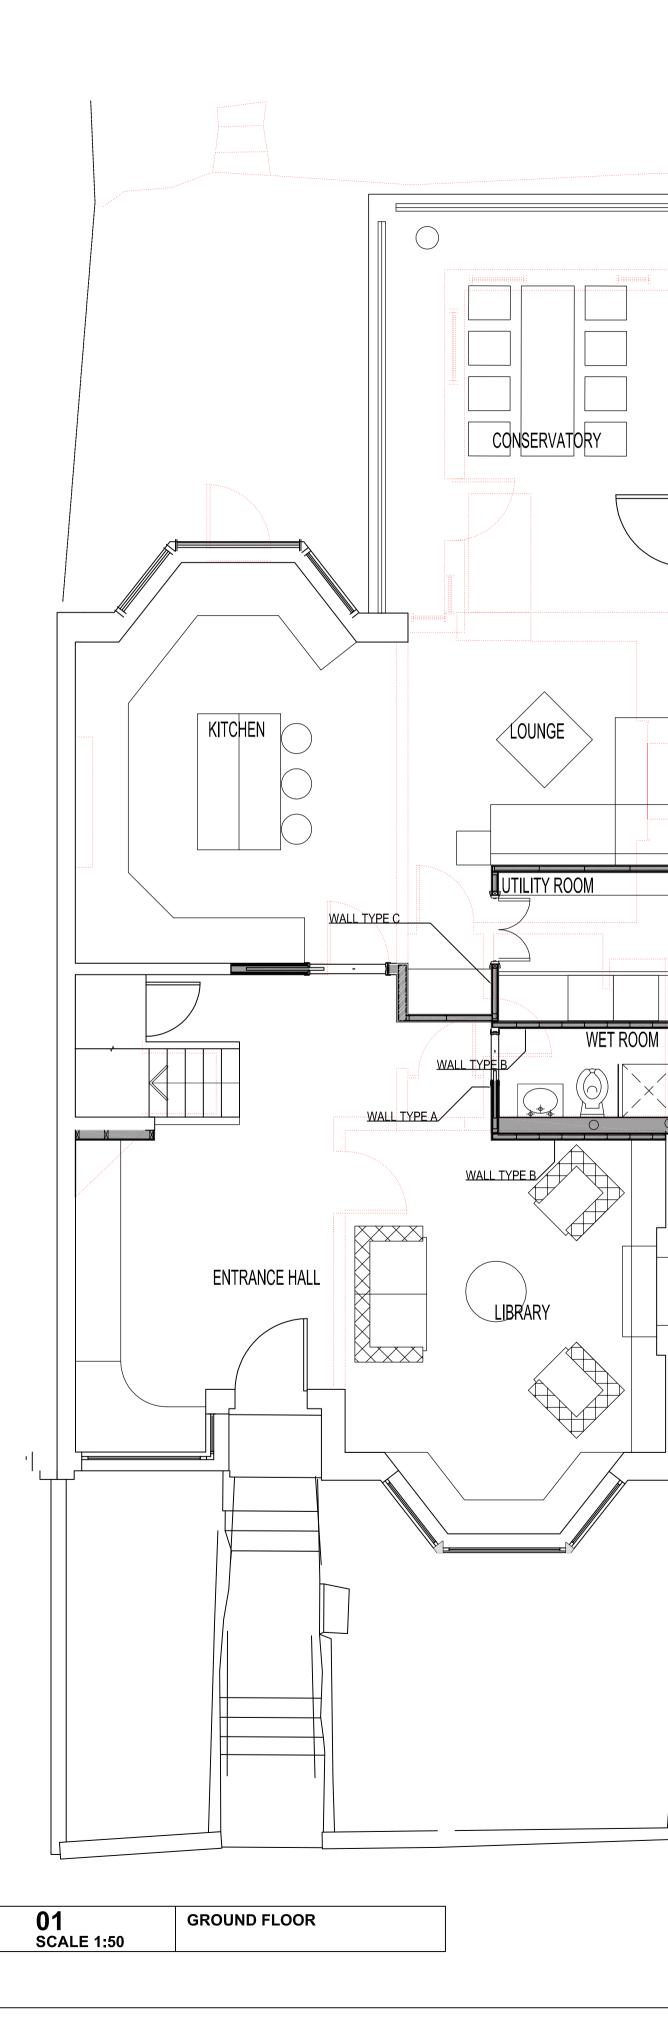

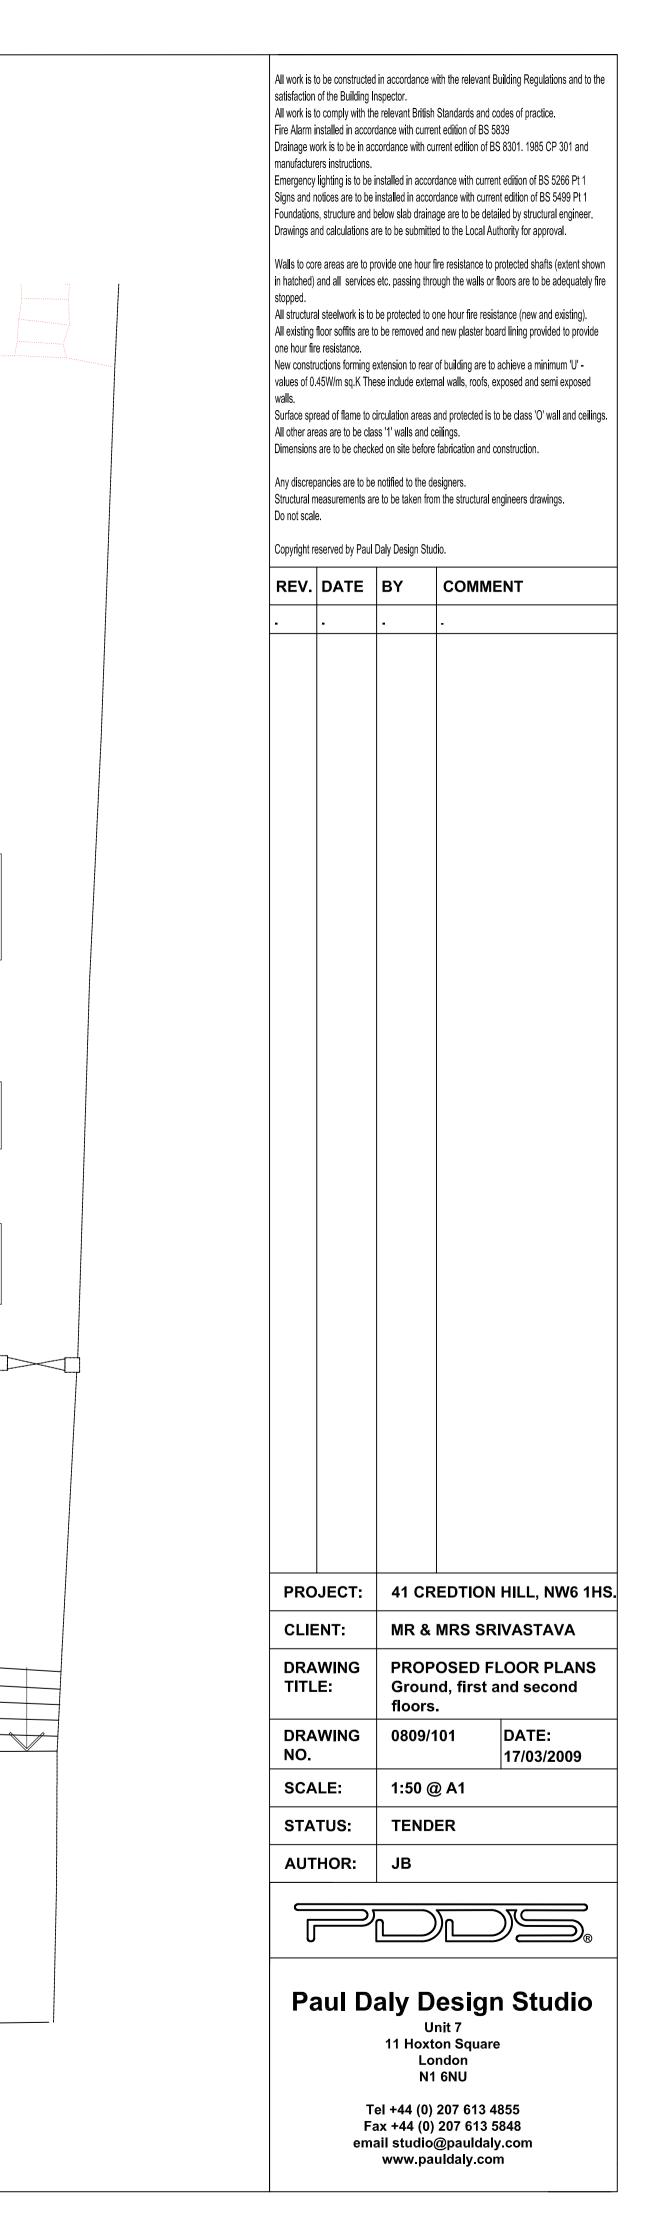


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	Drainage w manufactur Emergency	ork is to be in a ers instructions. lighting is to be	ccordance with o	rent edition of BS 5839 current edition of BS 8301. 1985 CP 301 and ordance with current edition of BS 5266 Pt 1			
	Foundation	s, structure and	below slab drair	ordance with current edition of BS 5499 Pt 1 nage are to be detailed by structural engineer. ted to the Local Authority for approval.			
	Walls to co	Drawings and calculations are to be submitted to the Local Authority for approval. Walls to core areas are to provide one hour fire resistance to protected shafts (extent shown in hatched) and all services etc. passing through the walls or floors are to be adequately fire					
	All structural steelwork is to be protected to one hour fire resistance (new and existing). All existing floor soffits are to be removed and new plaster board lining provided to provide						
	one hour fire resistance. New constructions forming extension to rear of building are to achieve a minimum 'U' - values of 0.45W/m sq.K These include external walls, roofs, exposed and semi exposed						
	walls. Surface spread of flame to circulation areas and protected is to be class 'O' wall and ceilings. All other areas are to be class '1' walls and ceilings.						
	Any discrep	pancies are to b	e notified to the	re fabrication and construction. designers. om the structural engineers drawings.			
	Do not scal	е.	Daly Design St				
	REV. DATE		BY	COMMENT			
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	PRO	JECT:	41 CF	REDTION HILL, NW6 1HS.			
	CLIENT:			MRS SRIVASTAVA			
	DRA	DRAWING		EXISTING EXTERNAL ELEVATIONS.			
	DRAWING NO.		0809/				
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Structural measurements are to be taken from the structural engineers drawings. Do not scale.
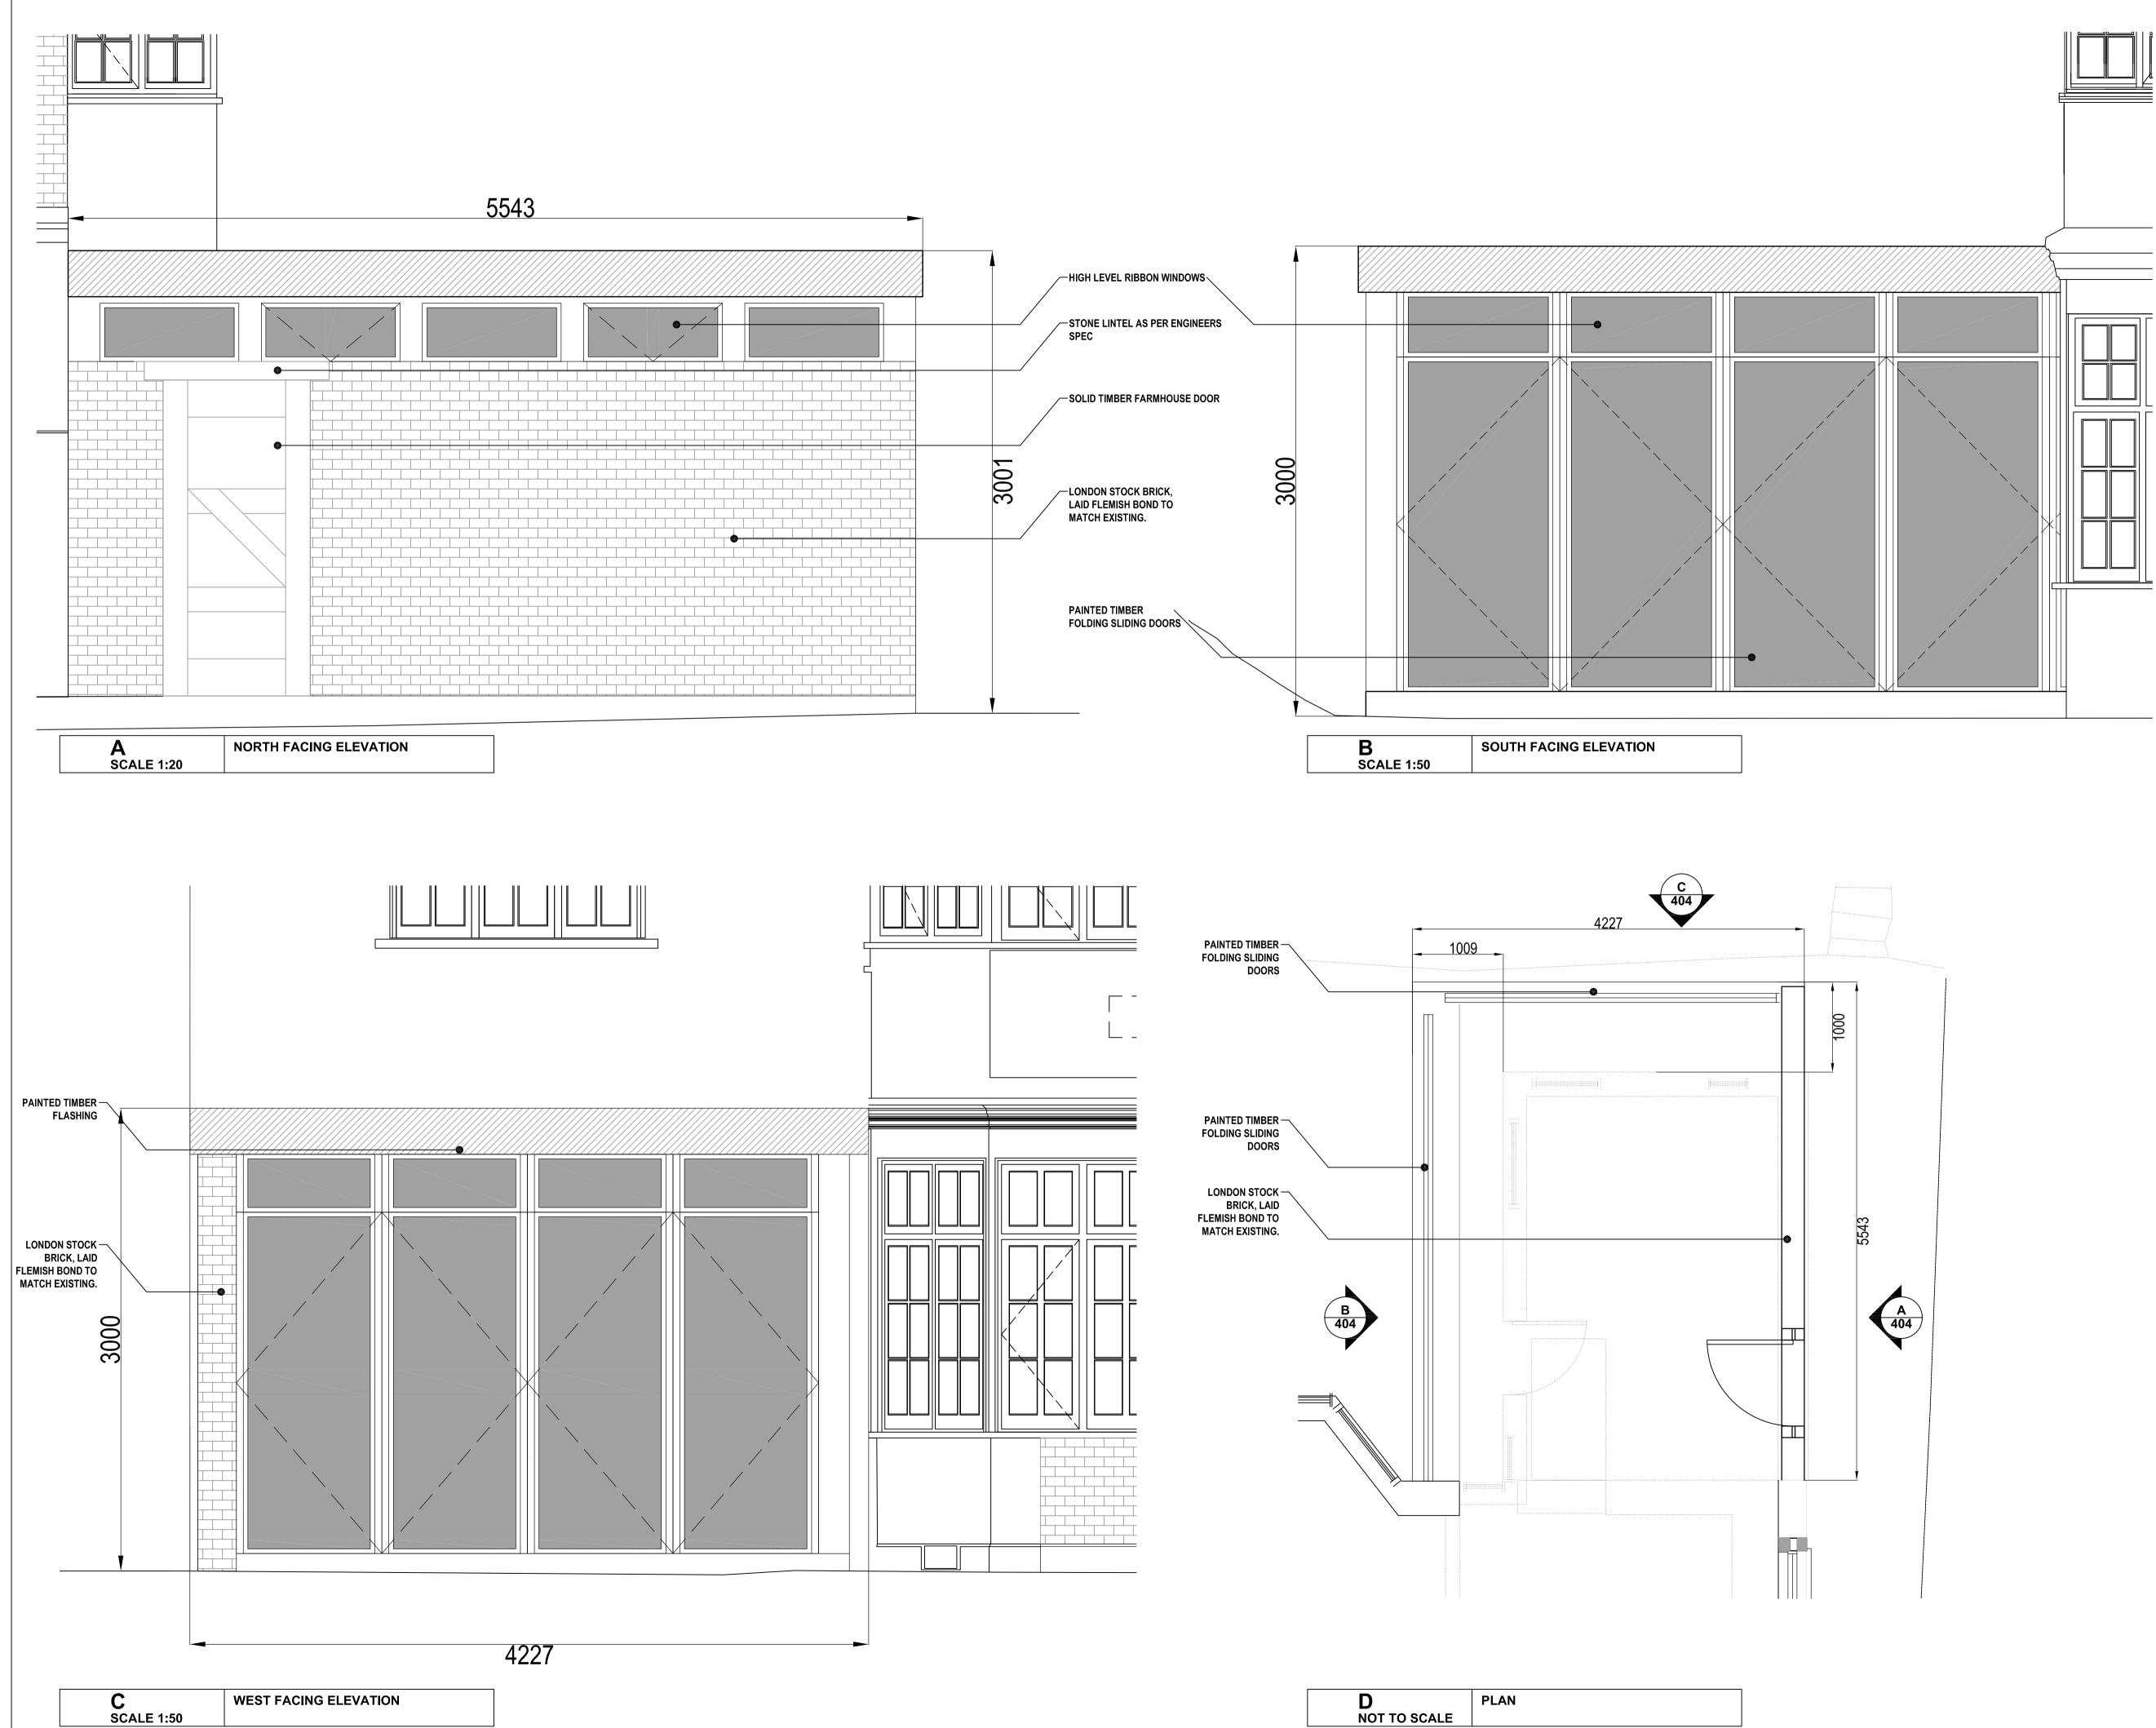
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REV.	REV. DATE BY		COMMENT		
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		44.00			
	PROJECT:		41 CREDTION HILL, NW6 1HS		
			MR & MRS SRIVASTAVA PROPOSED EXTENSION ELEVATIONS		
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DRA NO.			104	DATE: 17/03/2009	
	SCALE: STATUS: AUTHOR:		1:20 @ A1 TENDER JB		
STA					
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Pa	aul Da	alv D	esian	Studio	
	Paul Daly Design Studio Unit 7 11 Hoxton Square London N1 6NU				
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	email studio@pauldaly.com www.pauldaly.com				