






REV.	DATE	BY	COMMENT

AUTHOR: EDL SURVEYS



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All work is to be constructed in accordance with the relevant Building Regulations and to the satisfaction of the Building Inspector.
All work is to comply with the relevant British Standards and codes of practice.
Fire Alarm installed in accordance with current edition of BS 5839
Drainage work is to be in accordance with current edition of BS 8301, 1985 CP 301 and manufacturers instructions.
Emergency lighting is to be installed in accordance with current edition of BS 5266 Pt 1
Signs and notices are to be installed in accordance with current edition of BS 5499 Pt 1
Foundations, structure and below slab drainage are to be detailed by structural engineer.
Drawings and calculations are to be submitted to the Local Authority for approval.

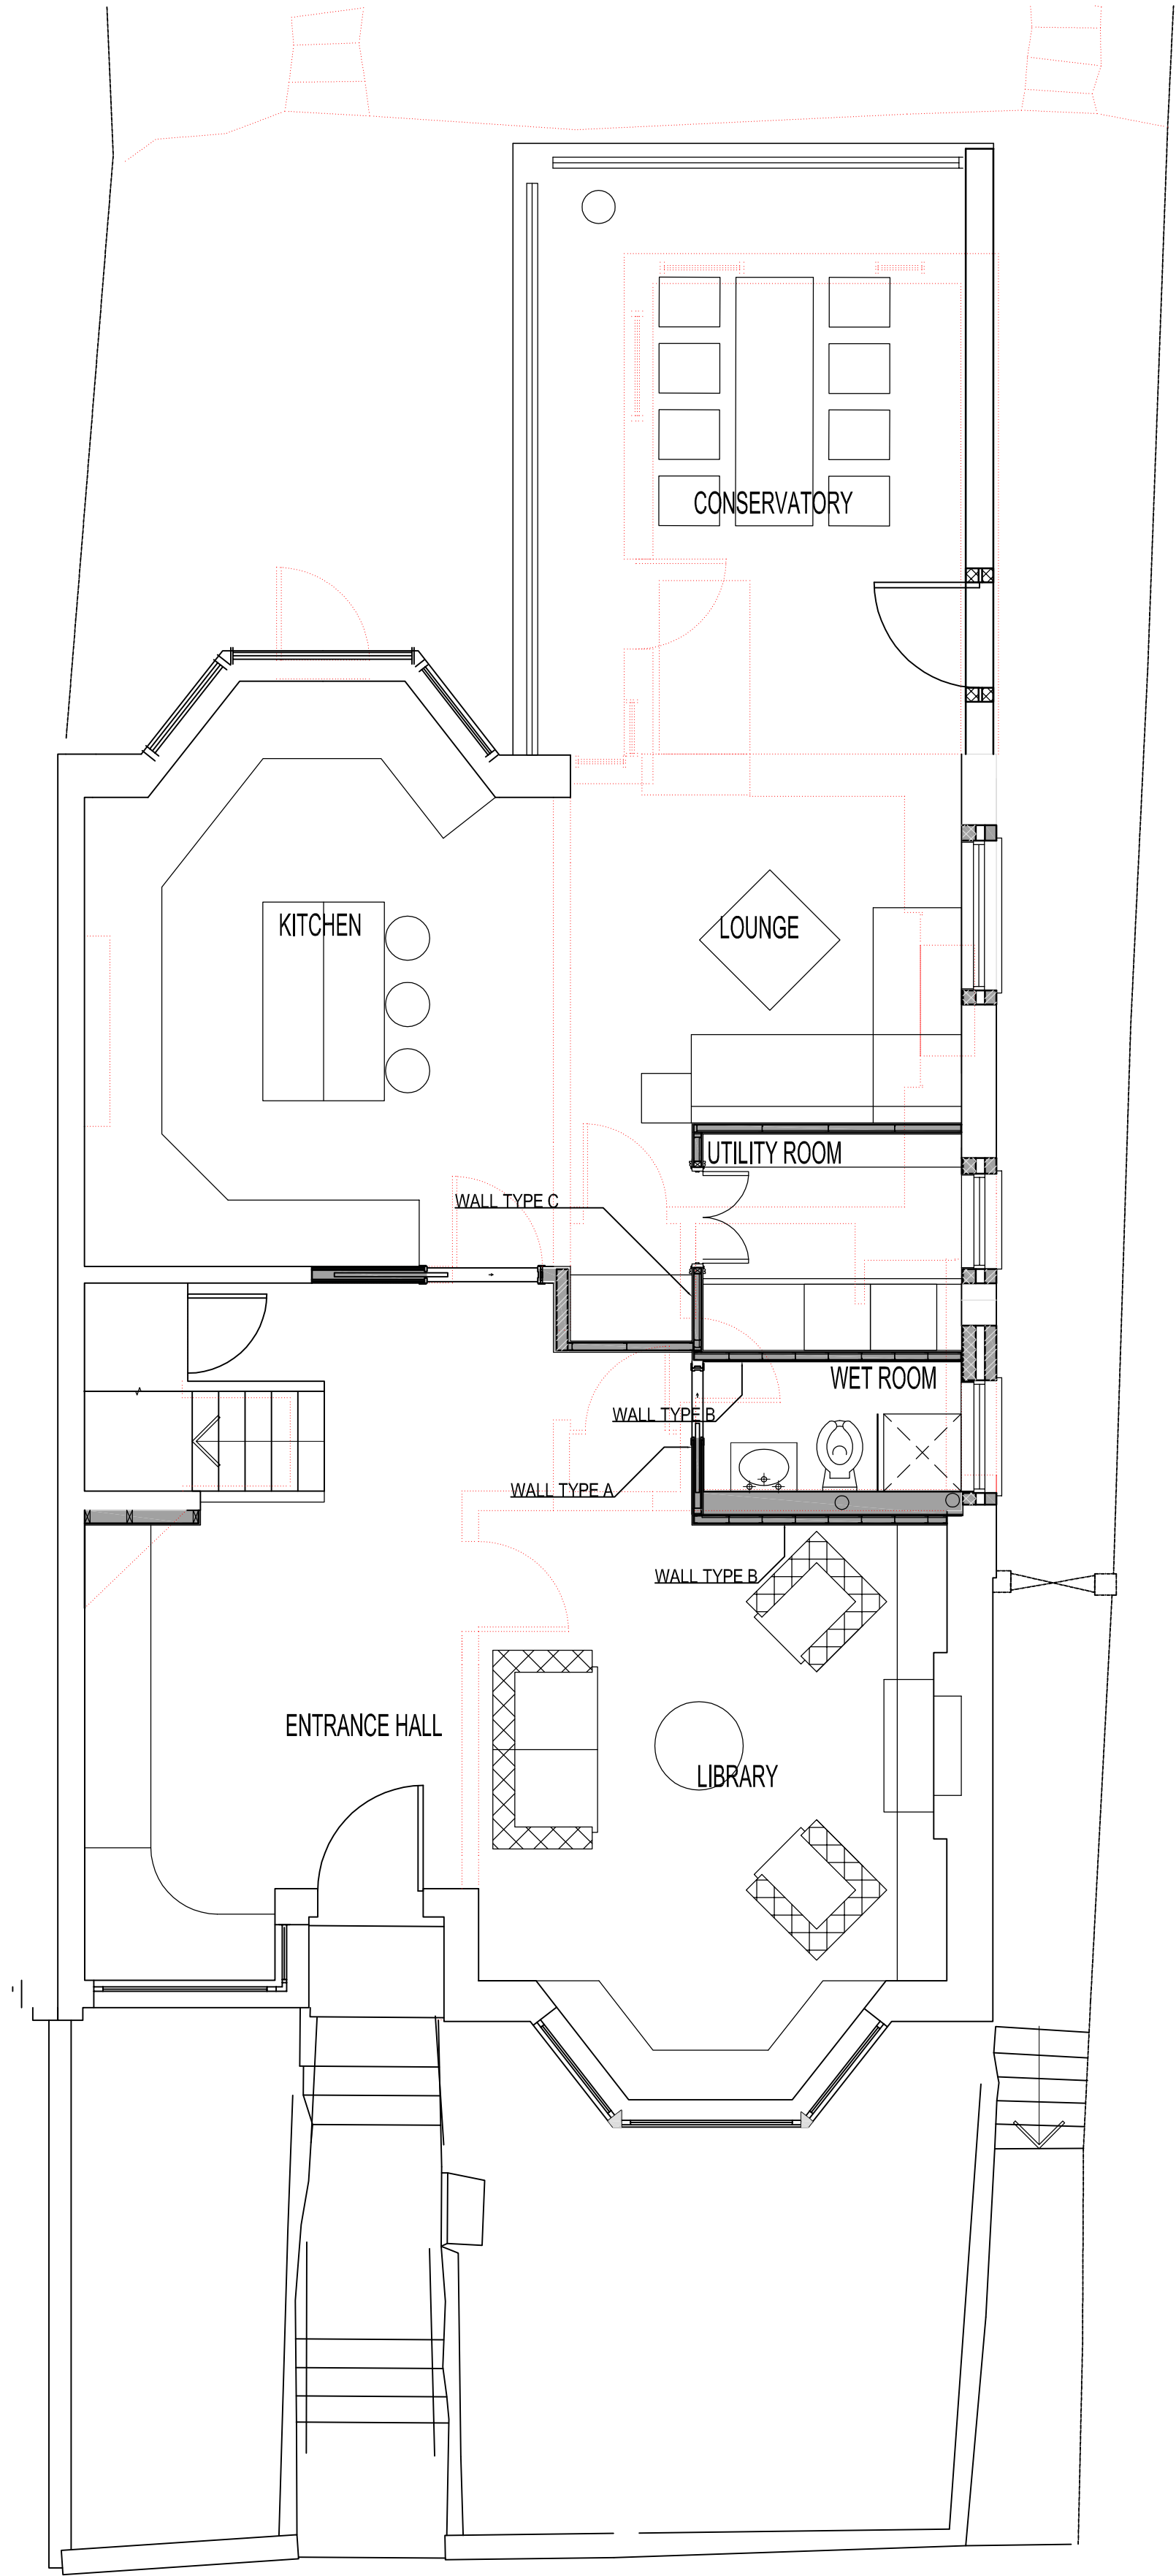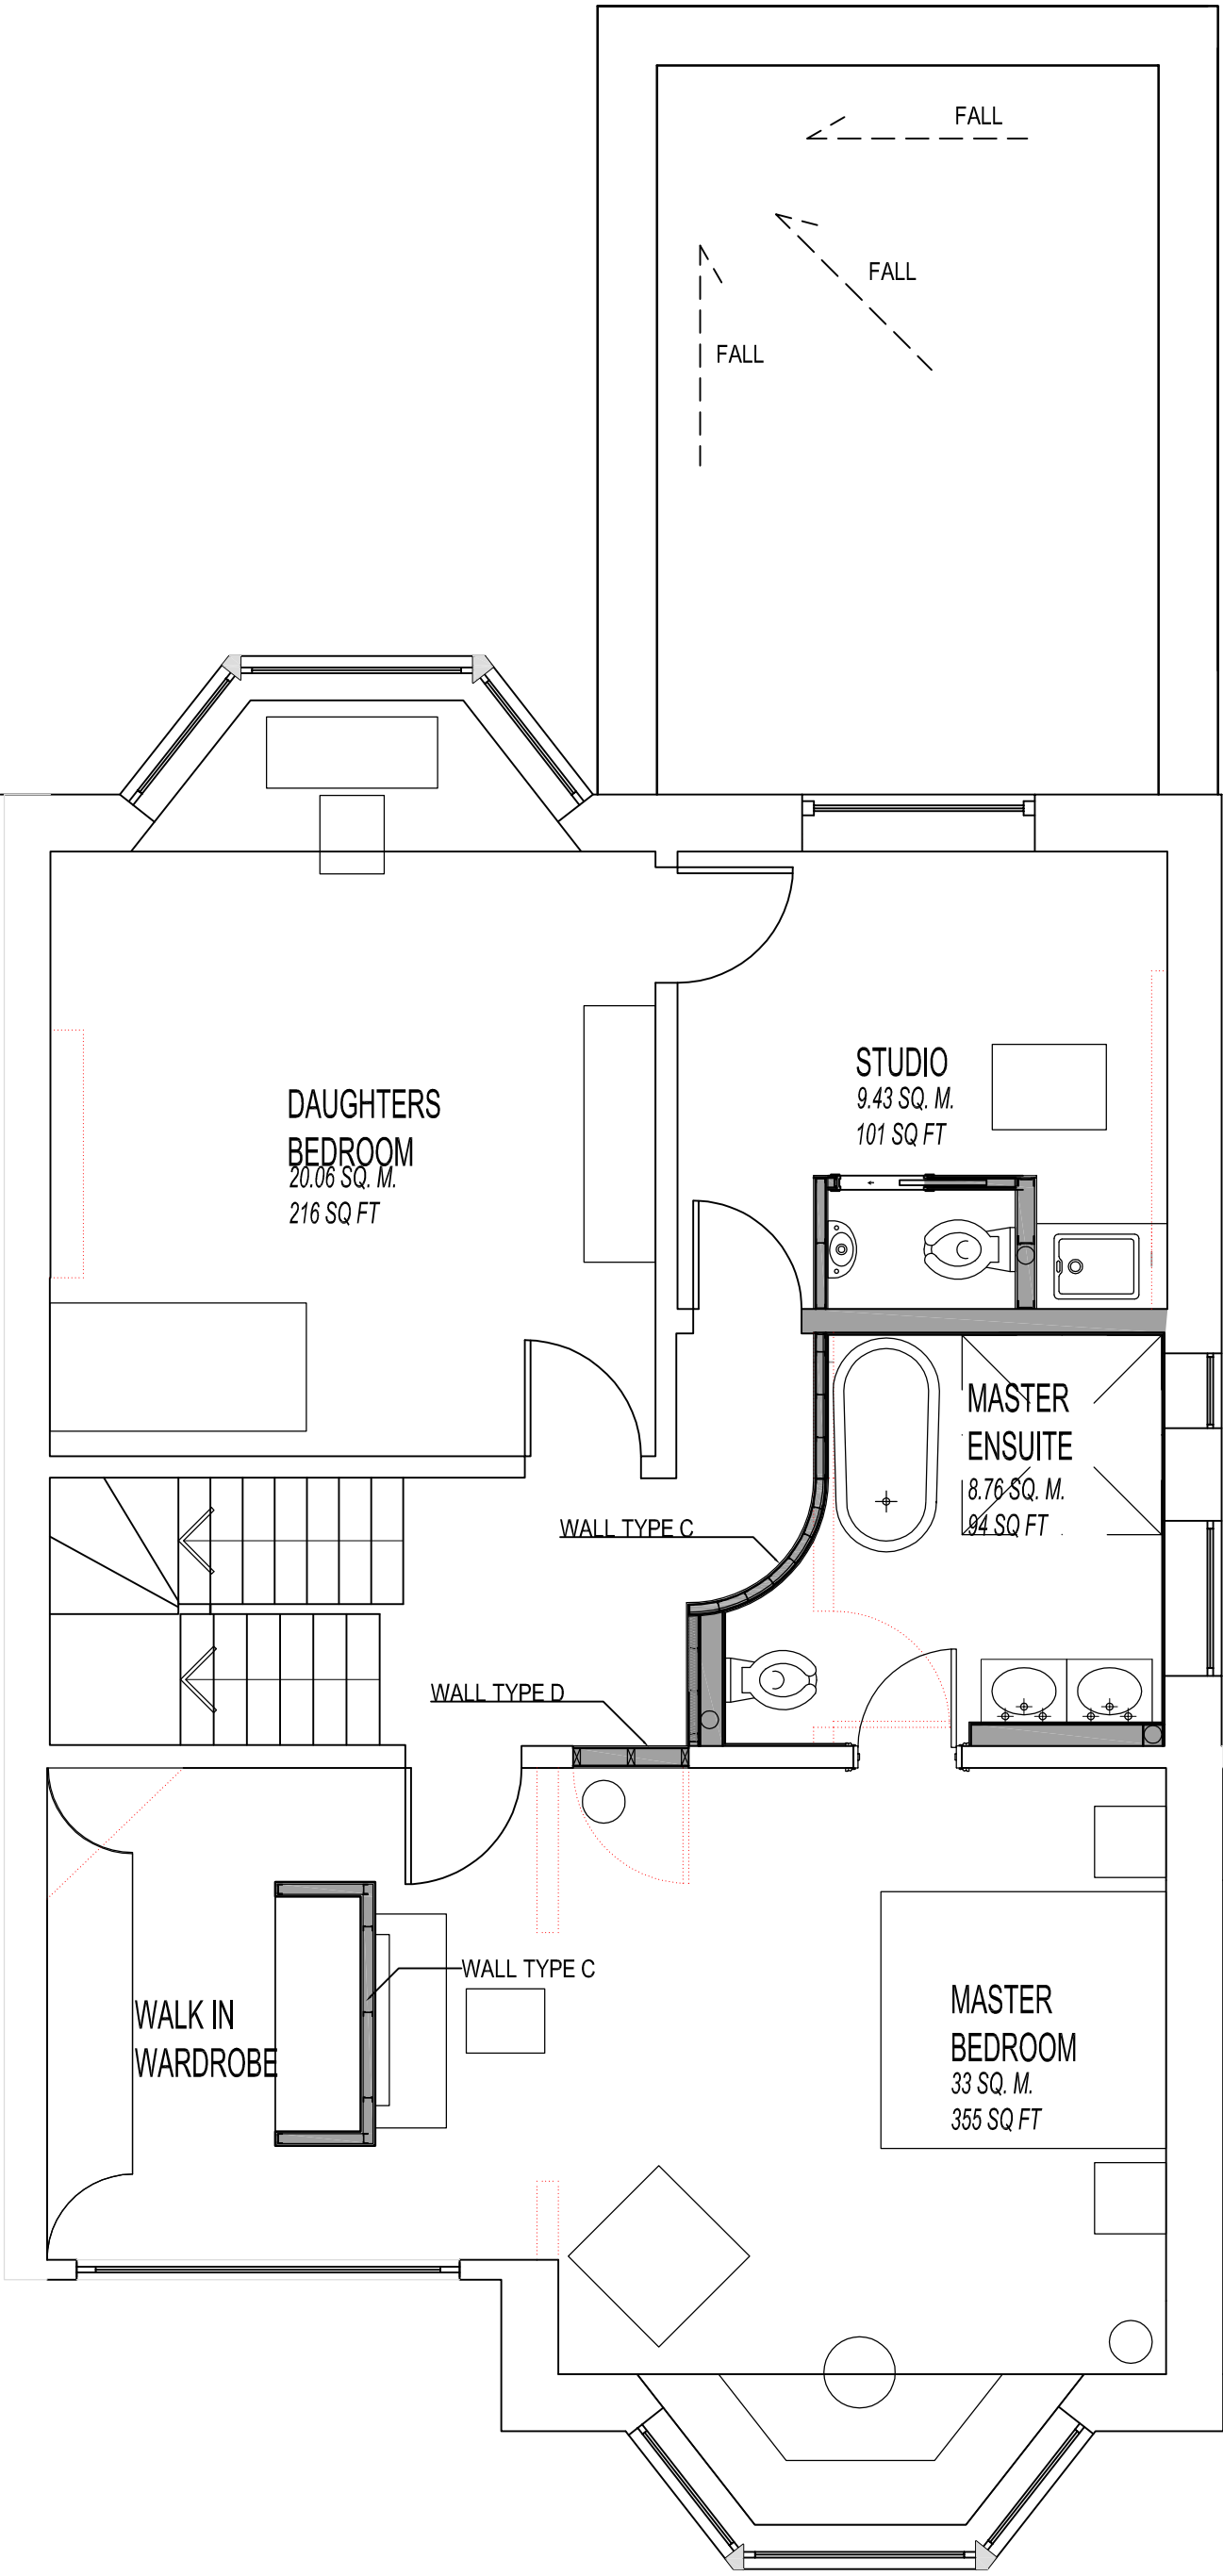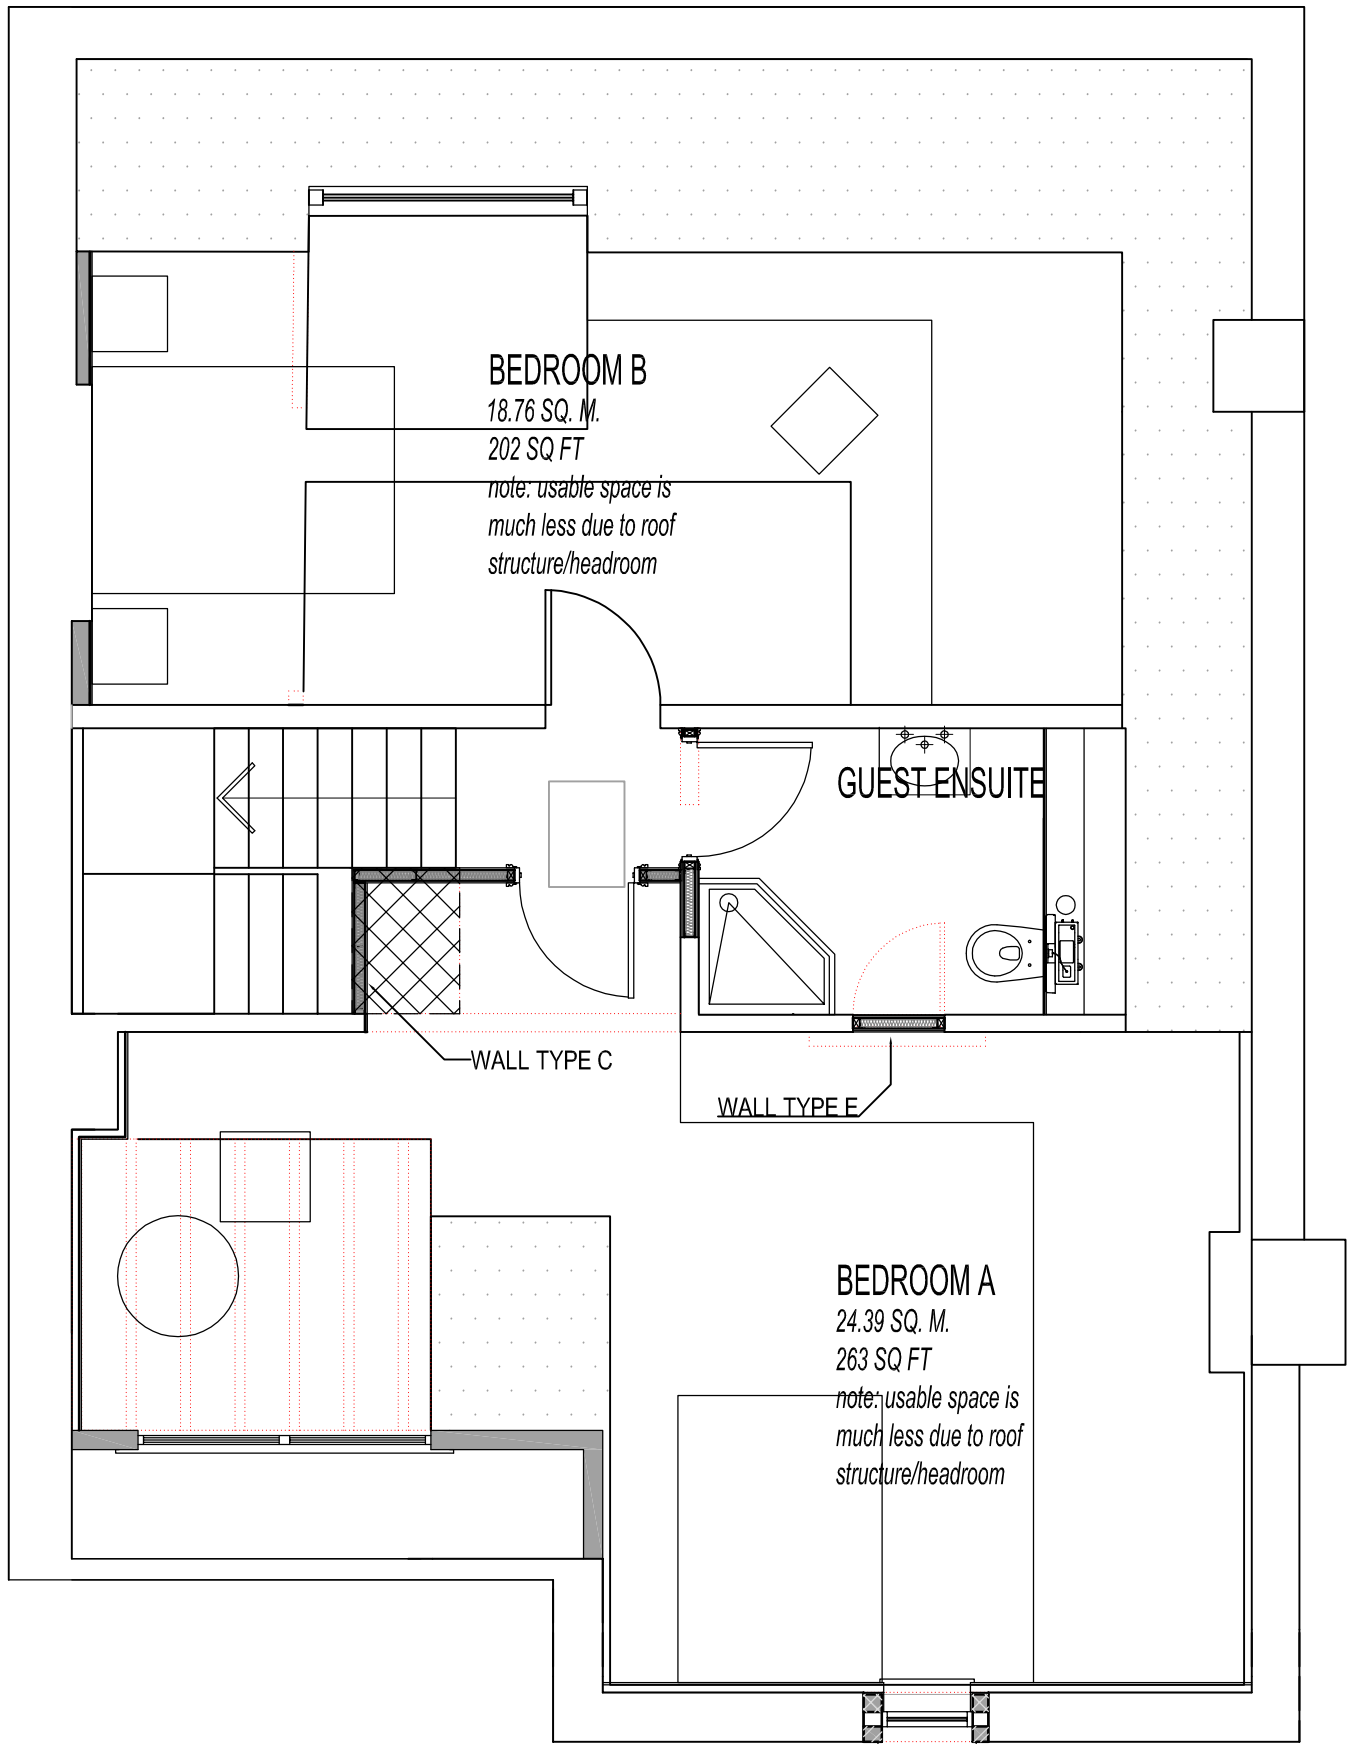Walls to core areas are to provide one hour fire resistance to protected shafts (extent shown in hatched) and all services etc, passing through the walls or floors are to be adequately fire stopped.
All structural steelwork is to be protected to one hour fire resistance (new and existing).
All existing floor soffits are to be removed and new plaster board lining provided to provide one hour fire resistance.
New constructions forming extension to rear of building are to achieve a minimum 'U' - values of 0.45W/m sq.K These include external walls, roofs, exposed and semi exposed walls.
Surface spread of flame to circulation areas and protected is to be class '0' wall and ceilings.
All other areas are to be class '1' walls and ceilings.
Dimensions are to be checked on site before fabrication and construction.

Any discrepancies are to be notified to the designers.
Structural measurements are to be taken from the structural engineers drawings.
Do not scale.

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REV.	DATE	BY	COMMENT
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PROJECT:	41 CREDTION HILL, NW6 1HS.		
CLIENT:	MR & MRS SRIVASTAVA		
DRAWING TITLE:	PROPOSED FLOOR PLANS Ground, first and second floors.		
DRAWING NO.	0809/101	DATE:	17/03/2009
SCALE:	1:50 @ A1		
STATUS:	TENDER		
AUTHOR:	JB		


PDDS

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03
SCALE 1:50
SECOND FLOOR


02
SCALE 1:50
FIRST FLOOR

01
SCALE 1:50
GROUND FLOOR

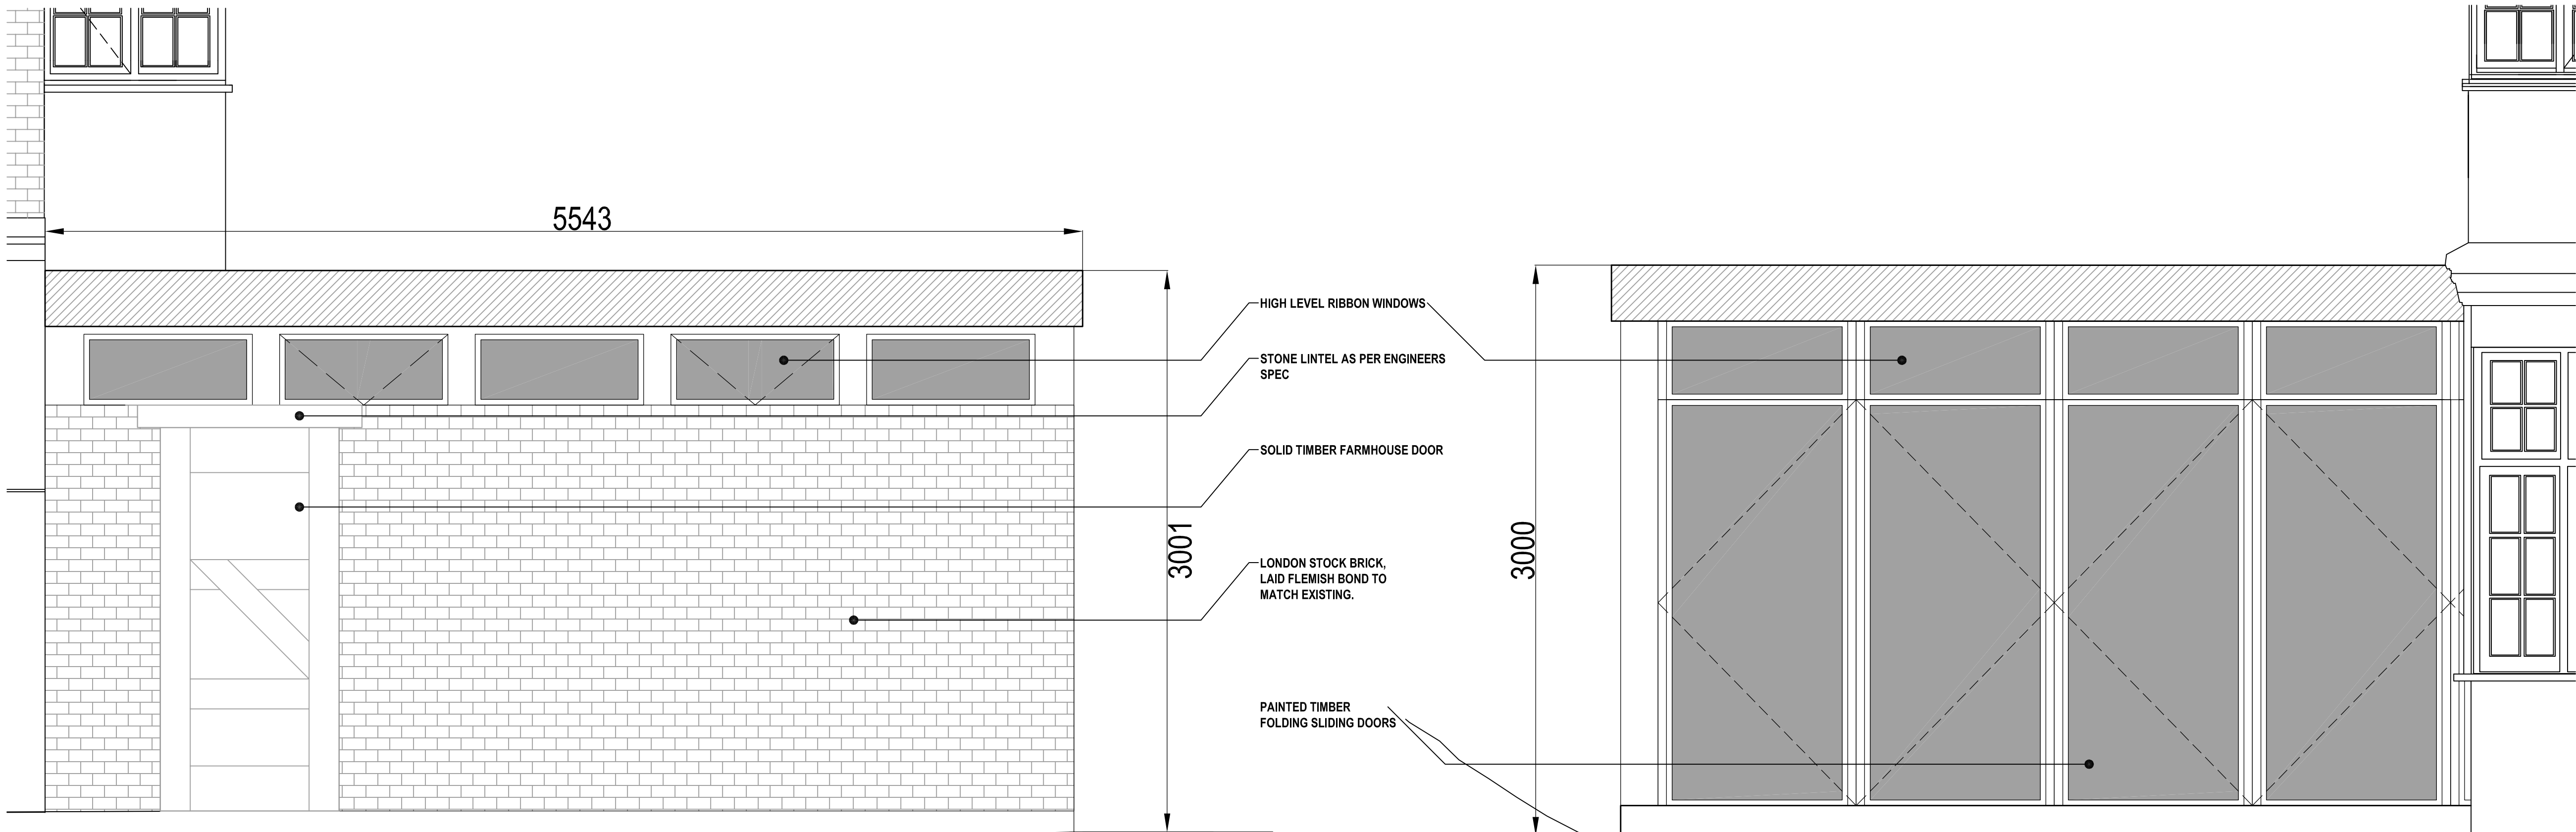


A
SCALE 1:20
NORTH FACING ELEVATION

B
SCALE 1:50
SOUTH FACING ELEVATION

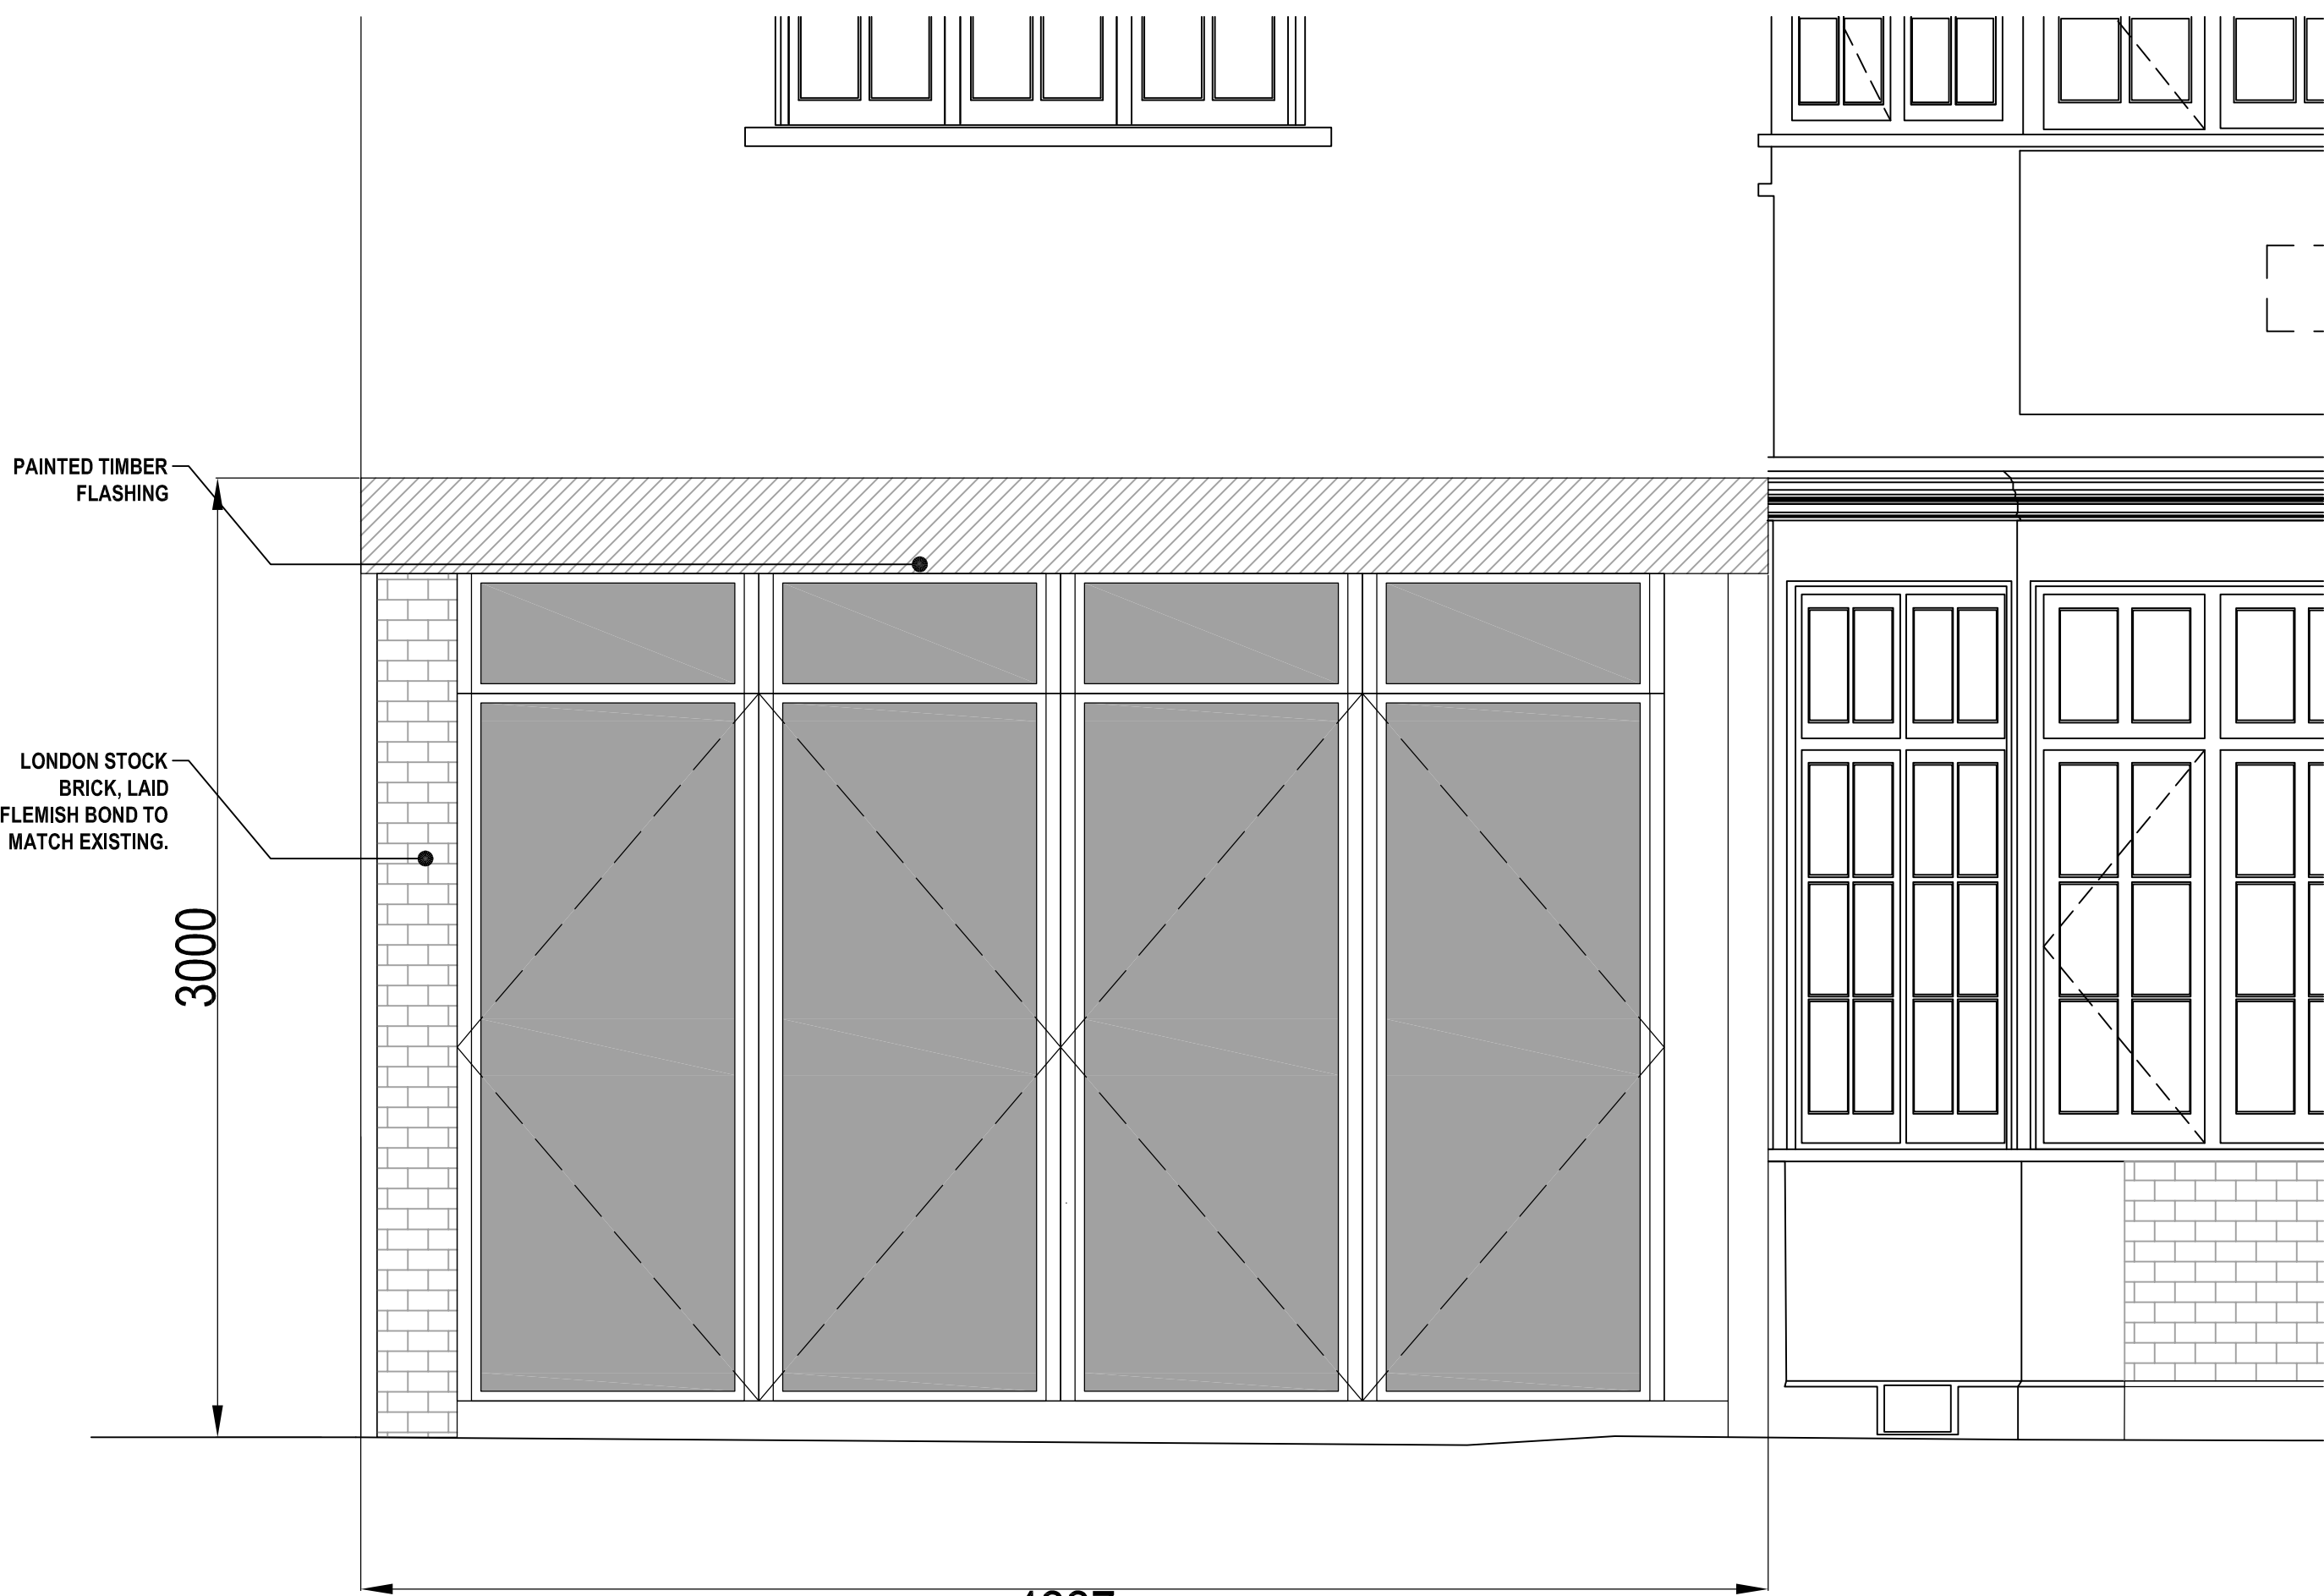

C
SCALE 1:50
WEST FACING ELEVATION

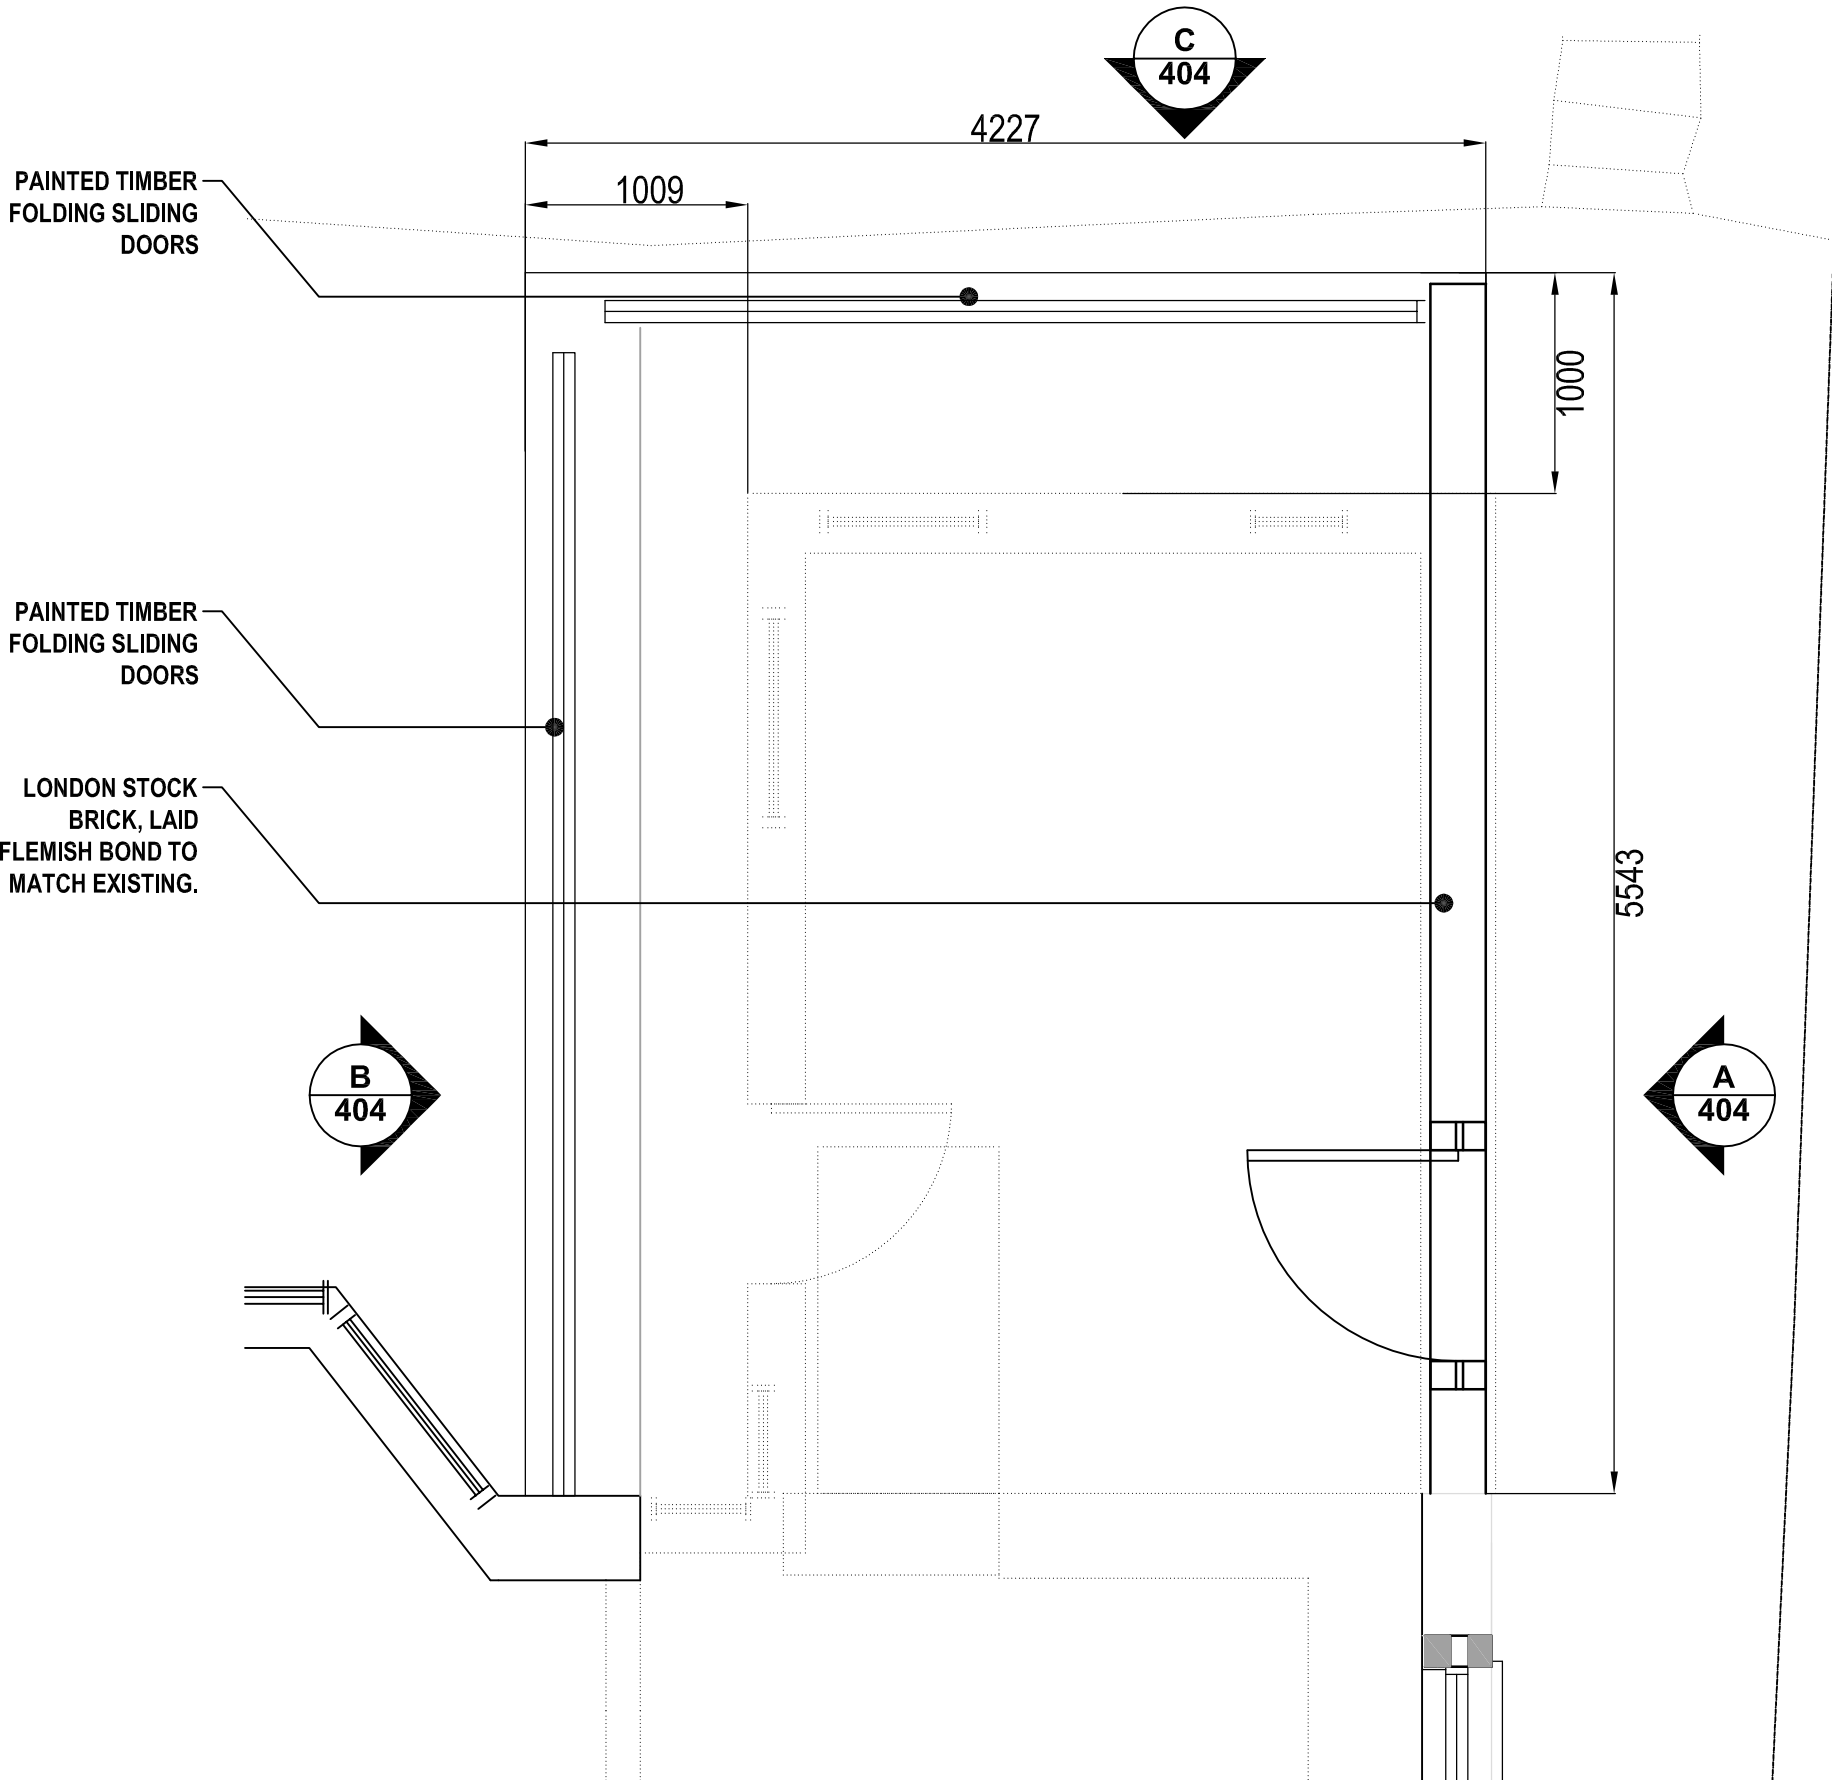

D
NOT TO SCALE
PLAN

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REV.	DATE	BY	COMMENT
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PROJECT:	41 CREDTION HILL, NW6 1HS.		
CLIENT:	MR & MRS SRIVASTAVA		
DRAWING TITLE:	PROPOSED EXTENSION ELEVATIONS		
DRAWING NO.	0809/404	DATE:	17/03/2009
SCALE:	1:20 @ A1		
STATUS:	TENDER		
AUTHOR:	JB		

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