# 30 Oval Road London & Newcastle (Camden) Limited

Application for approval of details reserved by condition 4. Planning Permission Dated 09 April 2009 Reference: 2009/0066/P

## **Discharge of Condition No 4**


Typical detail of all windows in development shall be submitted for approval before any work is commenced on the relevant part of development. Such details should include sections and elevations detailing materials, cill and lintols and depth of reveals. The windows shall not be installed until approval is given by the Council, and shall be installed in strict accordance with the detail thus approved.

Reason: To safeguard the appearance of the premises and the character of the immediate area in accordance with the requirements of policies S1/S2 and B1 and B7 of the London Borough of Camden Replacement Unitary Development Plan 2006.

## Drawing list:


Building elevations:

building elevations.	
4260 (05) 001 rev 17	South and North Elevations
4260 (05) 002 rev 14	East and West Elevations
4260 (05) 003 rev 13	Atrium South and North Elevations
4260 (05) 004 rev 13	Atrium West and East Elevations
Window elevations:	
4260 (31) 001 rev 07	Sash Window Elevations to Office and Private Residence
4260 (31) 002 rev 07	Composite Window Elevations to Office and Private Residence
4260 (31) 003 rev 06	Composite Window Elevations to Affordable Residence
4260 (31) 004 rev 05	Curtain Walling Elevations to Private Residence
4260 (31) 005 rev 07	Curtain Walling Elevations to Private Residence
4260 (31) 006 rev 06	Curtain Walling Elevations to Private Residence
4260 (31) 007 rev 05	Curtain Walling Elevations to Affordable Residence
4260 (31) 008 rev 06	Curtain Walling Elevations to Private and Affordable Residence
4260 (31) 009 rev 06	Curtain Walling Elevations to Private and Affordable Residence
4260 (31) 010 rev 08	Curtain Walling Elevations to Office on Ground Floor
4260 (31) 012 rev 01	Composite Window Elevations to Private Residence
4260 (31) 013 rev 02	Composite Window Elevations to Affordable and Private Residence
Window Details:	
4260 (21) 001 rev 07	External Envelope Details Sheet 1
4260 (21) 001 fev 07 4260 (21) 002 rev 07	External Envelope Details Sheet 1
4260 (21) 002 rev 07 4260 (21) 003 rev 09	External Envelope Details Sheet 2
` '	External Envelope Details Sheet 3
4260 (21) 005 rev 06	External Envelope Details
4260 (21) 006 rev 08	External Envelope Details
4260 (21) 007 rev 06	External Envelope Details, Atrium foods, Section 2.2.4 Details DSE
4260 (21) 008 rev 01	External Envelope Details, Atrium façade, Section 2,3,4, Details D&F
4260 (21) 011 rev 02 4260 (21) 012 rev 02	3rd Floor Sash Window Details, Existing Opening
, ,	3rd Floor Sash Window Details, Arch Head, Existing Opening
4260 (21) 030 rev 01	External Envelope Details, Section 1, Details B&C
4260 (21) 031 rev 01	External Envelope Details, Atrium facade, Details F&G
4260 (21) 035 rev 00	Ground Floor Sash Window Details, Existing Opening
4260 (21) 036 rev 00	1st Floor Sash Window Cill Detail, SFS Wall
4260 (21) 037 rev 00	Typical Sash Window Cill Detail, SFS Wall
4260 (21) 038 rev 00	Typical Sash Window Jamb Detail, SFS Wall
4260 (21) 039 rev 00	Ground Floor Sash Window Head Detail, SFS Wall
4260 (21) 040 rev 00	External Envelope Details, Window Head, Cill, Jamb and AB in Affordable Block
4260 (21) 041 rev 00	Typical Sash Window Head Detail, SFS Wall

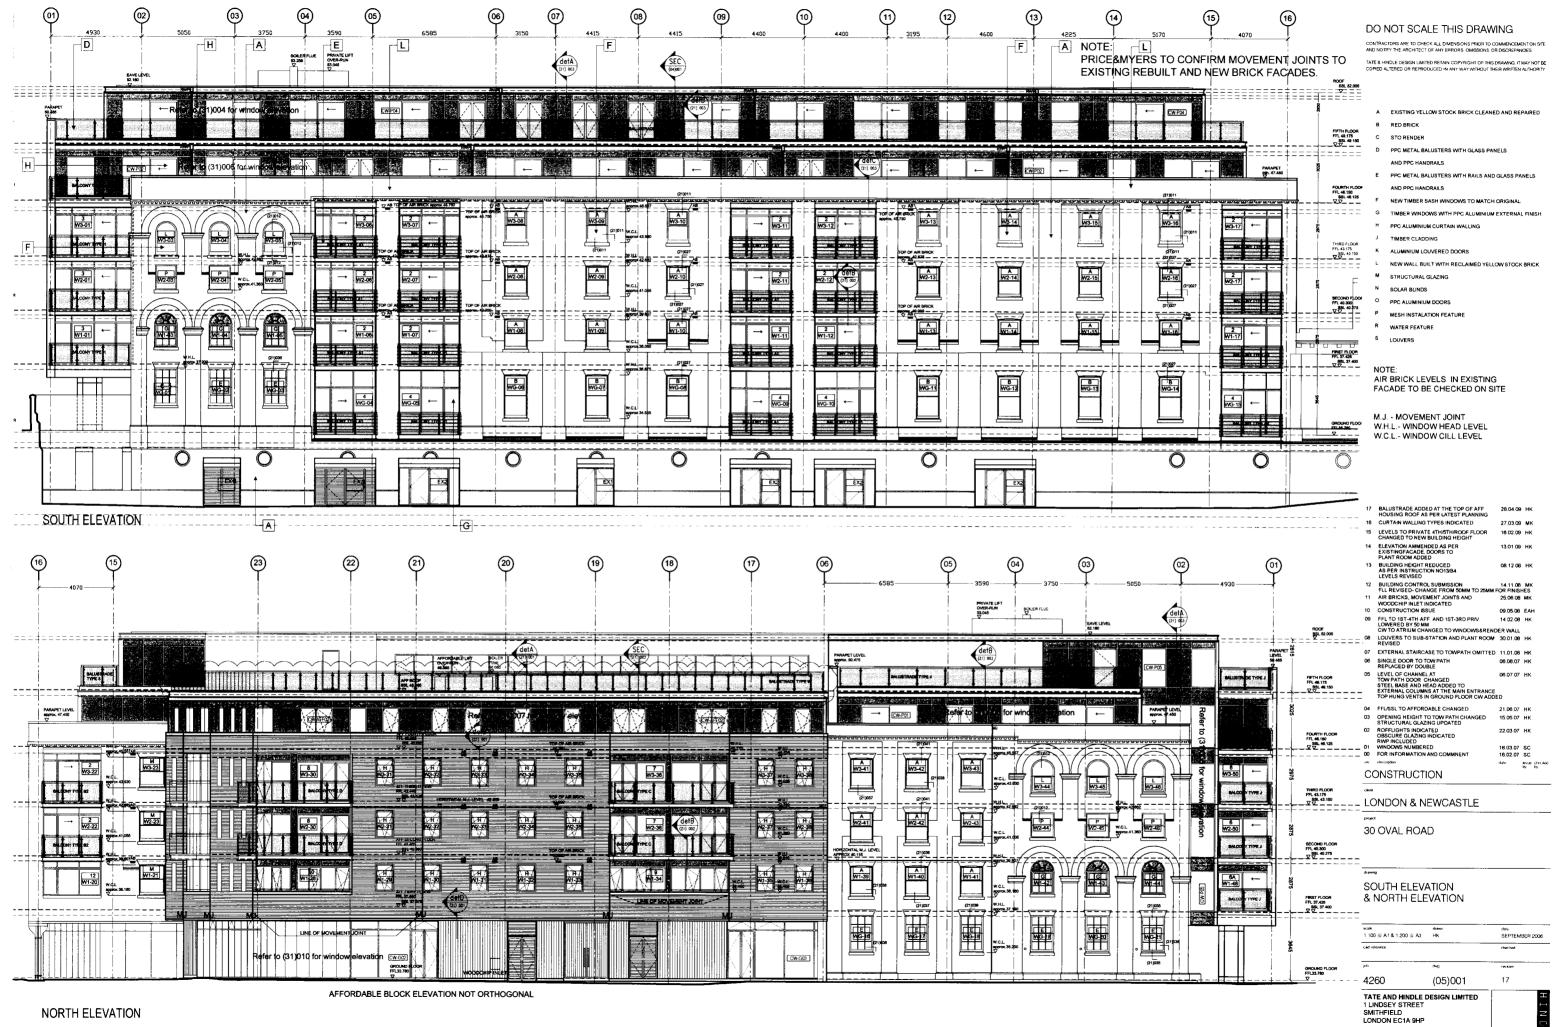

Tel: 020 7332 4850 Fax: 020 7332 4888 E: mail@tatehindle.co.uk W: www.tatehindle.co.

TATE

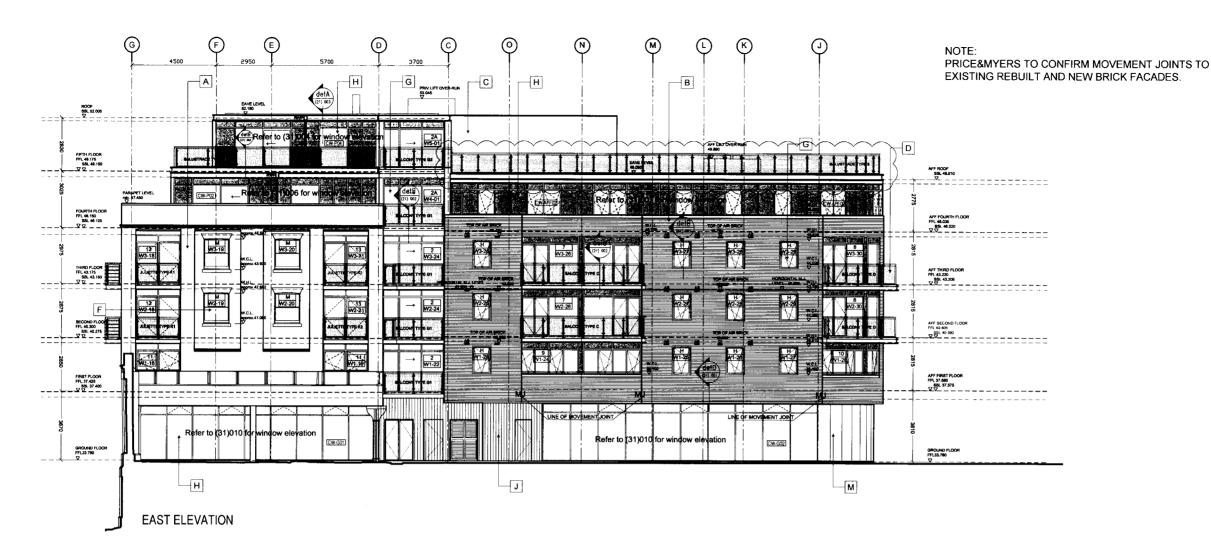


CONTRACTORS ARE TO CHECK ALL DIMENSIONS PRIOR TO COMMENCEMENT ON SITE AND NOTIFY THE ARCHITECT OF ANY ERRORS OMISSIONS OR DISCREPANCIES

TATE & HINDLE DESIGN LIMITED RETAIN COPYRIGHT OF THIS DRAWING IT MAY NOT B COPIED ALTERED OR REPRODUCED IN ANY WAY WITHOUT THEIR WRITTEN AUTHORITY

- A EXISTING YELLOW STOCK BRICK CLEANED AND REPAIRED
- B RED BRICK
- C STO RENDER
- D PPC METAL BALUSTERS WITH GLASS PANELS
- AND PPC HANDRAILS
- E PPC METAL BALUSTERS WITH RAILS AND GLASS PANELS
- NEW TIMBER SASH WINDOWS TO MATCH ORIGINAL
- TIMBER WINDOWS WITH PPC ALUMINIUM EXTERNAL FINISH
- H PPC ALUMINIUM CURTAIN WALLING
- J TIMBER CLADDING
- K ALUMINIUM LOUVERED DOORS
- NEW WALL BUILT WITH RECLAIMED YELLOW STOCK B
- M STRUCTURAL GLAZING
- N SOLAR BLINDS
- O PPC ALUMINIUM DOORS
- MESH INSTALATION FEATURE
- R WATER FEATURE
- S LOUVERS

NOTE: AIR BRICK LEVELS IN EXISTING FACADE TO BE CHECKED ON SITE

M.J. - MOVEMENT JOINT W.H.L.- WINDOW HEAD LEVEL W.C.L.- WINDOW CILL LEVEL

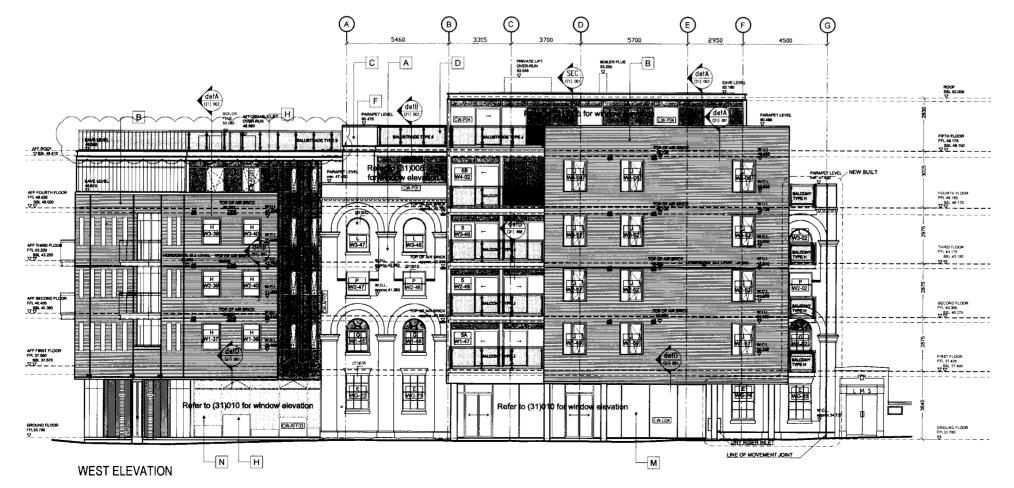

CC	ONSTRUCTION		b
rov	description	date	
00	FOR INFORMATION AND COMMNENT	16.02.07	5
01	WINDOWS NUMBERED	16.03.07	5
02	ROFFLIGHTS INDICATED OBSCURE GLAZING INDICATED RWP INCLUDED	22 03.07	,
03	WINDOW SIZE AND LOCATION REVISED	15.05.07	
04	FFL/SSL TO AFFORDABLE CHANGED	21.06.07	•
05	TOP HUNG VENTS IN GROUND FLOOR CW ADDED	06,07,07	
06	FFL TO 1ST-4TH AFF. AND 1ST-3RD PRIV. LOWERED BY 50 MM	14.02.08	
07	CONSTRUCTION ISSUE	09.05.06	
08	AIR BRICKS, MOVEMENT JOINTS AND DRY RISER INLET INDICATED	25.06.08	3 1
09	BUILDING CONTROL SUBMISSION FLL REVISED- CHANGE FROM 50MM TO 25MM	14.11.06 FOR FINIS	
10	BUILDING HEIGHT REDUCED AS PER INSTRUCTION NO13/B4 LEVELS REVISED	08.12.08	3
11	ELEVATION AMMENDED AS PER EXISTINGFACADE, CURTAIN WALLING REVISE DOOR TO BIN STORE AND AFF.ENTRANCE RE	VISED	
12	LEVELS TO PRIVATE 4TH/5TH/ROOF FLOOR CHANGED TO NEW BUILDING HEIGHT	16.02.09	
13	CURTAIN WALLING TYPES INDICATED	27 03.09	
14	BALUSTRADE ADDED AT THE TOP OF AFF HOUSING ROOF AS PER LATEST PLANNING	28.04.09	•

LONDON & NEWCASTLE

30 OVAL ROAD


EAST ELEVATION & WEST ELEVATION

suals 1 100 @ A1 & 1 200 @ A3	diawn HK	SEPTEMBER 2006
rad reference	***	checked
kop	dwg	(events)


TATE AND HINDLE DESIGN LIMITED
1 LINDSEY STREET
SMITHFIELD
LONDON EC1A 9HP


Tel 020 7332 4850 Fax: 020 7332 4888 E: mail@tatehindle.co.uk W: www.tatehindle



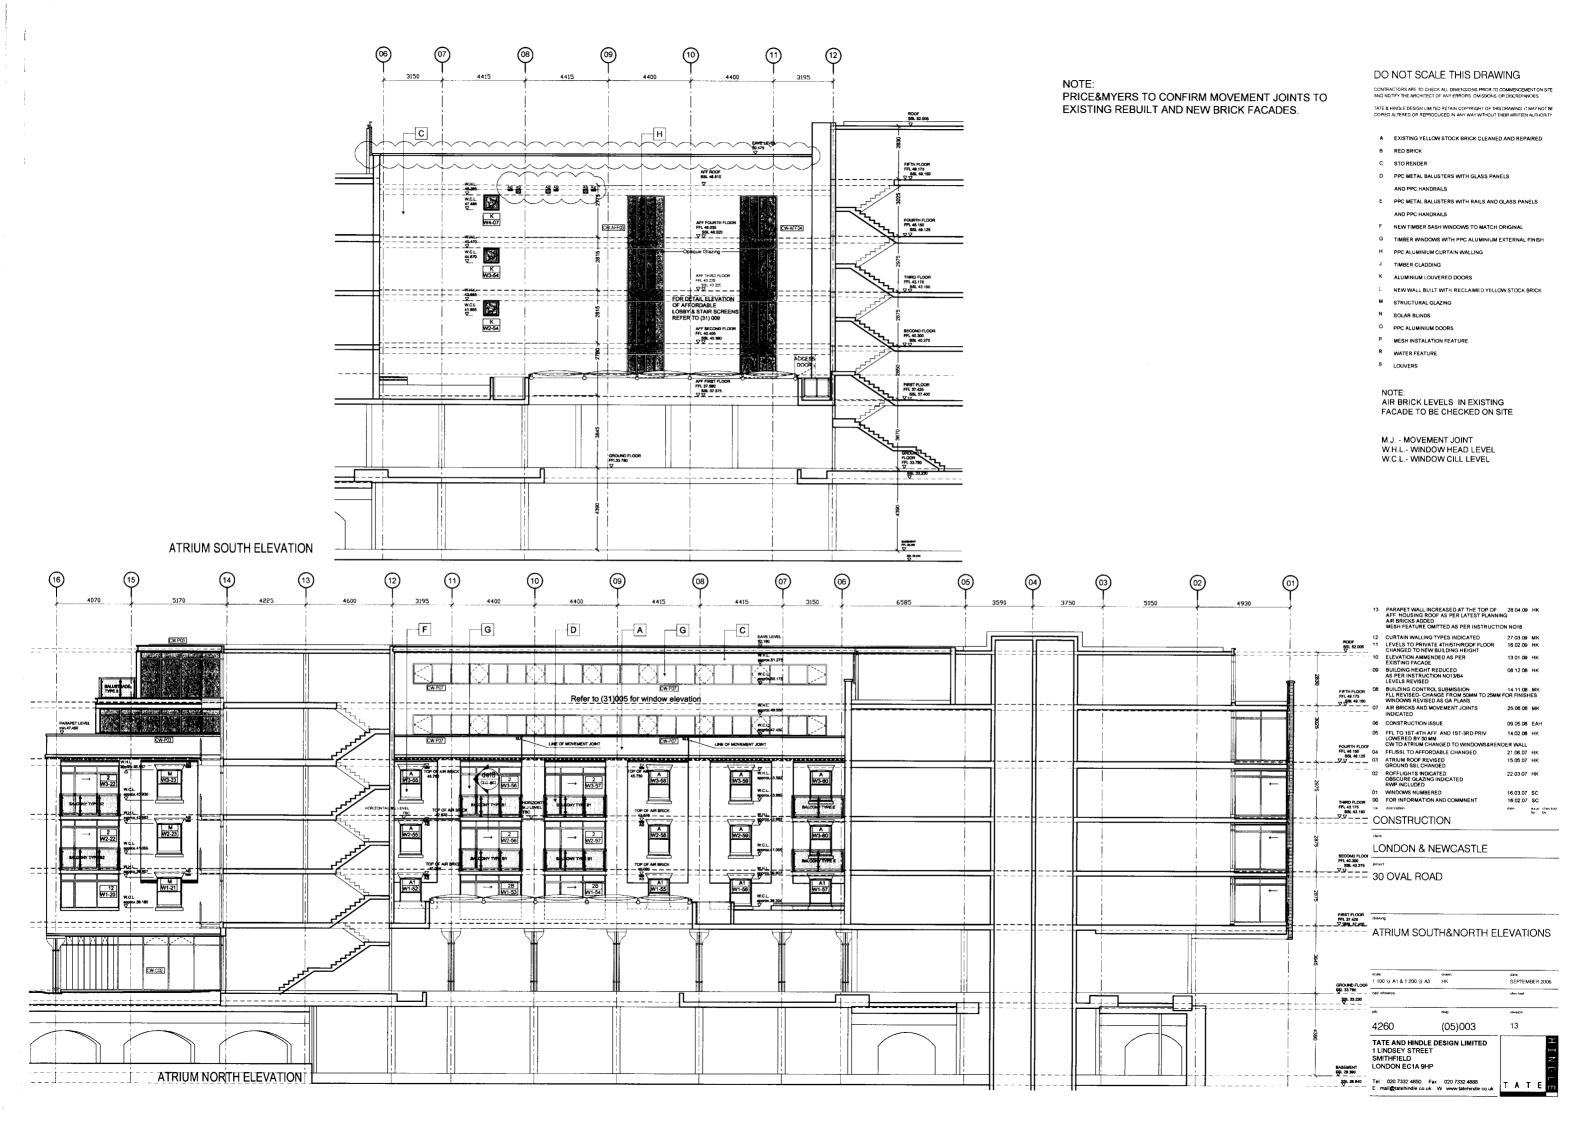

NOTE: PRICE&MYERS TO CONFIRM MOVEMENT JOINTS TO EXISTING REBUILT AND NEW BRICK FACADES.

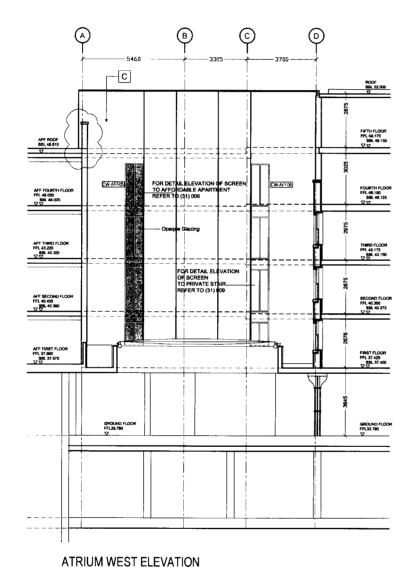

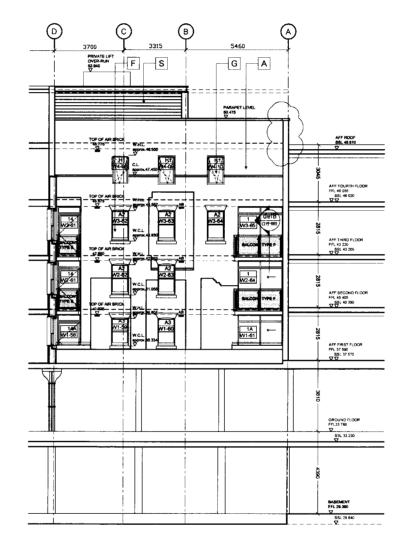

ATRIUM EAST ELEVATION

## DO NOT SCALE THIS DRAWING

CONTRACTORS ARE TO CHECK ALL DIMENSIONS PRIOR TO COMMENCEMENT ON AND MODIES THE ARCHITECT OF ANY ERRORS OMISSIONS OR DISCREPANCIES.

TATE & HINDLE DESIGN LIMITED RETAIN COPYRIGHT OF THIS DRAWING IT MAY NOT BE COPIED ALTERED OR REPRODUCED IN ANY WAY WITHOUT THEIR WRITTEN AUTHORITY

- A EXISTING YELLOW STOCK BRICK CLEANED AND REPAIRED
- 6 RED BRICK
- C STORENDER
- D PPC METAL BALUSTERS WITH GLASS PANELS
- AND PPC HANDRAILS
- E PPC METAL BALUSTERS WITH RAILS AND GLASS PANELS
- F NEW TIMBER SASH WINDOWS TO MATCH ORIGINAL
- G TIMBER WINDOWS WITH PPC ALUMINIUM EXTERNAL FINISH
- PPC ALUMINIUM CURTAIN WALLING
- J TIMBER CLADDING
- K ALUMINIUM L
- NEW WALL BUILT WITH RECLAIMED YELLOW STOCK BRICK
- M STRUCTURAL GLAZING
- b
- O PPC ALUMINIUM DOORS
- P MESH INSTALATION FEATURE
- R WATER FEATURE
- S LOUVERS

NOTE: AIR BRICK LEVELS IN EXISTING FACADE TO BE CHECKED ON SITE

M.J. - MOVEMENT JOINT W.H.L.- WINDOW HEAD LEVEL W.C.L.- WINDOW CILL LEVEL

13	PARAPET WALL INCREASED AT THE TOP OF		нк	
	AFF HOUSING ROOF AS PER LATEST PLANNI			
	WATER FEATURE OMITTED AS PER INSTRUCT			
12	CURTAIN WALLING TYPES INDICATED	27.03.09	MK	
11	LEVELS TO PRIVATE 4TH/5TH/ROOF FLOOR CHANGED TO NEW BUILDING HEIGHT	16.02.09	HK	
10	ELEVATION AMMENDED AS PER EXISTING FACADE	13.01.09	нк	
09	BUILDING HEIGHT REDUCED AS PER INSTRUCTION NO13/B4 LEVELS REVISED	08.12.08	HK	
80	BUILDING CONTROL SUBMISSION FLL REVISED- CHANGE FROM 50MM TO 25MM FOR FINISHES	14.11.08	MK	
07	AIR BRICKS INDICATED	25.06.08	MK	
06	CONSTRUCTION ISSUE	09.05.08	EAH	•
05	FFL TO 1ST-4TH AFF AND 1ST-3RD PRIV LOWERED BY 50 MM	14 02.08	HK	
04	FFL/SSL TO AFFORDABLE CHANGED	21.06.07	HK	
03	STRUCTURE & SSL REVISED	15.05.07	HK	
02	ROFFLIGHTS INDICATED OBSCURE GLAZING INDICATED	22.03.07	HK	
01	WINDOWS NUMBERED	16.03.07	SC	
00	FOR INFORMATION AND COMMINENT	16.02.07	SC	
14%	description	date	es sur	checked by

## CONSTRUCTION


client

## LONDON & NEWCASTLE

30 OVAL ROAD


## ATRIUM WEST & EAST ELEVATIONS

1 100 @ A1 & 1:200 @ A3	нк	SEPTEMBER 2006
ad reference		checked
eb	dwg.	Iferson
4260	(05)004	13

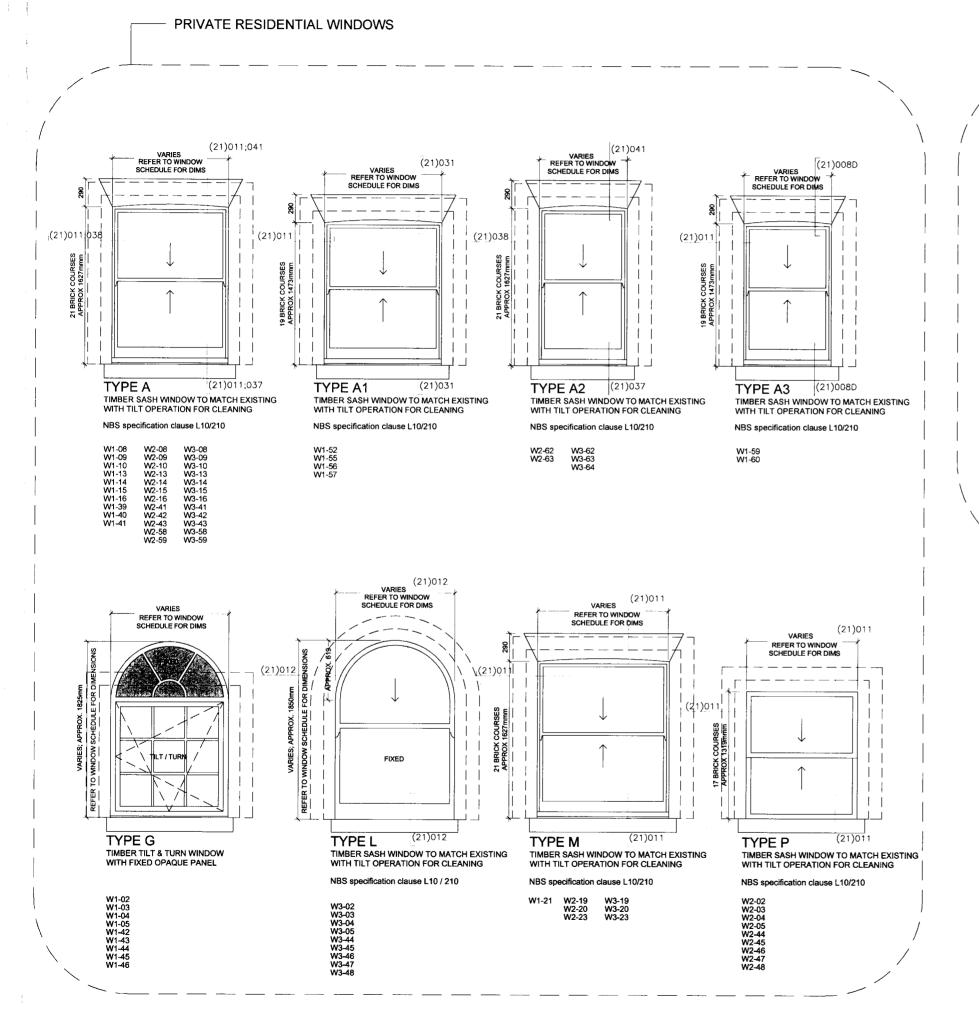

CONTRACTORS ARE TO CHECK ALL DIMENSIONS PRIOR TO COMMENCEMENT ON SI AND NOTIFY THE ARCHITECT OF ANY ERRORS, OMISSIONS, OR DISCREPANCIES

TATE & HINDLE DESIGN LIMITED RETAIN COPYRIGHT OF THIS DRAWING IT MAY NOT

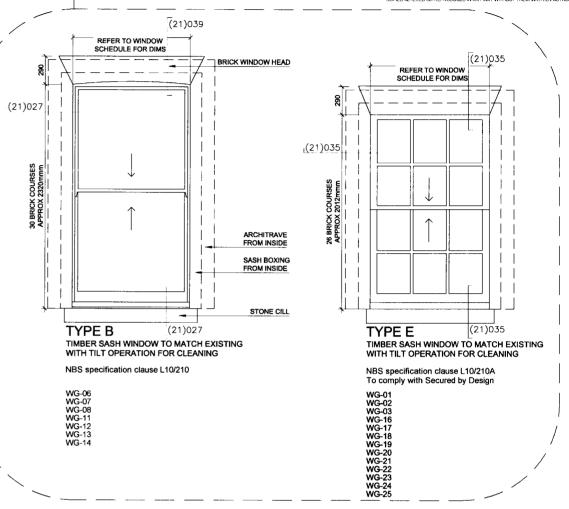

## NOTE:

ALL DIMENSIONS INDICATED
ARE APPROXIMATE
ALL OPENINGS MUST BE SITE MEASURED
PRIOR TO FABRICATION
REFER TO SCHEDULE
P08 007 FOR DIMENSIONS.

OFFICE WINDOWS

DIMENSIONS TO EXISTING OR NEW OPENINGS FOR SASH WINDOWS ARE BASED ON IMPERIAL BRICK SIZE: 67 x 107.5 x 225mm.

STRUCTURAL OPENING SIZE IS MEASURED FROM OUTSIDE.


ALL SASH WINDOWS TO BE FINISHED WITH ARCHITRAVE INTERNALLY.

07	NBS SPEC UPDATED AND	27.03.09	нк
06	TYPE E1 OMITTED	17.03.09	нк
05	TYPR E1 EXTRACTED FROM TYPE E	26.02 09	HK
04	WINDOW \$1ZES REVISED TO BUILDING HEIGHT REDUCTIONS	17 12.08	
03	DETAIL REFS UPDATED. DIMENSIONS ALTERED AND NOTE ADDED	23.05.08	EAH
02	CONSTRUCTION ISSUE	09.05.08	EAH
01	WINDOW TYPES L, M, N & P ADDED WINDOW TYPES C,D OMITTED	22.03.07	sc
00	INITIAL ISSUE	02.03.07	BP
rev	description	date	issue checke
	***************************************	Case	
С	ONSTRUCTION	U-aue	
Cien	ONSTRUCTION		
clien	ONSTRUCTION		
clien	ONSTRUCTION ONDON & NEWCASTLE	U-ster	
client L(	ONSTRUCTION ONDON & NEWCASTLE	0486	


scale drawn date 1:20 @ A1 & 1:40 @ A3 BP FEBRUA	RESIDENCE	AND PRIV	AIL
1:20 @ A1 & 1:40 @ A3 BP FEBRUA	scale	drawn	date
	1:20 M A1 # 1:40 M A3	BP	FEBRUAR'

SASH WINDOW ELEVATIONS

1:20 @ A1 & 1:40 @ A3	BP	FEBRUARY 2007
cad reference		checked
dol	dwg	revision
4260	(31) 001	07
TATE AND HINDLE 1 LINDSEY STREET SMITHFIELD LONDON EC1A 9HP		H 12
Tel: 020 7332 4850 Fa		TATE

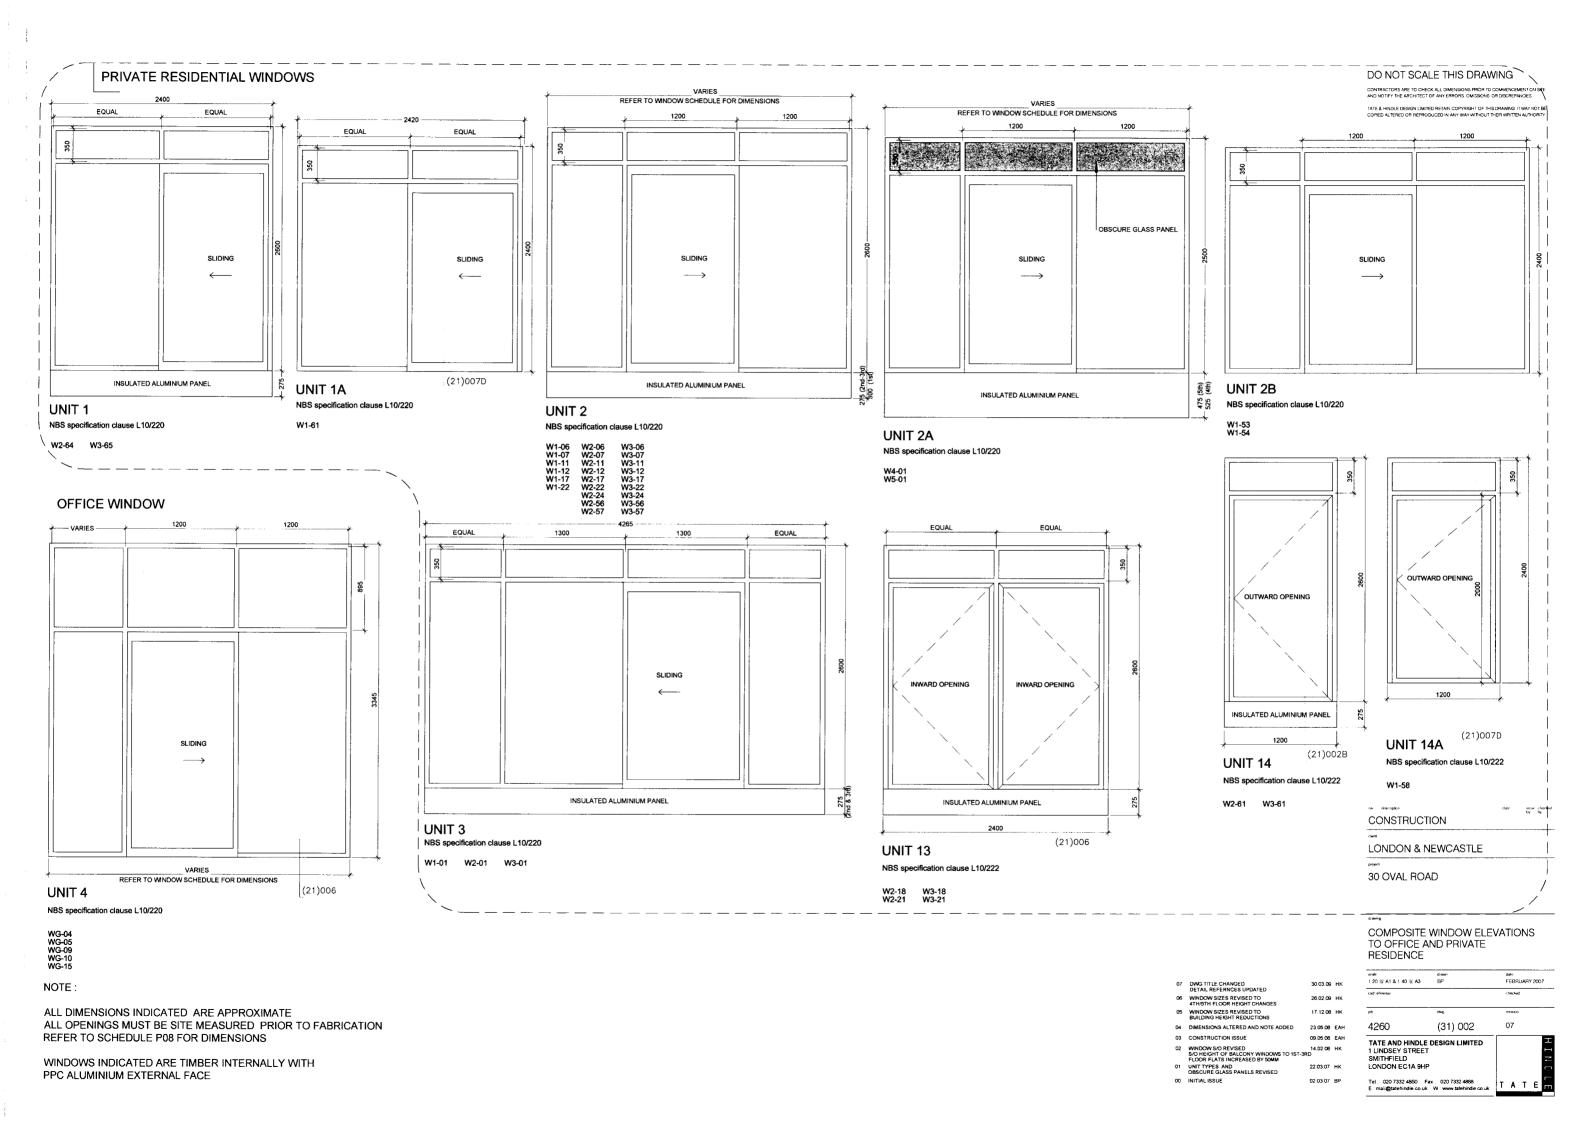

## AFFORDABLE RESIDENTIAL WINDOWS

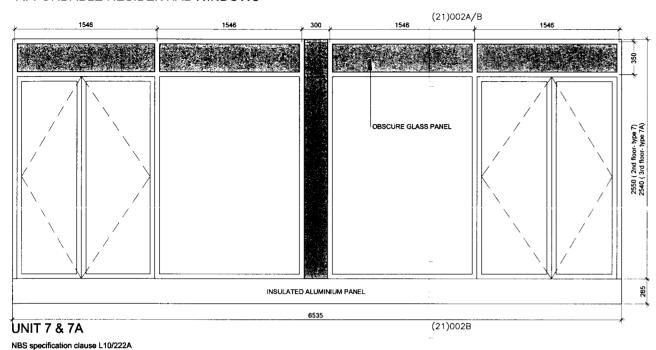

W2-26 W3-26 (7A) W2-36 W3-36 (7A) (21)002B --- 773 ---OBSCURE GLASS PANEL TURN TILT / TURN TILT / TURN 6535

(21)002C

UNIT 9

NBS specification clause L10/221A


W1-24 W1-34

M INDICATES OBSCURE GLASS PANEL

## NOTE:

ALL DIMENSIONS INDICATED ARE APPROXIMATE ALL OPENINGS MUST BE SITE MEASURED PRIOR TO FABRICATION REFER TO SCHEDULE P08 FOR DIMENSIONS


WINDOWS INDICATED ARE TIMBER INTERNALLY WITH PPC ALUMINIUM EXTERNAL FACE

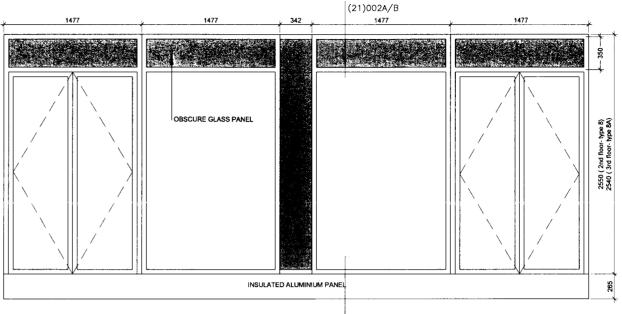

(21)002B

UNIT 8 & 8A (facetted window, dimension t.b.c.)

NBS specification clause L10/222A

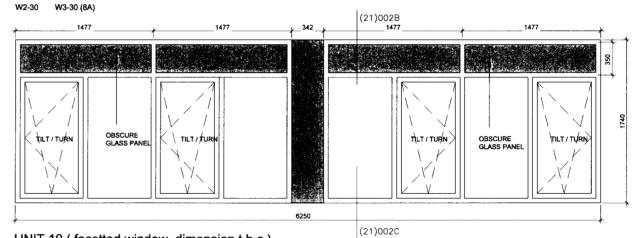

UNIT 10 (facetted window, dimension t.b.c.)

NBS specification clause L10/221A

W1-28

06 DWG TITLE CHANGED DETAIL REFERNCES UPDATED 05 WINDOW SIZES REVISED TO BUILDING HEIGHT REDUCTIONS 17.12.08 HK

09.05.08 EAH

DO NOT SCALE THIS DRAWING

CONTRACTORS ARE TO CHECK ALL DIMENSIONS PRIOR TO COMMENCEMENT ON SITE AND NOTIFY THE ARCHITECT OF ANY ERRORS, OMISSIONS, OR DISCREPANCIES.

03 CONSTRUCTION ISSUE | 02 | SIO HEIGHT OF BALCONY WINDOWS TO 1ST-4TH14.02.08 | HK | FLOOR FLATS INCREASED BY 50MM | 01 | OBSCURE GLASS PANELS REVISED | 22.03.07 | HK | 02.03.07 | BP |

CONSTRUCTION

LONDON & NEWCASTLE


30 OVAL ROAD

COMPOSITE WINDOW ELEVATIONS TO AFFORDABLE RESIDENCE

scale draw 1:20:@ A1 & 1 40 @ A3 BP riehi FEBRUARY 2007 06 4260 (31) 003

TATE AND HINDLE DESIGN LIMITED 1 LINDSEY STREET SMITHFIELD LONDON EC1A 9HP

Tel. 020 7332 4850 Fax 020 7332 4888 E , mail@tatehindle.co.uk W www.tatehindle.co.uk

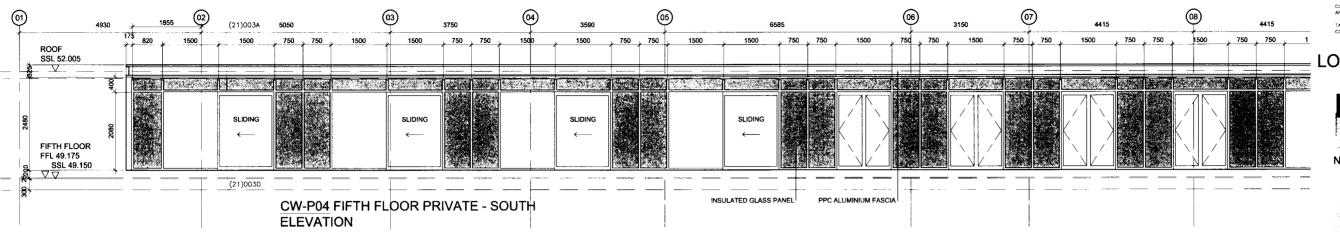

PPC ALUMINIUM FASCIA INSULATED GLASS PANEL


10

(13)


CW-P04 FIFTH FLOOR PRIVATE - SOUTH ELEVATION

## DO NOT SCALE THIS DRAWING


## **LOCATION KEY:**

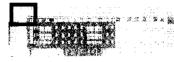

NORTH ELEVATION

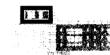

EAST ELEVATION

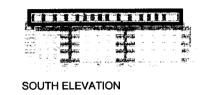

## NOTE:

ROOF SSL 52.005

FIFTH FLOOR

FFL 49.175 SSL 49.150 ♥▽▽

 $\nabla$ 

(21)003A 5170

SLIDING

(21)003D


1500

EAVE LEVEL 52.180

WINDOWS INDICATED ARE TIMBER INTERNALLY WITH PPC ALUMINIUM EXTERNAL FACE

FOR STRUCTURAL **CURTAIN WALLING** REFER TO NBS SPECIFICATION CLAUSE: H11 / 110A

INSULATED GLASS PANEL

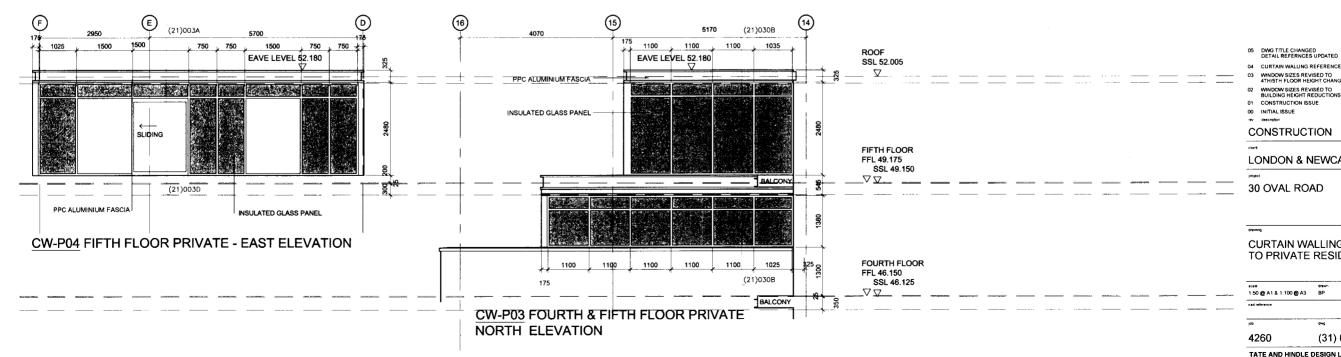

00 INITIAL ISSUE CONSTRUCTION LONDON & NEWCASTLE 09 05 08 FAH

WINDOW SIZES REVISED TO 4TH/5TH FLOOR HEIGHT CHAI

30 OVAL ROAD

CURTAIN WALLING ELEVATIONS TO PRIVATE RESIDENCE

scale	drawn	date
1:50 @ A1 & 1:100 @ A3	BP	FEBRUARY 200
cad reference		checked
job	dwg	revision
4260	(31) 004	05
TATE AND HINDLE 1 LINDSEY STREET SMITHFIELD LONDON EC1A 9HP		

## LOCATION KEY: DO NOT SCALE THIS DRAWING NOTE: CONTRACTORS ARE TO CHECK AL QID NSIONS PRIOR WINDOWS INDICATED ARE TIMBER INTERNALLY (21)003A **5050** WITH PPC ALUMINIUM EXTERNAL FACE TATE & HINDLE DESIGN COPIED & TEREDOR RE 1325 1295 EAVE LEVEL 52.180 SSL 52.005 □ ∇\_\_\_\_\_ S FOR STRUCTURAL CURTAIN WALLING REFER TO NBS SPECIFICATION CLAUSE: H11 / 110A STO RENDER **NORTH ELEVATION** INSULATED GLASS PANEL INSULATED ---FIFTH FLOOR FFL 49.175 SSL 49.150 (21)0030 CW-P05 FIFTH FLOOR PRIVATE NORTH ELEVATION NORTH ATRIUM ELEVATION FOURTH FLOOR FFL 46.150 SSL 46.125 $\nabla \nabla$ (21)003D WEST ELEVATION THIRD FLOOR FFL 43.175 SSL 43.150 <u>08</u>) (10) (09) (07) (12) $\nabla\nabla$ ROOF (21)031F EAVE LEVEL 52.180 SSL 52.005 SECOND FLOOR FFL 40.300 AOV ` AOV AOV SSL 40.275 FIFTH FLOOR FFL 49.175 SSL 49.150 - 2070 SO to GRID $\nabla \nabla$ FIRST FLOOR FFL 37.425 $\nabla \nabla$ FOURTH FLOOR FFL 46.150 SSL 46.125 DWG TITLE CHANGED DETAIL REFERNCES UPDATED (21)031F 05 WINDOW SIZES REVISED TO 4TH/5TH FLOOR HEIGHT CHAI 04 WINDOW SIZES REVISED TO BUILDING HEIGHT REDUCTIONS CW-P07 FOURTH & FIFTH FLOOR PRIVATE NORTH ELEVATION (ATRIUM SOUTH SIDE) 02 4TH/5TH FLOORS CW TO ATRIUM REPLACED BY WINDOWS 01 GLAZING SIZE AND DESIGN REVIS 01 INITIAL ISSUE CONSTRUCTION LONDON & NEWCASTLE (21)003A 0 30 OVAL ROAD ROOF EAVE LEVEL 52.180 SSL 52.005 $\nabla$

Wall Take PPC ALUM, POST SLIDING FIFTH FLOOR INSULATED GLASS PANEL PPC ALUMINIUM FASCIA (21)003D CW-P04 FIFTH FLOOR PRIVATE - WEST **ELEVATION** 

CURTAIN WALLING ELEVATIONS TO PRIVATE RESIDENCE


scale drawn 1 50 @ A1 & 1.100 @ A3 BP 07 4260 (31) 005

TATE AND HINDLE DESIGN LIMITED 1 LINDSEY STREET SMITHFIELD LONDON EC1A 9HP

Tel: 020 7332 4850 Fax: 020 7332 4888 E:mail@tatehindle.co.uk W:www.tatehindle

14.02.08 HK

FEBRUARY 2007

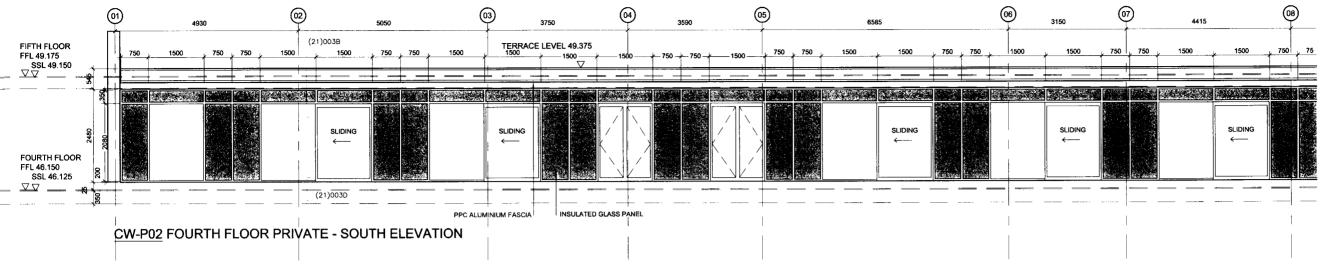

# LOCATION KEY:

DO NOT SCALE THIS DRAWING





EAST ELEVATION



SOUTH ELEVATION

INSULATED GLASS PANEL

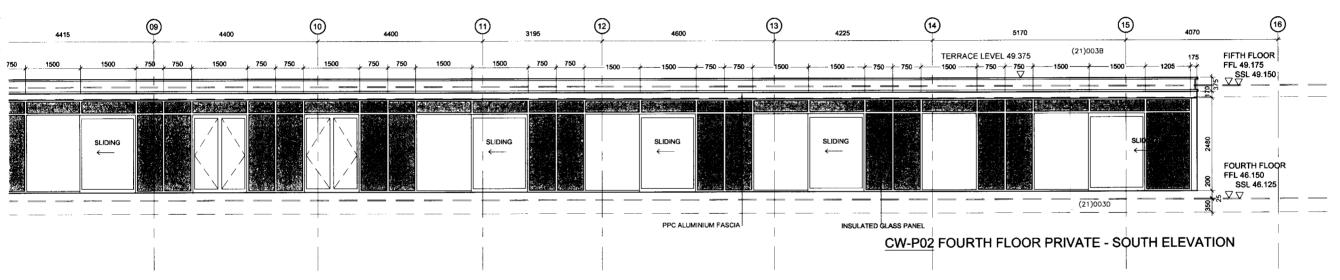

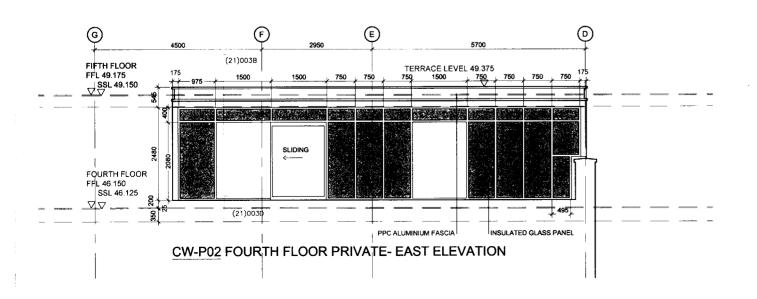

WINDOWS INDICATED ARE TIMBER INTERNALLY WITH PPC ALUMINIUM EXTERNAL FACE

FOR STRUCTURAL CURTAIN WALLING REFER TO NBS SPECIFICATION CLAUSE: H11 / 110A

rev	description	date	tesue check by by
00	INITIAL ISSUE	02.03.07	BP
01	WINDOW DIVISIONS REVISED	22.03.07	нк
02	CONSTRUCTION ISSUE	09.05.08	EAH
03	WINDOW SIZES REVISED TO BUILDING HEIGHT REDUCTIONS	17 12.08	HK
Q4	WINDOW SIZES REVISED TO 4TH/5TH FLOOR HEIGHT CHANGES	26.02.09	нк
05	CURTAIN WALLING REFERENCE ADDED	17.03.09	нк
06	DWG TITLE CHANGED DETAIL REFERNCES UPDATED	30.03.09	HK

## CONSTRUCTION

LONDON & NEWCASTLE

30 OVAL ROAD

CURTAIN WALLING ELEVATIONS TO PRIVATE RESIDENCE

scale	drawn	date
1:50 @ A1 & 1:100 @ A3	BP	FEBRUARY 200
cad reference		checked
kop	dwg	revision
4260	(31) 006	06

TATE AND HINDLE DESIGN LIMITED 1 LINDSEY STREET SMITHFIELD LONDON EC1A 9HP Tel. 020 7332 4850 Fax : 020 7332 4888 E: mail@tatehindle.co.uk W: www.tatehindle

CONTRACTORS ARE TO CHECK ALL DIMENSIONS PRIOR TO COMMENCEMENT ON S AND NOTIFY THE ARCHITECT OF ANY ERRORS OMISSIONS, OR DISCREPANCIES


TATE & HINDLE DESIGN LIMITED RETAIN COPYRIGHT OF THIS DRAWING IT MAY NO COPIED ALTERED OR REPRODUCED IN ANY WAY WITHOUT THEIR WRITTEN AUTHO

## LOCATION KEY:







NORTH ELEVATION

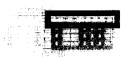

EAST ELEVATION

INSULATED GLASS PANEL

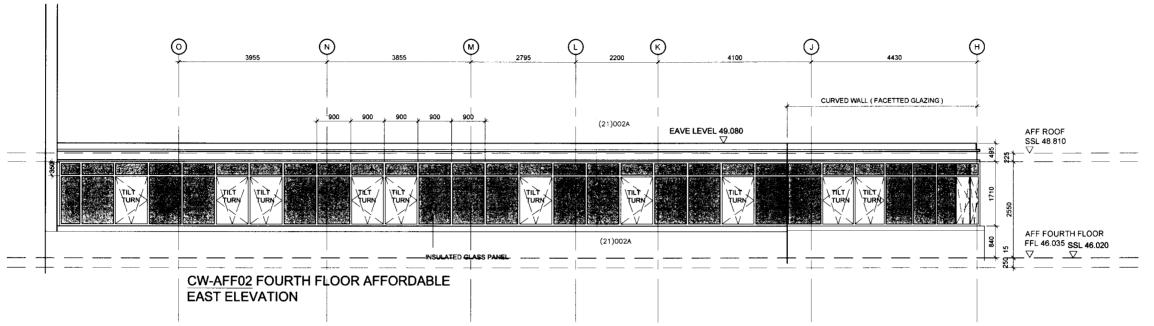

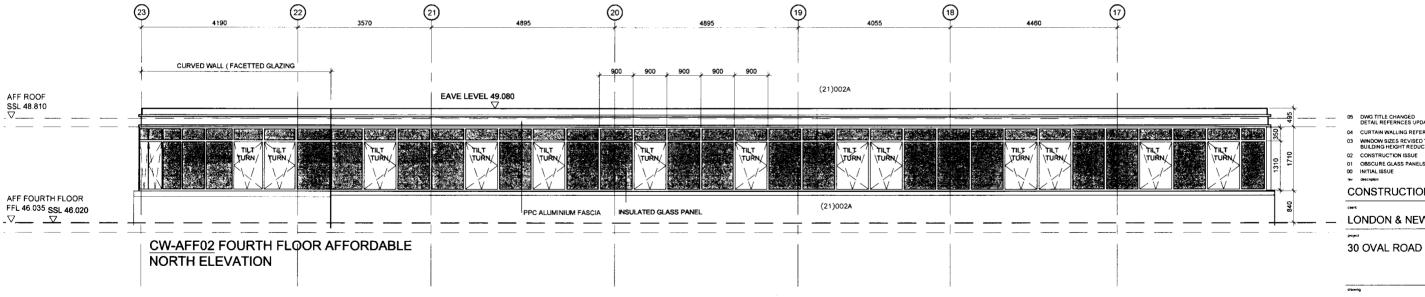

WINDOWS INDICATED ARE TIMBER INTERNALLY WITH PPC ALUMINIUM EXTERNAL FACE

FOR STRUCTURAL CURTAIN WALLING REFER TO NBS SPECIFICATION CLAUSE: H11 / 110A


	buole	d		
_	L(	ONDON & NEWCASTLE		
	C	ONSTRUCTION		
	rev	description	date	nasue by
	00	INITIAL ISSUE	02.03.07	8P
	01	OBSCURE GLASS PANELS REVISED	22.03.07	нк
	02	CONSTRUCTION ISSUE	09.05.08	EAH
	03	WINDOW SIZES REVISED TO BUILDING HEIGHT REDUCTIONS	17.12.08	нк
	04	CURTAIN WALLING REFERENCE ADDED	17.03.09	нк
	05	DWG TITLE CHANGED DETAIL REFERNCES UPDATED	30.03.09	нк

# CURTAIN WALLING ELEVATIONS TO AFFORDABLE RESIDENCE

50200	drawn	date
1:50 @ A1 & 1:100 @ A3	BP	FEBRUARY 2007
cad reference		checked
job	owg	revision
4260	(31) 007	05

TATE AND HINDLE DESIGN LIMITED 1 LINDSEY STREET SMITHFIELD Tel. 020 7332 4850 Fax . 020 7332 4888 E. mail@tatehindle.co.uk W www.tatehindle



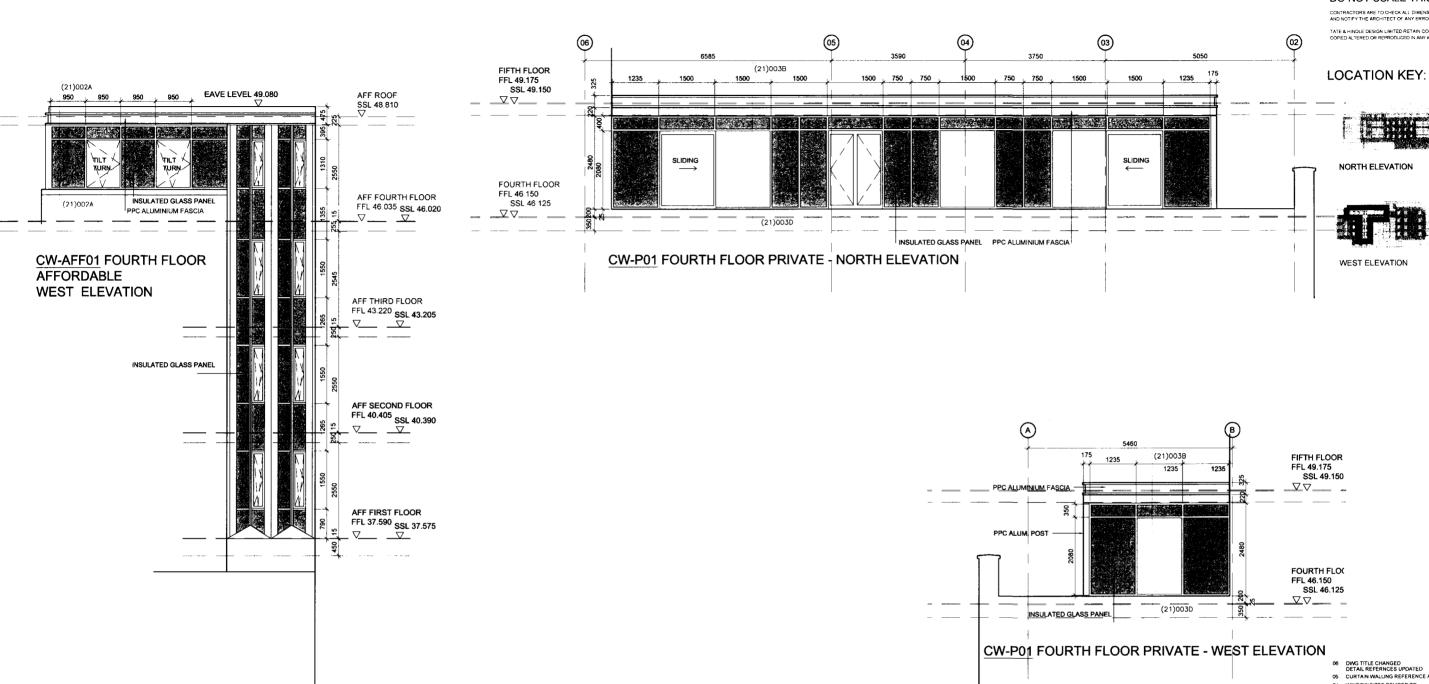

CONTRACTORS ARE TO CHECK ALL DIMENSIONS PRIOR TO COMMENCEMENT ON S AND NOTIFY THE ARCHITECT OF ANY ERRORS OMISSIONS OR DISCREPANCIES

TATE & HINDLE DESIGN LIMITED RETAIN COPYRIGHT OF THIS DRAWING IT MAY NO COPIED ALTERED OR REPRODUCED IN ANY WAY WITHOUT THEIR WRITTEN AUTHO





06 DWG TITLE CHANGED
DETAIL REFERNCES UPDATED
05 CURTAIN WALLING REFERENCE ADDED
04 WINDOW SIZES REVISED TO
4TH5TH FLOOR HEIGHT CHANGES

30.03.09 HK 17.03.09 HK 26.02.09 HK

17.12.08 HK

193 WINDOW SIZES REVISED TO
BUILDING HEIGHT REDUCTIONS
CONSTRUCTION ISSUE
OSCURE GLASS PANELS REVISED
INITIAL ISSUE

CONSTRUCTION

LONDON & NEWCASTLE

30 OVAL ROAD

INSULATED GLASS PANEL

WINDOWS INDICATED ARE TIMBER INTERNALLY WITH PPC ALUMINIUM EXTERNAL FACE


FOR STRUCTURAL CURTAIN WALLING REFER TO NBS SPECIFICATION CLAUSE: H11 / 110A

## **CURTAIN WALLING ELEVATIONS** TO AFFORDABLE AND PRIVATE RESIDENCE

FEBRUARY 2007 1.50 @ A1 & 1.100 @ A3 BP 4260 06 (31) 008

TATE AND HINDLE DESIGN LIMITED
1 LINDSEY STREET
SMITHFIELD LONDON EC1A 9HP

Tel: 020 7332 4850 Fax: 020 7332 4888 E:mail@tatehindle.co.uk W:www.tatehindle.co

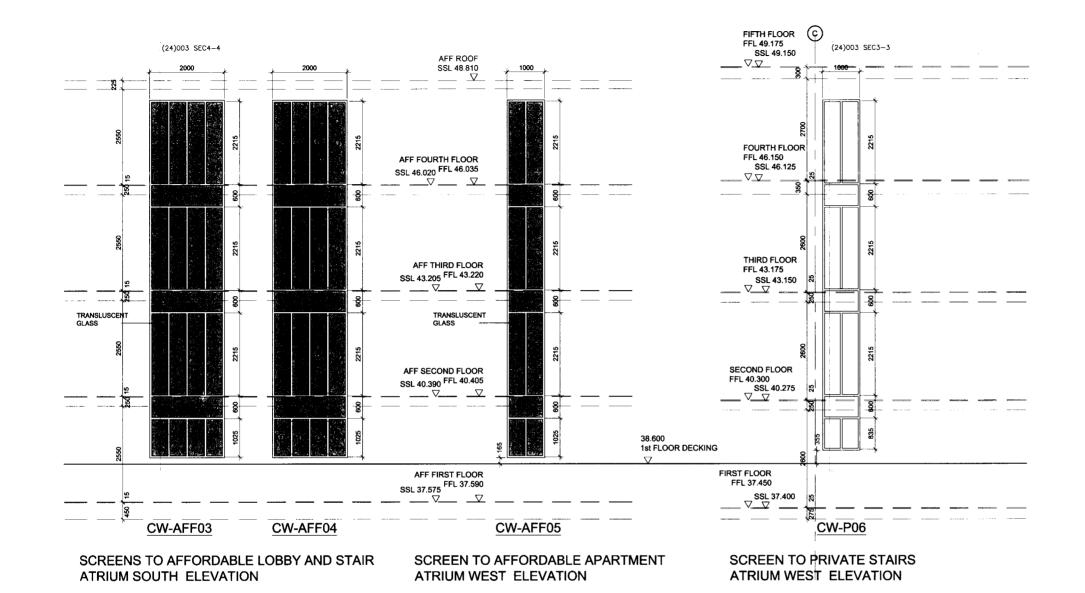


WINDOWS INDICATED ARE TIMBER INTERNALLY WITH PPC ALUMINIUM EXTERNAL FACE

FOR STRUCTURAL CURTAIN WALLING REFER TO NBS SPECIFICATION CLAUSE: H11 / 110A


## DO NOT SCALE THIS DRAWING

## TATE & HINDLE DESIGN LIMITED RETAIN COPYRIGHT OF THIS DRAWING IT MAY NOT BE COPIED ALTERED OR REPRODUCED IN ANY WAY WITHOUT THEIR WRITTEN AUTHORITY

## LOCATION KEY:

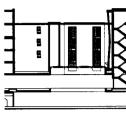

SOUTH ATRIUM ELEVATION

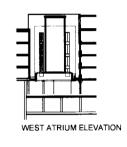

06 DWG TITLE CHANGED
DETAIL REFERNCES UPDATED
05 CURTAIN WALLING REFERENCE ADDED

30.03.09 HK 17.03.09 HK 17.12.08 HK

09.05.08 EAH

02 CONSTRUCTION ISSUE 01 FFL TO 1ST-4TH AFF. AND 1ST-3RD PRINCOWERED BY 50 MM
00 INITIAL ISSUE

CONSTRUCTION

LONDON & NEWCASTLE

30 OVAL ROAD


CURTAIN WALLING ELEVATIONS TO AFFORDABLE AND PRIVATE


RESIDENCE susin 1:50 @ A1 & 1 100 @ A3 4260 (31) 009 06

TATE AND HINDLE DESIGN LIMITED 1 LINDSEY STREET SMITHFIELD LONDON EC1A 9HP

Tel: 020 7332 4850 Fax: 020 7332 4888 E: mail@tatehindle.co.uk W: www.tatehindle.co



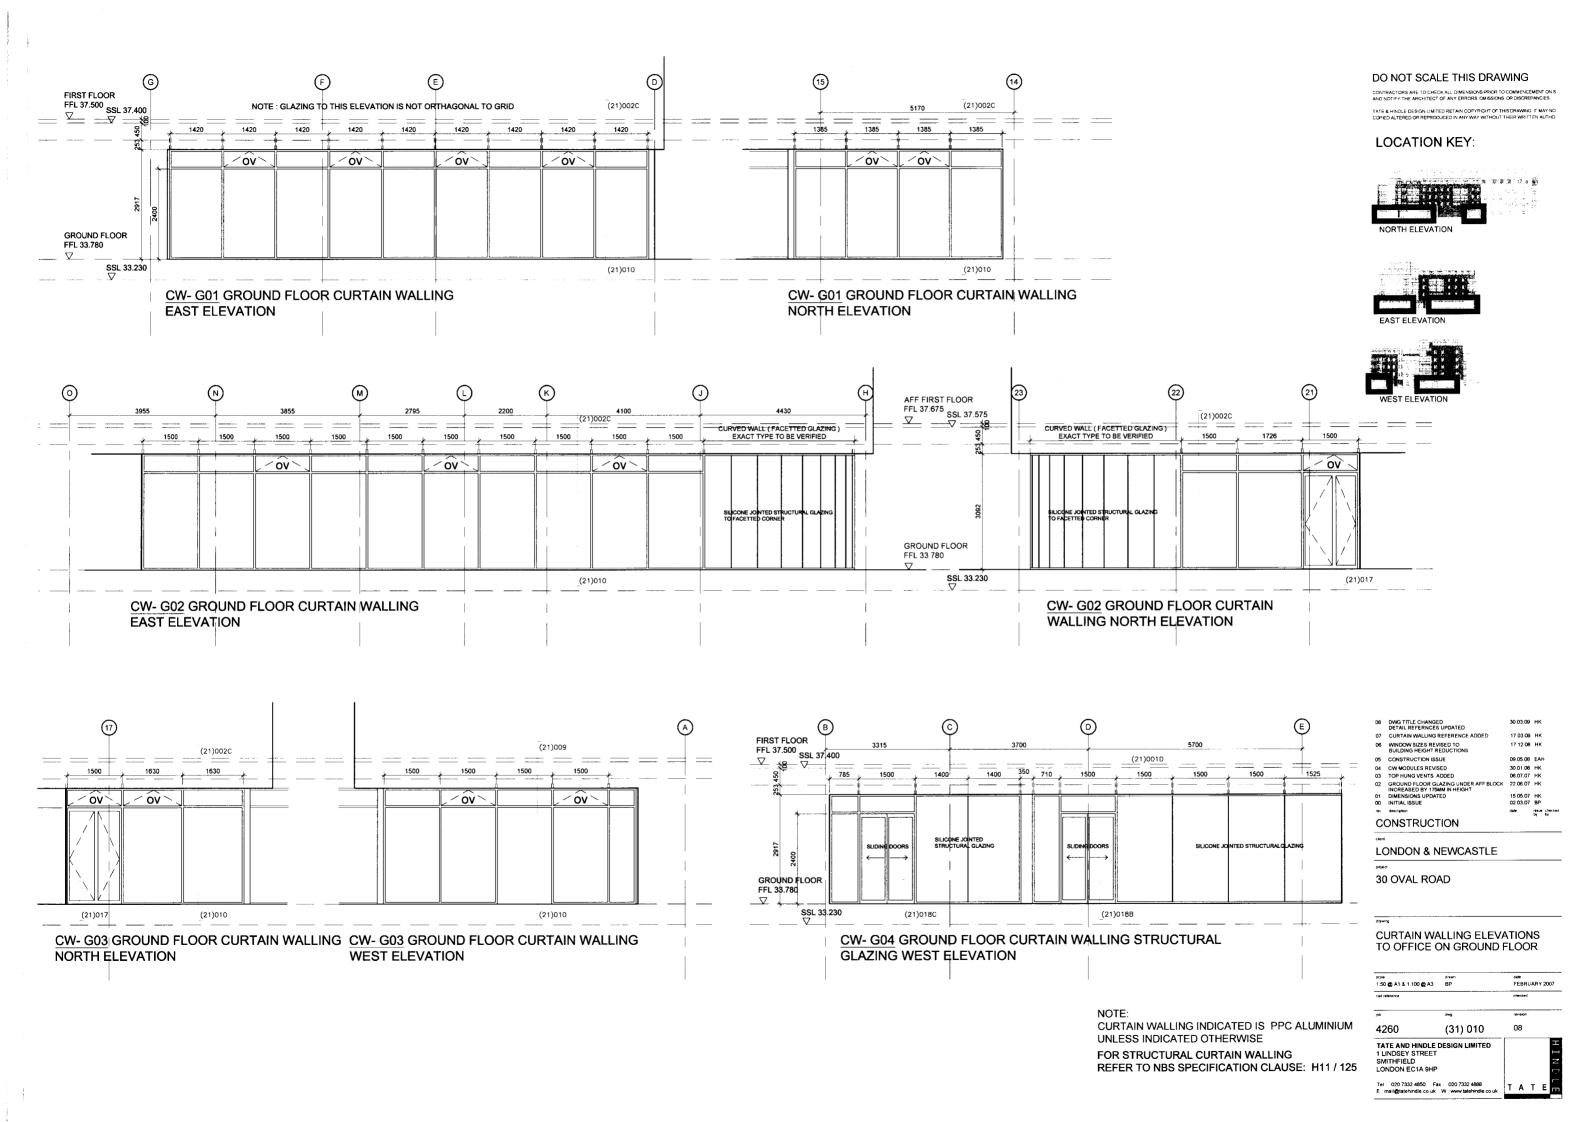

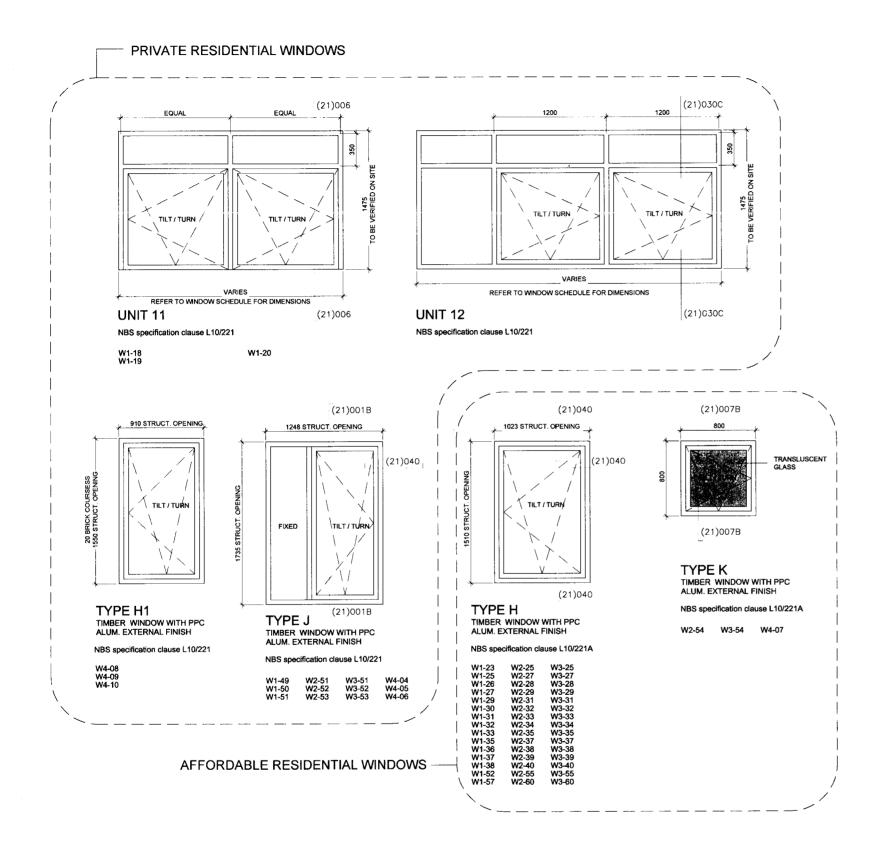



CONTRACTORS ARE TO CHECK ALL DIMENSIONS PRIOR TO COMMENCEMENT ON SITE AND NOTIFY THE ARCHITECT OF ANY ERRORS OMISSIONS OR DISCREPANCIES

TATE & HINDLE DESIGN LIMITED RETAIN COPYRIGHT OF THIS DRAWING IT MAY NO COPIED ALTERED OR REPRODUCED IN ANY WAY WITHOUT THEIR WRITTEN AUTHOR

## NOTE:

ALL DIMENSIONS INDICATED ARE APPROXIMATE
ALL OPENINGS MUST BE SITE MEASURED PRIOR TO FABRICATION
REFER TO SCHEDULE P08 FOR DIMENSIONS

WINDOWS INDICATED ARE TIMBER INTERNALLY WITH PPC ALUMINIUM EXTERNAL FACE

01	DWS TITLE CHANGED DETAIL REFERNCES UPDATED WNDOWS EXTRACTED FROM DWG (31)X02 & 003	30.03.09	нк
00	INITIAL ISSUE	22.03.07	HK
(Ov	description	date	serum checked by by
PF	RELIMINARY		
cheet			
LC	NDON & NEWCASTLE		
projec	1		
30	OVAL ROAD		

COMPOSITE WINDOW ELEVATIONS
TO AFFORDABLE AND PRIVATE
RESIDENCE

TATE AND HINDLE	DESIGN LIMITED	
4260	(31) 012	01
job	dwg	revision
cad relevence		checked
1.20 @ A1 & 1.40 @ A3	нк	FEBRUARY 200
snale	drawn	date

TATE AND HINDLE DESIGN LIMITE

LINDSEY STREET


SMITHFIELD


LONDON EC1A 9HP

Tel: 020 7332 4850 Fax: 020 7332 4888

E: mail@tatehindle co.uk W www.batehindle

32 4888 atehindle.co.uk

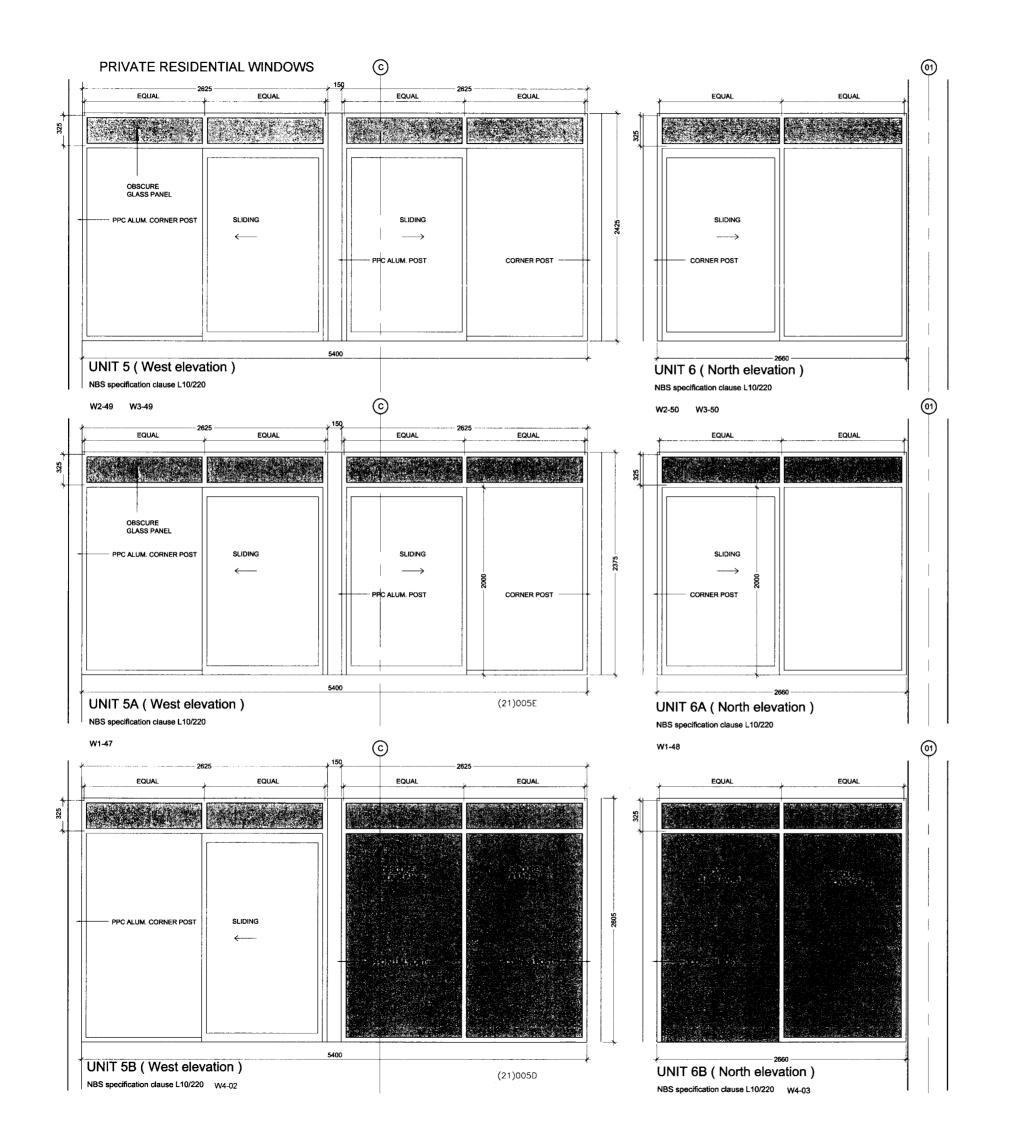

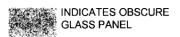

CONTRACTORS ARE TO CHECK ALL DIMENSIONS PRIOR TO COMMENCEMENT ON SITE AND NOTIFY THE ARCHITECT OF ANY ERRORS OMISSIONS OR DISCREPANCIES

TATE & HINDLE DESIGN LIMITED RETAIN COPYRIGHT OF THIS DRAWING IT MAY NOT BE COPIED ALTERED OR REPRODUCED IN ANY WAY WITHOUT THEIR WRITTEN AUTHORITY

## NOTE:


ALL DIMENSIONS INDICATED ARE APPROXIMATE
ALL OPENINGS MUST BE SITE MEASURED PRIOR TO FABRICATION
REFER TO SCHEDULE P08 FOR DIMENSIONS


WINDOWS INDICATED ARE TIMBER INTERNALLY WITH PPC ALUMINIUM EXTERNAL FACE


02	DWG TITLE CHANGED DETAIL REFERNCES UPDATED	30.03 09	нк
01	WINDOW SIZES REVISED TO 4TH/5TH FLOOR HEIGHT CHANGES	26.02.09	нк
00	WINDOWS MOVED FROM DWG 4260 (31)002 VARIATION TO WINDOW TYPES ADDED	17.12.08	нк
ıqı	description	dale	issue checked by by
C	ONSTRUCTION		
clerá	i		
LC	ONDON & NEWCASTLE		
proje	ત		
30	OVAL ROAD		


COMPOSITE WINDOW ELEVATIONS	
TO PRIVATE RESIDENCE	


scale	drawn	date
1.20 @ A1 & 1 40 @ A3	BP BP	FEBRUARY 2007
cad selerence		checked
lop	dwg	TOWNSIGN
4260	(31) 013	02

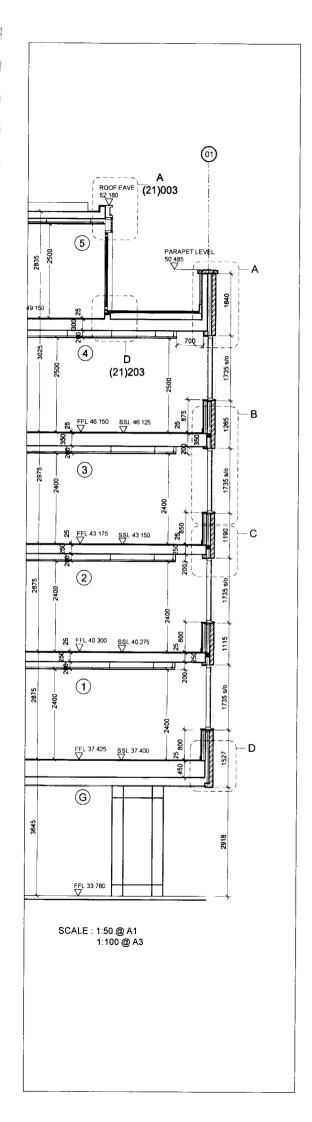

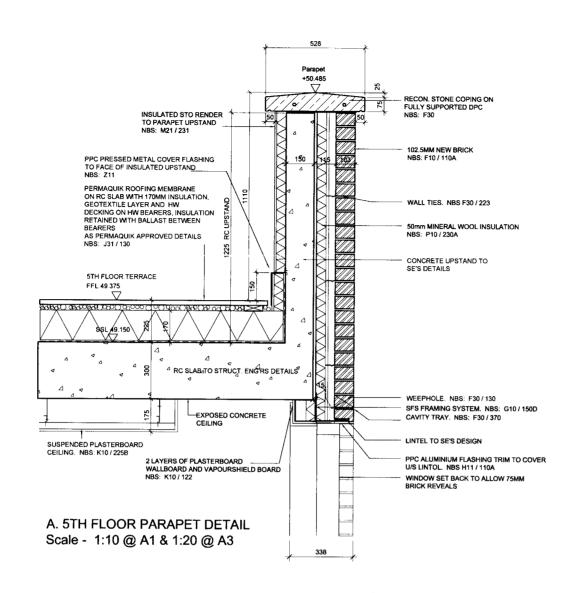

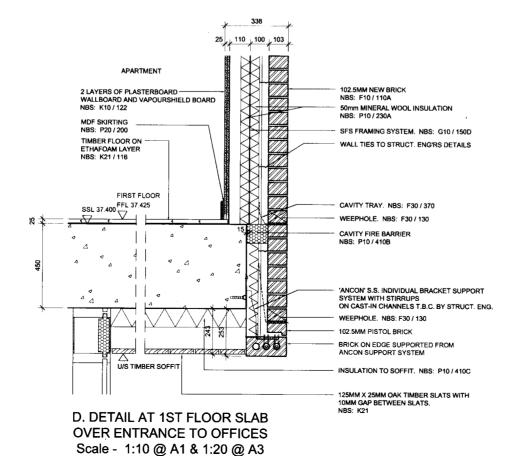

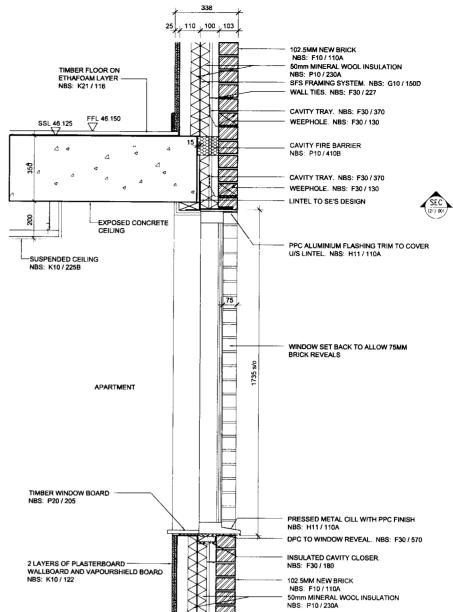

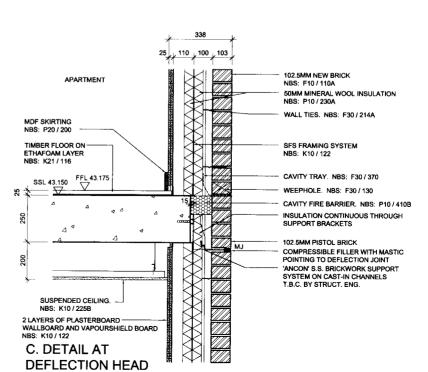

**B. DETAIL AT WINDOW** 

Scale - 1:10 @ A1 & 1:20 @ A3


Scale - 1:10 @ A1 & 1:20 @ A3

SFS FRAMING SYSTEM. NBS: G10 / 150D

## DO NOT SCALE THIS DRAWING

CONTRACTORS ARE TO CHECK ALL DIMENSIONS PRIOR TO COMMENCEMENT ( NND NOTIFY THE ARCHITECT OF ANY ERRORS OMISSIONS, OR DISCREPANCIE:

TATE & HINDLE DESIGN LIMITED RETAIN COPYRIGHT OF THIS DRAWING IT MAYING COPIED ALTERED OR REPRODUCED IN ANY WAY WITHOUT THEIR WRITTEN AUTHO

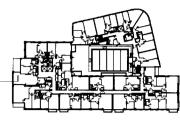

## EXTERNAL ENVELOPE DETAILS SHEET 1

scale	drawn	ciate
Varies	AM	NOVEMBER 2006
cad reference		checked
job	dwg	revision
4260	(21)001	07

SMITHFIELD LONDON EC1A 9HP Tel: 020 7332 4850 Fax: 020 7332 4888


Z TATE I

### INSULATED UPSTAND WITH CEMENTITIOUS FACING NBS: P10 / 258 REDUCED INSULATION TO 100MM APARTMENT TERRACE PERMAQUIK ROOFING MEMBRANE ON RC SLAB WITH 180MM INSULATION. GEOTEXTILE LAYER AND 50MM THICK CONCRETE PAYING SLAB ON SPACERS OR GRAVEL BALLAST. PPC ALUMINIUM CAPPING NBS: F30 MEMBRANE TO BE DRESSED UP AND OVER THE TOP OF RC UPSTANDS. NBS: J31 / 130 -2x15mm thick PPC METAL POSTS CARPET ON ETHAFOAM LAYER NBS: K21/116 PPC ALUMINIUM INSULATED FASCIA NBS: H11/110A WATERPROOFED MEMBRANE **(4)** T&G TIMBER DECKING ON TIMBER BATTENS RC SLAB TO STRUCT, ENG'RS DETAILS 150 SECOND FLOOR SSL 40.390 FFL 40.405 EXTENT OF INSUL. T.B.C. FALLS 1 in 80 FFL 46.035 SSL 46.02 PROVISION FOR CURTAIN FIXING INSULATED GLASS PANEL 200 T.B.S. BY SPECIALIST SUSPENDED PLASTERBOARD CEILING NBS: K10 / 225B (3) A. ROOF PARAPET TIMBER SLATS TO SOFFIT FIXED THE SAME DIRECTION AS DECKING SUSPENDED PLASTERBOARD CEILING NBS: K10 / 225B FFL 43.220 SSL 43.205 INSULATED ALUMINIUM PANEL WITH INTEGRATED FIRE STOP TO WINDOW SUB-CONTRACTOR'S DESIGN INSULATED GLASS PANEL NBS: H11 / 110A 2 B. BALCONY DETAIL PROVISION FOR CURTAIN FIXING Scale - 1:10 @ A1 & 1:20 @ A3 FFL 40.405 SSL 40.390 AFFORDABLE APARTMENT (1) 46.875 50mm Ø PPC HANDRAI FIXED TO 22MM Ø PPC STEM NBS: L30 || 3 × APARTMENT T/O CILL FFL 37.590 SSL 37 57 VAPOUR BARRIER NBS: P10 / 442 DPC BELOW COPING NBS: F30 / 570 PLASTERBOARD NBS: K10 / (G) RECON. STONE CILL NBS: F30 / 720 102.5MM RED BRICK NBS: F10 / 110A 2 LAYERS PLASTERBOARD ON SFS. NBS: K10 VAPOUR BARRIER NBS: P10 / 442 MINERAL WOOL INSULATION THICKNESS T.B.C. NBS: F30 / 155A CARPET ON ETHAFOAM LAYER NBS: K21 / 116 102.5MM NEW BRICK NBS: F10 / 110A MDF SKIRTING NBS: P20 / 200 CONCRETE UPSTAND TO SE'S DETAIL CARPET ON ETHAFOAM LAYER NBS: K21 / 116 WALL TIES. NBS: F30 / 223 **FOURTH FLOOR** 50mm MINERAL WOOL INSULATION NBS: P10 / 230A CAVITY TRAY. NBS: F30 / 370 SSL 46.020 FFL 46.035 WEEPHOLE. NBS: F30 / 130 FIRST FLOOR SFS FRAMING SYSTEM NBS: G10 / 150D FFL 37.590 SSL 37.575 CAVITY FIRE BARRIER NBS: P10 / 410B RC SLAB TO STRUCT, ENG'RS DETAILS SCALE: 1:50 @ A1 CAVITY FIRE BARRIER, NBS: P10 / 4108 1:100 @ A3 CAVITY TRAY, NBS: F30 / 370 INSULATION CONTINUOUS THROUGH SUPPORT BRACKETS WEEPHOLE. NBS: F30 / 130 CAVITY TRAY NBS: F30 / 370 RECESSED STRETCHER SUSPENDED PLASTERBOARD CEILING NBS: K10 / 225B WEEPHOLE. NBS: F30 / 130 'ANCON' S.S. INDIVIDUAL BRACKET SUPPORT SYSTEM WITH STIRRUPS ON CAST-IN CHANNELS T.B.C. BY STRUCT. ENG. BRICK ON EDGE SUPPORTED FROM ANCON SUPPORT SYSTEM INSULATED SPANDREL PANEL 100MM ROCKSILK UNIVERSAL SLAB RS80 NBS: P10 / 410C A. CURTAIN WALLING DOUBLE GLAZED CURTAIN WALL SYSTEM NBS: H11/110A C. 1ST FLOOR RECESSED LIGHTING IN TIMBER SOFFIT TO OPIUS DESIGN CONSULTANTS DETAILS **DETAIL TO 4TH FLOOR** CURTAIN WALL SET BACK TO ALLOW 75MM BRICK REVEALS WINDOW CILL 125MM X 25MM OAK TIMBER SLATS. NBS: K21 AFFORDABLE BLOCK **DETAIL TO** Scale - 1:10 @ A1 & 1:20 @ A3 AFFORDABLE BLOCK Scale - 1:10 @ A1 & 1:20 @ A3

## DO NOT SCALE THIS DRAWING

CONTRACTORS ARE TO CHECK ALL DIMENSIONS PRIOR TO COMMENCEMENT ON S AND NOTIFY THE ARCHITECT OF ANY ERRORS OMISSIONS OR DISCREPANCIES

TATE & HINDLE DESIGN LIMITED RETAIN COPYRIGHT OF THIS DRAWING IT MAY NO COPIED ALTERED OR REPRODUCED IN ANY WAY WITHOUT THEIR WRITTEN AUTHO

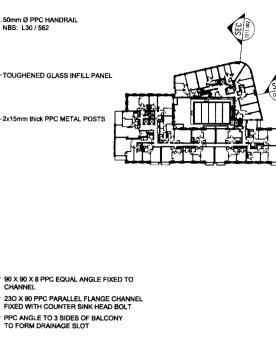

SUSPENDED CEILUNG CHANGED TO 200MM BALCONY CONSTRUCTION REVISED TO STEEL  05 NBS REFS ADDED. KEY PLAN ADDED 15.06.0  04 FEL TO 1ST-4TH AFF AND 1ST-3RD PRIV. 14.02.0  15 LOWREDB YS 0MM AND RESILIENT TIMBER FLOOR CHANGED TO TIMBER ON ETHAFOAM LAYER BALCONY DETAIL REVISED 25.0  15 TIMBER HANDRAIL REPLACED BY PPC SS CHANNEL CHANGED TO ALUMINIUM FASCIA AS PER VE LIST 12.0  12 SPS REPLACED BY CONCRETE UPSTAND 22.06.0  15 WINDOW HEAD, CILL, PARAPET & BALUSTRADE 12.03.0  16 TAILS REVISED - OAS SOFFIT ADDED TO BALCONY - ROOOFING SPEC REVISED 10.0  17 TIME OF THE ORDER CHANGED 10.0  18 OF THE ORDER CHANGED 10.0  19 FOR INFORMATION AND COMMENT 10.0  10 CONSTRUCTION 10.0  CONSTRUCTION 10.0  10 STRUCTION 10.0  10 TO STRUCTION 10.	Dy
SUSPENDED CEILING CHANGED TO 200MM BALCONY CONSTRUCTION REVISED TO STEEL	
SUSPENDED CEILING CHANGED TO 200MM BALCONY CONSTRUCTION REVISED TO STEEL  5 NBS REFS ADDED. KEY PLAN ADDED  15 05 02  FF. TO 1ST-4TH AFF AND IST-3RD PRIV. 14 02 02  AND RESIDED BY 50 MM. FROOT CHANGED TO AND RESIDENT HIS CONTROL OF THE CONTROL ON THE CONTROL OF	issi by
SUSPENDED CELLING CHANGED TO 200MM BALCONY CONSTRUCTION REVISED TO STEEL  55 NBS REFS ADDED. KEY PLAN ADDED. 15 05 02  46 FFL TO 1ST-4TH AFF AND 1ST-3RD PRIV. LOWERED BY 50 MM AND RESILIENT TIMBER FLOOR CHANGED TO TIMBER ON ETHAFOAM LAYER BALCONY DETAIL REVISED.  53 TIMBER HANDRAIL REPLACED BY PPC S/S CHANNEL CHANGED TO ALUMINIUM FASCIA AS PER YELIST 102  57 ST REPLACED BY CONCRETE UPSTAND 22 08 0. SSUFET TO AFFORDABLE CHANGED  58 SUFET TO AFFORDABLE CHANGED  10 WINDOW HEAD. CILL PARAPET & BALUSTRADE 12 03 0. DETAILS REVISED. CAS OFFIT ADDED TO	н
SUSPENDED CEILING CHANGED TO ZOOMM BALCONY CONSTRUCTION REVISED TO STEEL  15 NBS REFS ADDED. KEY PLAN ADDED.  15 05 02  15 FEL TO 15T-4TH AFF AND 15T-3RD PRIV. LOWERED BY 50 MM AND RESILIENT TIMBER FLOOR CHANGED TO TIMBER ON ETHAFOAM LAYER  10 TIMBER WHOOD THAN THE PRIVACED BY PRO  22 10.03  10 TIMBER WHOOD ALL PRIVACED BY PRO  25 10 TIMBER WHOOD ALL WINNIUM FASCIA  26 SPE REVELIST AND 22 08 05  27 SPE REVELIST ALL WINNIUM FASCIA  28 SPE REVELIST AND 22 08 05	н
SUSPENDED CEILING CHANGED TO ZOOMM	' н
SUSPENDED CEILING CHANGED TO ZOOMM BALCONY CONSTRUCTION REVISED TO STEEL  15 NBS REFS ADDED. KEY PLAN ADDED.  15 06 04  FEL TO 1ST-4TH AFF AND 1ST-3RD PRIV. LOWERED BY 50 MM. AND RESILIENT TIMBER FLOOR CHANGED TO TIMBER ON ETHAFOAM UNDER THE	' н
SUSPENDED CEILING CHANGED TO 200MM	
SUSPENDED CEILING CHANGED TO 200MM BALCONY CONSTRUCTION REVISED TO STEEL	н
SUSPENDED CEILING CHANGED TO 200MM	E
05 FFL CHANGED TO 25MM 10.09 0	Н
07 AMENDED TO REFLECT REDUCTION OF 13.01.0 BUILDING HEIGHT	H


## **EXTERNAL ENVELOPE DETAILS** SHEET 2


NOVEMBER 2006 checked
checked
revision
07


TATE AND HINDLE DESIGN LIMITED 1 LINDSEY STREET SMITHFIELD

30 OVAL ROAD



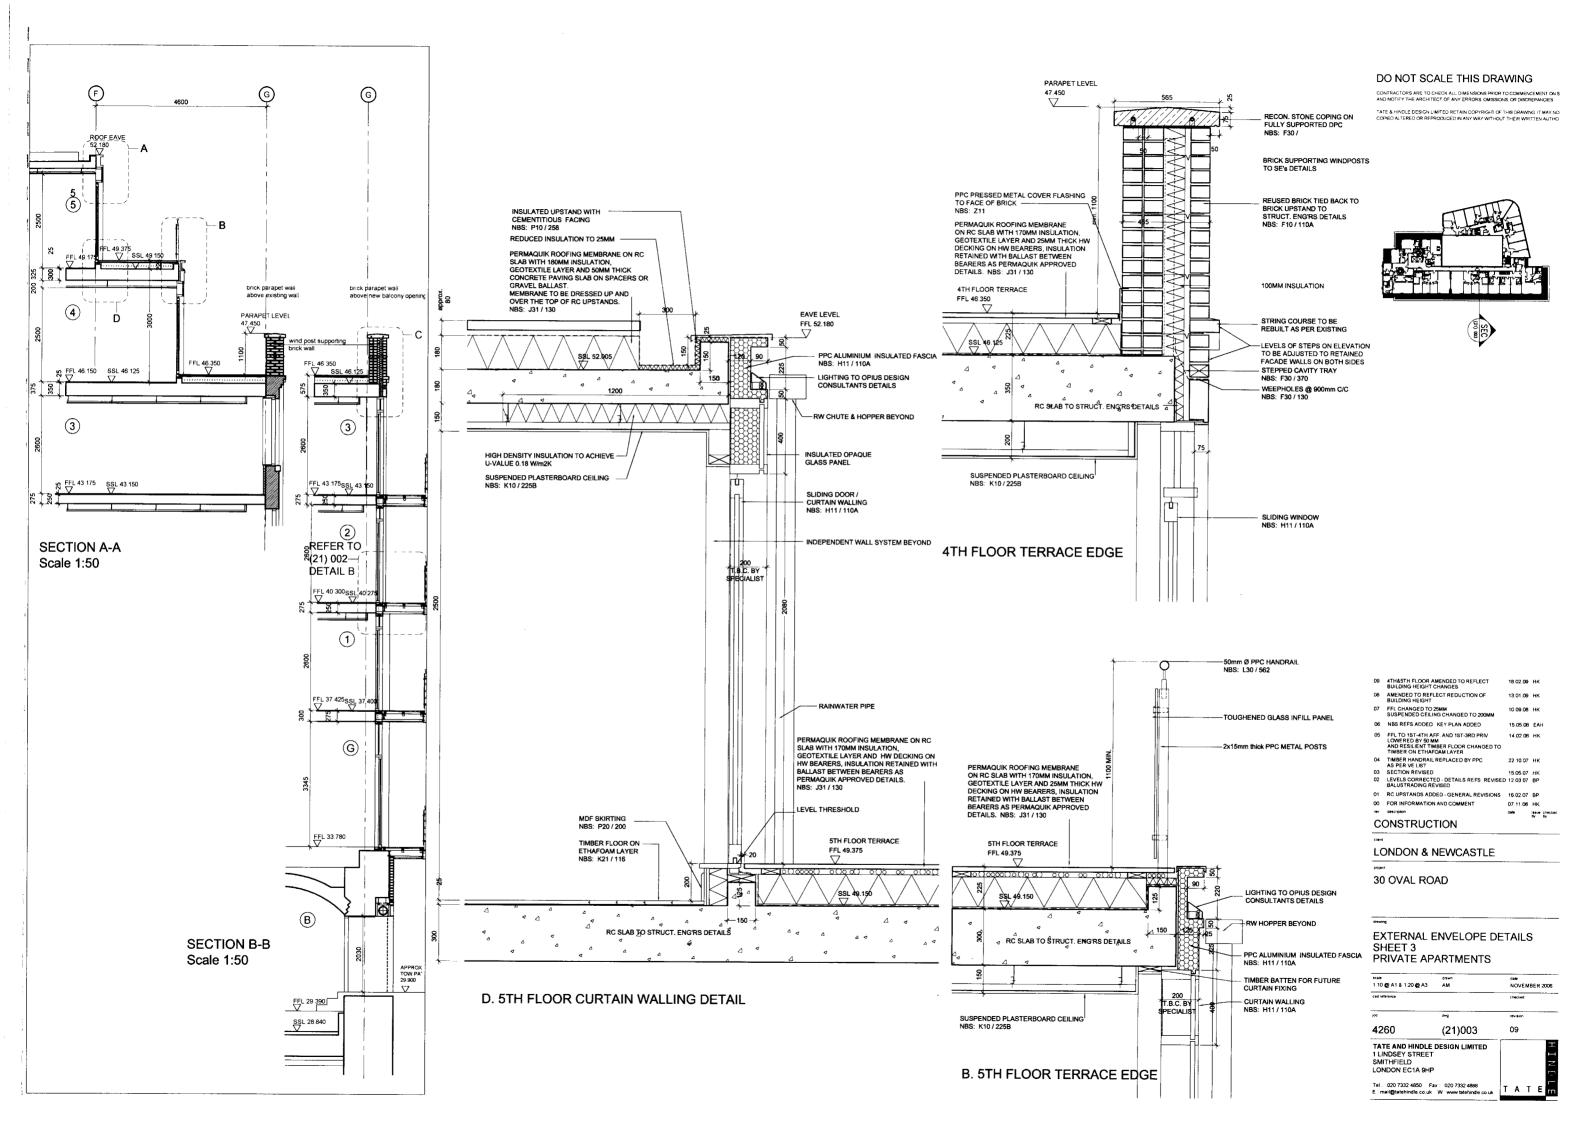


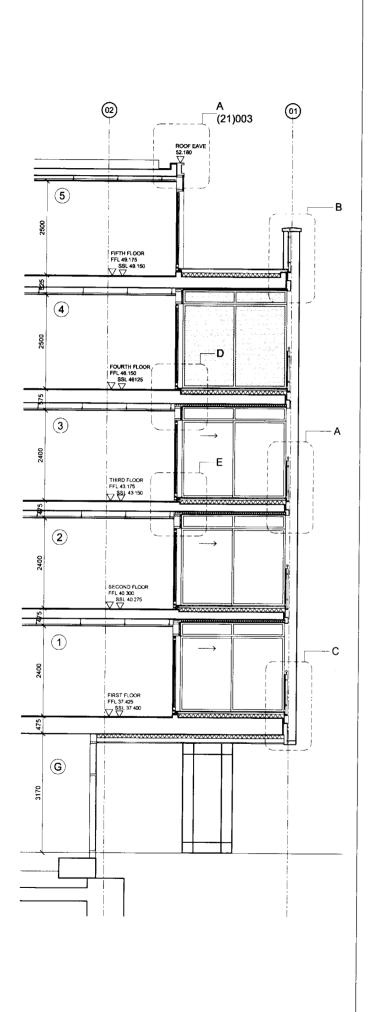

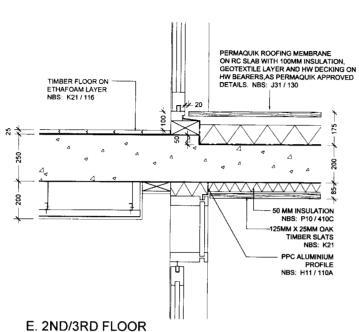


WINDOW CILL&HEAD DETAIL


Scale - 1:10 @ A1 & 1:20 @ A3

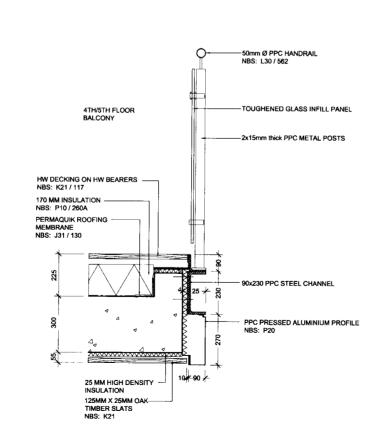

B. BALCONY DETAIL Scale - 1:10 @ A1 & 1:20 @ A3

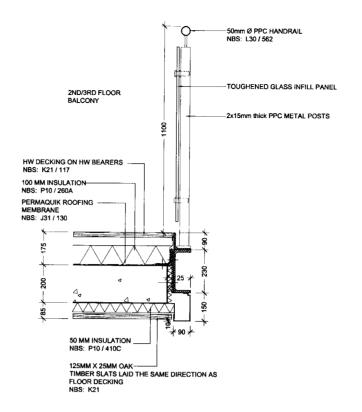


A. BALCONY DETAIL Scale - 1:10 @ A1 & 1:20 @ A3

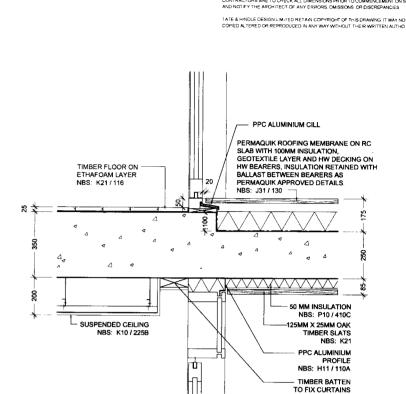

DO NOT SCALE THIS DRAWING

D. 4TH FLOOR
WINDOW CILL&HEAD DETAIL
Scale - 1:10 @ A1 & 1:20 @ A3

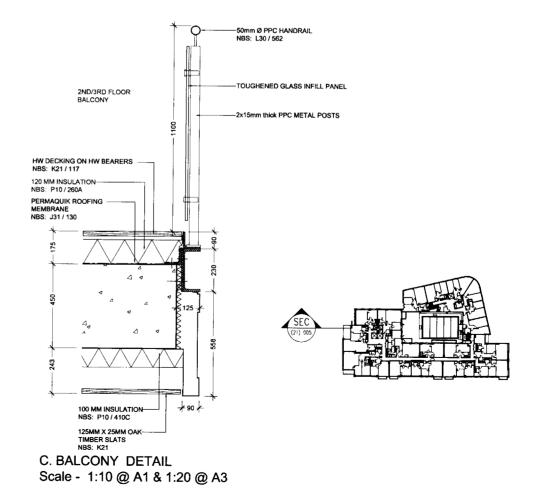

EXTERNAL ENVELOPE DETAILS

05 AMENDED TO REFLECT REDUCTION OF BUILDING HEIGHT

BALUSTRADE ALUMINIUM FASCIA CHA TO STEEL CHANNEL D3 NBS REFS ADDED. KEY PLAN ADDED

CONSTRUCTION

30 OVAL ROAD

02 FFL TO 1ST-4TH AFF AND 1ST-3RD PRIV. LOWERED BY 50 MM AND RESILIENT TIMBER FLOOR CHANGED TO TIMBER ON ETHAFOAM LAYER

1 TIMBER ON E I PAP-CAM LAYER

1 TIMBER HANDRAIL REPLACED BY PPC
S/S CHANNEL CHANGED TO ALUMINIUM FASCIA
AS PER VEUST

PP OF INFORMATION AND COMMENT


PP Georophon


LONDON & NEWCASTLE


14.02.08 HK


30.03 07 HK


scale	drawn	date	
1:10 @ A1 & 1:20 @ A3	HK	MARCH	2007
cad reference		checked	
lop	dwg	revision	
4260	(21)005	06	
TATE AND HINDLE	DESIGN LIMITED		
1 LINDSEY STREET			
SMITHFIELD			
LONDON EC1A 9HP			- 1

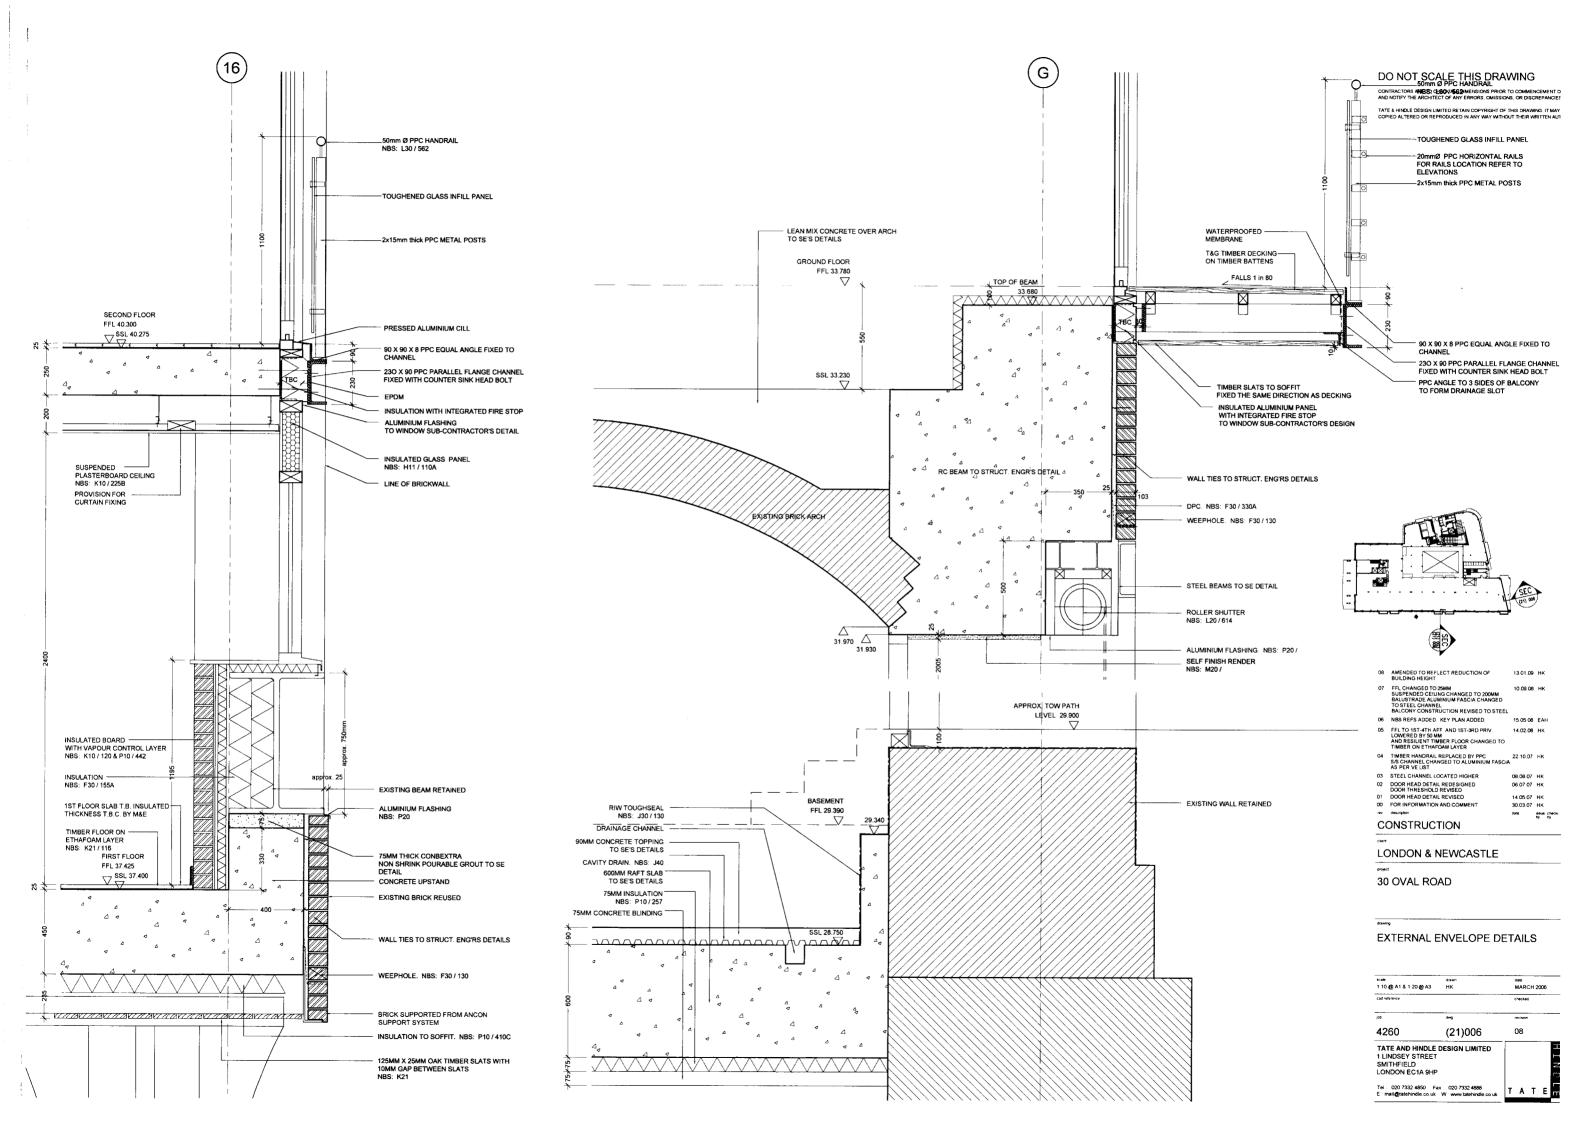

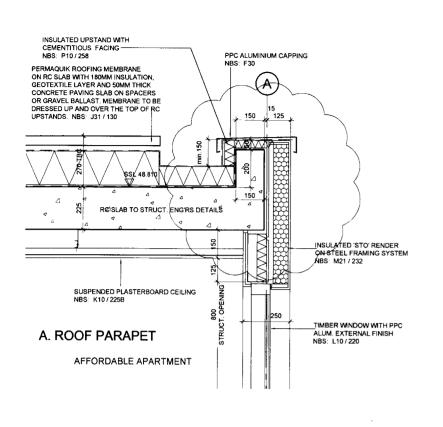

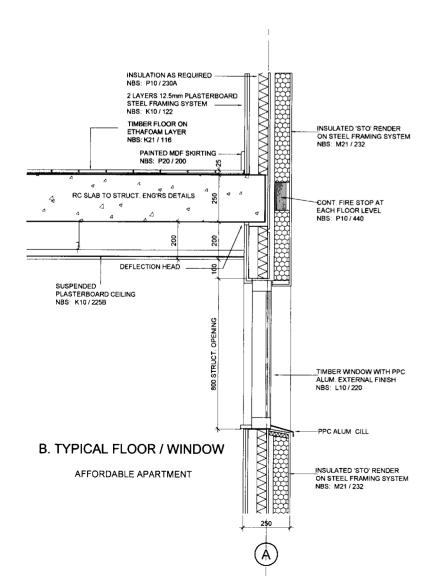

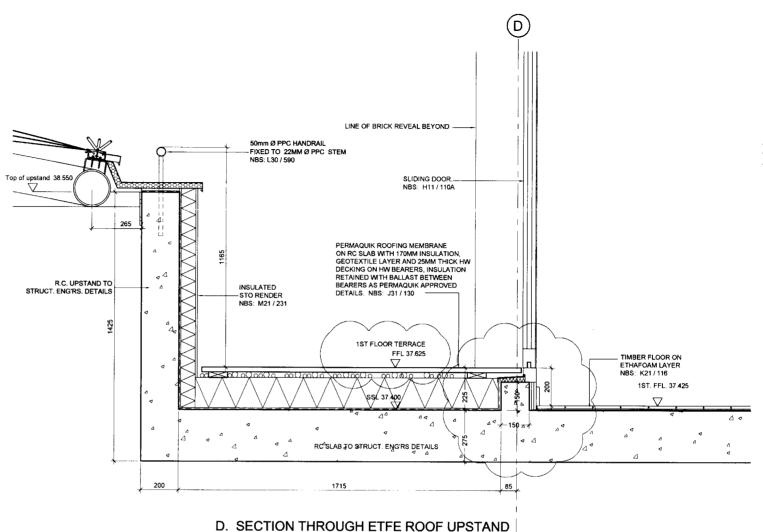

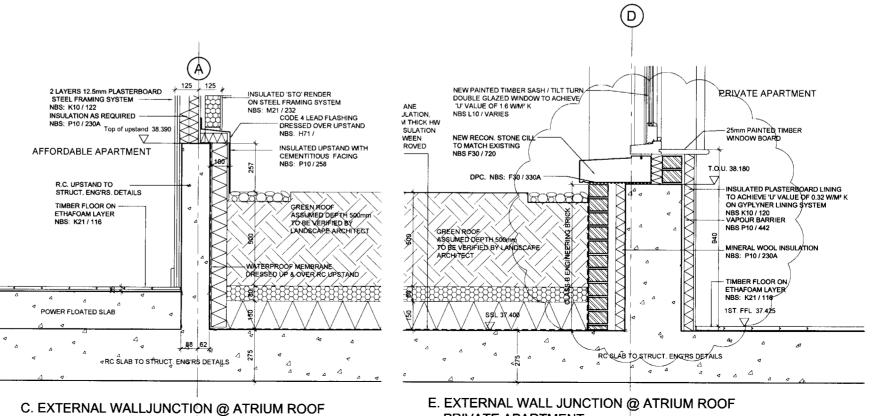

AFFORDABLE APARTMENT


PRIVATE APARTMENT

AND PRIVATE 1ST FLOOR TERRACE

DO NOT SCALE THIS DRAWING

CONTRACTORS ARE TO CHECK ALL DIMENSIONS PRIOR TO COMMENCEMENT O AND NOTIFY THE ARCHITECT OF ANY ERRORS, OMISSIONS, OR DISCREPANCIES

TATE & HINDLE DESIGN LIMITED RETAIN COPYRIGHT OF THIS DRAWING, IT MAY COPIED ALTERED OR REPRODUCED IN ANY WAY WITHOUT THEIR WRITTEN AUT

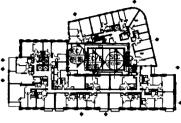

06 LEVELS REVISED TO CHANGED BUILDING HEIGHT RC UPSTANDS UPDATED

5 SECTION D REVISED
UPSTAND LEVEL REVISED,
GANTRY SYSTEM OMMITED,
RAILING REVISED
SECTION OF REVISED UPSTAND LEVEL
NBS REFS ADDED KEY PLAN ADDED

04 UPSTAND HEIGHT REVISED UPSTAND HEIGHT REVISED
FFL TO 1ST-4TH AFF AND 1ST-3RD PRIV
LOWERED BY 50 MM
AND RESILIENT TIMBER FLOOR CHANGED TO
TIMBER ON ETHAFOAM LAYER
CONCRETE UPSTAND TO TERRACE REVISED

 02
 SOIL DEPTH REDUCED AROUND ATRIUM ROOF
 06 07 07
 HK

 INSULATION INDICATED IN SOIL LAYERS
 14.05 07
 HK

 01
 CLEANING BRIDGE AND VENTS INCORPORATED TO DESIGN
 14.05 07
 HK

CONSTRUCTION

LONDON & NEWCASTLE

30 OVAL ROAD


## EXTERNAL ENVELOPE DETAILS TO ATRIUM


scale 1:10 @2 A1 & 1:20 @2 A3	drawn BP	date MARCH 2007
cad reference	-	cnecked
ob	dwg	revision.
4260	(21)007	06

TATE AND HINDLE DESIGN LIMITED
1 LINDSEY STREET
SMITHFIELD


LONDON EC1A 9HF Tel : 020 7332 4850 Fax : 020 7332 4888 E : mail@tatehindle.co.uk W : www.tatehindle.co.ul


issue checks by by

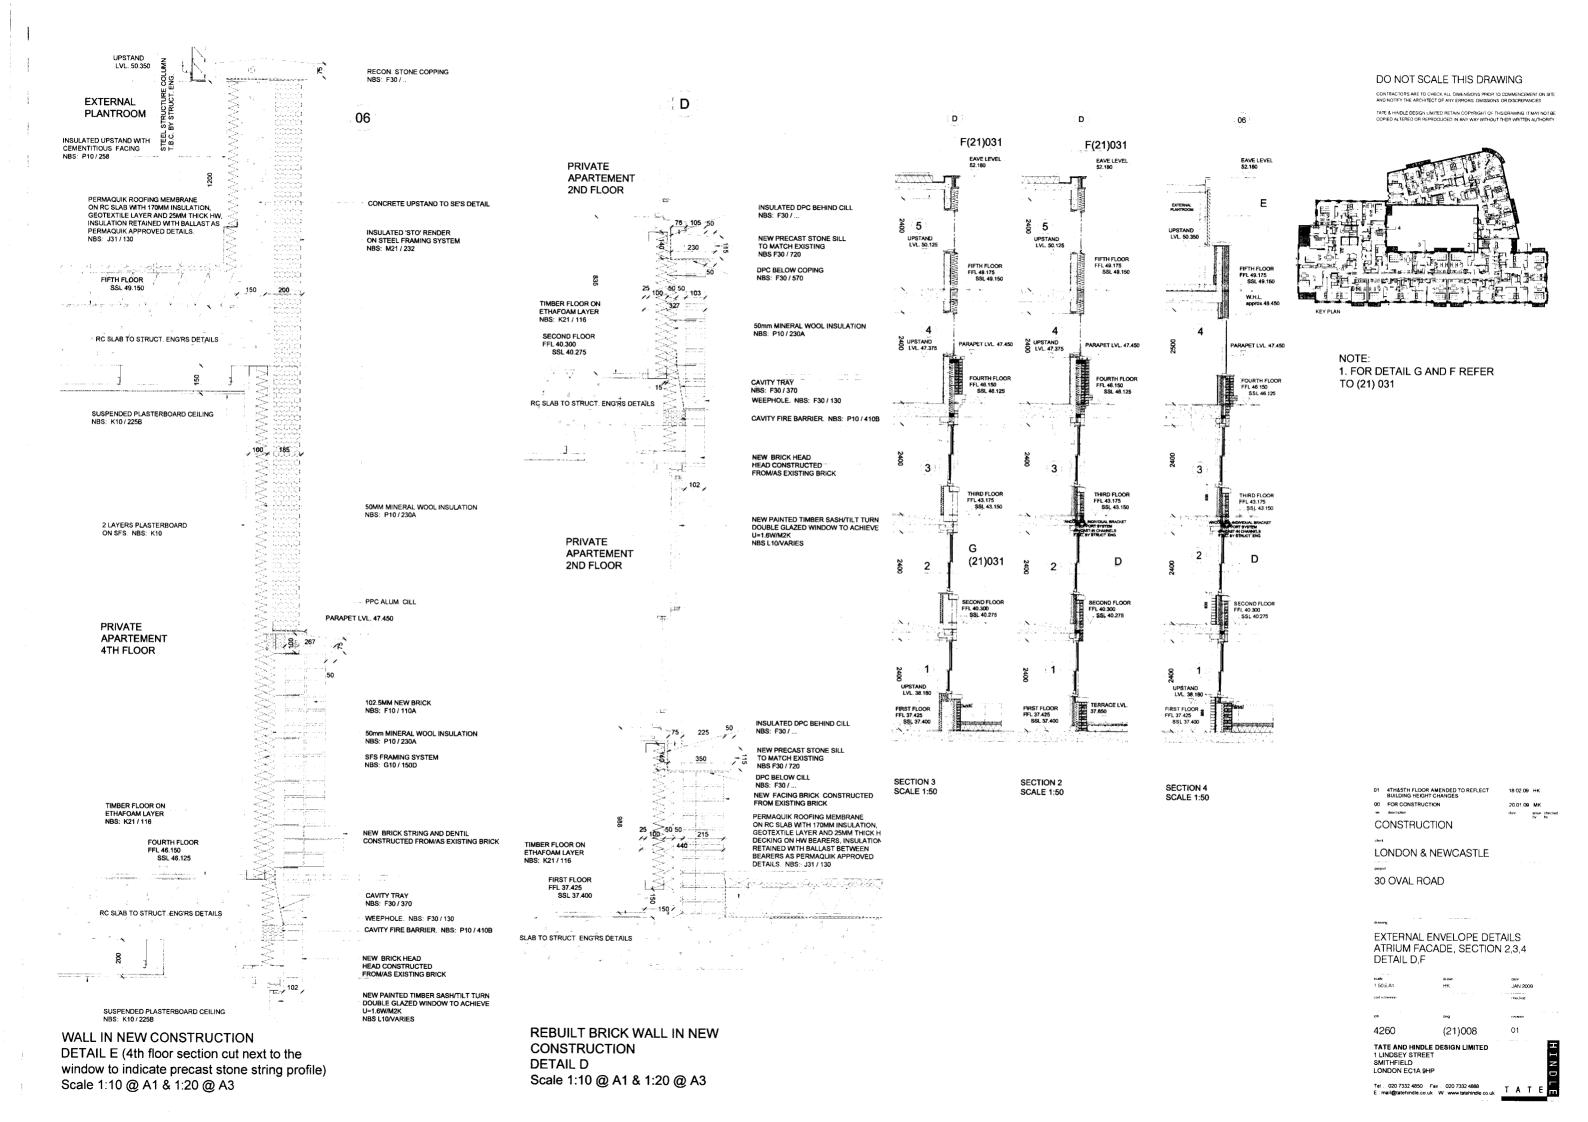

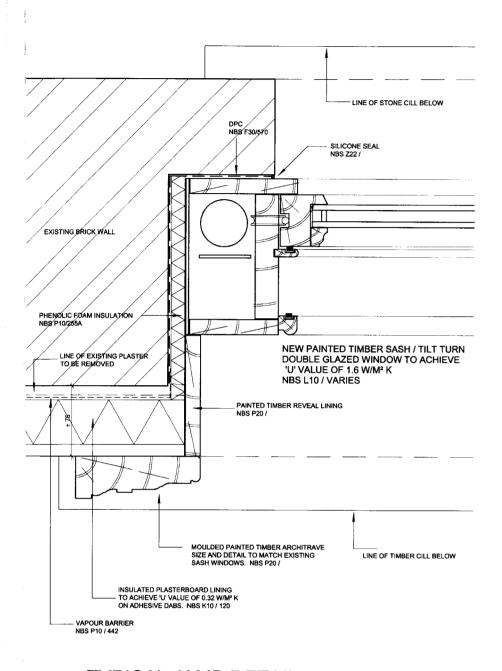


TYPICAL JAMB DETAIL

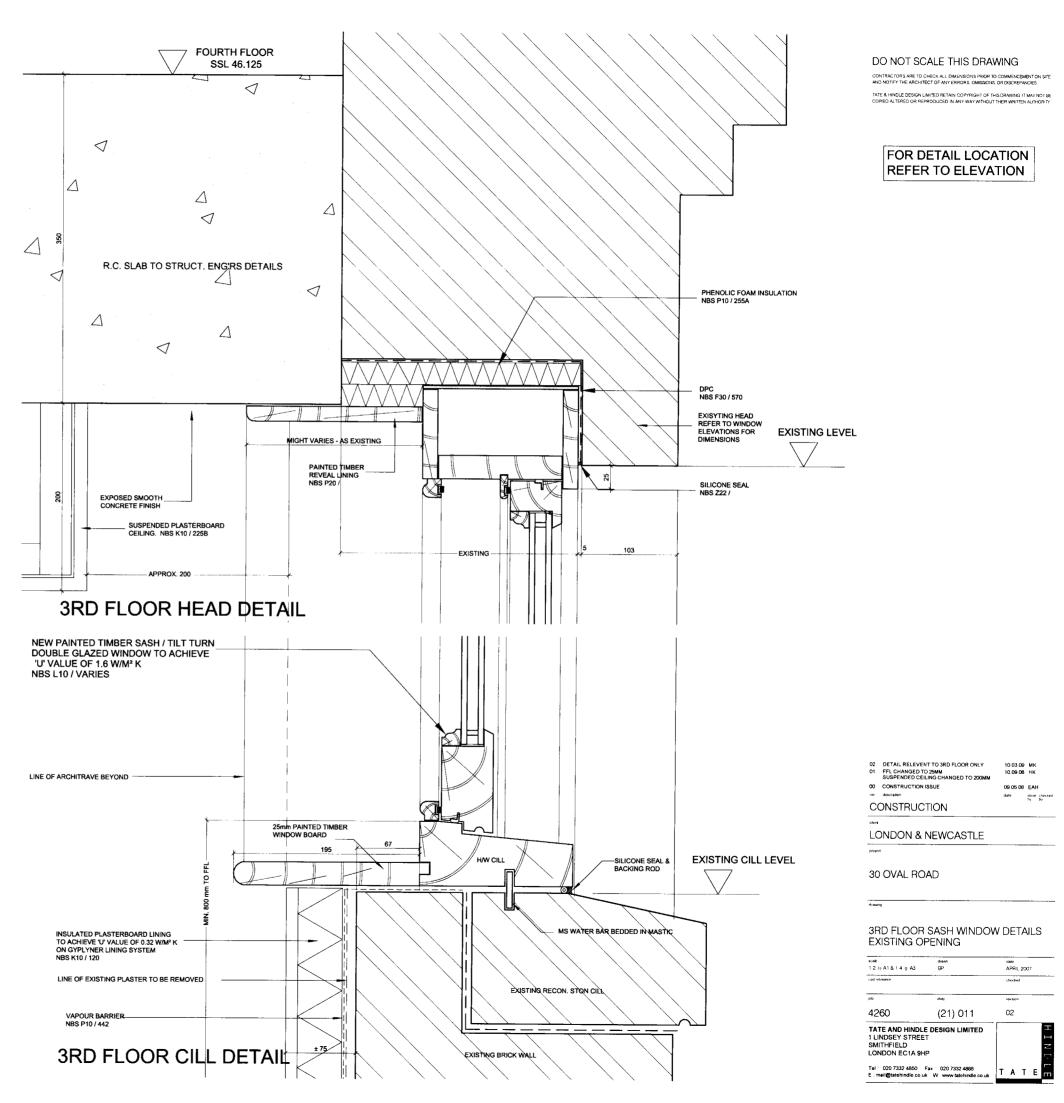


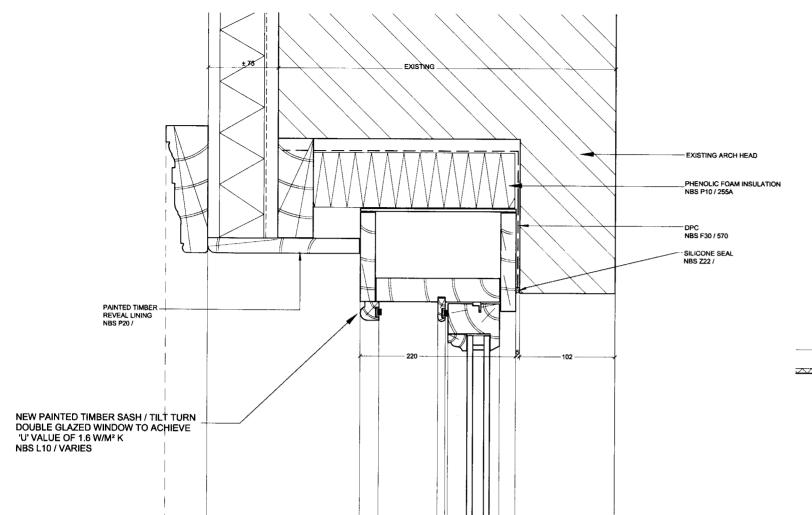

3RD FLOOR HEAD DETAIL TO EXISTING WINDOWS

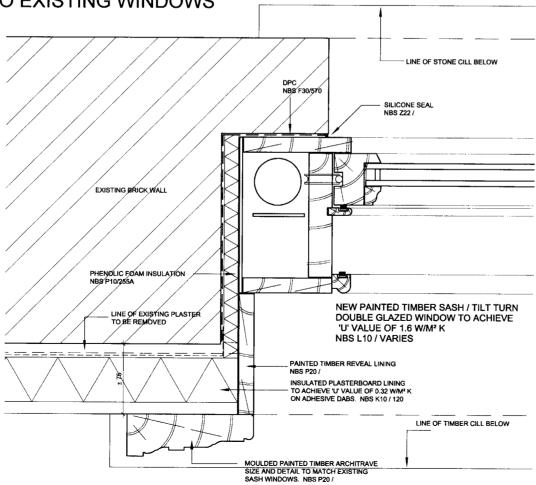

TYPICAL JAMB DETAIL

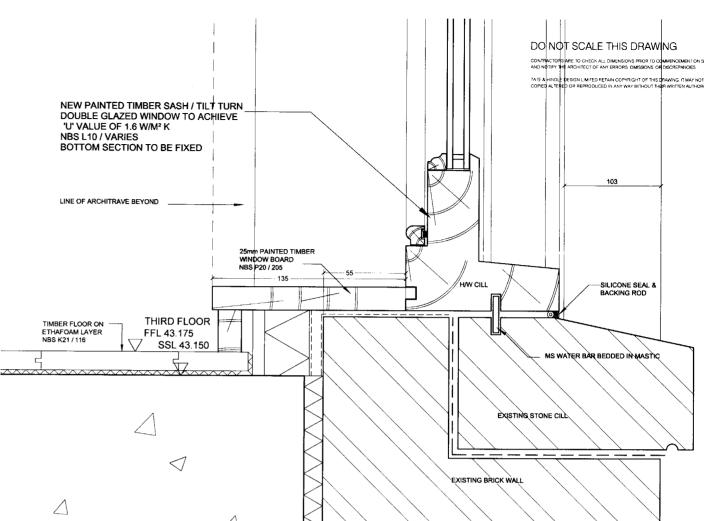

FOR DETAIL LOCATION

REFER TO ELEVATION

3RD FLOOR CILL DETAIL AT LEVEL OF FFL

02 DETAIL RELEVENT TO 3RD FLOOR ONLY
01 FFL CHANGED TO 25MM
SUSPENDED CEILING CHANGED TO 200MM
00 CONSTRUCTION ISSUE
09 05 08 EAH
dut of the second of the s


3RD FLOOR SASH WINDOW DETAILS ARCH HEAD, EXISTING OPENING


TATE AND HINDLE DESIGN LIMITED 1 LINDSEY STREET SMITHFIELD LONDON EC1A 9HP

LONDON EC1A 9HP

Tel: 020 7332 4850 Fax: 020 7332 4888
E mail@tatehindle.co.uk W: www.tatehindle.co.uk

uk TATE

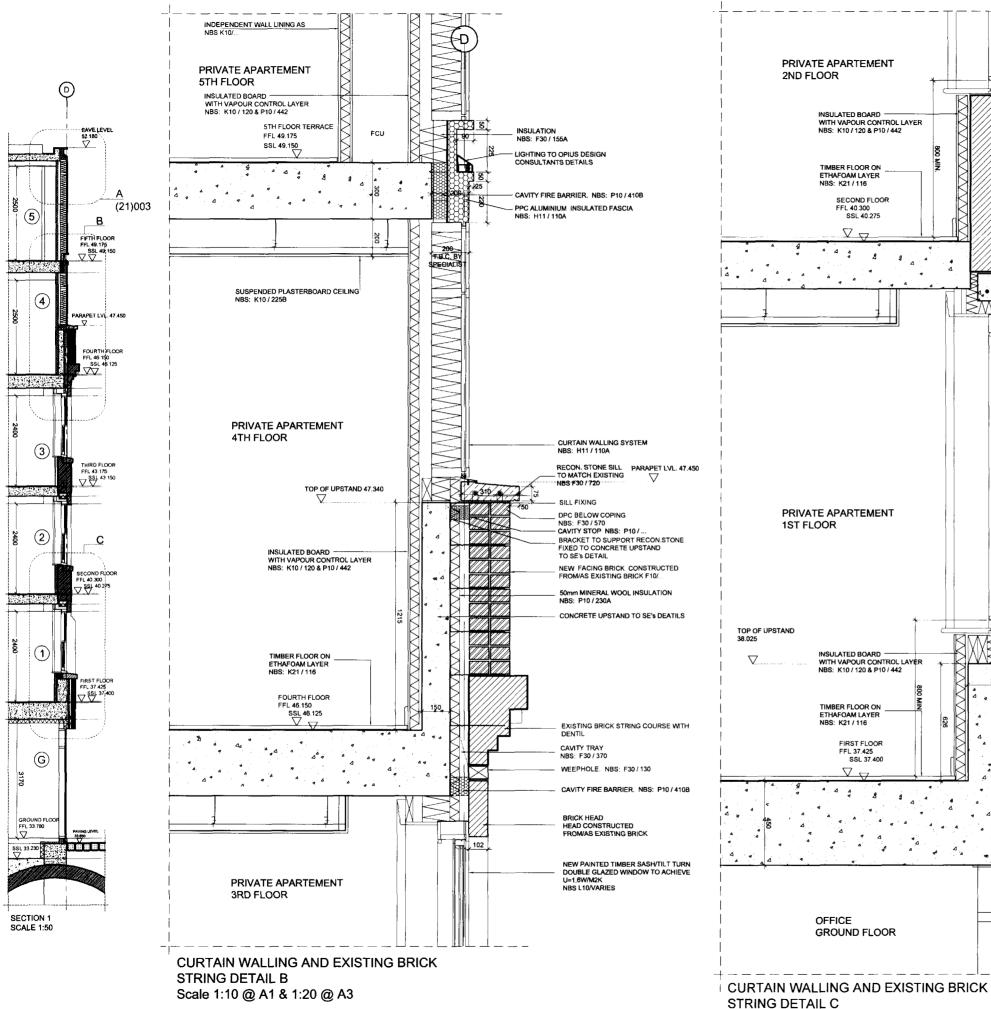


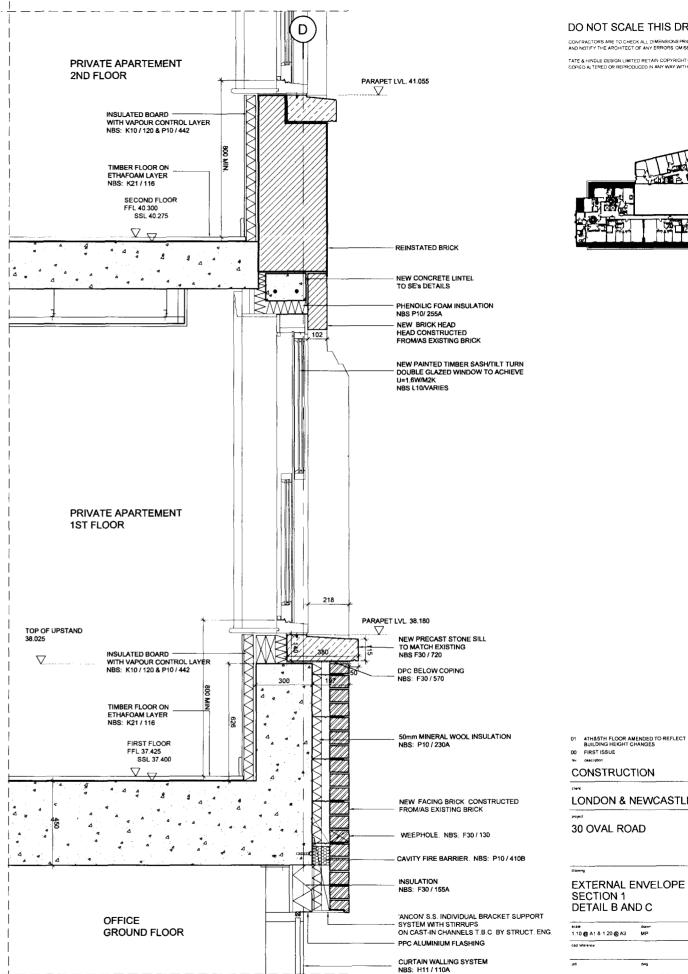

Scale 1:10 @ A1 & 1:20 @ A3

DO NOT SCALE THIS DRAWING

CONTRACTORS ARE TO CHECK ALL DIMENSIONS PRIOR TO COMMENCEMENT ON S AND NOTIFY THE ARCHITECT OF ANY ERRORS OMISSIONS OR DISCREPANCIES

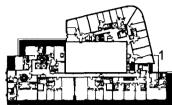

CONSTRUCTION

LONDON & NEWCASTLE

30 OVAL ROAD


EXTERNAL ENVELOPE DETAILS SECTION 1


DETAIL B AND C 1.10 @ A1 & 1.20 @ A3

issue checks by by

01 4260 (21)030

TATE AND HINDLE DESIGN LIMITED
1 LINDSEY STREET
SMITHFIELD
LONDON EC1A 9HP

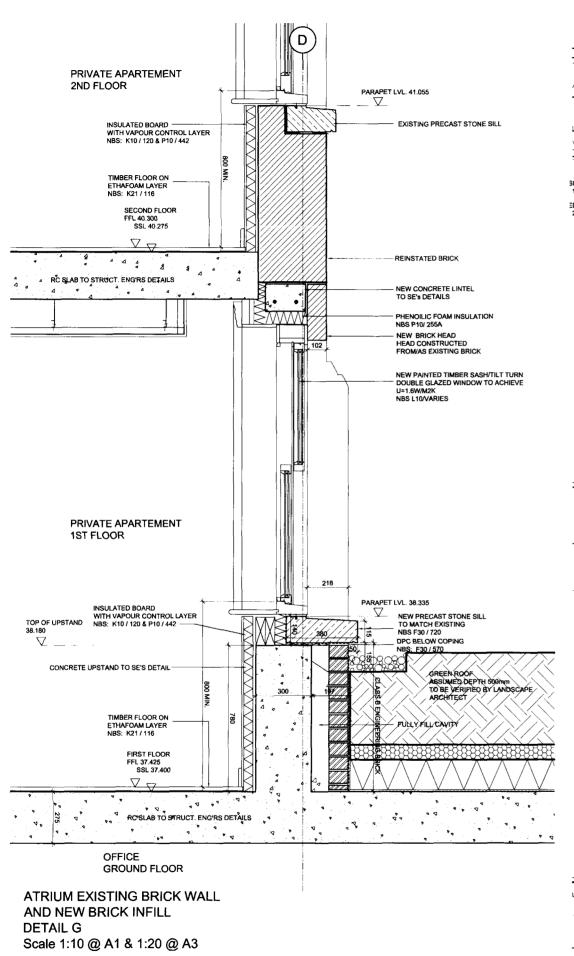

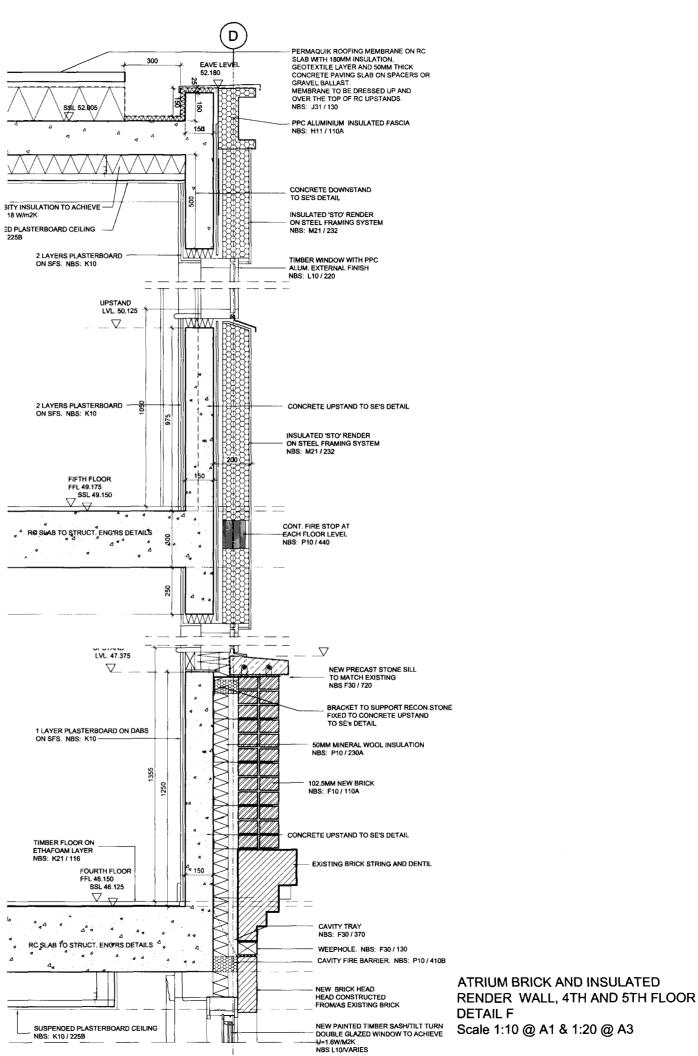

CONTRACTORS ARE TO CHECK ALL DIMENSIONS PRIOR TO COMMENCEMENT AND NOTIFY THE ARCHITECT OF ANY ERRORS, OMISSIONS OF DISCREPANCIE

TATE & HINDLE DESIGN LIMITED RETAIN COPYRIGHT OF THIS DRAWING IT MAY NOT

NOTE: 1. FOR DETAIL LOCATION REFER TO (21) 008


01 4TH&5TH FLOOR AMENDED TO REFLECT BUILDING HEIGHT CHANGES
0 FOR CONSTRUCTION 21 01 08 MK date but the second of the construction but the description but the description but the description but the second of the construction but the second of the second of the second of the construction but the second of the


EXTERNAL ENVELOPE DETAILS ATRIUM FACADE DETAIL F ANF G


TATE AND HINDLE DESIGN LIMITED
1 LINDSEY STREET
SMITHFIELD
LONDON EC14 OHD

SMITHFIELD
LONDON EC1A 9HP

Tel: 020 7332 4850 Fax: 020 7332 4888
E: mail@taletrindle.co.uk W www.batehindle.co.uk

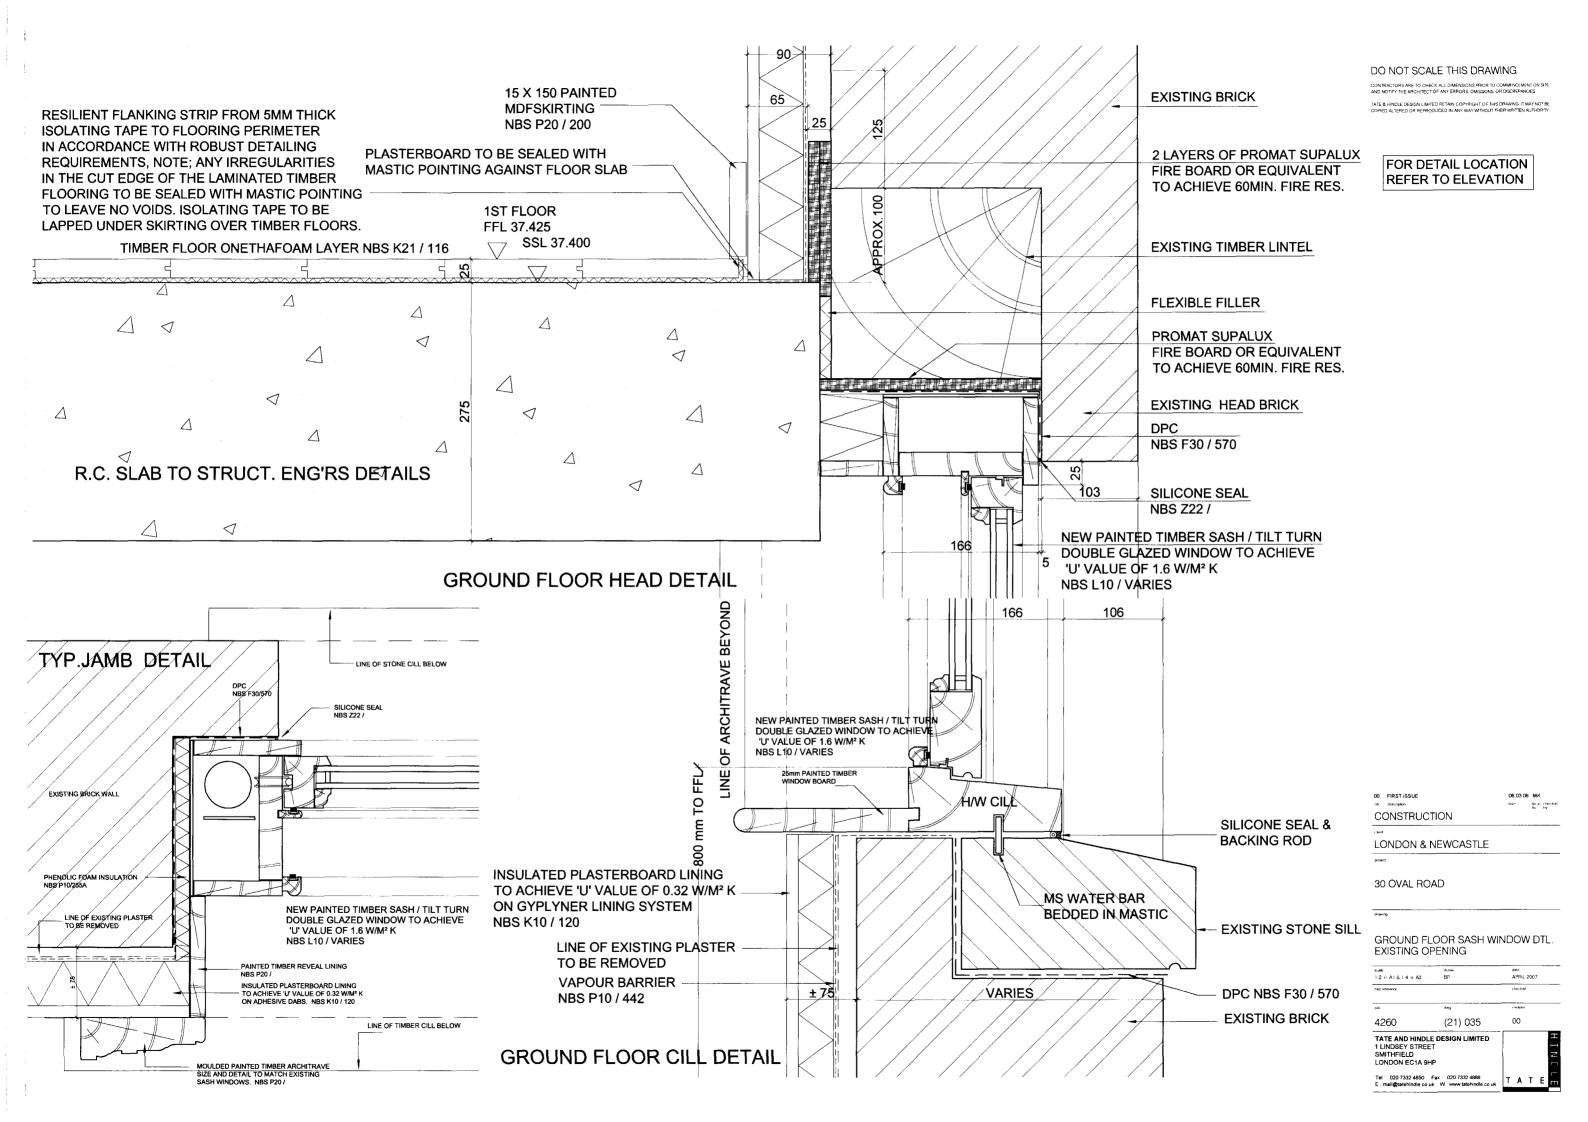

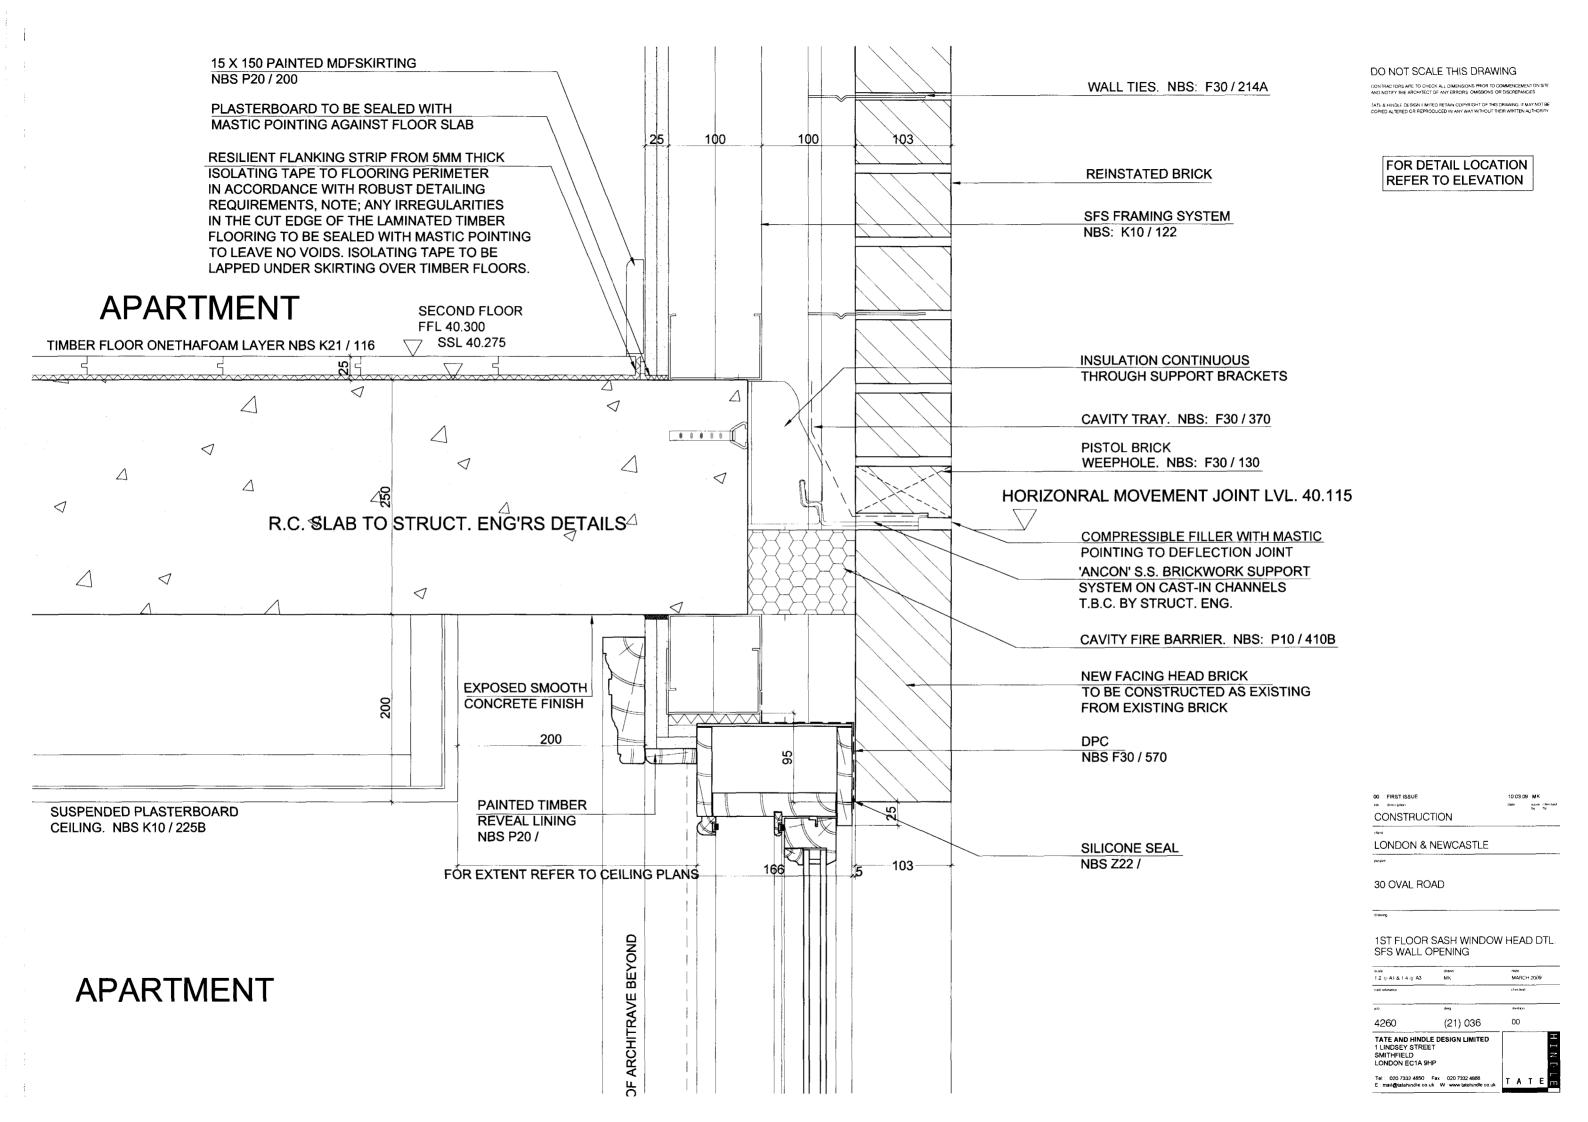

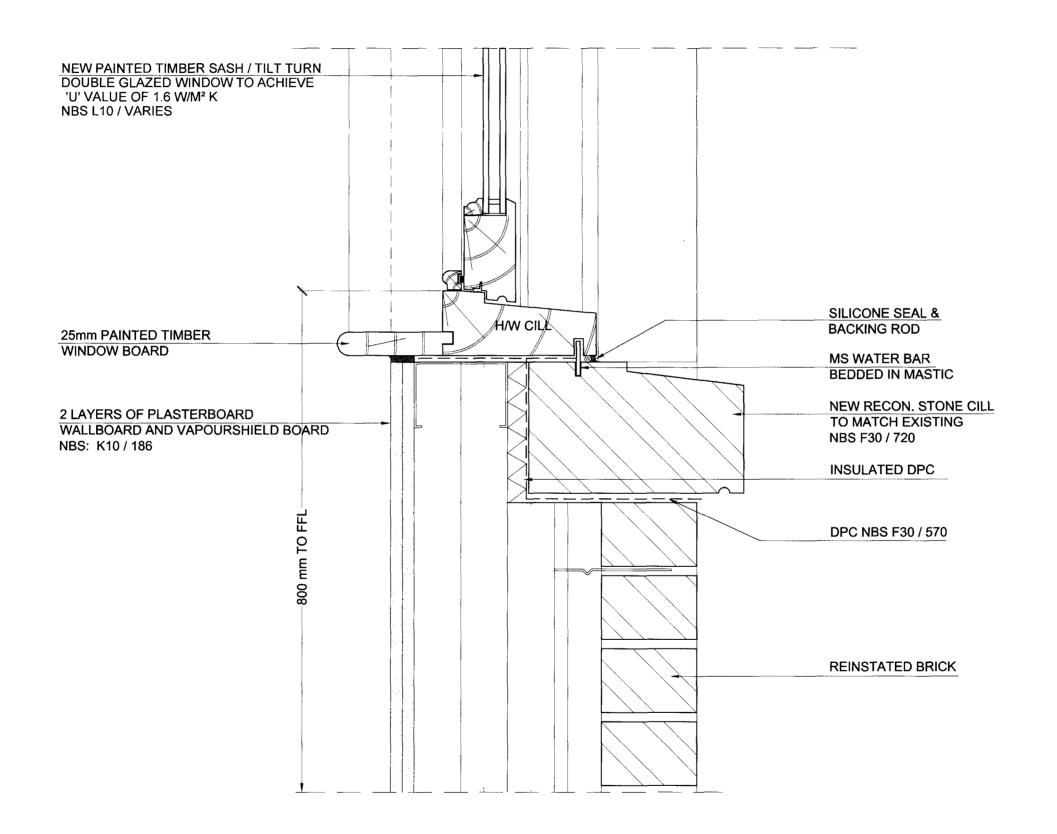

CONTRACTORS ARE TO CHECK ALL DIMENSIONS PRIOR TO COMMENCEMENT ON SITE AND NOTIFY THE ARCHITECT OF ANY ERRORS OMISSIONS OR DISCREPANCIES

FOR DETAIL LOCATION REFER TO ELEVATION

00 FIRST ISSUE rev description CONSTRUCTION

LONDON & NEWCASTLE


30 OVAL ROAD

# TYPICAL SASH WINDOW SILL DTL. SFS WALL OPENING

scalu	drawn	date
12 @ A1 & 14 @ A3	MK	MARCH 2009
cad reference		checked
hop	dwg	1918LF
4260	(21) 037	00

TATE AND HINDLE DESIGN LIMITED 1 LINDSEY STREET SMITHFIELD LONDON EC1A 9HP



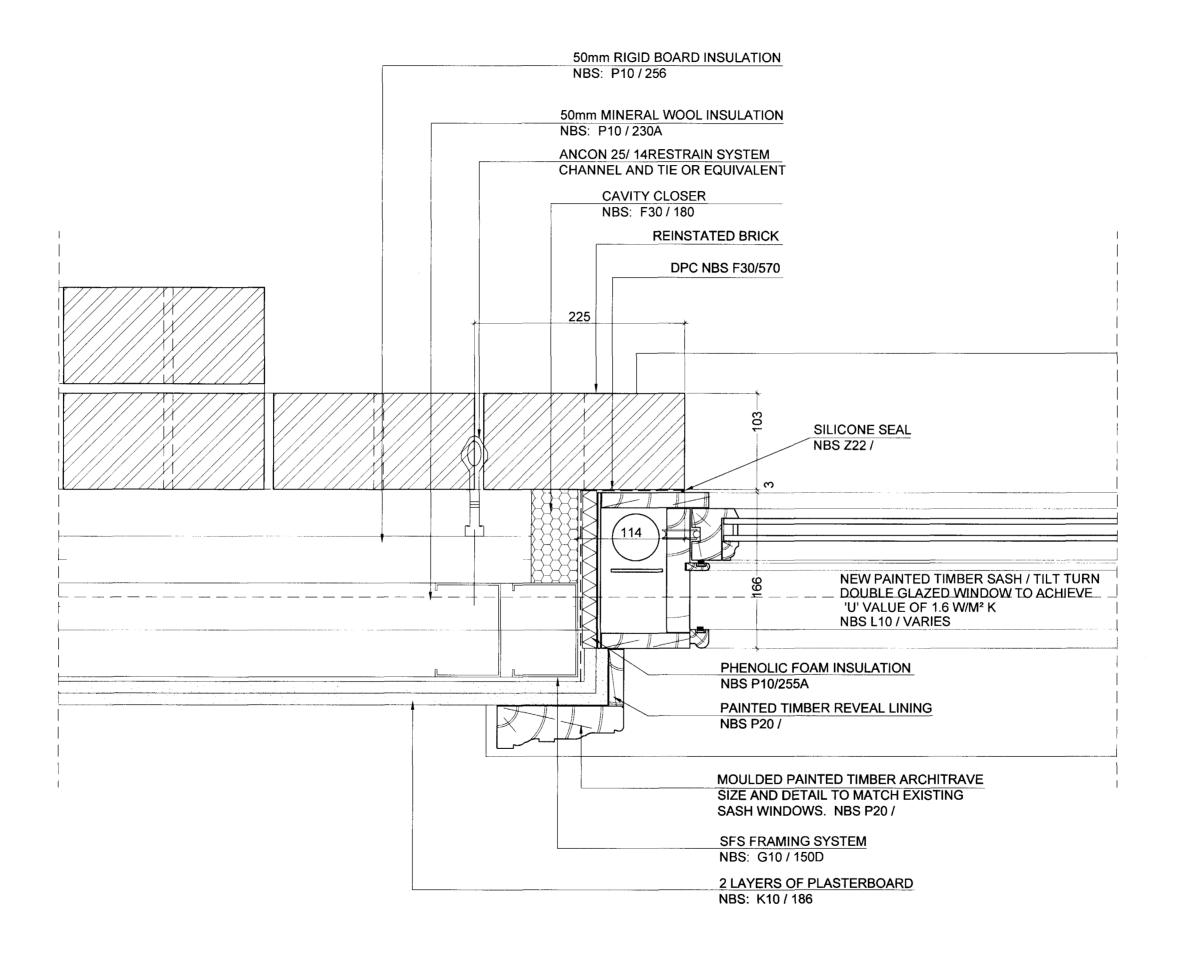

CONTRACTORS ARE TO CHECK ALL DIMENSIONS PRIOR TO COMMENCEMENT ON STE AND NOTIFY THE ARCHITECT OF ANY ERRORS OMISSIONS OR DISCREPANCIES

TATE & HINDLE DESIGN LIMITED RETAIN COPYRIGHT OF THIS DRAWING IT MAY NOT BE COPIED ALTERED OR REPRODUCED IN ANY WAY WITHOUT THEIR WRITTEN AUTHORITY

FOR DETAIL LOCATION REFER TO ELEVATION

OD FIRST ISSUE
TWO descriptor

CONSTRUCTION

\*ford

LONDON & NEWCASTLE

proper

30 OVAL ROAD

## TYPICAL SASH WINDOW JAMB DTL SFS WALL OPENING


scale	duwe	dale
1 2 ii A1 & 1 4 ii A3	MK	MARCH 2009
cad reference		checked
мор	dwj	roveron

TATE AND HINDLE DESIGN LIMITED 1 LINDSEY STREET SMITHFIELD LONDON EC1A 9HP

LONDON EC1A 9HP

Tel: 020 7332 4850 Fax: 020 7332 4888
E: mail@tatehindle co uk W: www tatehindle co uk



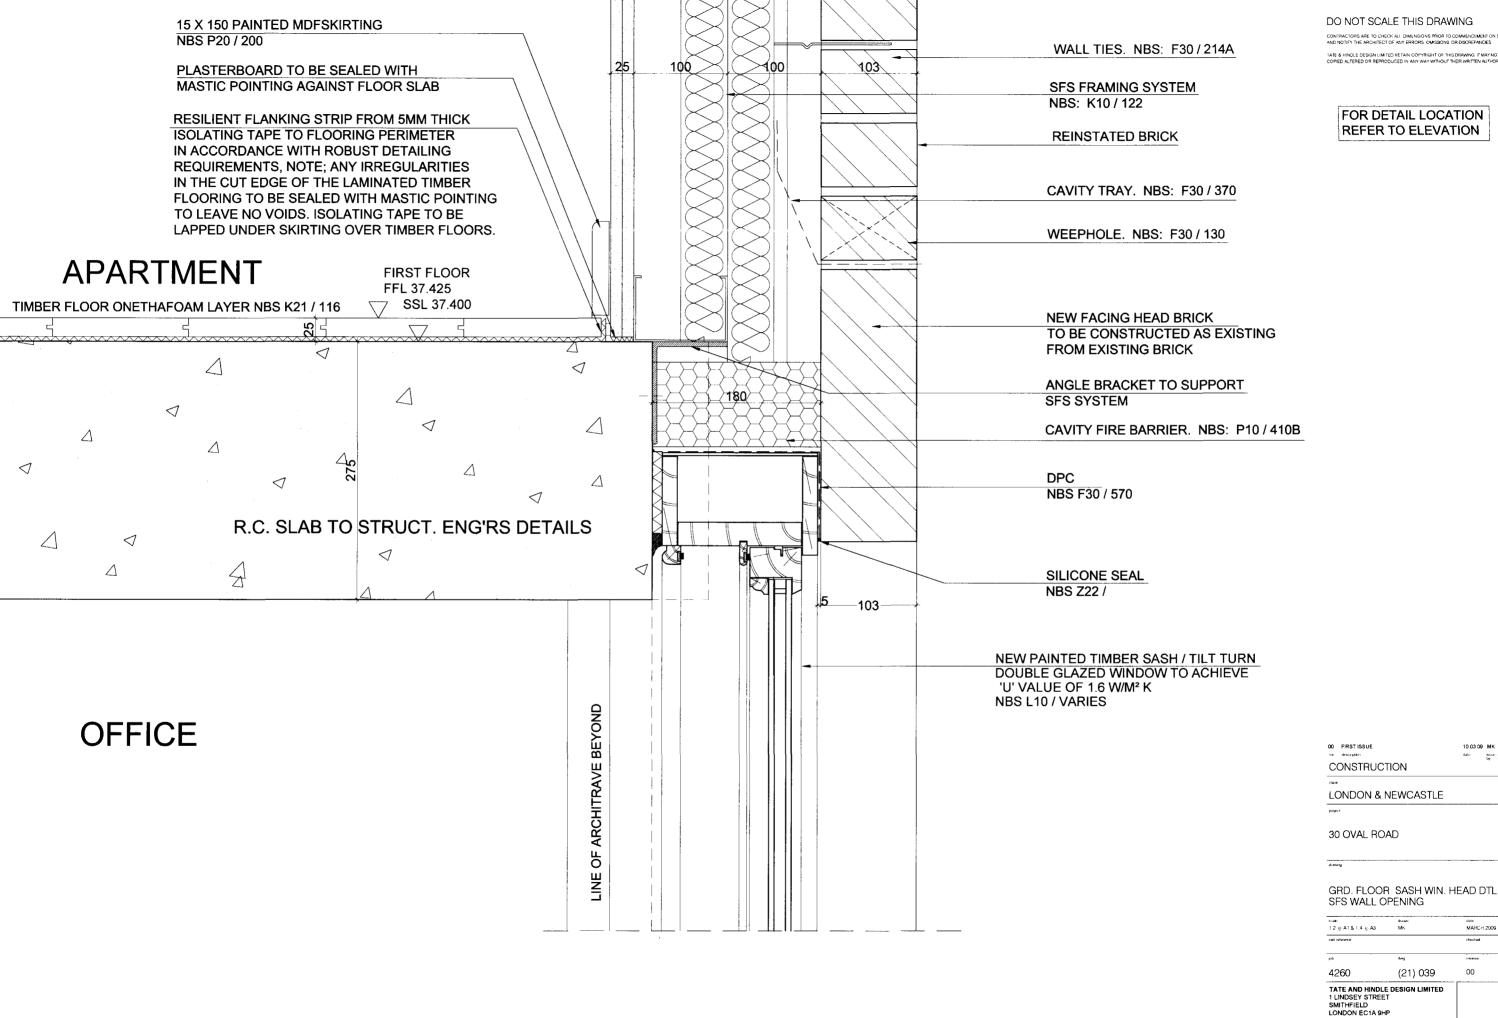


CONTRACTORS ARE TO CHECK ALL DIMENSIONS PRIOR TO COMMENCEMENT ON SITE AND NOTIFY THE ARCHITECT OF ANY ERRORS OMISSIONS OR DISCREPANCIES

TAIF & HINDLE DESIGN LIMITED RETAIN COPYRIGHT OF THIS DRAWING IT MAY NOT BE COPIED ALTERED OR REPRODUCED IN ANY WAY WITHOUT THEIR WRITTEN AUTHORITY


FOR DETAIL LOCATION REFER TO ELEVATION

00


Tel : 020 7332 4850 Fax : 020 7332 4888 E : mail@tatehindle.co.uk W www.tatehindle.co

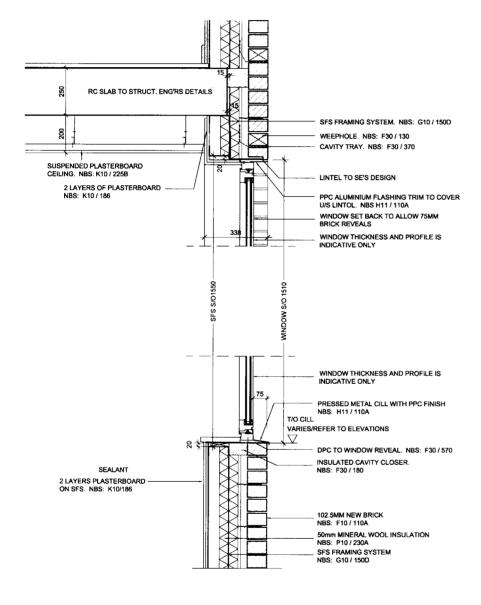

TYPICAL CILL AND HEAD DETAIL TO AFFORDABLE BLOCK Scale - 1:10 @ A1 & 1:20 @ A3

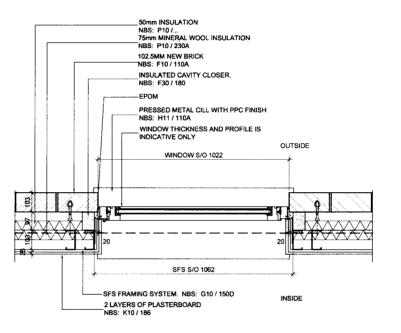

## TYPICAL JAMB DETAIL TO AFFORDABLE BLOCK Scale - 1:10 @ A1 & 1:20 @ A3

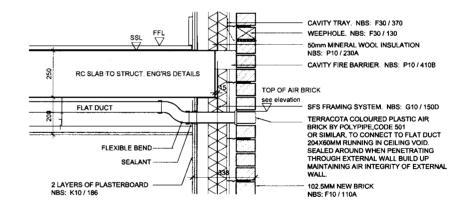

TYPICAL AIR BRICK DETAIL Scale - 1:10 @ A1 & 1:20 @ A3

DO NOT SCALE THIS DRAWING CONTRACTORS ARE TO CHECK ALL DIMENSIONS PRIOR TO COMMENCEMENT ON S AND NOTIFY THE ARCHITECT OF ANY ERRORS OMISSIONS OR DISCREPANCIES

TATE & HINDLE DESIGN LIMITED RETAIN COPYRIGHT OF THIS DRAWING. IT MAY NO COPIED ALTERED OR REPRODUCED IN ANY WAY WITHOUT THEIR WRITTEN AUTHO

00 FIRSTISSUE rev description CONSTRUCTION LONDON & NEWCASTLE 30 OVAL ROAD

EXTERNAL ENVELOPE DETAILS WINDOW HEAD, SILL, JAMB, AIR BRICK, AFFORDABLE BLOCK

scale drawn 1,10 @ A1 & 1:20 @ A3 MK 4260 (21)040 00

> TATE AND HINDLE DESIGN LIMITED
> 1 LINDSEY STREET
> SMITHFIELD LONDON EC1A 9HP

Tel : 020 7332 4850 Fax : 020 7332 4888 E : mail@tatehindle.co.uk W : www.tatehindle.co.uk



