
Front Elevation.


No. t. Lyn 7 THE SITE - 15 Lawfords Wharf

7 14 Lawfords Wharf

This drawing is protected under Copyright.
 All dimensions are to be verified on site prior to commencement.
 This drawing is to be read with all others.

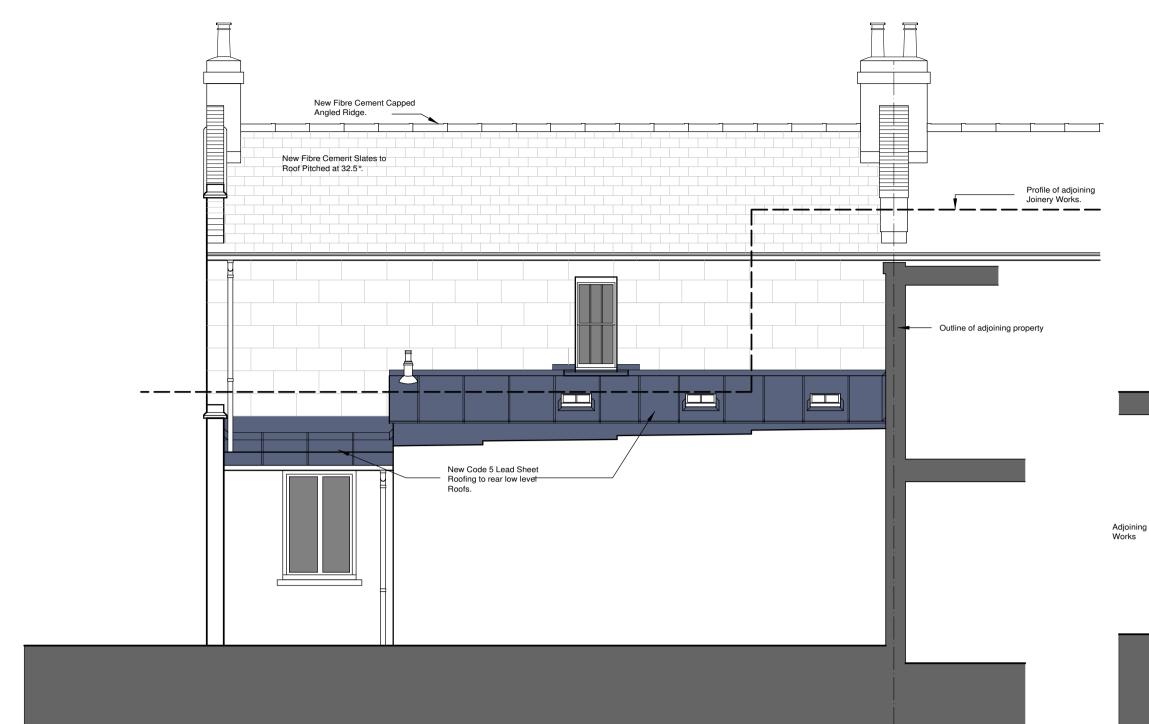

Sectional Rear Elevation.

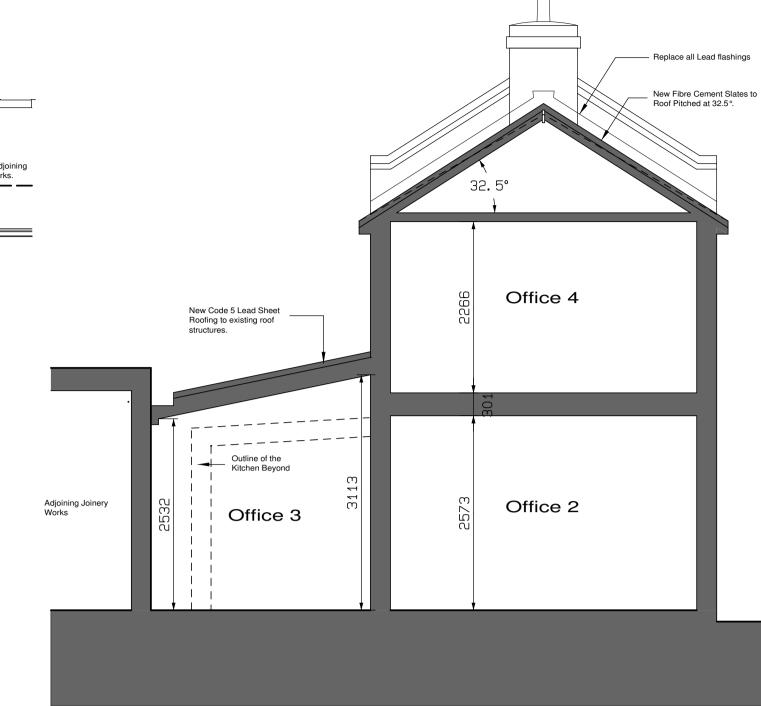

Outline Section


THE WORKS


Rear Roofs.

Remove existing fibre cement slates and sheet roofing to kitchen roof. Install new ply timber deck to roof with necessary firings to falls and Install new Code 5 lead sheet roof in accordance with the specifications and details of the Lead Sheet Association. Re-form and re-dress existing valley gutter in accordance with the requirements of the LSA.

Main Roof

Remove existing fibre cement slates and remove from site. Remove existing Rafters and re-pitch roof at 32.5 degrees to match adjoining roof. Provide Warm roof insulation system, in accordance with the requirements of Approved Document L2 of the Building Regulations to prevent further Condensation damage to the roof structures. Retain and re-use all facsias And rainwater goods. Re-roof with fibre cement slates on battens to match Adjoining roof to no.14 Lawfords Wharf. Allow to replace all lead flashings With code 4 lead. Make good upon completion to all disturbed paintwork And Renderwork.

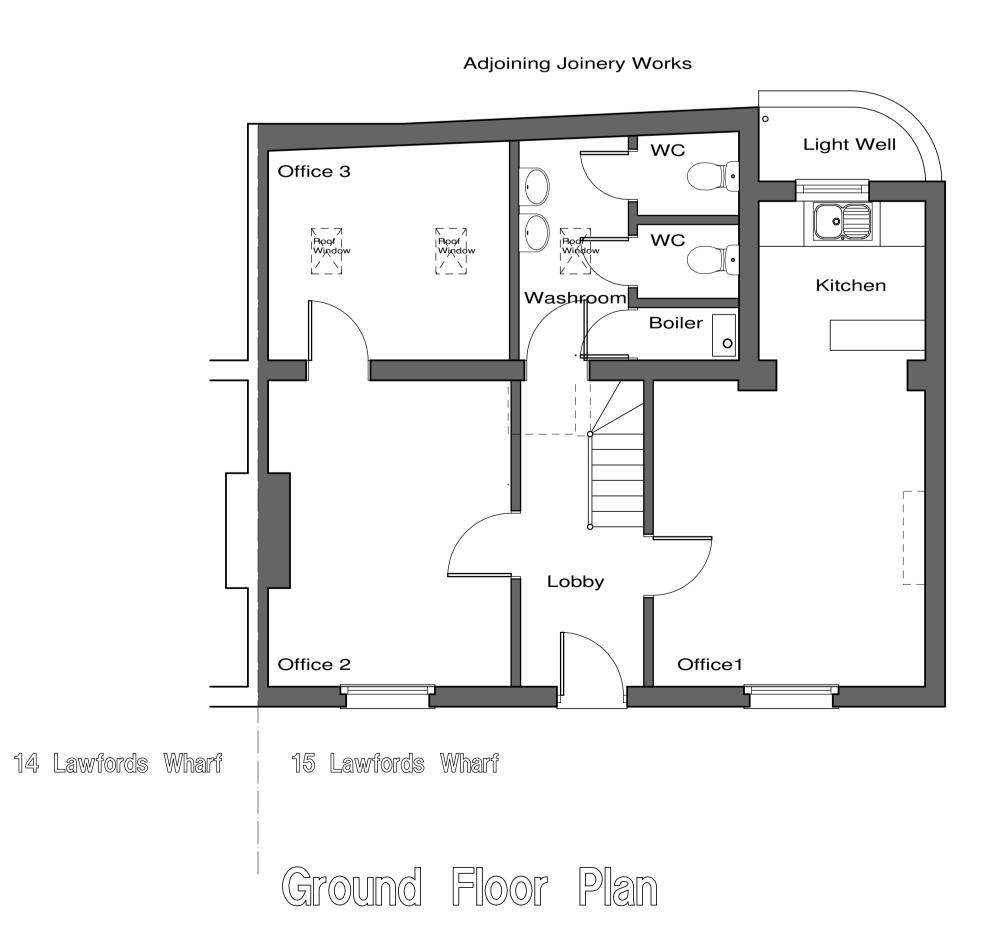

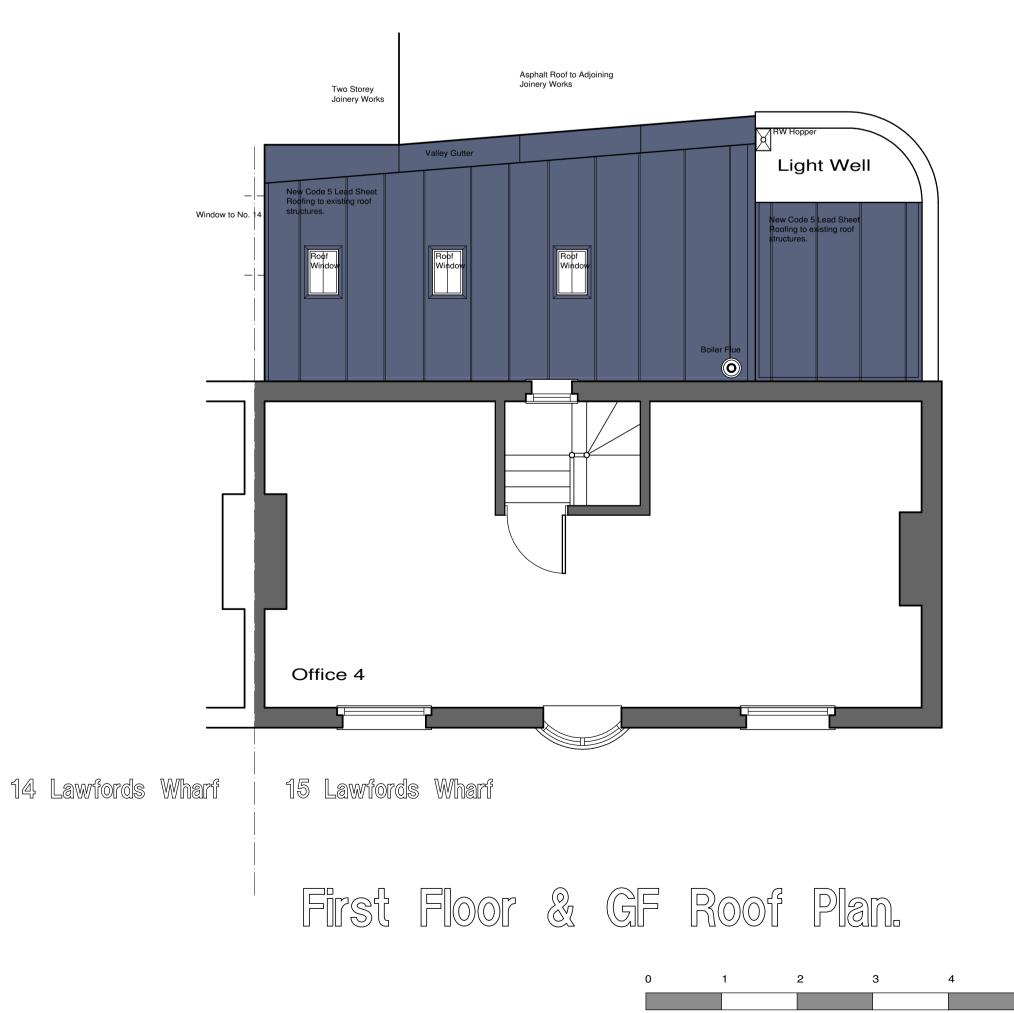

Scale 1:50

WAKEFIELD POYSER
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Proposed Plans & Elevations

Client:	Mrs Sue Fenton		
Drawn by: JSP		Scale: 1:50 @ A1	
Date: March 2010		Drg No: 1488/02	Rev.