

All dimensions in mm. Work to figured dimensions only. All dimensions to be checked on site. In event of discrepancy contact architect for clarification prior to proceeding. These drawings are to be read in conjunction with architects, mechanical and electrical engineers and structural engineers drawings, schedules and specifications. All dimensions are to structural faces.

Revision Ref	Revisions	Date




Existing Rear Elevation



Proposed Rear Elevation


Stamford West Ltd.

Client: Alveno Ltd.	
Project: 30 Harley Road NW3	
Title: Existing and Proposed Rear Elevations	
Scale: 1:50	Drawn:
Date: May 2010	Checked:
Drawing No.: 100/10/05	Revision:

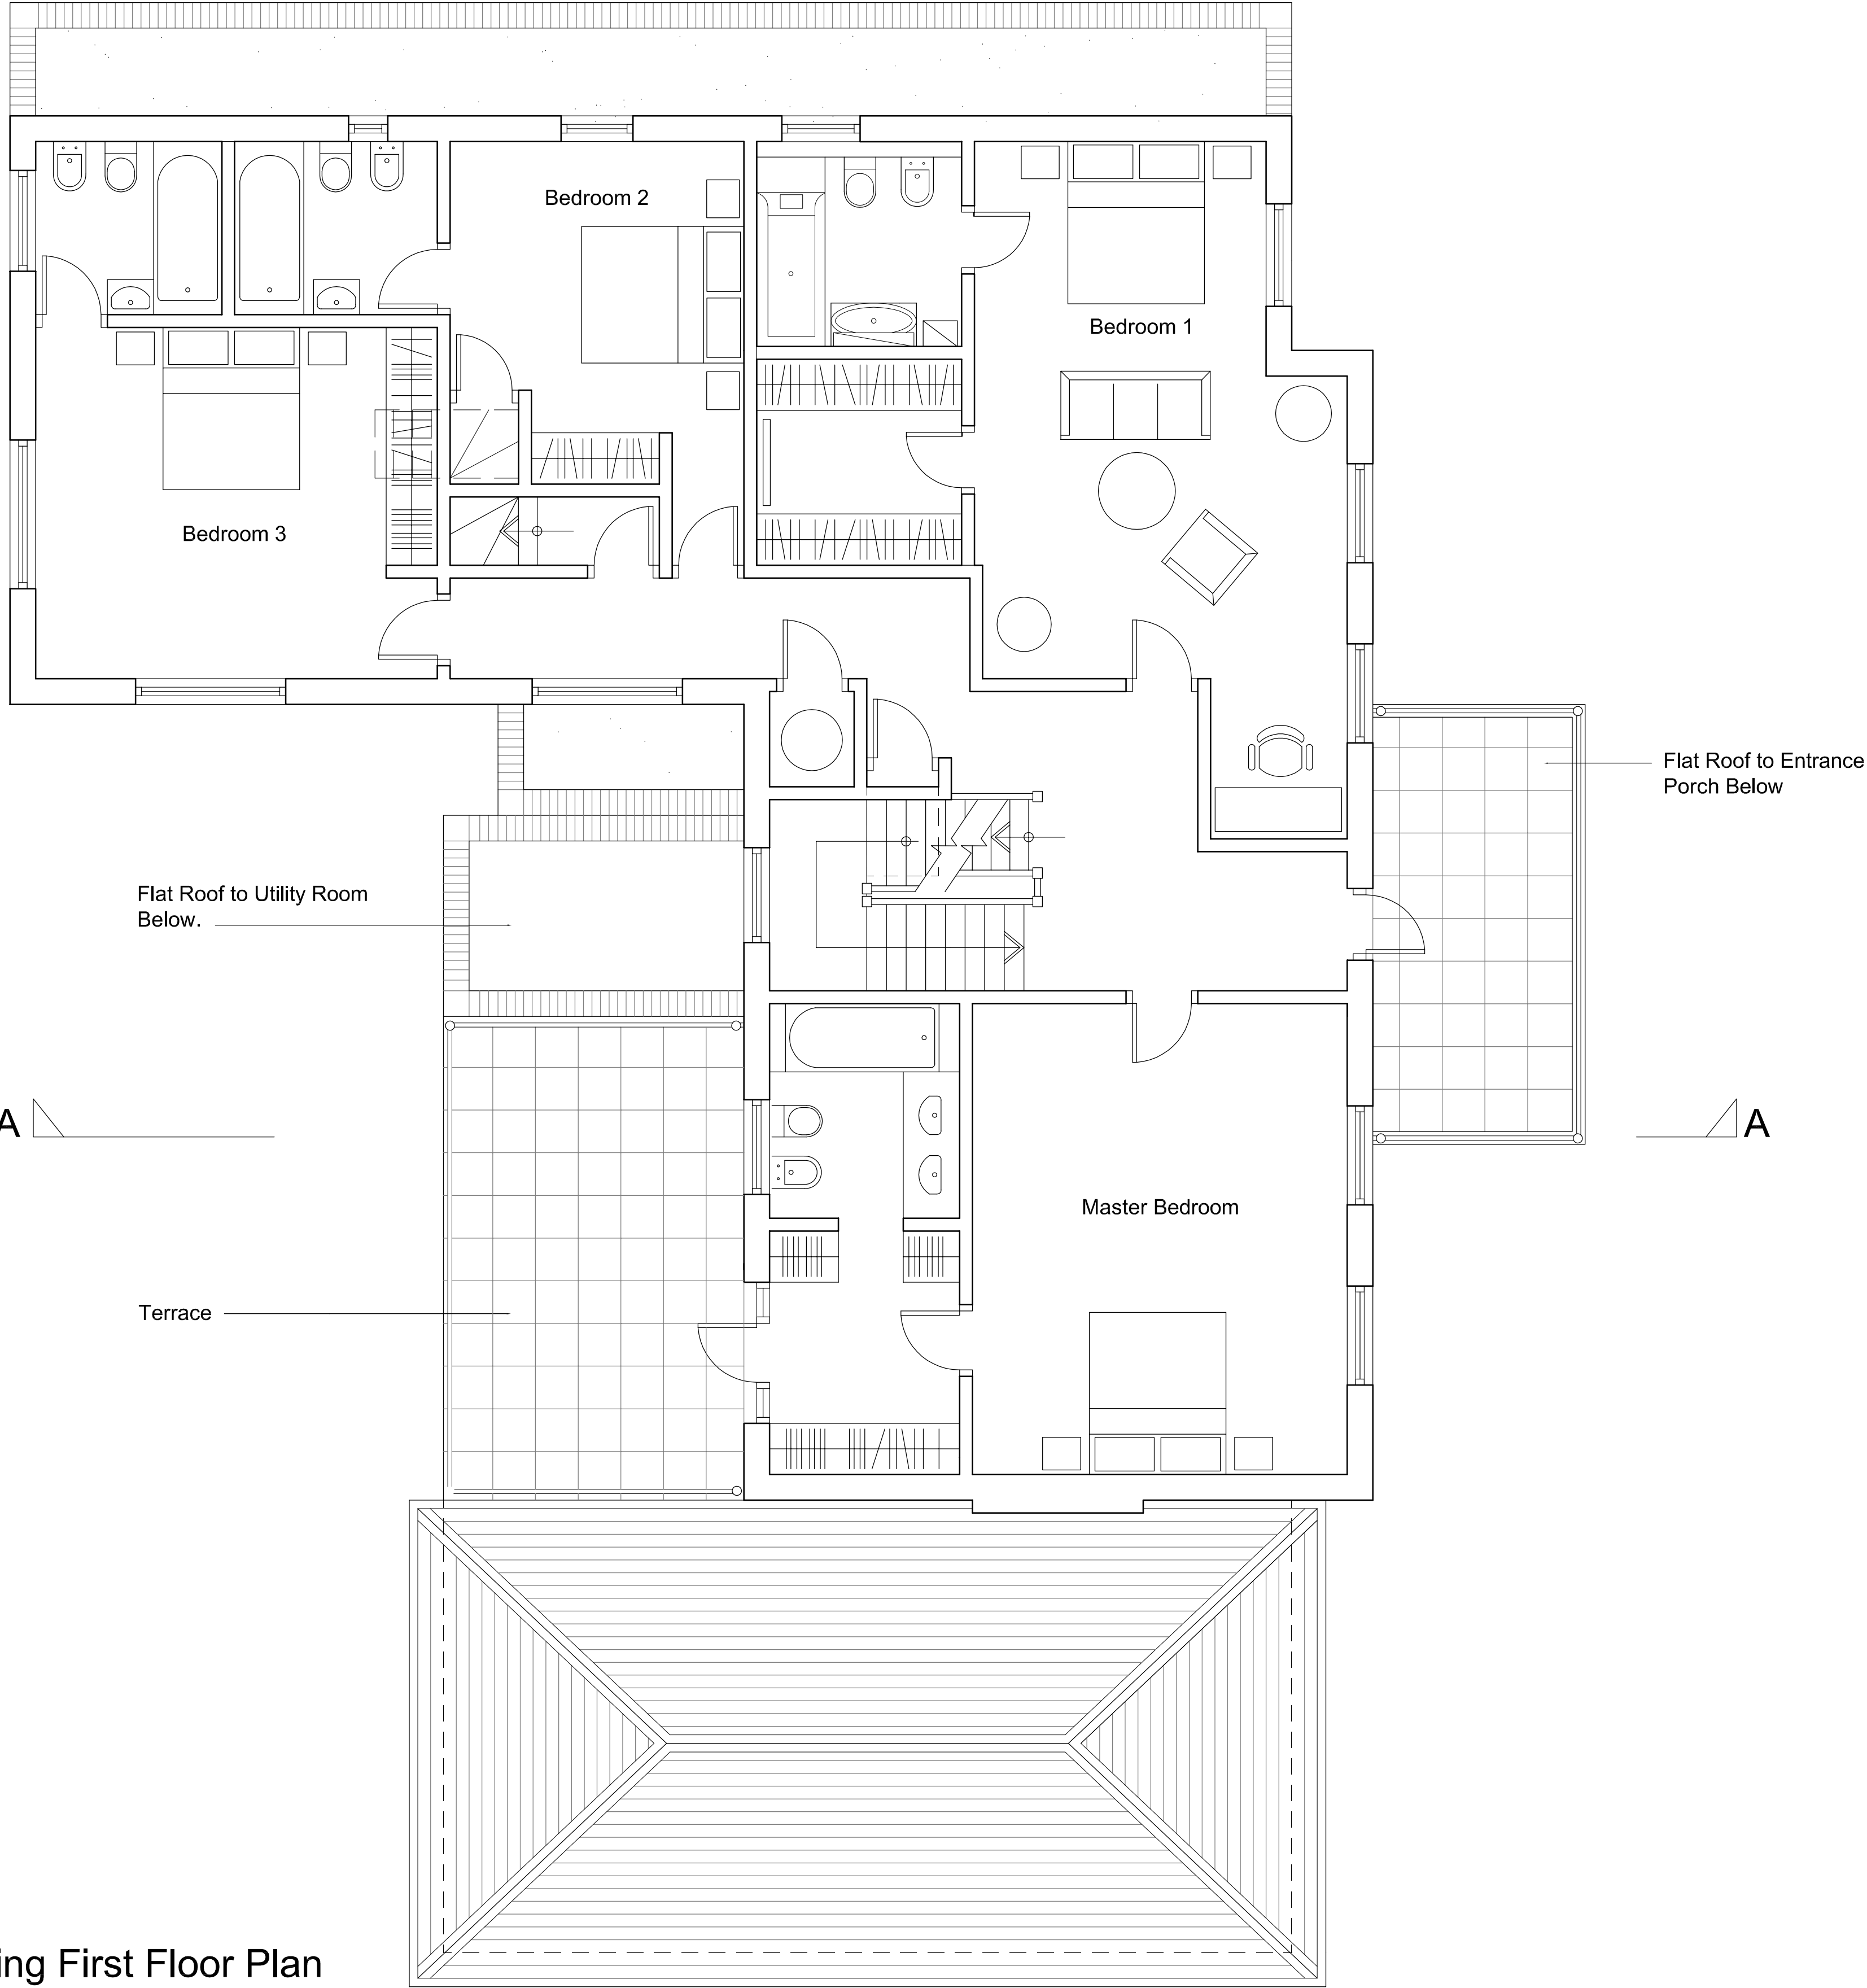

Existing First Floor Plan

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Revision Ref	Revisions	Date
Stamford West Ltd.		
Client: Alveno Ltd.		
Project: 30 Harley Road NW3		
Title: Existing First Floor Plan		
Scale:	1:50	Drawn:
Date:	May 2010	Checked:
Drawing No.: 100/10/01		Revision:

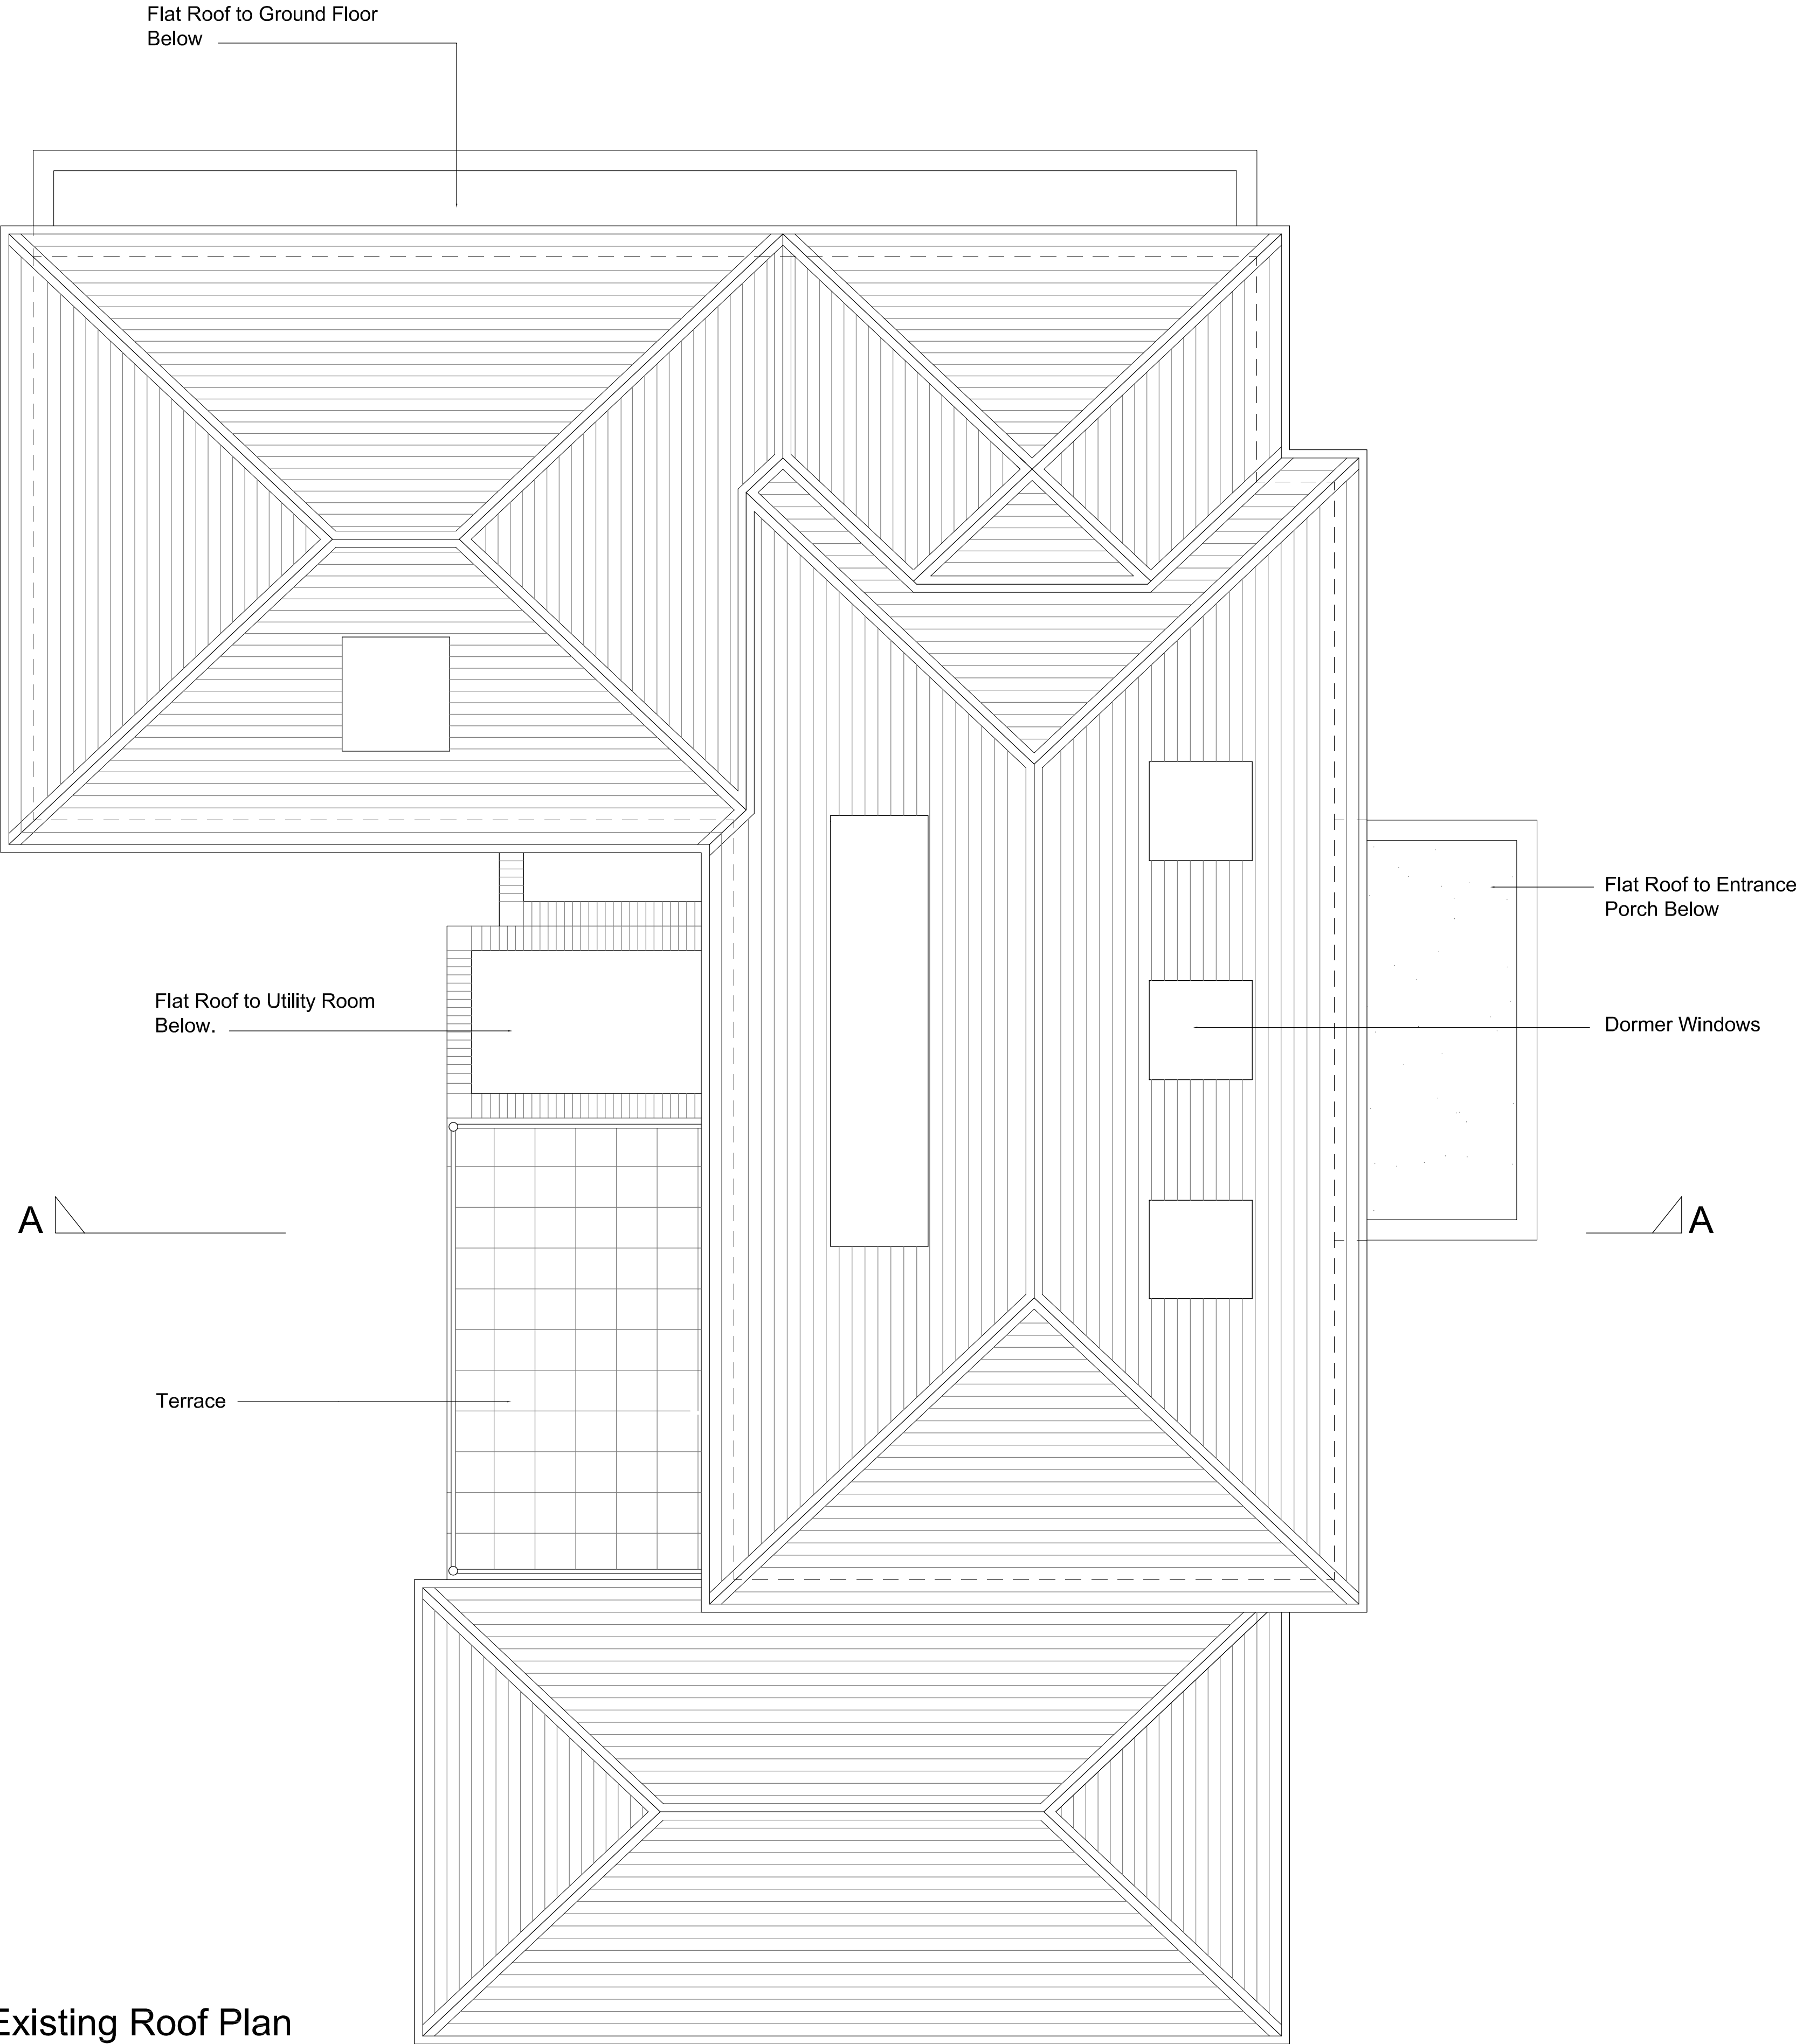

Existing Roof Plan

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Revision Ref	Revisions	Date
Stamford West Ltd.		
Client: Alveno Ltd.		
Project: 30 Harley Road NW3		
Title: Existing Roof Plan		
Scale: 1:50	Drawn:	
Date: May 2010	Checked:	
Drawing No.: 100/10/02		Revision:

All dimensions in mm. Work to figured dimensions only. All dimensions to be checked on site. In event of discrepancy contact architect for clarification prior to proceeding. These drawings are to be read in conjunction with architects, mechanical and electrical engineers and structural engineers drawings, schedules and specifications. All dimensions are to structural faces.

Revision Ref	Revisions	Date

Stamford West Ltd.

Client: Alveno Ltd.	
Project: 30 Harley Road NW3	
Title: Existing Side Elevations	
Scale: 1:50	Drawn:
Date: May 2010	Checked:
Drawing No.: 100/10/06	Revision:



Existing Side Elevation



Existing Side Elevation