
## 00. INDEX


Drawing Number	Drawing Title	Description
E14034/00	Index	Index of Drawings
E 14034/01	Location Plan	Scale 1:1250 at A4
E 14034/02	Block Plan	Photo of Site from above
E 14034/03	Roof Plan	Drawing of block from above
E 14034/04	SW Elevation 12-20	Proposed view of cable routes, Table of cable loom sizes Flats 12-20
E 14034/05	SW Elevation 2-10	Proposed view of cable routes, Table of cable loom sizes Flats 2-10
E 14034/06	NW Elevation 2-10	Proposed Aerial & Dish location.
E 14034/07	SE Elevation 12-20	View of existing Equipment
E 14034/08	Aerial Dish Sizes & Typical Mounting Heights	Measurement of Aerial & Dish mounting positions / height.

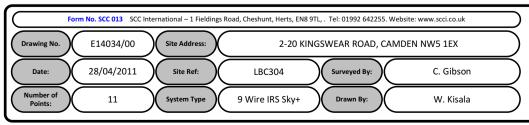







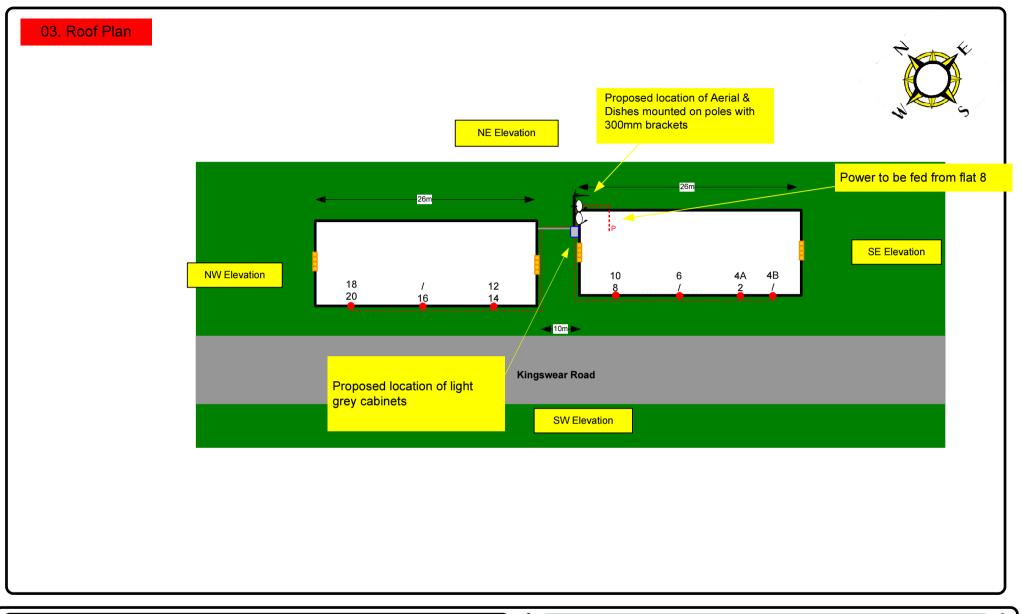



Each property will have two cables to lounge position.

Cable Harness sizes

2-4 cables = 15mm

6-8 cables = 20mm


10-14 cables = 30mm

16-18 Cables = 35mm


20 cables = 40mm


40 cables = 65mm

60 cables = 90mm

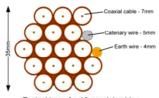

Typical loom for 16 coaxial cable + 1 earth wire, + 1 catenary wire

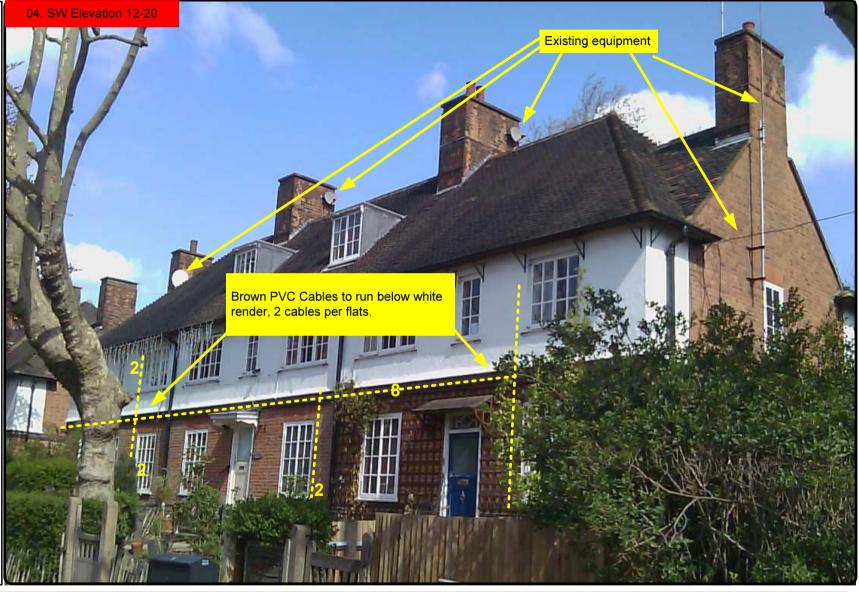

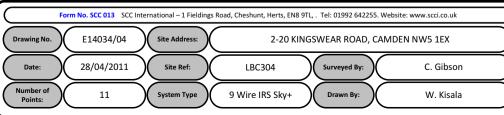



Each property will have two cables to lounge position.

Cable Harness sizes

2-4 cables = 15mm

6-8 cables = 20mm


10-14 cables = 30mm

16-18 Cables = 35mm


20 cables = 40mm

40 cables = 65mm

60 cables = 90mm

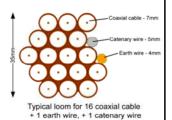



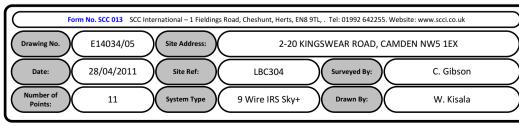



Each property will have two cables to lounge position.

Cable Harness sizes

2-4 cables = 15mm

6-8 cables = 20mm


10-14 cables = 30mm

16-18 Cables = 35mm

20 cables = 40mm

40 cables = 65mm

60 cables = 90mm

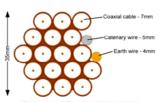

Typical loom for 16 coaxial cable + 1 earth wire, + 1 catenary wire

