


00. INDEX

Drawing Number	Drawing Title	Description
E10024/00	Index	Index of Drawings
E10024/01	Location Plan	Scale 1:1250 at A4
E10024/02	Block Plan	Photo of Site from above
E10024/03	Roof Plan	Drawing of block from above
E10024/04	NW Elevation	Proposed view of cable routes, Table of cable loom sizes
E10024/05	SW Elevation	Proposed view of cable routes, Table of cable loom sizes
E10024/06	SE Elevation	Proposed view of cable routes, Table of cable loom sizes
E10024/07	Power Location	Power cable routes to the intake cupboard
E10024/08	Existing Equipment	View of existing equipment
E10024/09	Aerial Location	Proposed Aerial & Dish location.
E10024/10	Aerial Dish Sizes & Typical Mounting Heights	Measurement of Aerial & Dish mounting positions / height.

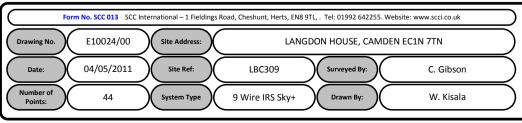




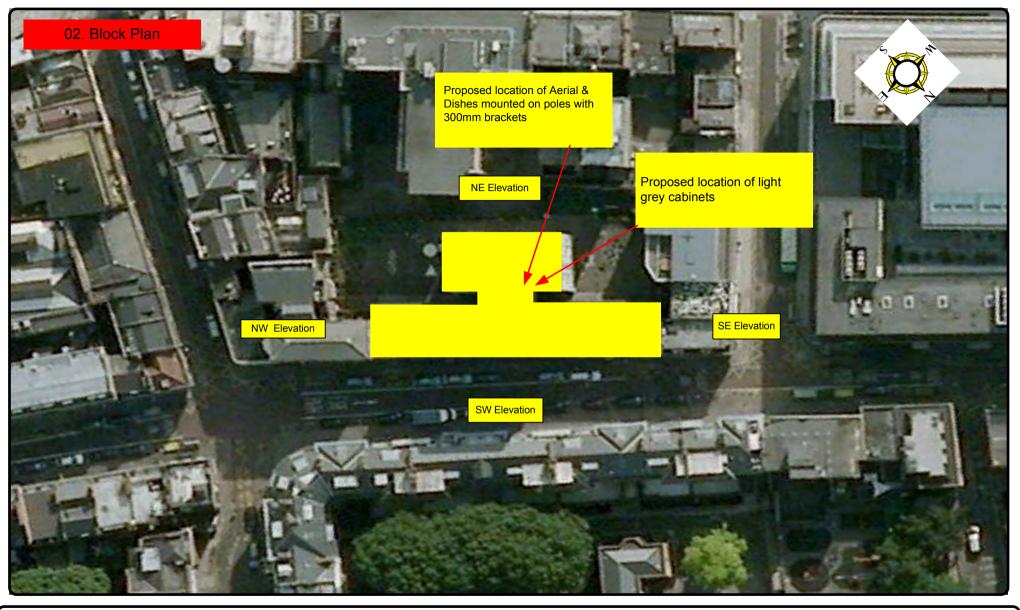

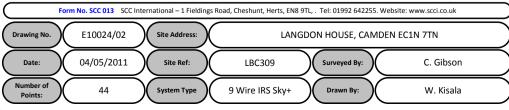



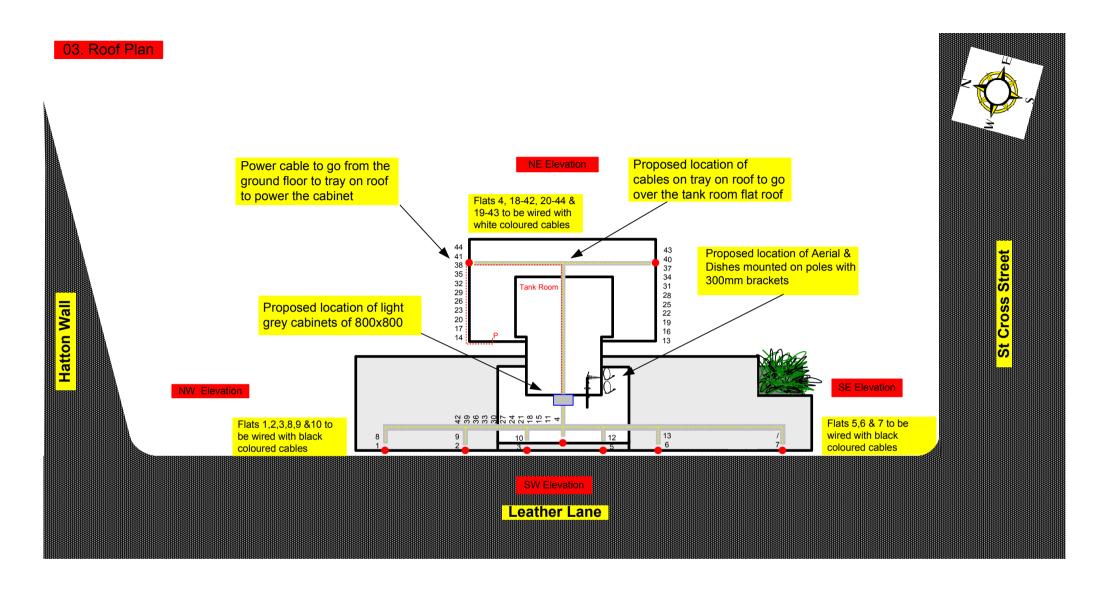



Cable Harness sizes

2-4 cables = 15mm

6-8 cables = 20mm


10-14 cables = 30mm

16-18 Cables = 35mm


20 cables = 40mm

40 cables = 65mm

60 cables = 90mm

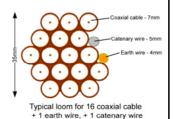



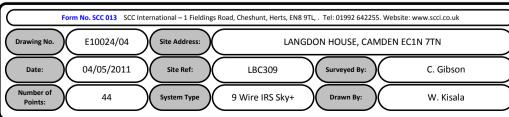



Cable Harness sizes

2-4 cables = 15mm

6-8 cables = 20mm


10-14 cables = 30mm

16-18 Cables = 35mm


20 cables = 40mm

40 cables = 65mm

60 cables = 90mm

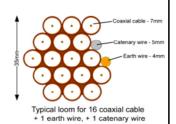



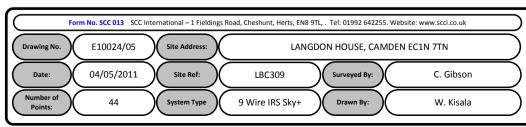



Cable Harness sizes

2-4 cables = 15mm

6-8 cables = 20mm


10-14 cables = 30mm

16-18 Cables = 35mm


20 cables = 40mm

40 cables = 65 mm

60 cables = 90mm

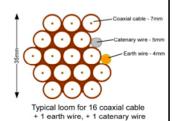



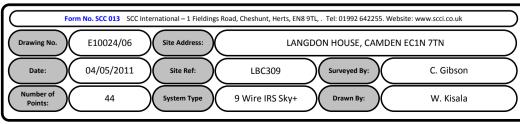



Cable Harness sizes

2-4 cables = 15mm

6-8 cables = 20mm


10-14 cables = 30mm

16-18 Cables = 35mm

20 cables = 40mm

40 cables = 65mm

60 cables = 90mm

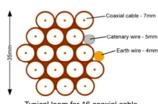

ypical loom for 16 coaxial cable
1 earth wire, + 1 catenary wire

